

DATE: 7 September 2023

A meeting of the **WAVERLEY LOCAL PLANNING PANEL** will be held by video conference at:

12.00PM THURSDAY, 14 SEPTEMBER 2023

QUORUM: Three Panel members.

APOLOGIES: By email to WLPP@waverley.nsw.gov.au

AGENDA

WLPP-2307.A Apologies

WLPP-2307.DI

Declarations of Interest

The Chair will call for any declarations of interest.

WLPP-2307.1 PAGE 4

74 Victoria Street, WAVERLEY NSW 2024 - Modification to alter internal layout, ground floor extension, new first floor rear terrace and planter and relocation of two dormer windows. (DA-165/2022/A)

Report dated 31 August 2023 from the Development and Building Unit.

Council Recommendation: That the modification application be approved for the reasons contained in the report.

WLPP-2307.2 PAGE 50

12A-14 Wilga Street, BONDI NSW 2026 - Alterations to replace main roof membrane and Unit 11 roof top stair enclosure and terrace to residential flat building. (DA-99/2023)

Report dated 9 August 2023 from the Development and Building Unit.

Council Recommendation: That the application be approved for the reasons contained in the report.

WLPP-2307.3 PAGE 100

396 Bronte Road, BRONTE NSW 2024 – Alterations and additions to detached dwelling including new first floor addition and swimming pool to the rear. (DA-50/2023)

Report dated 14 August 2023 from the Development and Building Unit.

Council Recommendation: That the application be approved for the reasons contained in the report.

WLPP-2307.4 PAGE 144

134 Hewlett Street, BRONTE NSW 2024 – Demolition of the existing dwelling and construction of a new part-two, part-three storey dwelling house, garage, landscaping works and swimming pool. (DA-19/2023)

Report dated 31 August 2023 from the Development and Building Unit.

Council Recommendation: That the application be approved for the reasons contained in the report.

WLPP-2307.5 PAGE 196

25 St Thomas Street, BRONTE NSW 2024 – Demolition and construction of a new three storey dwelling including basement garage and new swimming pool at rear. (DA-57/2023)

Report dated 31 August 2023 from the Development and Building Unit.

Council Recommendation: That the application be refused for the reasons contained in the report.

WLPP-2307.6 PAGE 264

Unit 15 of 7 Francis Street, BONDI BEACH NSW 2026 - Alterations and additions to unit 15, including conversion of roof void to attic level. (DA-161/2023)

Report dated 31 August 2023 from the Development and Building Unit.

Council Recommendation: That the application be approved for the reasons contained in the report.

WLPP-2307.7 PAGE 314

56 Campbell Parade, BONDI BEACH NSW 2026 - Substantial demolition with retention of the front façade and a portion of the side walls and construction of a shop-top housing building containing four units with retail below and a basement. The proposal is Integrated development for Water NSW. (DA-367/2022)

Report dated 1 September 2023 from the Development and Building Unit.

Council Recommendation: That the application be approved for the reasons contained in the report.





Report to the Waverley Local Planning Panel

Application number	DA-165/2022/A	
Site address	74 Victoria Street, Waverley	
Proposal	Modification to alter internal layout, ground floor extension, new first floor rear terrace and planter and relocation of two dormer windows.	
Description of Approved Development	Alterations and additions to an existing heritage listed dwelling.	
Date of lodgement	17 July 2023	
Owner	Mr T R Snow	
Applicant	Miss Sian Grant	
Submissions	Nil	
Amended cost of works	\$1,277,976 (no change)	
Principal Issues	Size of rear first floor balcony	
Recommendation	That the application be APPROVED in accordance with the conditions contained in the report.	

SITE MAP



Page 4 of 500

1. PREAMBLE

1.1. Executive Summary

The modification application seeks to modify development consent, known as DA-165/2022 for alterations and additions to an existing heritage listed dwelling at the site known as 74 Victoria Street, Waverley. In summary, the proposed modifications are for modification to alter the internal layout, ground floor extension, new first floor rear terrace and planter and relocation of two dormer windows.

The principal issues arising from the assessment of the application are as follows:

• The size of the rear first floor balcony.

The assessment finds this issue unacceptable as the depth of the balcony is excessive and extends past an appropriate building line. It is recommended to be rectified via a condition of consent.

No submissions were received.

The application has been assessed against the relevant matters for consideration under section 4.55(2) the *Environmental Planning and Assessment Act 1979* (the Act) and is recommended for approval subject to conditions of consent.

The application is referred to the Waverley Local Planning Panel for determination as the original development consent was granted by the Waverley Local Planning Panel and this modification application is made under section 4.55(2) of the Act, seeking to further increase the exceedance of the floor space ratio development standard under Waverley Local Environmental Plan 2012, which is greater than 10% above the development standard.

1.2. Site and Surrounding Locality

A site visit was carried out during the assessment of the original development application on 5 July 2022.

The site is identified as Lot 2 in DP 857358, known as 74 Victoria Street, Waverley.

The site is 'L' shaped with multiple frontages. The lot has a primary frontage to Victoria Street of 20.115m and secondary frontages to O'Dowd Street of 6.095m and Wiley Street of 20.115m. It has an area of 672.1m² and is generally flat.

The site is occupied by a two storey heritage listed dwelling house with an associated attic. Vehicular access is provided from O'Dowd Street to a single detached garage.

The site is adjoined by a single storey dwelling house to the west at 72 Victoria Street. The locality is characterised by a variety of historical low density residential development.

Figures 1 to 4 are photos of the site and its context.



Figure 1. Subject site in context with the surrounding neighbourhood. (Source: Google Maps, 2023)

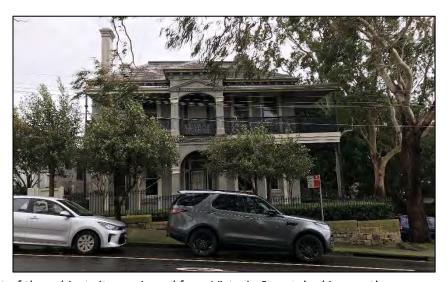


Figure 2. Front of the subject site as viewed from Victoria Street, looking north.



Figure 3. Front of the subject site as viewed from the corner of Victoria Street and Wiley Street, looking north-west.



Figure 4. Rear of the subject site as viewed from the private open space, looking south.

1.3. Details of Approved Development

The original development application, known as DA-165/2022 for alterations and additions to an existing heritage listed dwelling, was approved on 2 November 2022 by the Waverley Local Planning Panel.

1.4. Proposal

The modification application has been submitted under section 4.55 (2) of the *Environmental Planning* and Assessment Act 1979. It seeks consent for the following modifications to the approved development, as denoted by red clouds on the architectural plans:

Ground Floor

- Extension to rear of the ground floor to straighten the northern façade;
- Reconfiguration of rear living areas with kitchen relocated to the western side and family room to the east.
- Remove two existing windows, which were approved as two full height doors under DA-165/2022, from northern façade of new family room and replace with bifold door.
- New bifold doors to northern façade of kitchen and casual dining room.
- Modify windows to the western elevation of the formal living room.
- Retain wall dividing family room from laundry/WC, with minor modifications to laundry/WC configuration.
- New external gate and balustrade within eastern side boundary.

First Floor

- Modify bedroom 2 to include ensuite and walk-in wardrobe/study.
- Window on northern façade of primary robe to be replaced with door to new north facing

terrace. The terrace will be surrounded by a large planter bed. This external addition is consistent with the dimensions (3605 \times 8080mm) of the roof approved under DA-165/2022.

- Retain existing window on northern façade of primary ensuite which was approved to be enclosed.
- Primary ensuite reconfigured and floor level lowered from FFL90,265 to FFL 90,060.
- Removal of a window to the western elevation of the primary ensuite, keeping the impression
 of the original window.
- Bathroom between Bed 3 & 5 to be reconfigured to provide an ensuite for Bed 3, and a separate bathroom accessed from the hallway.

<u>Attic</u>

Relocate the two approved dormers in northern roof slope so that they are adjoining.

ASSESSMENT

The following matters are to be considered in the assessment of this modification application under relevant sections of the *Environmental Planning and Assessment Act 1979* (the Act).

2.1. Section 4.55 – Modification of consents – generally

The application is made under section 4.55(2) of the Act.

The quantitative and qualitative elements and impacts between the approved development and the development, as proposed to be modified, are not considered overly dissimilar as demonstrated in the following sections of this report. In this regard, the proposal is considered to be *substantially the same* as the originally approved development with regard to matters arising from the NSW Land and Environment Court case of *Moto Projects (No 2) Pty Ltd v North Sydney Council (1999) 106 LGERA 298*.

The application was publicly notified and no submissions were received.

2.2. Evaluation of Matters for Consideration under Section 4.15

In accordance with section 4.56(1A) of the Act the following is an assessment of the proposed modifications of the development consent against the relevant matters for consideration under section 4.15(1) of the Act.

2.2.1. Planning Instruments and Development Control Plans

The following is an assessment against relevant environmental planning instruments, including State Environmental Planning Policies (SEPPs), and development control plans.

State Environmental Planning Policies (SEPPs)

The following SEPPs apply from the 1st March 2022 and have been considered acceptable in the assessment of this development application:

- SEPP (Building Sustainability Index BASIX) 2004
- SEPP (Resilience and Hazards) 2021.

Waverley Local Environmental Plan 2012 (Waverley LEP 2012)

The land use definition of the approved development as a dwelling house remains unchanged and continues to be permitted development in the R2 zone under Waverley LEP 2012.

The quantities of the approved development, as proposed to be modified, have changed as outlined in **Table 1** of this report in relation to principal development standards under Waverley LEP 2012.

Table 1: Waverley LEP 2012 Compliance Table

Provision	Approved	Proposed Modified	Compliance
4.4 Floor space ratio and	Gross Floor Area (GFA)	Gross Floor Area (GFA)	
4.4A Exceptions to floor	<u>Calculation:</u>	<u>Calculation:</u>	
 space ratio Lot Size: 672.2m² Max FSR: 0.5:1 Max GFA: 336.1m² 	Ground Floor: 179.5m ² First Floor: 170m ² Attic:	Ground Floor: 188.1m ² First Floor: 168.7m ² Attic:	No
	29.4m ² TOTAL GFA: 378.9m ² TOTAL FSR: 0.56:1	34.7m ² TOTAL GFA: 391.5m ² TOTAL FSR: 0.62:1	
5.10 Heritage conservation	The subject dwelling is listed as a local heritage item as it is an example of a late Victorian dwelling. The application was referred to Council's Heritage Officer who supported the proposal, as amended on 4 October 2022.	The subject dwelling is listed as a local heritage item as it is an example of a late Victorian dwelling. The application was referred to Council's Heritage Officer who supported the proposal.	Yes

Provision	Approved	Proposed Modified	Compliance
5.21 Flood Planning	The site is not		
	identified on the 'Flood		
	Planning Map' of		
	Waverley LEP 2012,		
	however, the Waverley		
	LGA Flood Study 2021		
	identifies the site		
	within a low risk Flood		
	Hazard zone. The		
	recorded maximum	The proposed works	
	probability mass	are not significantly	
	function (PMF) level is	modifying the	
	87.392m AHD,	approved building	
	however not subject to	footprint and ground	Merit
	flood storage. The	floor levels, hence it is	ivierit
	existing FFL 86.830 m	considered not	
	(Dining / Living) of the	necessary to impose	
	habitable area is less	flood control	
	than the maximum	requirements.	
	PMF Level of 87.392m.		
	The proposed works		
	are not modifying the		
	existing building		
	footprint (it is only		
	very minor), hence it is		
	considered not		
	necessary to impose		
	flooding requirements.		

The following is a detailed discussion of exceedances of particular development standards under Waverley LEP 2012 as a result of the approved development, as proposed to be modified.

Floor Space Ratio (FSR)

The proposed modifications result in a net increase of gross floor area (GFA) of 12.6m², resulting in an overall FSR of 0.62:1:1. This culminates in an overall exceedance of the FSR development standard by 55.4m² or 16.5%. The net increase of FSR due to the proposed modifications represents 3.8% of the overall exceedance of the standard.

The applicant has provided some written justification for the non-compliance with the FSR development standard and has based the justification on the performance of the proposal against the objectives of the development standard. The relevant objectives of the development standard are as follows:

Objective (b): To provide an appropriate correlation between maximum building heights and density controls.

Objective (c): to ensure that buildings are compatible with the bulk and scale of the desired future character of the locality,

Objective (d): to establish limitations on the overall scale of development to preserve the environmental amenity of neighbouring properties and the locality.

The justification provided by the applicant to support the increased exceedance of the FSR development standard is summarised as follows:

The additional gross floor area on the ground floor will be not be visible from the public domain and will provide significant improvement to the residential amenity. The additional gross floor area in the attic will be concealed within the existing roof form. None of the proposed modifications will result any adverse amenity impacts to surrounding development.

Despite the breach to the FSR development standard the proposed development meets the relevant objectives of the development standard and the zone. The additional GFA is primarily located at ground floor level, which is significantly below the LEP height limit of 8.5m. Whilst it is noted that there is additional GFA proposed to the attic level this will not increase the overall bulk of the development as it is still contained within the original roof form.

The existing dwelling is of significant heritage value, so it already appears greater in mass than the surrounding dwellings. However, the additions have been appropriately designed as to be of a bulk and scale that complements the original dwelling whilst not appearing as over development.

This is apparent as the proposed works will not result in additional environmental amenity impacts to surrounding properties in terms of overshadowing or view loss.

The approved development, as proposed to be modified, will achieve and be consistent with the relevant objectives of the FSR development standard. Therefore, the net exceedance is deemed acceptable and is supported.

Waverley Development Control Plan 2022 (Waverley DCP 2022)

The approved development, as proposed to be modified, continues to comply with the relevant parts and sections of Waverley DCP 2022. Only the following parts and sections of Waverley DCP 2022 that apply to the proposed modifications are outlined in **Tables 2** and **3** of this report and detailed discussion below these tables.

Table 2: Waverley DCP 2022 - Part B General Provisions Compliance Table

Development Control	Compliance	Comment
2. Ecologically Sustainable	Yes	The amended BASIX Certificate is sufficient.
Development		
		The subject dwelling is listed as a local heritage item as it is an example of a late Victorian villa.
8. Heritage	Yes	The application was referred to Council's Heritage Officer who supported the proposal.
11. Design Excellence	Yes (by	An additional condition is recommended that a
11. Design Excellence	condition)	detailed materials and finishes schedule be

Development Control	Compliance	Comment
	submitted and be reviewed and satisfied	
		Council's Heritage Officer.

Table 33: Waverley DCP 2022 – Part C1 Low Density Residential Development Compliance Table

Development Control	Compliance	Comment
1.0 General Objectives		
	Yes	The proposal does not contravene the general objectives of this part of the DCP.
1.2 Setbacks		
 1.2.1 Front and rear building lines Predominant rear building line at each floor 	Yes	The addition to the rear of the ground floor will align with the existing rear ground floor building line.
level (adjacent three neighbours or either side)	No (resolved by condition)	The proposed first floor rear balcony extends beyond the existing rear first floor building line. Due to the lack of nearby first floor levels, a condition is recommended to require the balcony to not extend past the external northern wall of the primary bedroom on first floor level
 1.2.2 Side setbacks Minimum of 0.9m for ground floor and first floors.) 	Yes	The ground floor rear addition is set back 1m from the western side boundary.
1.3 Streetscape and visual imp	oact	
 New development to be compatible with streetscape context Replacement windows to complement the style and proportions of existing dwelling Significant landscaping to be maintained. 	Yes	The proposed modified works are either internal or to the rear of the dwelling and therefore will not alter the appearance of the dwelling as identified from the street.
1.5 Visual and acoustic privace	У	
Habitable windows are not to directly face habitable windows or open space of neighbouring dwellings unless direct views are screened or other appropriate measures are incorporated into the design	Yes	The modified windows will not affect the visual privacy of neighbouring properties.
 Maximum size of balconies: 10m² in area 1.5m deep 	No (resolved by condition)	To increase visual privacy, reduce the balcony depth and maintain an appropriate rear first floor building line, a condition is recommended to require that the rear first floor balcony not

Development Control	Compliance	Comment
		extend north of the northern external wall of the primary bedroom. Although the depth of the balcony will exceed 1.5m, it is accessed from a bedroom, which is a room less frequented than living or active rooms, and set back modestly from the lot boundaries.
1.6 Solar access		
 Minimum of 3 hours of sunlight to 50% of living areas and principal open space areas on 21 June to subject site Minimum of 3 hours of sunlight maintained to at least 50% of principal open space areas of adjoining properties on 21 June. Avoid unreasonably overshadowing of solar collectors (including habitable windows). 	Yes	No additional shadowing impacts will be cast onto neighbouring properties.
1.9 Landscaping and open spa	ce	
Overall open space: 40% of site area	Yes	Over 40%
Overall landscaped area: 20% of site area, with at least half deep soil	Yes	Over 20%
Minimum area of 25m² for private open space	Yes	Over 25m ²
1.11 Dormer windows		
	Yes	The modified rear dormer window is supported, respecting the outline of the original dormer windows.

2.2.2. Other Impacts of the Development

The proposal is considered to have no significant detrimental effect relating to environmental, social or economic impacts on the locality, subject to appropriate conditions being imposed.

2.2.3. Suitability of the Site for the Development

The site is considered suitable for the proposal.

2.2.4. Any Submissions

The application was notified for 21 days between 24 July and 14 August 2023 and a site notice erected on the site in accordance with the *Waverley Community Development Participation and Consultation Plan*.

No submissions were received.

2.2.5. Public Interest

The proposal is considered to have no detrimental effect on the public interest, subject to appropriate conditions being imposed.

3. REFERRALS

The following internal referral comments were sought:

3.1. Heritage

An internal referral was sought from Council's Heritage Officer who did not object to the proposal, subject to a detailed schedule of materials and finishes being submitted and approved by the Heritage Officer prior to the issue of a construction certificate.

3.2. Tree Management

An internal referral was sought from Council's Tree Officer who recommended conditions of consent.

4. CONCLUSION

The modification application seeks to modify development consent, known as DA-165/2022 for alterations and additions to an existing heritage listed dwelling at the site known as 74 Victoria Street, Waverley. In summary, the proposed modifications are for modification to alter the internal layout, ground floor extension, new first floor rear terrace and planter and relocation of two dormer windows.

The principal issues arising from the assessment of the application are as follows:

The size of the rear first floor balcony.

The assessment finds this issue unacceptable as the depth of the balcony is excessive and extends past an appropriate building line. An additional condition of consent has been recommended to resolve this issue.

No submissions were received.

The application has been assessed against the relevant matters for consideration under section 4.55(2) the *Environmental Planning and Assessment Act 1979* and is recommended for approval subject to conditions of consent.

5. RECOMMENDATION TO WAVERLEY LOCAL PLANNING PANEL

That the modification application be APPROVED by the Waverley Local Planning Panel subject to modified and new conditions in Appendices A and B.

Report prepared by:	Application reviewed and agreed by:	Application reviewed and agreed by:
J/smille	A.	
Joseph Somerville	Ben Magistrale	Angela Rossi
Senior Development	Manager, Development	A/ Executive Manager,
Assessment Planner	Assessment	Development Assessment
Date: 23 August 2023	Date: 31 August 2023	Date: 31 August 2023

Reason for WLPP referral:

The consent authority for the original development application was the WLPP, this modification is made under section 4.55(2) of the Act and relates to:

3. Departure from any development standard in an EPI by more than 10%

OFFICE USE ONLY

Affordable Rental Housing Units? *This is a planning portal reporting requirement	No
Secondary Dwelling *This is a planning portal reporting requirement	No
Boarding House *This is a planning portal reporting requirement	No
Group Home *This is a planning portal reporting requirement	No
Trial Period database entry required	No
VPA submitted – follow up actions required	No
Refer to compliance for investigation	No
Commercial/liquor operational conditions	No
Other (please specify):	No

APPENDIX A – CONDITIONS OF CONSENT TO BE MODIFIED

A. Amended/Deleted Conditions

1. APPROVED PLANS AND DOCUMENTATION

The development must be in accordance with:

(a) Architectural Plans prepared by MCK Architecture and Interiors of Project No: 2118 including the following:

Plan Number and Revision	Plan description	Plan Date	Date received by Council
DA10 / Rev 02	Site Plan	30/09/2022	04/10/2022
DA11 / Rev 01	Ground Floor Plan	13/04/2022	27/04/2022
DA12 / Rev 02	First Floor Plan	30/09/2022	04/10/2022
DA13 / Rev 02	Attic Plan	30/09/2022	04/10/2022
DA14 / Rev 02	Roof Plan	30/09/2022	04/10/2022
DA20 / Rev 02	West Elevation	30/09/2022	04/10/2022
DA21 / Rev 02	North Elevation	30/09/2022	04/10/2022
DA22 / Rev 02	East Elevation	30/09/2022	04/10/2022
DA23 / Rev 02	South Elevation	30/09/2022	04/10/2022
DA30 / Rev 02	Section A	30/09/2022	04/10/2022
DA60 / Rev 02	Finishes Board	30/09/2022	04/10/2022

i. As amended by Architectural Plans prepared by A&Co of Project No: 0572 including the following:

Plan Number and Revision	Plan description	Plan Date	Date received by Council
DA10 / Rev 03	Site Plan	09/06/2023	10/07/2023
DA11 / Rev 02	Ground Floor Plan	09/06/2023	10/07/2023
DA12 / Rev 03	First Floor Plan	09/06/2023	10/07/2023
DA13 / Rev 03	Attic Plan	09/06/2023	10/07/2023
DA14 / Rev 03	Roof Plan	09/06/2023	10/07/2023
DA20 / Rev 03	Elevation - West	09/06/2023	10/07/2023
DA21 / Rev 03	Elevation - North	09/06/2023	10/07/2023

DA22 / Rev 03	Elevation - East	09/06/2023	10/07/2023
DA23 / Rev 03	Elevation - South	09/06/2023	10/07/2023
DA30 / Rev 03	Section A	09/06/2023	10/07/2023
DA31 / Rev 02	Section B	09/06/2023	10/07/2023
DA32 / Rev 02	Section C	09/06/2023	10/07/2023

AMENDED DA-165/2022/A

- (b) BASIX Certificate
- (c) The Site Waste and Recycling Management Plan (SWRMP) Part 1 received by Council on 27/04/2022 Except where amended by the following conditions of consent.

27. STREET TREES TO BE RETAINED/TREE PROTECTION

Situated on the naturestrip in Wiley Street are three (3) Eucalyptus species trees that will need to be protected for the duration of works.

Precautions shall be taken when working near trees to ensure their retention, including the following:

- (a) Do not store harmful or bulk materials or spoil under or near trees;
- (b) Prevent damage to bark and root system;
- (c) Do not use mechanical methods to excavate within root zones;
- (d) Do not add or remove topsoil from under the drip line;
- (e) Do not compact ground under the drip line;
- (f) Do not mix or dispose of liquids within the drip line of the tree; and
- (g) All trees marked for retention must have a protective fence/guard placed around a nominated perimeter.

Trunk protection as per AS 4970 – 2009, Section 4.5.3 is to be installed.

Padding to be used shall be non-absorbing or free draining to prevent moisture build up around the part being protected. The trunk protection shall consist of a layer of carpet underfelt (or similar) wrapped around the trunk, followed by 1.8 metre lengths of softwood timbers (90 x 45mm in section) aligned vertically and spaced evenly around the trunk at 150mm centres (i.e. with a 50mm gap) and secured together with 2mm galvanised wire or galvanised hoop strap. The timbers shall be wrapped around the trunk (over the carpet underfelt), but not fixed to the tree to avoid mechanical injury or damage to the trunk. Trunk protection must be installed prior to any site works including demolition and maintained in good condition for the duration of the construction period.

TPZ – A 1.8m chain link wire fence or the like shall be erected around the above trees to be retained to protect them from damage during construction. Fencing is not to be removed until all building work has been completed. Fencing to be installed to the dimensions outlined in the table above.

- Trunk protection to be removed at the issue of the Occupation Certificate subject to the satisfaction of Council.
- If any tree roots are exposed during any approved works then roots smaller than 30mm are to be pruned as per the specifications below. Any roots greater than 30mm are to be assessed by a qualified arborist before any pruning is undertaken.
- If tree roots are required to be removed for the purposes of constructing the approved works, they shall be cut cleanly by hand, by an experienced Arborist/Horticulturist (with a minimum of the Horticulture Certificate or Tree Surgery Certificate).
- It is the arborist's responsibility to determine if such root pruning is suitable. If there are any
 concerns regarding this process, then Waverley Council's Tree Management Officer is to be
 contacted to make final determination.
- If any trees on neighbouring properties require pruning, then permission must be gained from the owner of the tree(s) and an Application to Prune or Remove Trees on Private Property is then to be presented to Council for processing.

AMENDED DA-165/2022/A

B. New Conditions

1A. GENERAL MODIFICATIONS

The application is approved subject to the following plan amendments;

(a) In order to reduce visual and privacy impacts upon neighbouring properties, the rear first floor terrace is not to extend north of the northern external wall of the master bedroom. The northern balustrade of the terrace is to be relocated accordingly.

The amendments are to be approved by the Principal Certifying Authority prior to the issue of any Construction Certificate.

ADDED DA-165/2022/A

1B. EXTERNAL FINISHES FOR HERITAGE BUILDING OR BUILDINGS OF CHARACTER

A schedule of external finishes shall be submitted for Council's consideration and approval, prior to the release of the relevant Construction Certificate.

The schedule shall include details of proposed external walls and roofing materials in the form of either trade brochures or building samples. The schedule shall also include window fenestration and window frame colour details, as well as fencing, paving and balustrading details and guttering colour and profile.

Any works to the retained building (which has historical value) including any paint or render finishes are to be subject to Council's written approval. Materials and finishes are to be restricted to the range of heritage colours sympathetic to the historical character of the area.

ADDED DA-165/2022/A

25A. GREEN ROOF LANDSCAPING DETAILS

The construction certificate landscape plans are to comply with the controls for green roofs in Part B3.2 of the Waverley Development Control Plan 2022 including;

- (a) Comprise plants that are suitable for the site in relation to the environmental conditions (sun, wind and views) and include indigenous or local native plants to Waverley (see Annexure B3 1).
- (b) Have a minimum soil depth of 300mm and use lightweight soil mixes that are porous, able to drain freely, and suitable for the selected plant species;
- (c) The green roof is to be designed to be a non-trafficable area (with no balustrades) and must be irrigated without requiring frequent maintenance access. Any access to the roof is to be for servicing purposes only.

A qualified landscape architect must review the design and verify that it complies with the above requirements.

ADDED DA-165/2022/A

<u>APPENDIX B – FULL SET OF CONDITIONS</u>

A. APPROVED DEVELOPMENT

1. APPROVED PLANS AND DOCUMENTATION

The development must be in accordance with:

(a) Architectural Plans prepared by MCK Architecture and Interiors of Project No: 2118 including the following:

Plan Number and Revision	Plan description	Plan Date	Date received by Council
DA10 / Rev 02	Site Plan	30/09/2022	04/10/2022
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DA20 / Rev 02	West Elevation	30/09/2022	04/10/2022
DA21 / Rev 02	North Elevation	30/09/2022	04/10/2022
DA22 / Rev 02	East Elevation	30/09/2022	04/10/2022
DA23 / Rev 02	South Elevation	30/09/2022	04/10/2022
DA30 / Rev 02	Section A	30/09/2022	04/10/2022
DA60 / Rev 02	Finishes Board	30/09/2022	04/10/2022

i. As amended by Architectural Plans prepared by A&Co of Project No: 0572 including the following:

Plan Number	Plan description	Plan Date	Date received by
and Revision			Council
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DA12 / Rev 03	First Floor Plan	09/06/2023	10/07/2023
DA13 / Rev 03	Attic Plan	09/06/2023	10/07/2023
DA14 / Rev 03	Roof Plan	09/06/2023	10/07/2023
DA20 / Rev 03	Elevation - West	09/06/2023	10/07/2023

DA21 / Rev 03	Elevation - North	09/06/2023	10/07/2023
DA22 / Rev 03	Elevation - East	09/06/2023	10/07/2023
DA23 / Rev 03	Elevation - South	09/06/2023	10/07/2023
DA30 / Rev 03	Section A	09/06/2023	10/07/2023
DA31 / Rev 02	Section B	09/06/2023	10/07/2023
DA32 / Rev 02	Section C	09/06/2023	10/07/2023

AMENDED DA-165/2022/A

- (b) BASIX Certificate
- (c) The Site Waste and Recycling Management Plan (SWRMP) Part 1 received by Council on 27/04/2022 Except where amended by the following conditions of consent.

1A. GENERAL MODIFICATIONS

The application is approved subject to the following plan amendments;

(a) In order to reduce visual and privacy impacts upon neighbouring properties, the rear first floor terrace is not to extend north of the northern external wall of the master bedroom. The northern balustrade of the terrace is to be relocated accordingly.

The amendments are to be approved by the Principal Certifying Authority prior to the issue of any Construction Certificate.

ADDED DA-165/2022/A

1B. EXTERNAL FINISHES FOR HERITAGE BUILDING OR BUILDINGS OF CHARACTER

A schedule of external finishes shall be submitted for Council's consideration and approval, prior to the release of the relevant Construction Certificate.

The schedule shall include details of proposed external walls and roofing materials in the form of either trade brochures or building samples. The schedule shall also include window fenestration and window frame colour details, as well as fencing, paving and balustrading details and guttering colour and profile.

Any works to the retained building (which has historical value) including any paint or render finishes are to be subject to Council's written approval. Materials and finishes are to be restricted to the range of heritage colours sympathetic to the historical character of the area.

ADDED DA-165/2022/A

B. PRIOR TO THE ISSUE OF A CONSTRUCTION CERTIFICATE

The requirements outlined in this section are to be provided to the satisfaction of the Principal Certifying Authority in all instances, except where a condition explicitly specifies the approval of Council or a Council Officer is required.

GENERAL REQUIREMENTS

2. NO BUILDING OR DEMOLITION WORKS PRIOR TO RELEASE OF CONSTRUCTION CERTIFICATE

The building work, or demolition work, must not be commenced until:

- (a) a Construction Certificate has been obtained from Council or an Accredited Certifier in accordance with the Environmental Planning & Assessment Act, 1979 and
- (b) a Principal Certifying Authority has been appointed and Council has been notified of the appointment in accordance with the Environmental Planning & Assessment Act, 1979 and Environmental Planning and Assessment Regulation 2000 and
- (c) Council is given at least two days' notice in writing of the intention to commence the building works.

3. HOME BUILDING ACT

The builder or person who does the residential building work shall comply with the applicable requirements of Part 6 of the *Home and Building Act, 1989*. In this regard a person must not contract to do any residential building work unless a contract of insurance that complies with this Act is in force in relation to the proposed work. It is the responsibility of the builder or person who is to do the work to satisfy the Principal Certifying Authority that they have complied with the applicant requirements of Part 6, before any work commences.

CONTRIBUTIONS, FEES & BONDS

4. SECTION 7.12 CONTRIBUTION

A cash contribution is payable to Waverley Council pursuant to section 7.12 of the *Environmental Planning and Assessment Act 1979* and Waverley Council Development Contributions Plan 2006 in accordance with the following:

- (a) A cost report indicating the itemised cost of the development shall be completed and submitted to Council:
 - (i) Where the total development cost is less than \$500,000:
 - "Waverley Council Cost Summary Report"; or,
 - (ii) Where the total development cost is \$500,000 or more:

"Waverley Council Registered Quantity Surveyor's Detailed Cost Report".

A copy of the required format for the cost reports are in the Waverley Council Contributions Plan 2006, available on Council's website.

(b) As legislated in section 25K of the Environmental Planning and Assessment Regulation 2000, the levy must be paid in accordance with the following;

- (i) A development valued at \$100,000 or less will be exempt from the levy.
- (ii) A development valued at \$100,001 \$200,000 will attract a levy of 0.5% OR
- (iii) A development valued at \$200,001 or more will attract a levy of 1% based on the <u>full</u> cost of the development.

Prior to the issue of any Construction Certificate, evidence must be provided that the levy has been paid to Council in accordance with this condition or that the cost of works is less than \$100,000.

5. SECURITY DEPOSIT

A deposit (cash or cheque) or guarantee for the amount of \$25,559.52 must be provided to Council for any damage caused to any property of the consent authority (ie. public land) as a consequence of the works and completing any public work (such as road work, kerbing and guttering, footway construction, stormwater drainage and environmental controls) required in connection with the consent.

This deposit (cash or cheque) or guarantee must be established prior to the issue of any Construction Certificate. The full amount of the difference after recovery of Council's cost for any repair of damage to Council property or rectification of unauthorised works on Council property will be refunded after satisfactory completion all of works associated with this consent (including the required public works) to the person who paid the deposit.

6. LONG SERVICE LEVY

A long service levy, as required under Section 34 of the *Building and Construction Industry Long Service Payments Act, 1986*, is to be paid in respect to this building work. In this regard, proof that the levy has been paid is to be submitted to the Principal Certifying Authority prior to the issue of any Construction Certificate.

<u>Note</u>: Council acts as an agent for the Long Service Payment Corporation and the levy may be paid at Council's office. The levy rate is 0.35% of building work costing \$25,000 or more.

7. ENGINEERING PLANS ASSESSMENT AND WORKS INSPECTION FEES

The applicant is to pay to Council fees for assessment of all engineering plans and inspection of the completed works in the public domain inclusive of all stormwater assessment, in accordance with Council's Schedule of Fees & Charges at the time of engineering plan approval, prior to such approval being granted by Council.

An invoice will be issued to the applicant for the amount payable, which will be calculated based on the design plans for the subject development.

CONSTRUCTION MATTERS

8. HOARDING

To ensure the site is contained during construction, if hoarding is required for the approved works which is to be designed and constructed in accordance with the requirements of Safe Work NSW. Where the hoarding is to be erected over the footpath or any public place, the approval of Council's Compliance Unit must be obtained and applicable fees paid, prior to the erection of the hoarding.

9. EROSION & SEDIMENT CONTROL

A Soil and Water Management Plan (SWMP), also known as an Erosion and Sediment Control Plan shall be prepared in accordance with Waverley Council's Water Management Technical Manual be installed and maintained until construction activities have been completed and the site is fully stabilised. A copy of the SWMP must be kept on site at all times and made available to Council officers upon request.

10. ENGINEERING DETAILS

Structural details are to be prepared and certified by a practicing Structural Engineer in connection with all structural components of the approved works, prior to the issue of the relevant Construction Certificate.

11. ENGINEERING CERTIFICATE OF ADEQUACY

A Certificate of Adequacy prepared by a practicing Structural Engineer is to be provided certifying the adequacy of the existing building structure to carry the extra load of the proposed additions, prior to the issue of the relevant Construction Certificate.

12. STRUCTURAL INTEGRITY OF RETAINED BUILDING ELEMENTS

Prior to the issue of a Construction Certificate, a report or certification from a practicing structural engineer must be submitted to the Principal Certifying Authority to explain how the retained building elements, such as building facades or chimneys are to be retained, supported and not undermined by the proposed development and give details of any intervention or retrofitting needed.

STORMWATER & FLOODING

13. STORMWATER AND PUBLIC INFRASTRUCTURE MANAGEMENT

To ensure that stormwater runoff from the development is drained in an appropriate manner, without impact to neighbouring properties and downstream systems, a detailed plan and certification of the development's stormwater management system must be submitted and approved by the Executive Manager, Infrastructure Services (or delegate) prior to the issue of the relevant Construction Certificate.

The submitted stormwater management plan prepared by PC Consulting Engineers Pty Ltd, Job No. 741-21, Drawing No. STW1, STW2, STW3, STW4 and STW5, Issue A, dated 21/03/2022 are considered conceptual only.

The applicant must submit amended plans and specifications to comply with the current Waverley Council Water Management Technical Manual and Development Control Plan (DCP) at the time of engineering plan approval. The submitted plans shall be prepared by a suitably qualified and practising Civil Engineer and:

a) The plans shall provide details of any required On-Site Stormwater Detention (OSD) system and its details e.g. pit dimensions, cross & long sections, significant water invert levels of inlet and outlet pipes, details of Discharge Control Pit, orifice plate details including orifice diameter, depth of water above centreline of orifice etc., pit overflow, OSD plaque, OSD warning sign and catchment plan. Amended Council's checklist as set out in Council's Water Management Technical Manual shall be completed and submitted.

- b) Details of any rainwater tank required by BASIX commitments or as nominated on the architectural plan, including the overflow connection to the approved stormwater drainage system are to be submitted.
- c) Detail the location of the existing stormwater drainage system including all pipes, inspection openings, surface drains, pits and their discharge location as well as any new stormwater drainage system.
- d) The stormwater management plan must specify any components of the existing system to be retained and certified during construction to be in good condition and of adequate capacity to convey additional runoff and be replaced or upgraded if required.
- e) Any new downpipes are to be located wholly within the property's boundary.
- f) Seepage water must not be directly or indirectly discharged to Council's street gutter.
- g) A sediment control stormwater pit must be installed inside the property, adjacent to the boundary, for all stormwater outlets.
- h) Any affected Council's infrastructure as the result of construction activities within the public domain area, inclusive of stormwater, stormwater outlet/s, kerb and gutter, pavement, grass verges and vehicle crossovers within the extent works shall be replaced as per Waverley Council Public Domain Technical Manual. All associated costs shall be borne by the applicant.

Notes:

- The Applicant is advised to consider the finished levels of the public domain, including new or existing footpaths and pavement prior to setting the floor levels for the proposed development.
- Waverley Council standard drawings for public domain infrastructure assets are available upon request. Details that are relevant may be replicated in the Engineering design submissions however, Council's title block shall not be replicated.
- Prior to commencement of works a security deposit will be made payable to Council to
 ensure any additional damage or unauthorised works within the Council property, not
 conditioned above. Council will reserve the right to withhold the cost of restoring the
 damaged assets from the security deposit should the applicant fail to restore the defects
 to the satisfaction of Council.
- Council's contact for infrastructure assessment: E-mail: <u>assets@waverley.nsw.gov.au</u> or Phone: 9083 8886 (operational hours between 9.30am to 4pm Monday to Friday).

ENERGY EFFICIENCY & SUSTAINABILITY

14. BASIX

All requirements of the BASIX Certificate and NatHERS documentation are to be shown on the Construction Certificate plans and documentation.

WASTE

15. SITE WASTE AND RECYCLING MANAGEMENT PLAN

A Site Waste and Recycling Management Plan (SWRMP) - Part 2 is to be submitted to the Principal Certifying Authority prior to the issue of the relevant Construction Certificate, which outlines materials to be reused and/or recycled as a result of demolition and construction works. At least one copy of the SWRMP Part 2 is to be available on site at all times during construction. Copies of demolition and construction waste dockets that verify the facility that received the material for recycling or disposal and the quantity of waste received, must be retained on site at all times during construction.

C. COMPLIANCE PRIOR TO WORK COMMENCING AND DURING CONSTRUCTION

The requirements outlined in this section are to be provided to the satisfaction of the Principal Certifying Authority in all instances, except where a condition explicitly specifies the approval of Council or a Council Officer is required.

PRIOR TO ANY WORKS

16. CONSTRUCTION SIGNS

Prior to commencement of any works on the site and during construction a sign shall be erected on the main frontage of the site detailing the name, address and contact details (including a telephone number) of the Principal Certifying Authority and principal contractor (the coordinator of the building works). The sign shall be clearly legible from the adjoining street/public areas and maintained throughout the building works.

17. DILAPIDATION REPORT

A Dilapidation report is to be prepared for any adjoining or nearby property that may be subject to potential damage as a result of any works being undertaken. The dilapidation report is be made available to affected property owners on request.

Note: Any damage that may be caused is a civil matter. This consent does not allow or authorise any party to cause damage, trespass, or any other unlawful act and Council will not be held responsible for any damage that may be caused to adjoining buildings as a consequence of the development being carried out. Council will not become directly involved in disputes between the builder, owner, developer, its contractors and the owners of neighbouring buildings.

DEMOLITION & EXCAVATION

18. DEMOLITION – ASBESTOS AND HAZARDOUS MATERIALS

The demolition, removal, storage, handling and disposal of products and materials containing asbestos must be carried out in accordance with the relevant requirements of SafeWork NSW and the NSW Environment Protection Authority (EPA), including:

- Work Health and Safety Act 2011;
- Work Health and Safety Regulation 2017;
- SafeWork NSW Code of Practice for the Safe Removal of Asbestos;
- Australian Standard 2601 (2001) Demolition of Structures;
- The Protection of the Environment Operations Act 1997;

At least 5 days prior to the demolition, renovation work or alterations and additions to any building, the person acting on the consent shall submit a Work Plan to the Principal Certifying Authority in accordance with Australian Standard AS 2601-2001, Demolition of Structure and a Hazardous Materials Assessment prepared by a person with suitable expertise and experience. The Work Plan and Hazardous Materials Assessment shall:

- (a) Outline the identification of any hazardous materials, including surfaces coated with lead paint;
- (b) Confirm that no asbestos products are present on the subject land; or

- (c) Particularise a method of safely disposing of the asbestos in accordance with the Code of Practice on how to safely remove asbestos published by SafeWork NSW (catalogue WC03561)
- (d) Describe the method of demolition;
- (e) Describe the precautions to be employed to minimise any dust nuisance; and
- (f) Describe the disposal methods for hazardous materials.

19. CONTROL OF DUST ON CONSTRUCTION SITES

The following requirements apply to demolition and construction works on site:

- (a) Hazardous dust is not to be allowed to escape from the site. The use of fine mesh dust proof screens or other measures are recommended. Any existing accumulations of dust (e.g.: ceiling voids and wall cavities) must be removed by the use of an industrial vacuum fitted with a high efficiency particle air (HEPA) filter. All dusty surfaces and dust created from work are to be suppressed by a fine water spray. Water must not be allowed to enter the street and stormwater systems. Demolition is not to be performed during adverse winds, which may cause dust to spread beyond the site boundaries.
- (b) All contractors and employees directly involved in the removal of hazardous dusts and substances are to wear protective equipment conforming to Australian Standard AS1716 Respiratory Protective Devices.

CONSTRUCTION MATTERS

20. CONSTRUCTION HOURS

Demolition and building work must only be undertaken between the hours of 7am and 5pm on Mondays to Fridays and 8am to 3pm on Saturdays with no work to be carried out on:

- (a) Sundays and public holidays;
- (b) Excavation works involving the use of heavy earth movement equipment including rock breakers and the like must only be undertaken between the hours of 7am and 5pm on Mondays to Fridays with no such work to be carried out on Saturday, Sunday or a public holiday.

Noise from construction activities shall comply with the Protection of the Environmental Operations (Noise Control) Regulation 2017.

21. STOCKPILES, STORAGE OF MATERIALS AND LOCATION OF BUILDING OPERATIONS

All building materials and any other items associated with the development are to be stored within the property. No materials are to be stored on Council's footpath, nature strip, or road reserve without prior Council approval.

22. CONSTRUCTION INSPECTIONS

The building works are to be inspected during construction by the Principal Certifying Authority (PCA) in accordance with the Building Legislation Amendment (Quality of Construction) Act 2002 and 162A Critical stage inspections for building work of the Environmental Planning and Assessment Regulation 2000.

23. CERTIFICATE OF SURVEY – LEVELS

All construction works are to be in accordance with the Reduced Levels (RLs) as shown on the approved plans. Certification from a Registered Surveyor certifying ground, upper floor/s and finished ridge levels is to be submitted to the Principal Certifying Authority during construction and prior to continuing to a higher level of the building.

24. CERTIFICATE OF SURVEY - BOUNDARIES AND LOCATION OF BUILDING

A Certificate of Survey prepared by a Registered Surveyor setting out the boundaries of the site and the location of the building on the site is to be submitted to the Principal Certifying Authority to certify the building is located in accordance with the development consent plans. The Certificate is to be submitted prior to the construction of the external walls above the ground floor level of the building

25. WORK OUTSIDE PROPERTY BOUNDARY

This consent does not authorise any work outside the property boundary.

LANDSCAPING

25A. GREEN ROOF LANDSCAPING DETAILS

The construction certificate landscape plans are to comply with the controls for green roofs in Part B3.2 of the Waverley Development Control Plan 2022 including;

- (a) Comprise plants that are suitable for the site in relation to the environmental conditions (sun, wind and views) and include indigenous or local native plants to Waverley (see Annexure B3 1).
- (b) Have a minimum soil depth of 300mm and use lightweight soil mixes that are porous, able to drain freely, and suitable for the selected plant species;
- (c) The green roof is to be designed to be a non-trafficable area (with no balustrades) and must be irrigated without requiring frequent maintenance access. Any access to the roof is to be for servicing purposes only.

A qualified landscape architect must review the design and verify that it complies with the above requirements.

ADDED DA-165/2022/A

TREE PROTECTION AND REMOVAL

26. TREE PROTECTION

All trees on site and adjoining properties, including street trees are to be retained and protected in accordance with AS4970-2009 'Protection of Trees on Construction Sites' and to be certified by an Arborist with AQF level 5 qualification or above, unless approved to be removed in this development consent.

27. STREET TREES TO BE RETAINED/TREE PROTECTION

Situated on the naturestrip in Wiley Street are three (3) Eucalyptus species trees that will need to be protected for the duration of works.

Precautions shall be taken when working near trees to ensure their retention, including the following:

- (h) Do not store harmful or bulk materials or spoil under or near trees;
- (i) Prevent damage to bark and root system;
- (j) Do not use mechanical methods to excavate within root zones;
- (k) Do not add or remove topsoil from under the drip line;
- (I) Do not compact ground under the drip line;
- (m) Do not mix or dispose of liquids within the drip line of the tree; and
- (n) All trees marked for retention must have a protective fence/guard placed around a nominated perimeter.

Trunk protection as per AS 4970 – 2009, Section 4.5.3 is to be installed.

Padding to be used shall be non-absorbing or free draining to prevent moisture build up around the part being protected. The trunk protection shall consist of a layer of carpet underfelt (or similar) wrapped around the trunk, followed by 1.8 metre lengths of softwood timbers (90 x 45mm in section) aligned vertically and spaced evenly around the trunk at 150mm centres (i.e. with a 50mm gap) and secured together with 2mm galvanised wire or galvanised hoop strap. The timbers shall be wrapped around the trunk (over the carpet underfelt), but not fixed to the tree to avoid mechanical injury or damage to the trunk. Trunk protection must be installed prior to any site works including demolition and maintained in good condition for the duration of the construction period.

TPZ – A 1.8m chain link wire fence or the like shall be erected around the above trees to be retained to protect them from damage during construction. Fencing is not to be removed until all building work has been completed. Fencing to be installed to the dimensions outlined in the table above.

- Trunk protection to be removed at the issue of the Occupation Certificate subject to the satisfaction of Council.
- If any tree roots are exposed during any approved works then roots smaller than 30mm are to be pruned as per the specifications below. Any roots greater than 30mm are to be assessed by a qualified arborist before any pruning is undertaken.
- If tree roots are required to be removed for the purposes of constructing the approved works, they shall be cut cleanly by hand, by an experienced Arborist/Horticulturist (with a minimum of the Horticulture Certificate or Tree Surgery Certificate).
- It is the arborist's responsibility to determine if such root pruning is suitable. If there are any concerns regarding this process, then Waverley Council's Tree Management Officer is to be contacted to make final determination.
- If any trees on neighbouring properties require pruning, then permission must be gained from the owner of the tree(s) and an Application to Prune or Remove Trees on Private Property is then to be presented to Council for processing.

AMENDED DA-165/2022/A

D. PRIOR TO THE ISSUE OF AN OCCUPATION CERTIFICATE

The requirements outlined in this section are to be provided to the satisfaction of the Principal Certifying Authority in all instances, except where a condition explicitly specifies the approval of Council or a Council Officer is required, prior to the issue of an Occupation Certificate or Subdivision Certificate, whichever applies.

28. FINAL OCCUPATION CERTIFICATE

Prior to occupation or use of the development, the Principal Certifying Authority must issue an Occupation Certificate. The Principal Certifying Authority must be satisfied that the requirements of the Environmental Planning & Assessment Act, 1979 have been satisfied including all critical stage inspections. Documentary evidence of all required inspections is to be submitted to Council.

29. CERTIFICATION OF BASIX COMMITMENTS

The Principal Certifying Authority shall certify that the all the undertakings in the approved BASIX certificate have been completed.

30. WORKS-AS-EXECUTED DRAWINGS – STORMWATER DRAINAGE SYSTEM

- a. A Works-As-Executed drawing (WAED) of the stormwater drainage system must be prepared by a Registered Surveyor. This drawing must detail the alignment of all pipelines, pits, basement pump-out facility, any detention facility, any rainwater harvesting facility and other drainage related infrastructure. An original or a colour copy must be submitted to Waverley Council. Where changes have occurred, the Council approved plans shall be marked-up in red ink and shall include levels and location for the drainage structures and works.
- b. A suitably qualified and practising Engineer must provide certification of the WAED of the stormwater drainage system that the stormwater drainage works) were constructed to their satisfaction and in accordance with the Development Consent, Water Management Technical Manual, all applicable Codes, Policies, Plans, Standards and good engineering practice. A copy of the aforementioned letter of certification must be submitted to Council.

31. CREATION OF POSITIVE COVENANT AND RESTRICTION FOR OSD

A "Restriction on the Use of Land" and "Positive Covenant" shall be created for any On-Site Stormwater Detention (OSD) system, under Section 88E of the Conveyancing Act 1919. This is to place a restriction on the title that the system is maintained and kept free of debris/weed to allow unobstructed passage of stormwater through the site and underneath the residence. The property owner/occupant shall not modify or remove the system without consent from Council.

The wording of the Instrument shall be submitted to and approved by Executive Manager, Infrastructure Services (or delegate) prior to lodgement at NSW Land Registry Services. The Instrument shall be registered and a registered copy of the document shall be submitted to and approved by the consent authority prior to the issue of an Occupation Certificate/use of the building. All associated costs shall be borne by the applicant.

32. CERTIFICATION OF NEWLY CONSTRUCTED AND RETAINED STORMWATER DRAINAGE SYSTEM

Prior to issue of any Occupation Certificate, certification is to be provided from a suitably qualified and practising Engineer or Plumber, that any new stormwater drainage system has been constructed in

accordance with the Development Consent, Water Management Technical Manual, all applicable Codes, Policies, Plans, Standards and good engineering practice. Similarly, any retained stormwater drainage system is unblocked, in good working order and to be repaired/replaced to best practice. A copy of the certification must be submitted to Council.

E. ADVISORY MATTERS

The following advisory matters are provided as additional information to ensure compliance with the relevant legislation and requirements. You must also check other Commonwealth and NSW Acts and Regulations which may apply to the works or use approved in this application.

AD1. POST CONSENT CONDITIONS REQUIRING COUNCIL INPUT

Various conditions require further input, review or approval by Council in order to be satisfied following the determination of the application (that is, post consent). In those instances, please adhere to the following process to avoid delays:

- Please read your conditions carefully.
- Information to be submitted to Council should be either via email to <u>info@waverley.nsw.gov.au</u>, in person (at Council's Customer Service Centre) or via post service.
- Attention the documentation to the relevant officer/position of Council (where known/specified in condition)
- Include DA reference number
- Include condition number/s seeking to be addressed
- Where multiple conditions need Council input, please try to group the documentation / email/s into relevant subjects (multiple emails for various officers may be necessary, for example).
- Information to be submitted in digital format refer to 'Electronic lodgement guidelines' on Council's website. Failure to adhere to Council's naming convention may result in documentation being rejected.
- Where files are too large for email, the digital files should be sent to Council via CD/USB.
 Council does not support third party online platforms (data in the cloud) for receipt of information.
- Please note in some circumstances, additional fees and/or additional documents (hard copy) may be required.
- Council's standard for review (from date the relevant officer receives documentation) is 14days. Times may vary or be delayed if information is not received in this required manner.
- Any queries, please contact Council's Duty Planner on duty.planner@waverley.nsw.gov.au

AD2. SYDNEY WATER REQUIREMENTS

You are required to submit your plans to the appropriate Sydney Water office to determine whether the development will affect Sydney Water's sewer and water mains, stormwater drains and/or easements.

If you are increasing the density of the site, a Section 73 Compliance Certificate under the Sydney Water Act 1994 must be obtained. The application must be made through an authorised Water Servicing Coordinator, for details see the Sydney Water website.

Following application a "Notice of Requirements" will be forwarded detailing water and sewer extensions to be built and charges to be paid. Please make early contact with the Coordinator, since building of water/sewer extensions can be time consuming and may impact on other services and building, driveway or landscape design.

AD3. DIAL BEFORE YOU DIG

Underground assets may exist in the area that is subject to your application. In the interests of health and safety and in order to protect damage to third party assets please contact Dial before you dig at www.1100.com.au or telephone on 1100 before excavating or erecting structures (This is the law in NSW). If alterations are required to the configuration, size, form or design of the development upon contacting the Dial before You Dig service, an amendment to the development consent (or a new development application) may be necessary. Individuals owe asset owners a duty of care that must be observed when working in the vicinity of plant or assets. It is the individual's responsibility to anticipate and request the nominal location of plant or assets on the relevant property via contacting the Dial before you dig service in advance of any construction or planning activities.

AD4. TELECOMMUNICATIONS ACT 1997 (COMMONWEALTH)

Telstra (and its authorised contractors) are the only companies that are permitted to conduct works on Telstra's network and assets. Any person interfering with a facility or installation owned by Telstra is committing an offence under the Criminal Code Act 1995 (Cth) and is liable for prosecution. Furthermore, damage to Telstra's infrastructure may result in interruption to the provision of essential services and significant costs. If you are aware of any works or proposed works which may affect or impact on Telstra's assets in any way, you are required to contact: Telstra's Network Integrity Team on Phone Number 1800810443.

AD5. ALTERATIONS AND ADDITIONS ONLY

This consent is for alterations and additions to the existing building only and should during the course of construction a significant amount of the remaining fabric of the building be required to be removed, works must cease immediately and a new development application will be required to be submitted for assessment.


AD6. TREE REMOVAL/PRESERVATION

Any trees not identified for removal in this application have not been assessed and separate approval may be required. Any pruning of trees on adjoining properties required for the erection of scaffolding and/or the construction of the building may also require approval.

SNOW-PENGILLY HOUSE


74 VICTORIA STREET WAVERLEY NSW 2024

RECEIVED
Waverley Council
Receipt No: DA-165/2022/A
Date Received: 10/07/2023

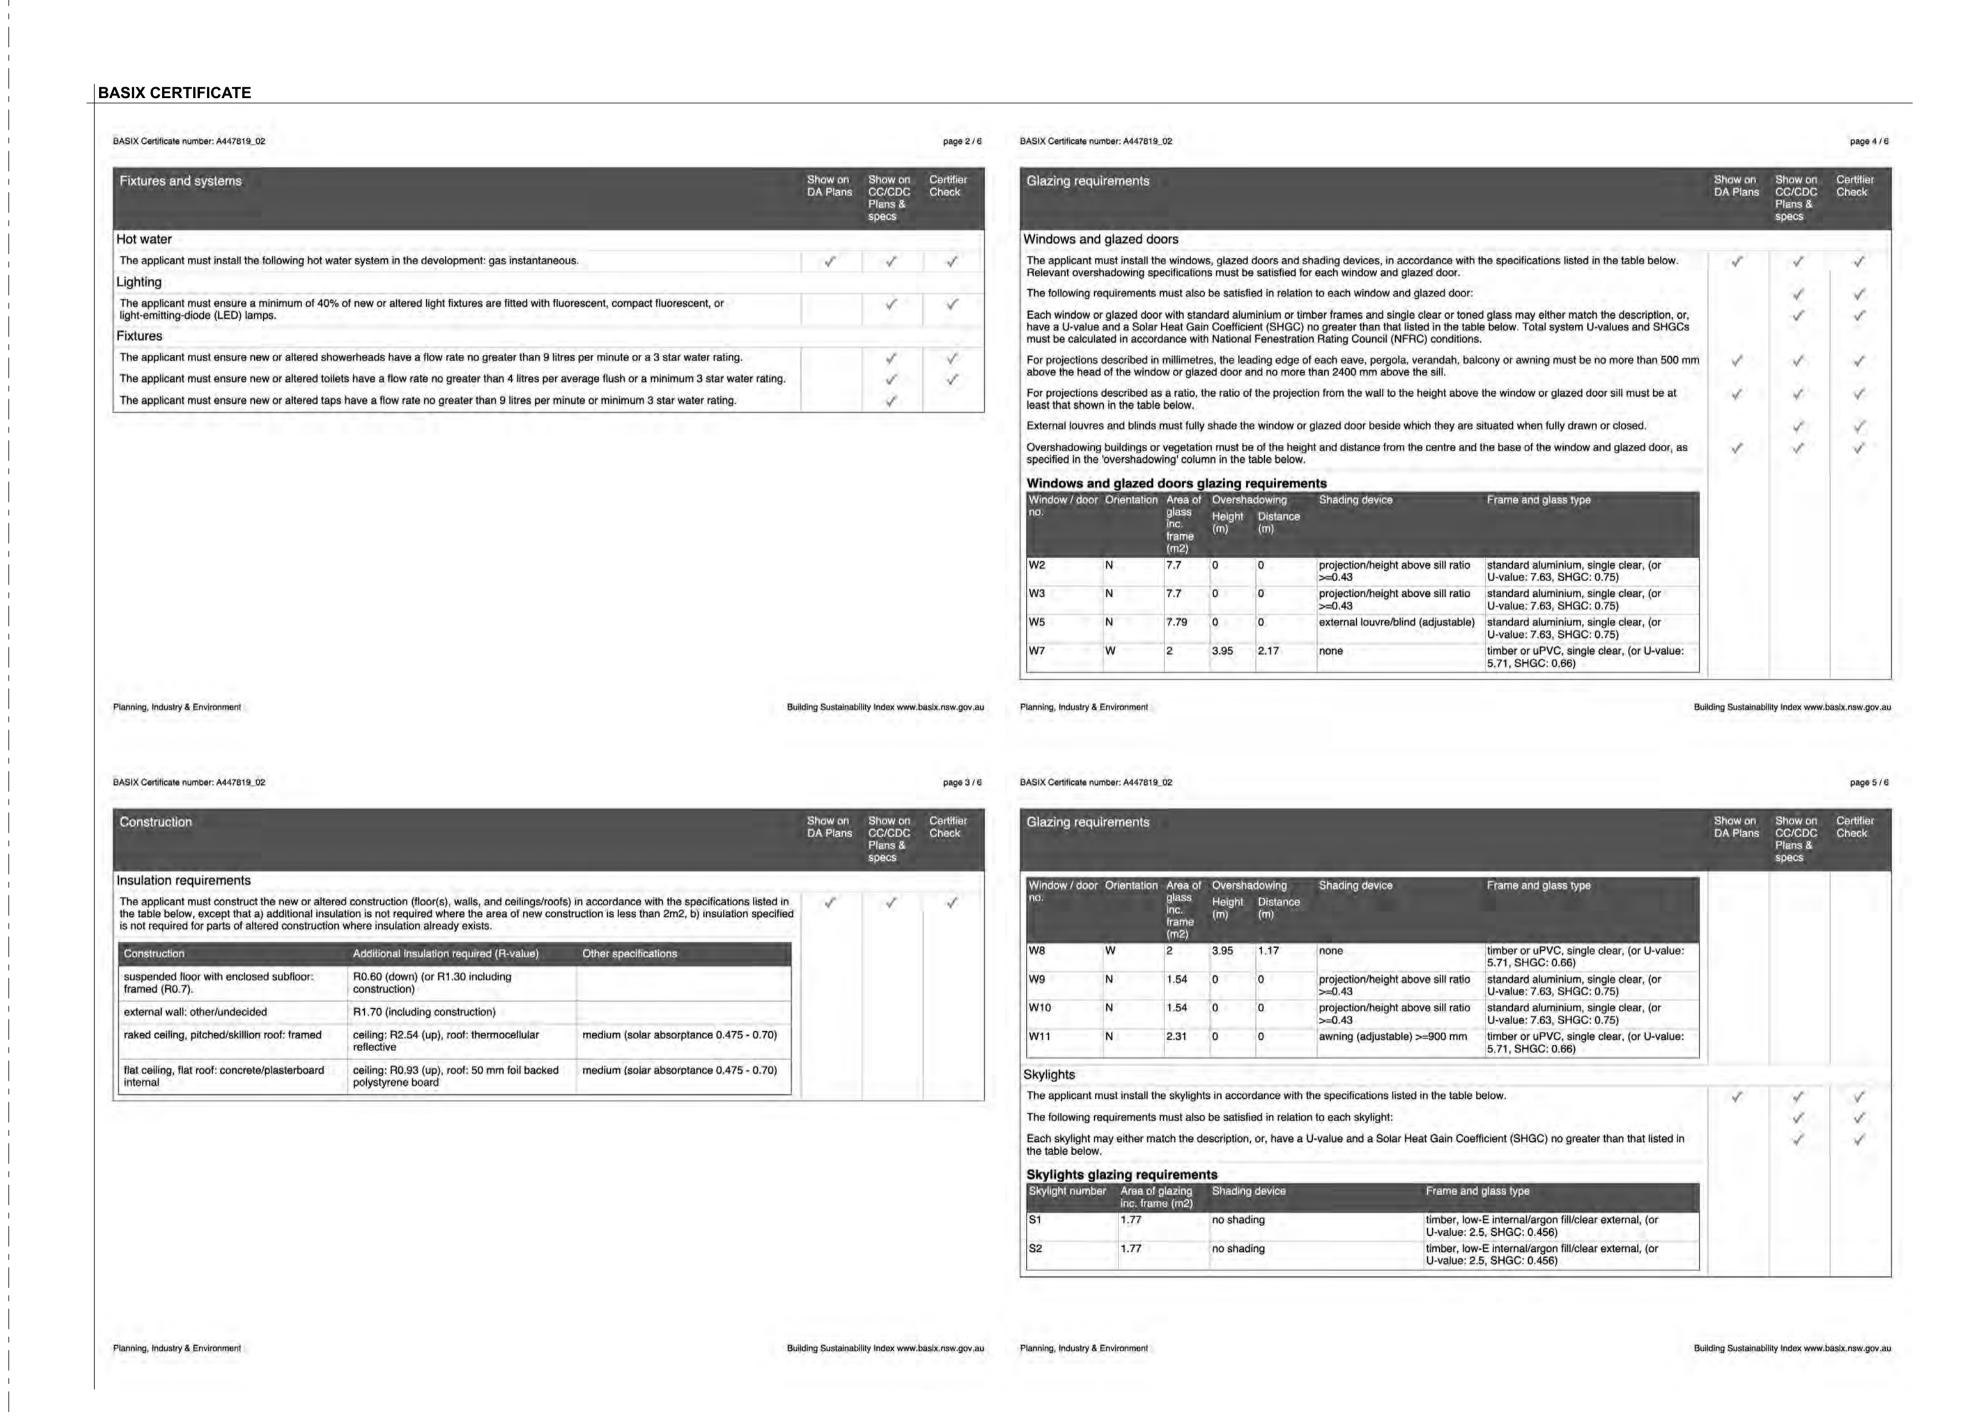

SITE LOCATION PLAN (NTS)



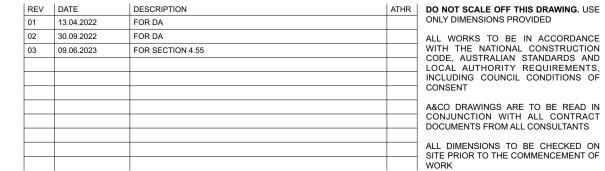



CLIENT:
Tom Snow & Doug Pengilly
PROJECT:
0572 - Victoria Street
74 Victoria Street
Waverley,
NSW 2024

DRAWING TITLE
REFERENCE
COVER PAGE

SCALE @ A1 / A3 CHECKED 1:50 / 1:(SCALEX2) JB
PROJECT NO. - DWG NO._REV.
0572 - DA00_03

O'DOWD STREET (6.095 WIDE) INSPECTION DRAINAGE PIT TK 88.36 RL GRATE 88.16 RL ELECTRIC. TELSTRA POLE 88.34 VEHICLE CROSSING CONCRETE KERB VEHICLE CROSS 88.33 BRICK WALL **DP 857358 ONE STOREY BRICK RESIDENCE** FLOOR LEY NO.72 *88.23 RL 88.42 RL DP 74389 FLOOR LEVEL PATIO DOOR FL 88.51 RL HEAD 90.75 RL PAVED 88.51 RL COURTYARD INGROUND SWIMMING POOL RETAIN EXISTING BIN STORE LOCATION SILL 90.12 RL-FLOOR LEVEL HEAD 90.80 RL 87.34 RL WINDOW SILL 89.94 RL HEAD 90.55 RL PAVED WINDOW SILL 89.36 RL HEAD, 90.81 RL COURTYARD RETAINING EXISTING WASTE COLLECTION POINT ON VICTORIA STREET, RATAIN EXISTING TRANSFER ROUTE OF BINS SHOWN DASHED SEALED **TWO STORY** ONSITE STORAGE & COLLECTION OF WASTE + RECYCLABLES DURING DEMOLITION RENDERED RESIDENCE WINDOW SILL 91.14 RL NO.51 HEAD 92.85 RL WINDOW SILL 90.04 RL HEAD 91.96 RL (0.015 CLEAR) FLOOR LEVEL FLOOR LEVEL WINDOW 87.235 RL SILL 91.42 RL 86.84 RL HEAD 92.30 RL TWO STORY FLOOR LEVEL * 87.26 RL RENDERED WALL ON BDY DP 857358 RESIDENCE 672.1M² NO.74 FLOOR LEVEL / AREAS 86.83 RL FLOOR LEVEL FLOOR LEVEL ATTIC 94.74 RL | 87.24 RL VER. FL BAL. FL VERANDAH/BALCONY 87.07 RL 91.18 RL L 29 AREA DRAINAGE PIT GARAGE TK 85.77 RL TERRACE FL. GRATE 85.60 RL 86.74 RL GARAGE FL 0.1 OVER) 83.68 RL. 86.3, VENT STONE RETAINING WALL SEWER INSPECTION CONCRETE BLOCK RETAINING WALL CONCRETE CONCRETE PATH DRIVEWAY CONCRETE PATH CONCRETE PATH CROSSING 0.7T15H10C 0.4T15H10C **LEGEND** 240L CO-MINGLED YELLOW LID GARBAGE BIN STORAGE AND COLLECTION LOCATION 240L ALL PURPOSE RED LID GARBAGE BIN STORAGE AND COLLECTION LOCATION **WILEY STREET** ONSIDE STORAGE & COLLECTION OF WASTE & RECYCLABLES DURING DEMOLITION AND CONSTRUCTION (20.115 WIDE) VEHICULAR ACCESS DURING CONSTRUCTION TEMPORARY INDOOR WASTE AND RECYCLING SPACE LOCATION

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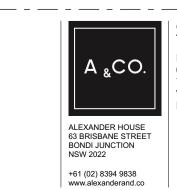
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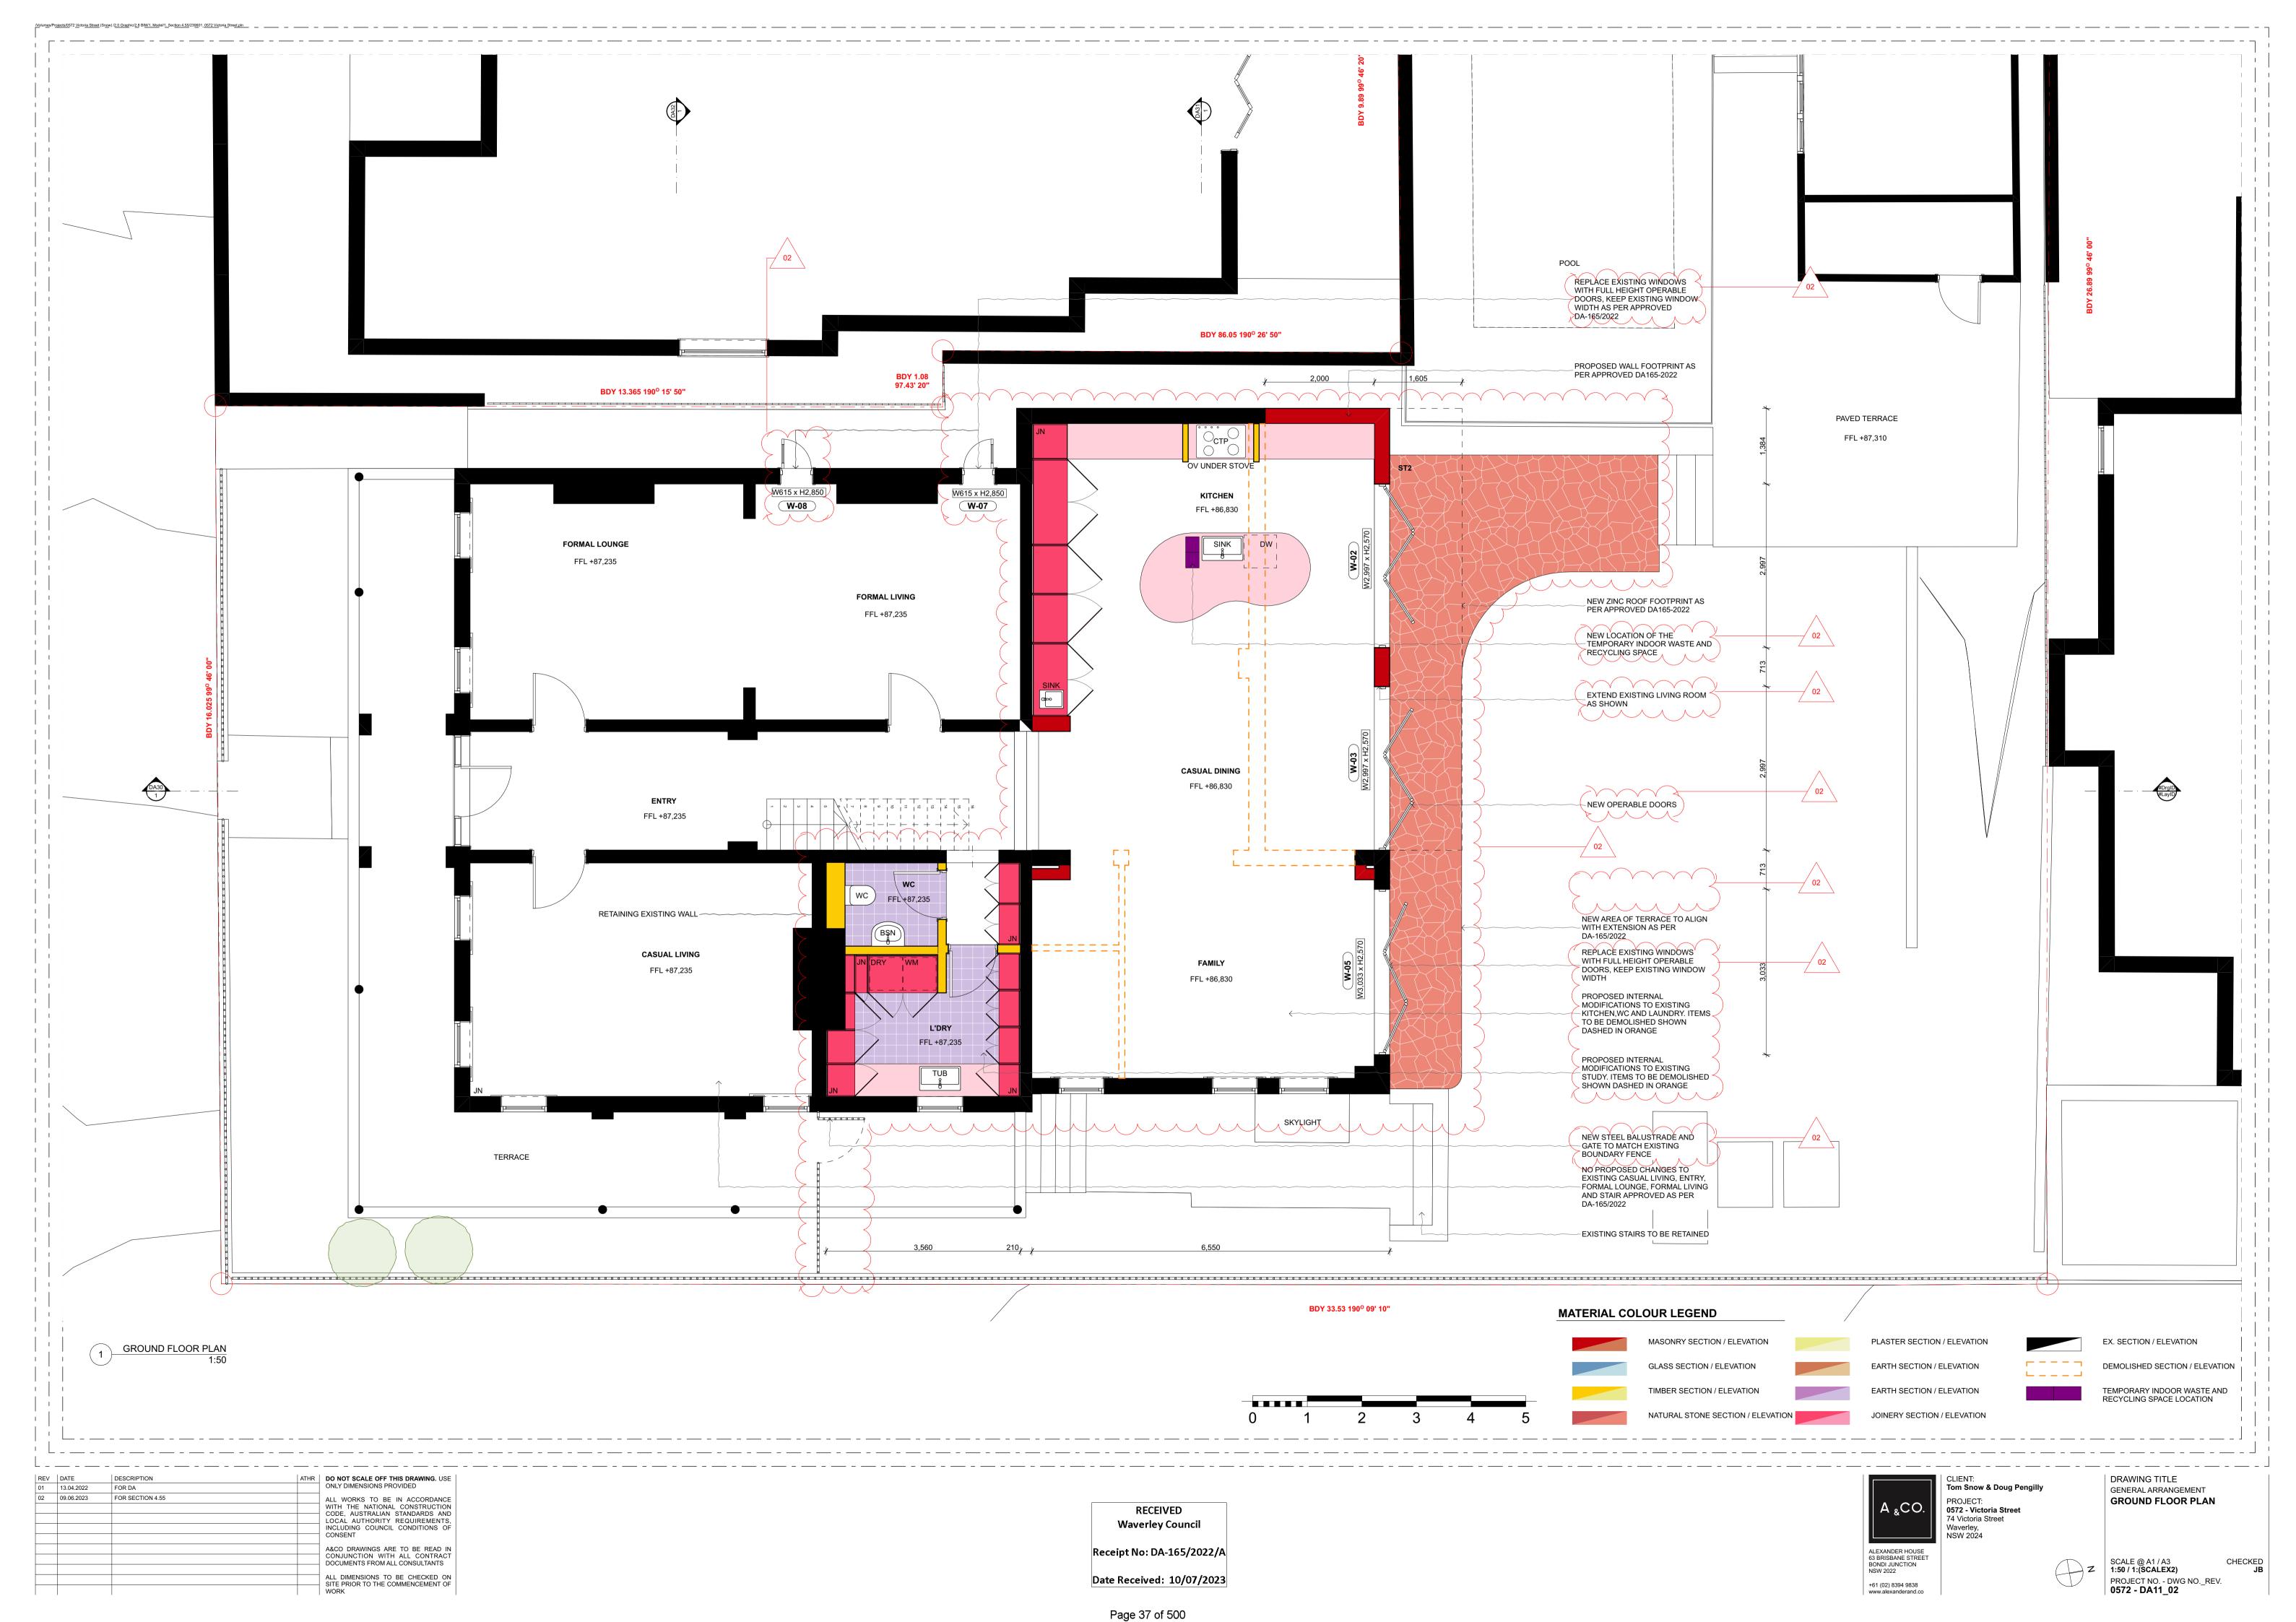



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Tom Snow & Doug Pengilly
PROJECT:
0572 - Victoria Street
74 Victoria Street
Waverley,
NSW 2024


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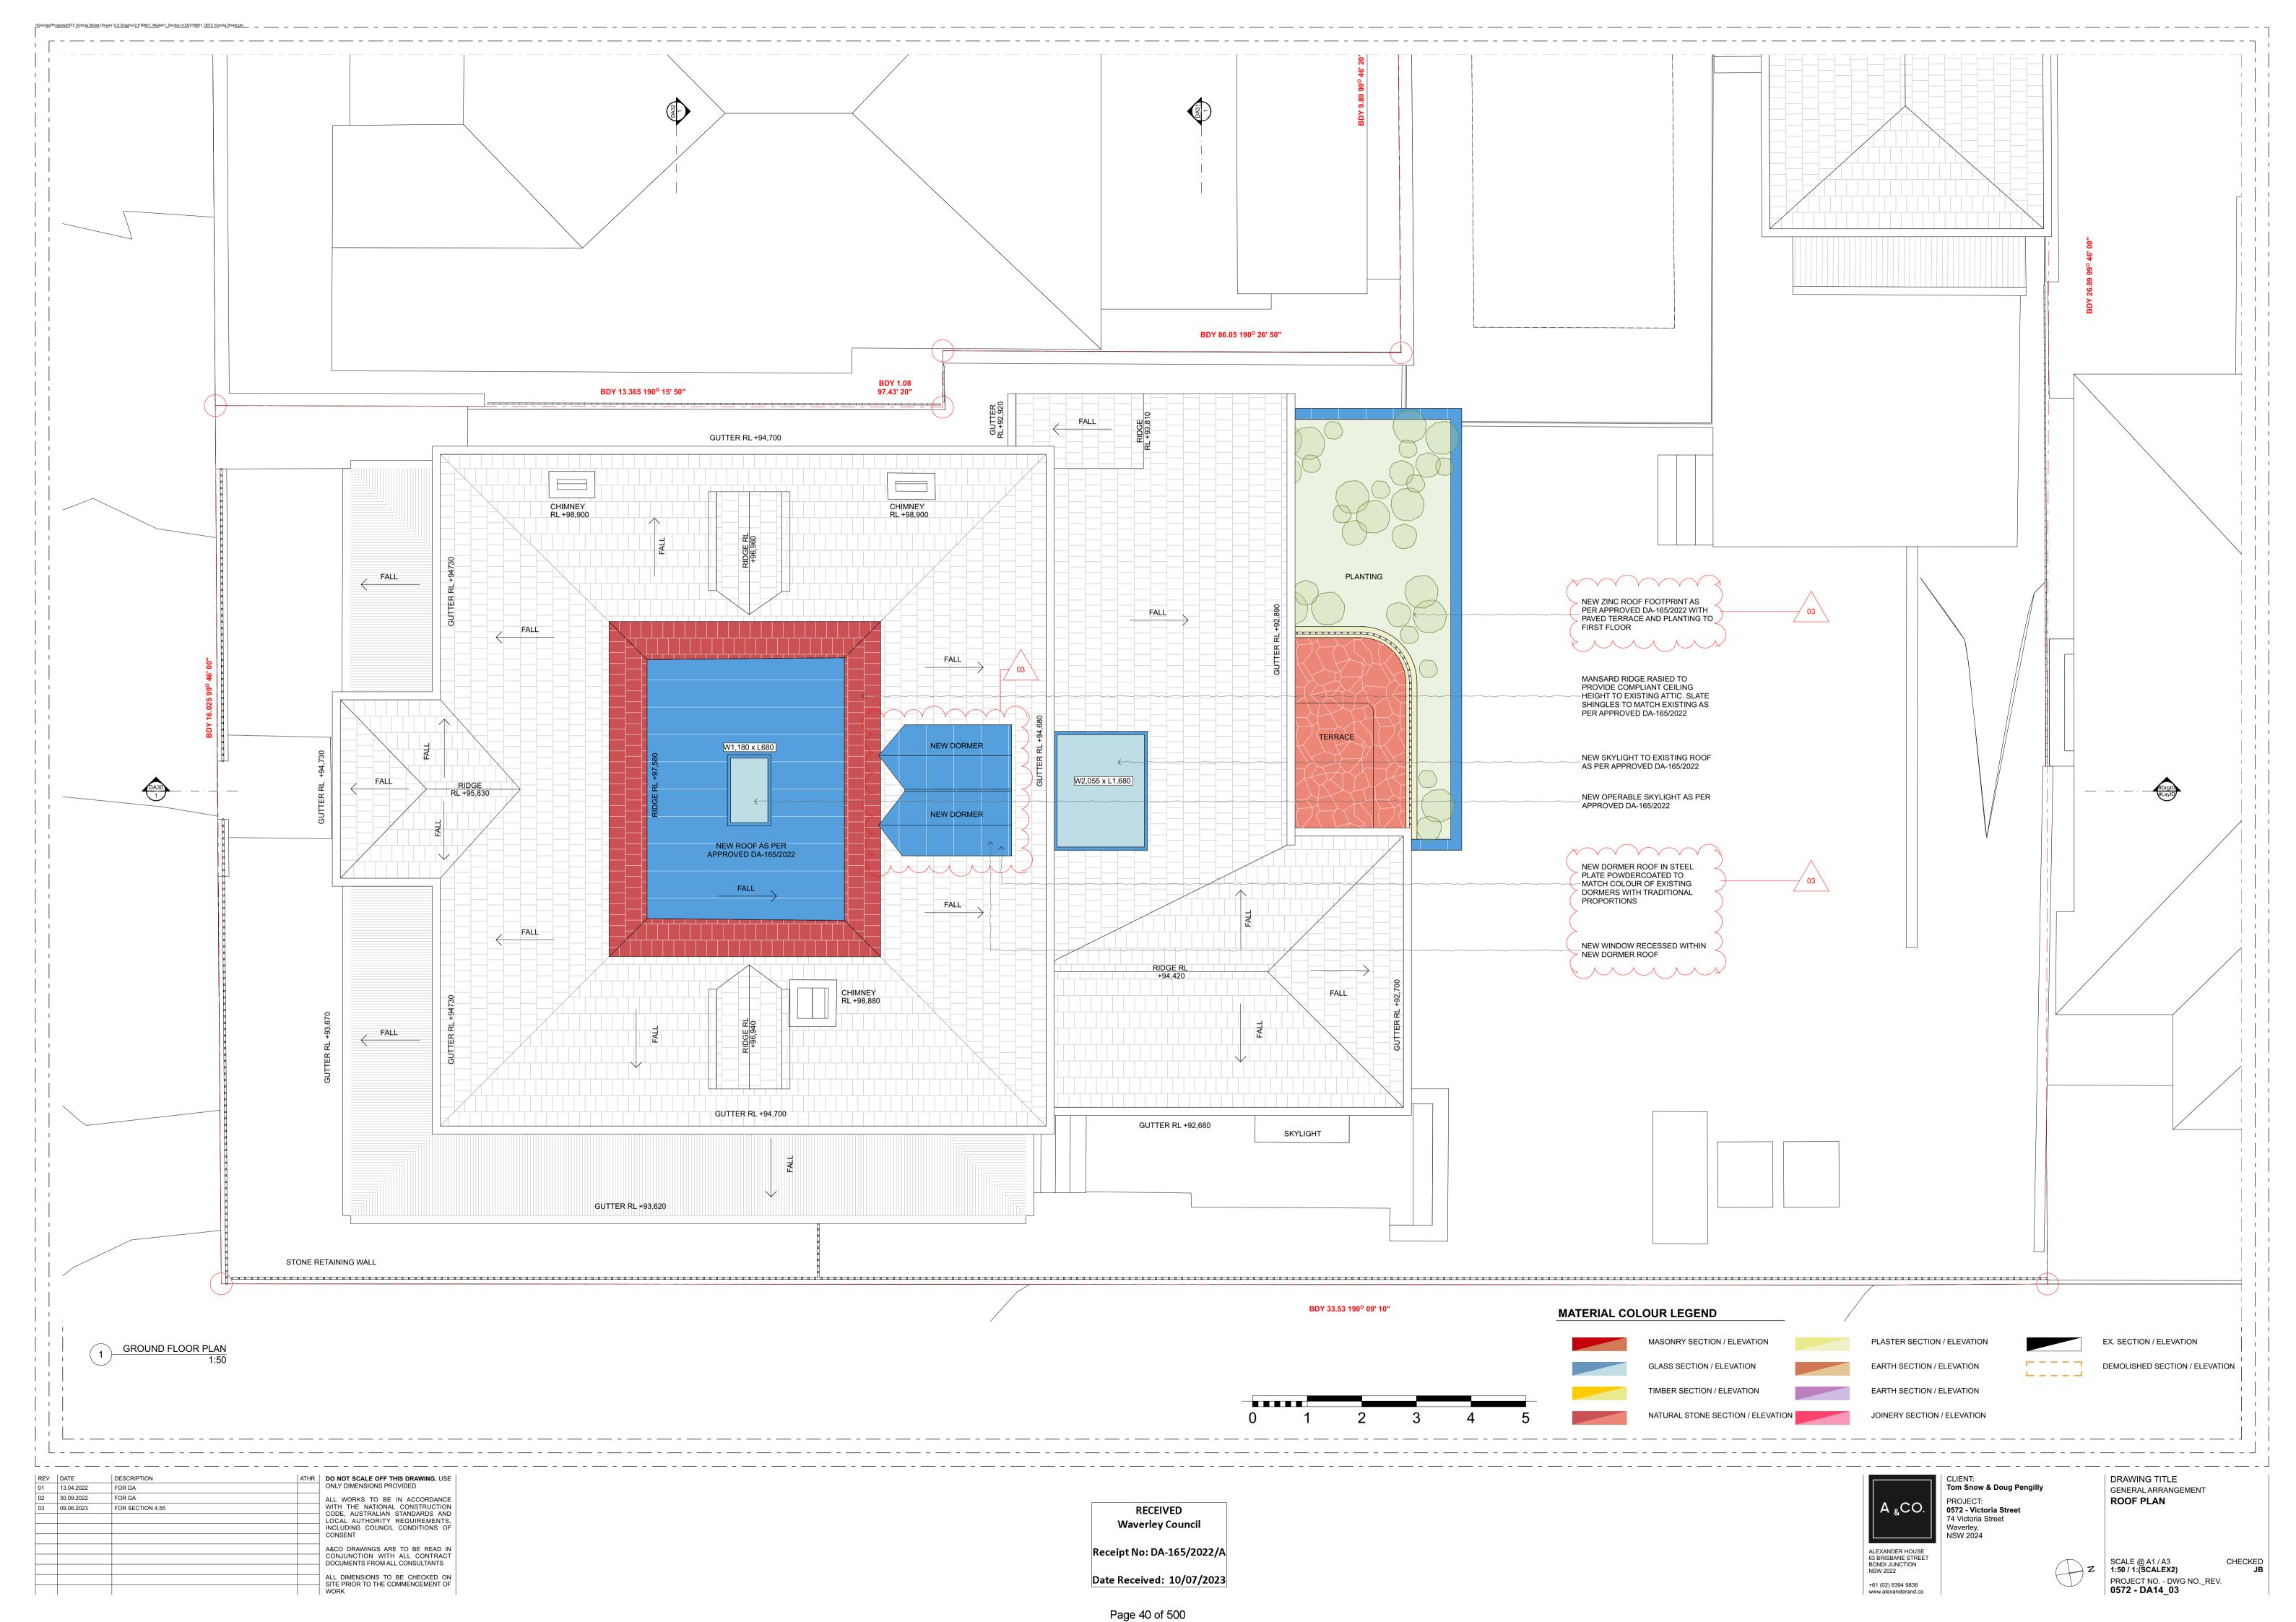
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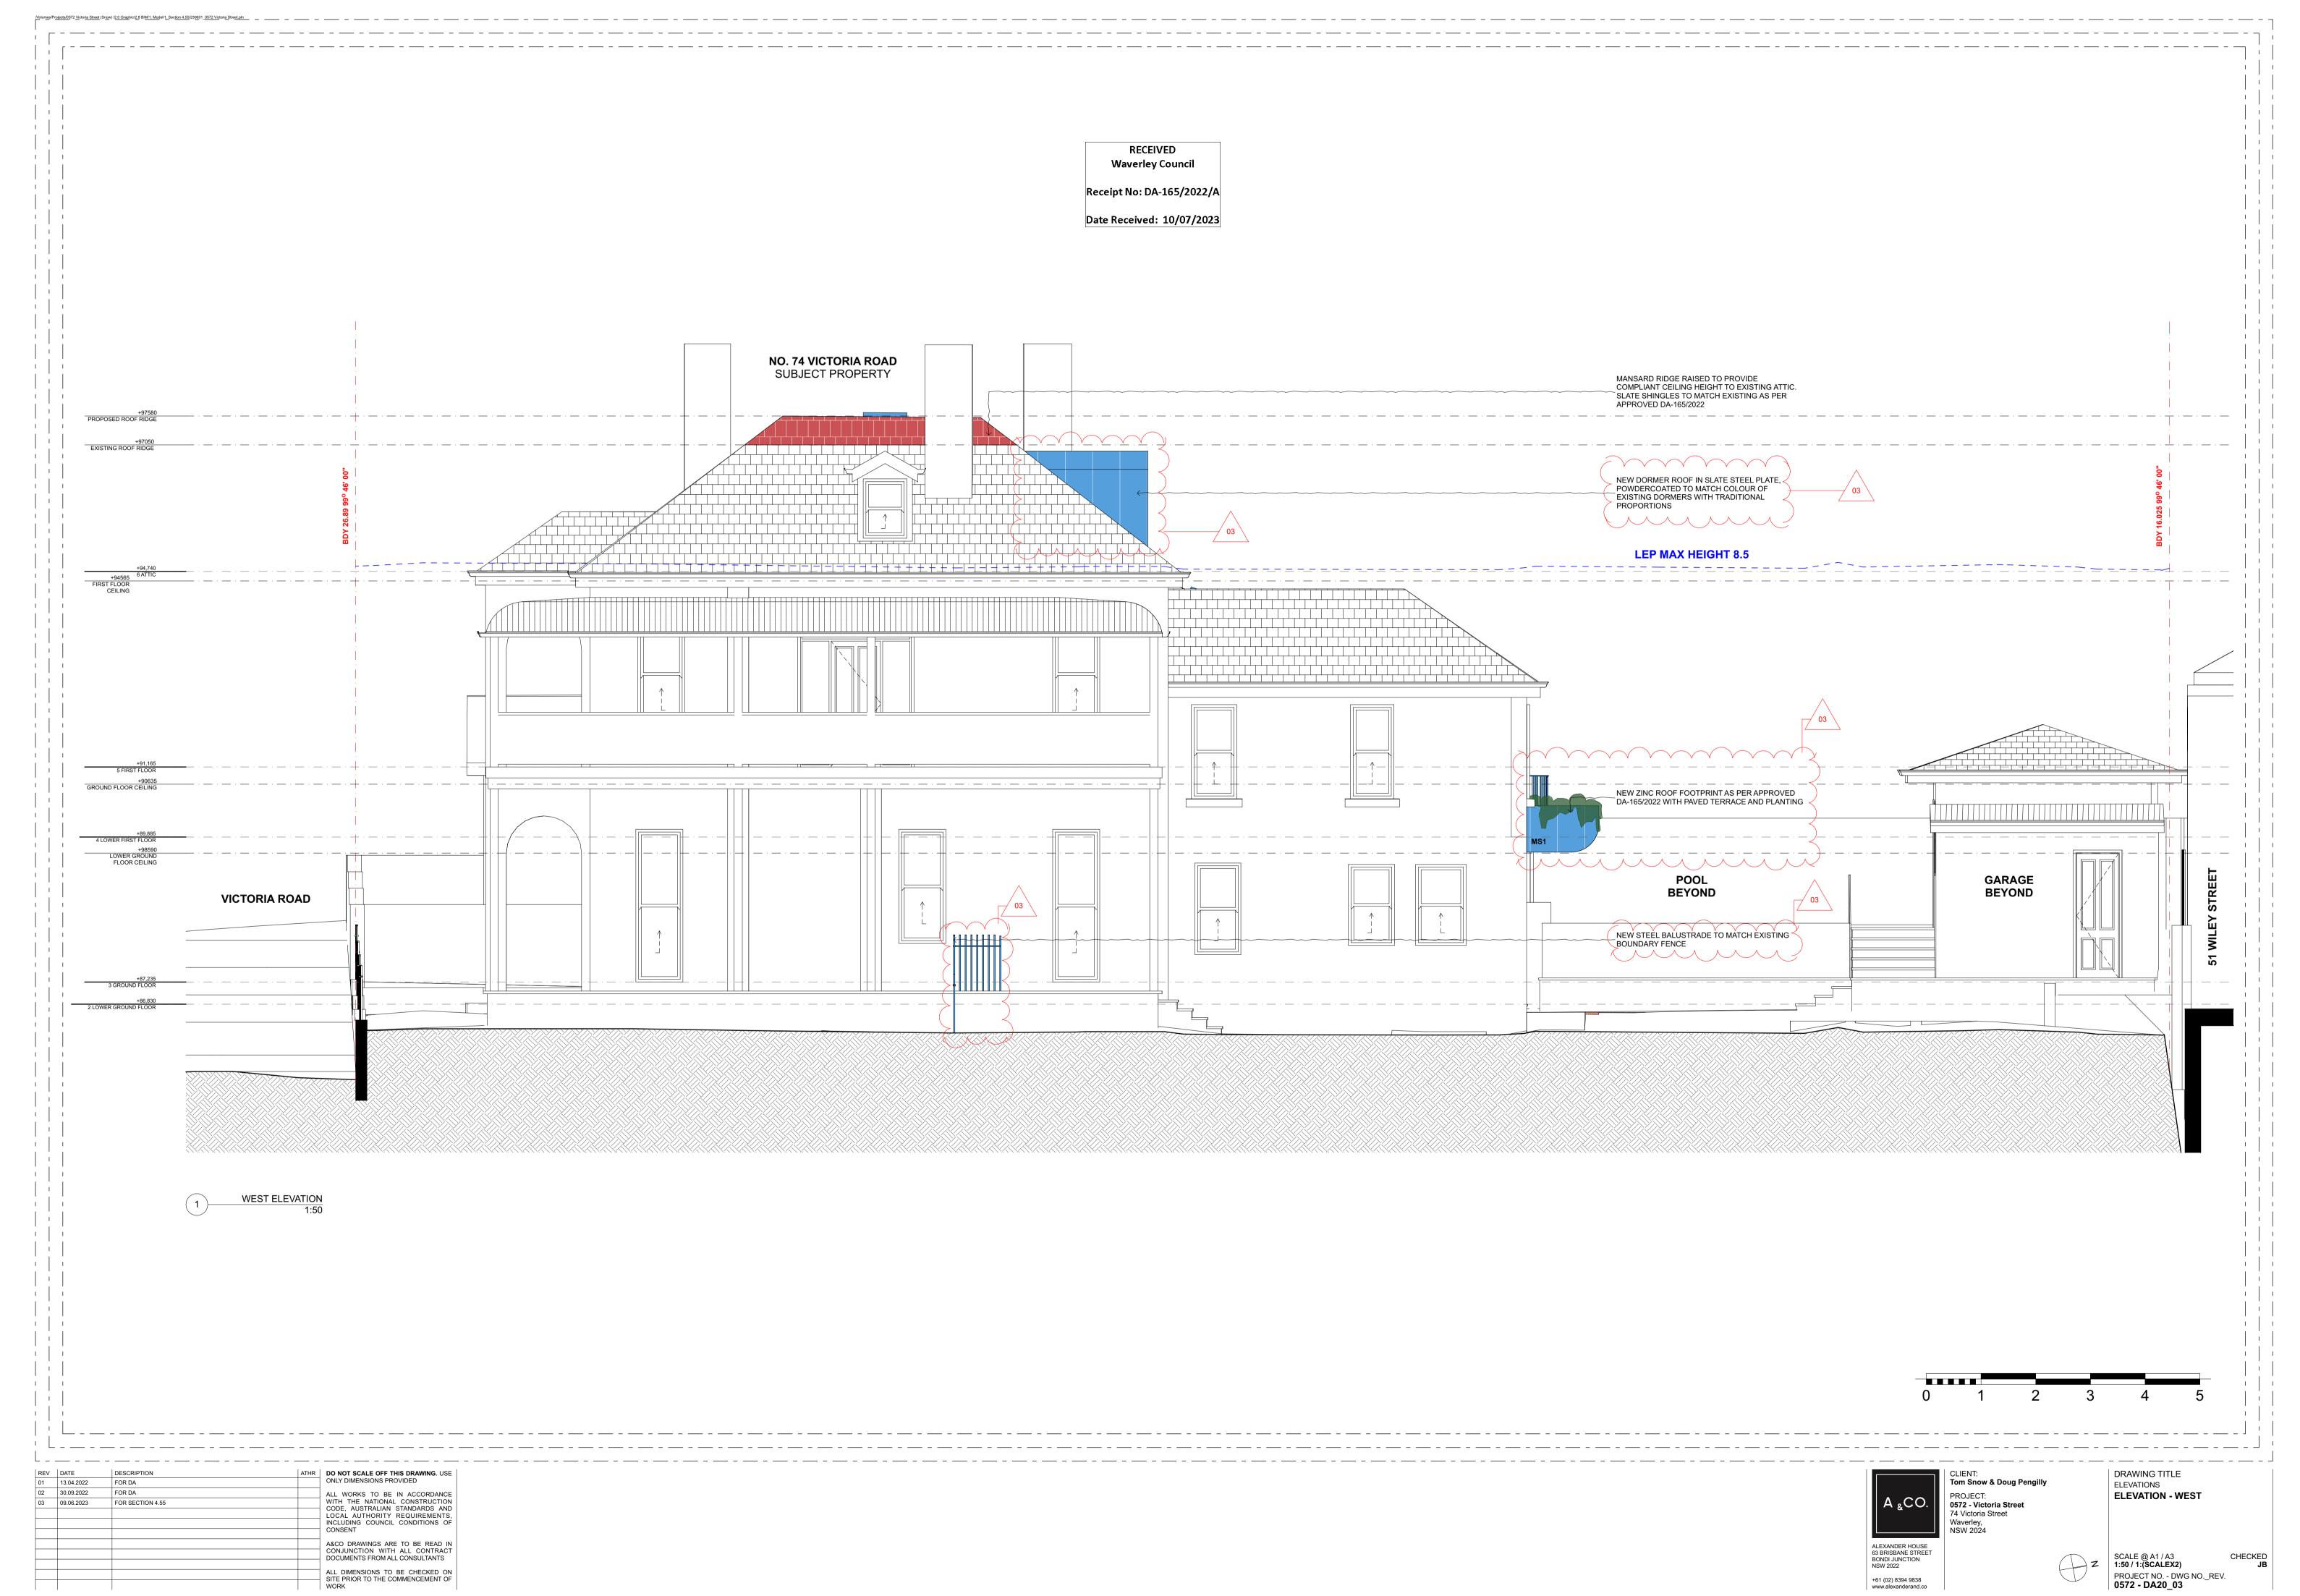
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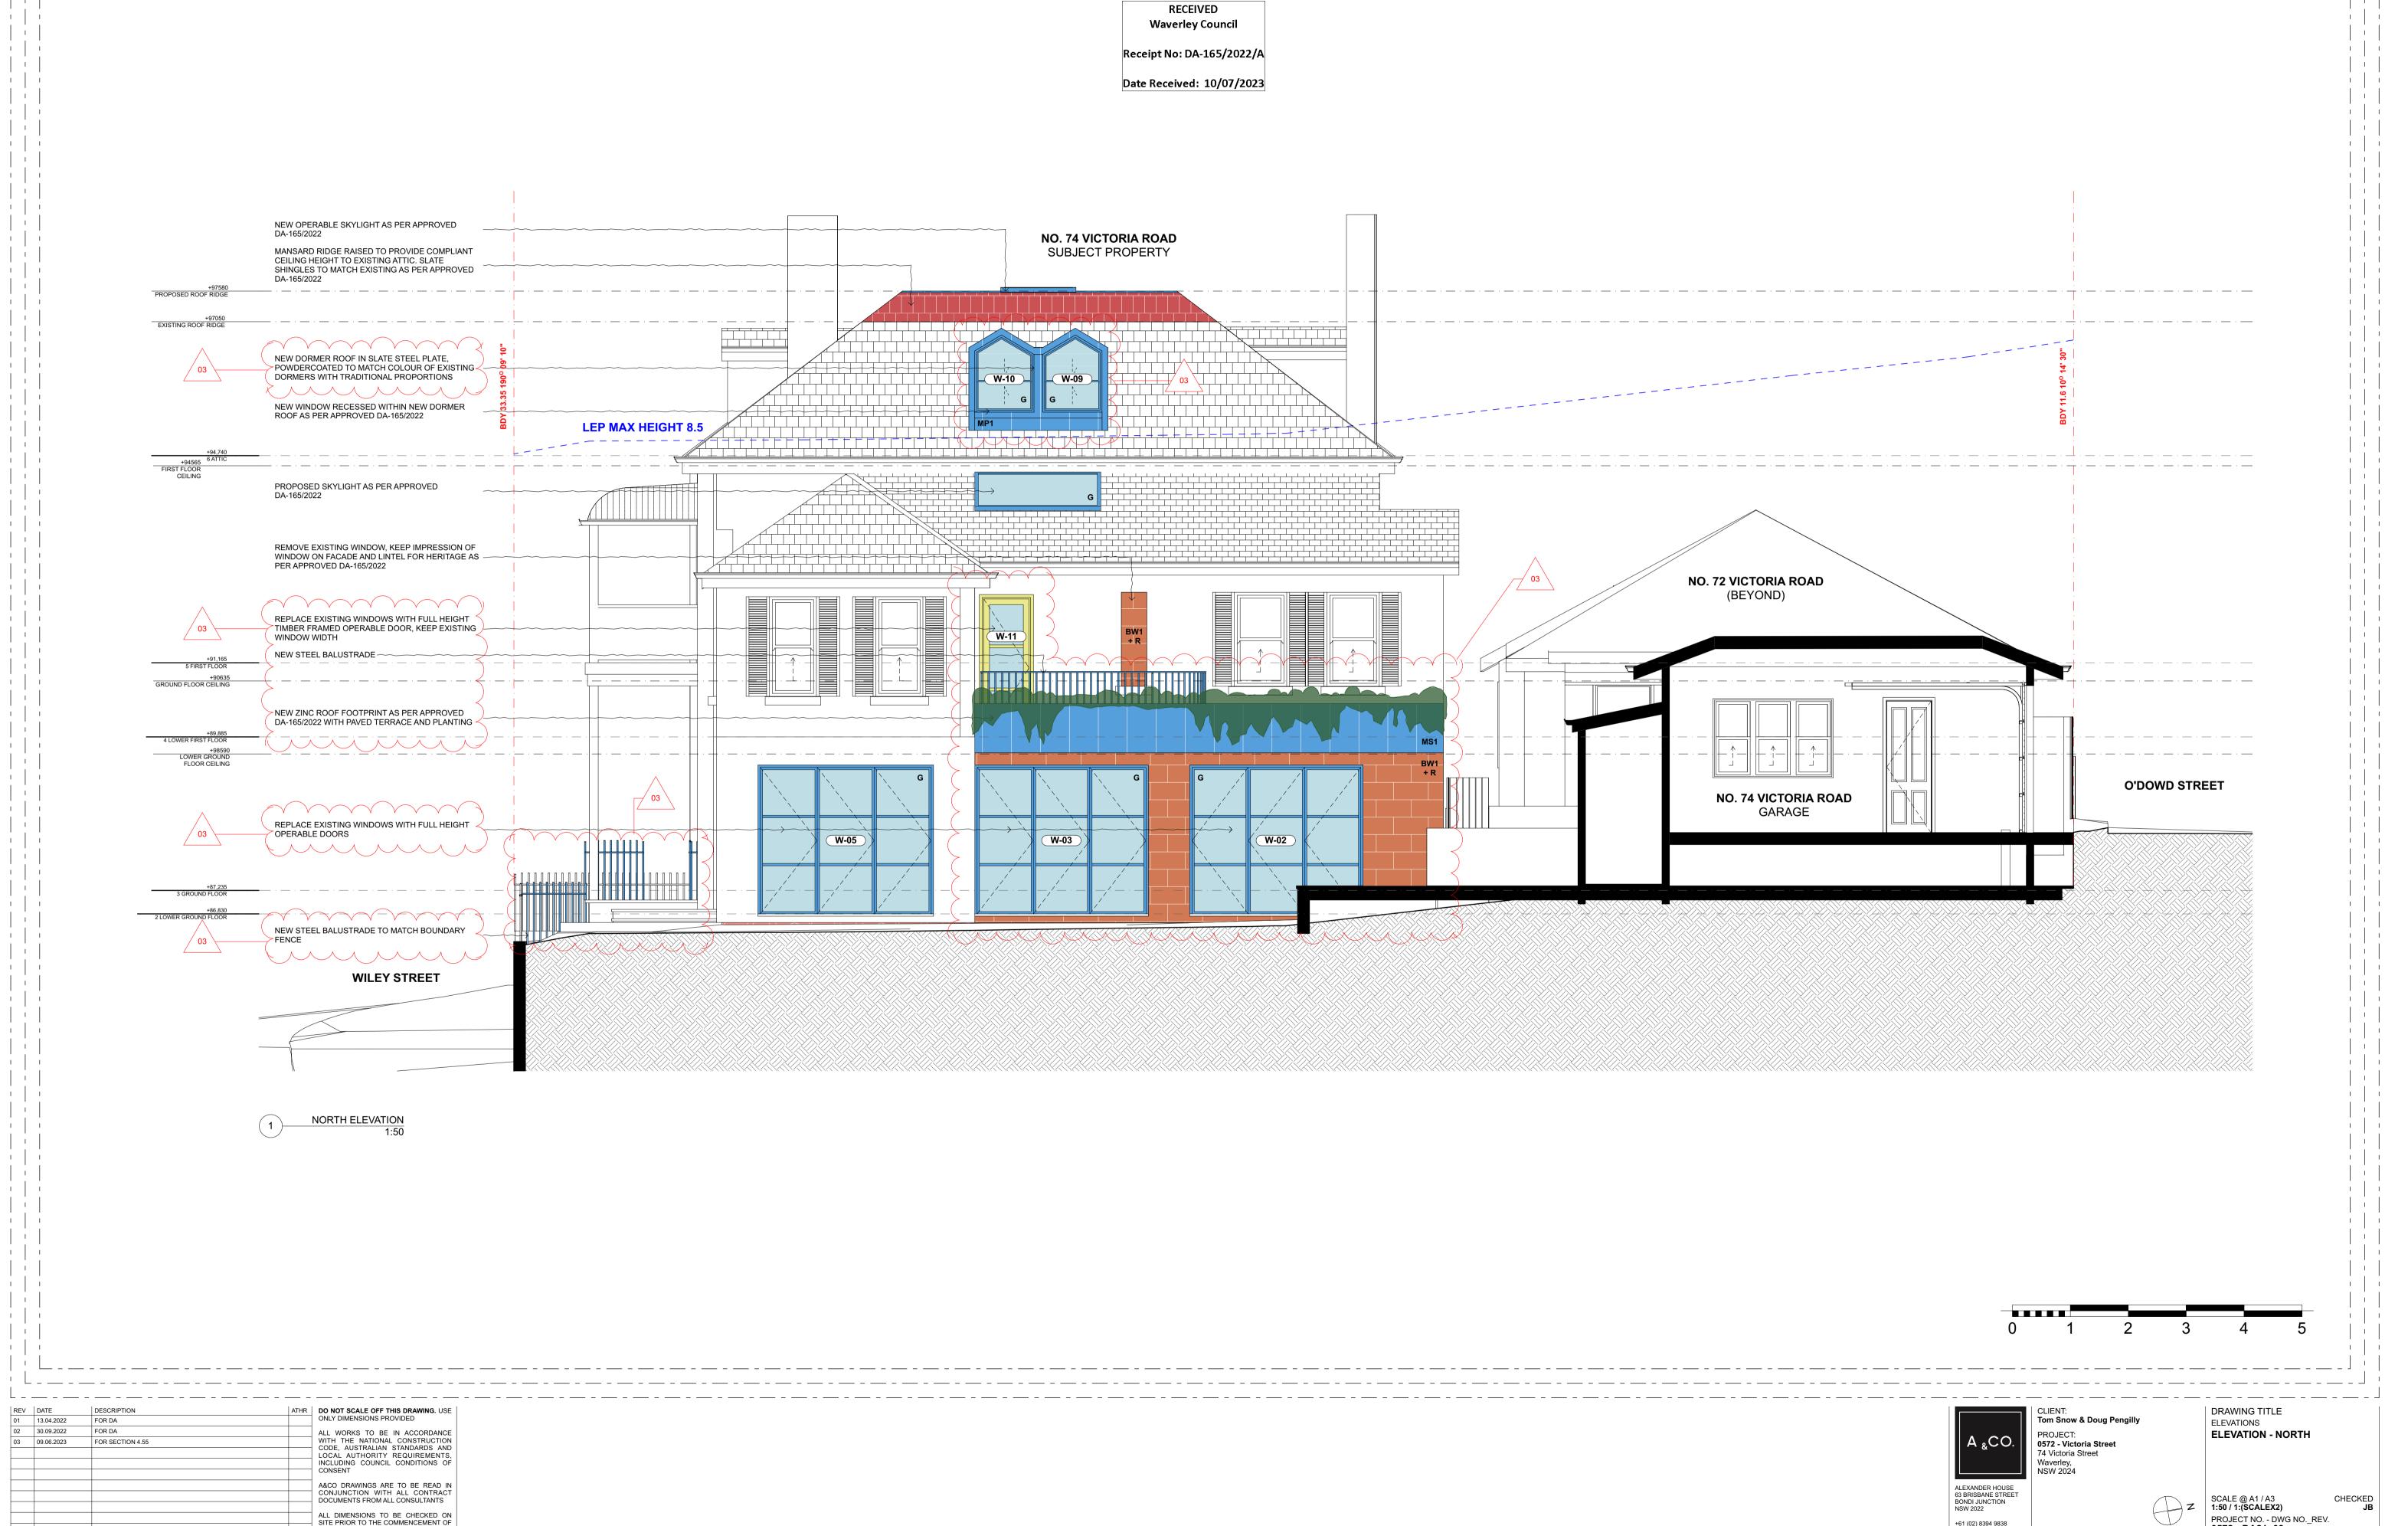








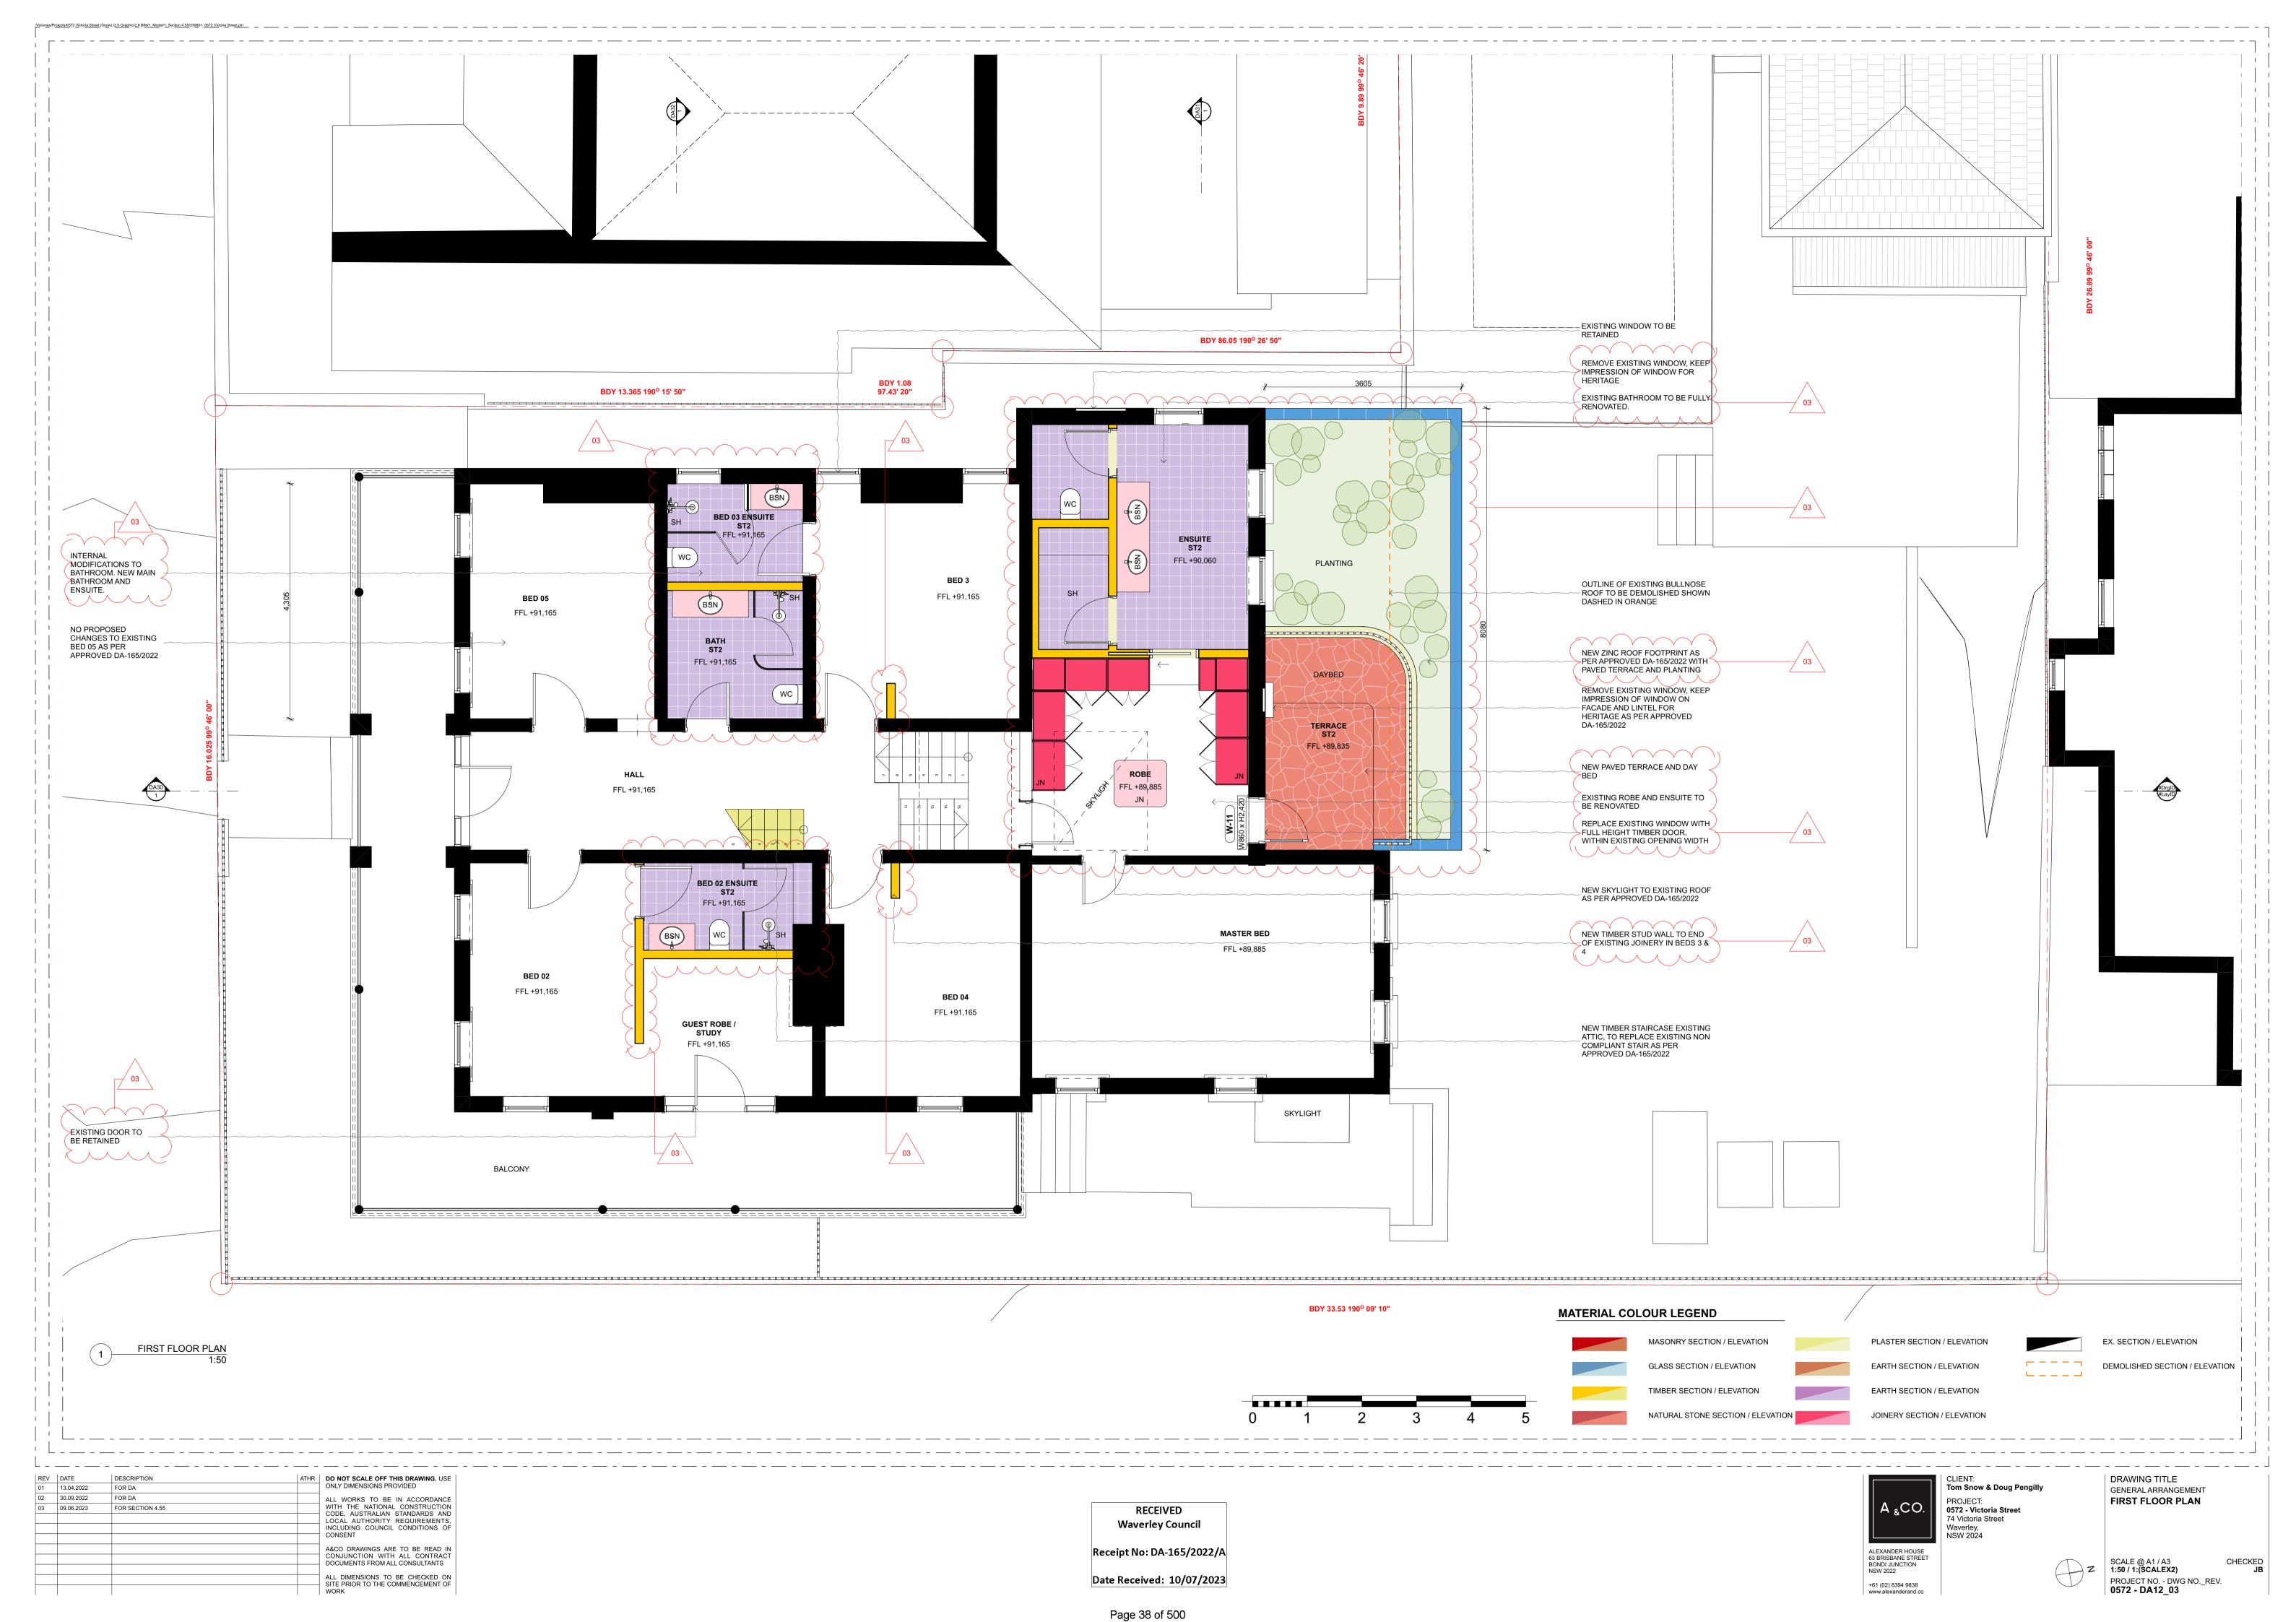

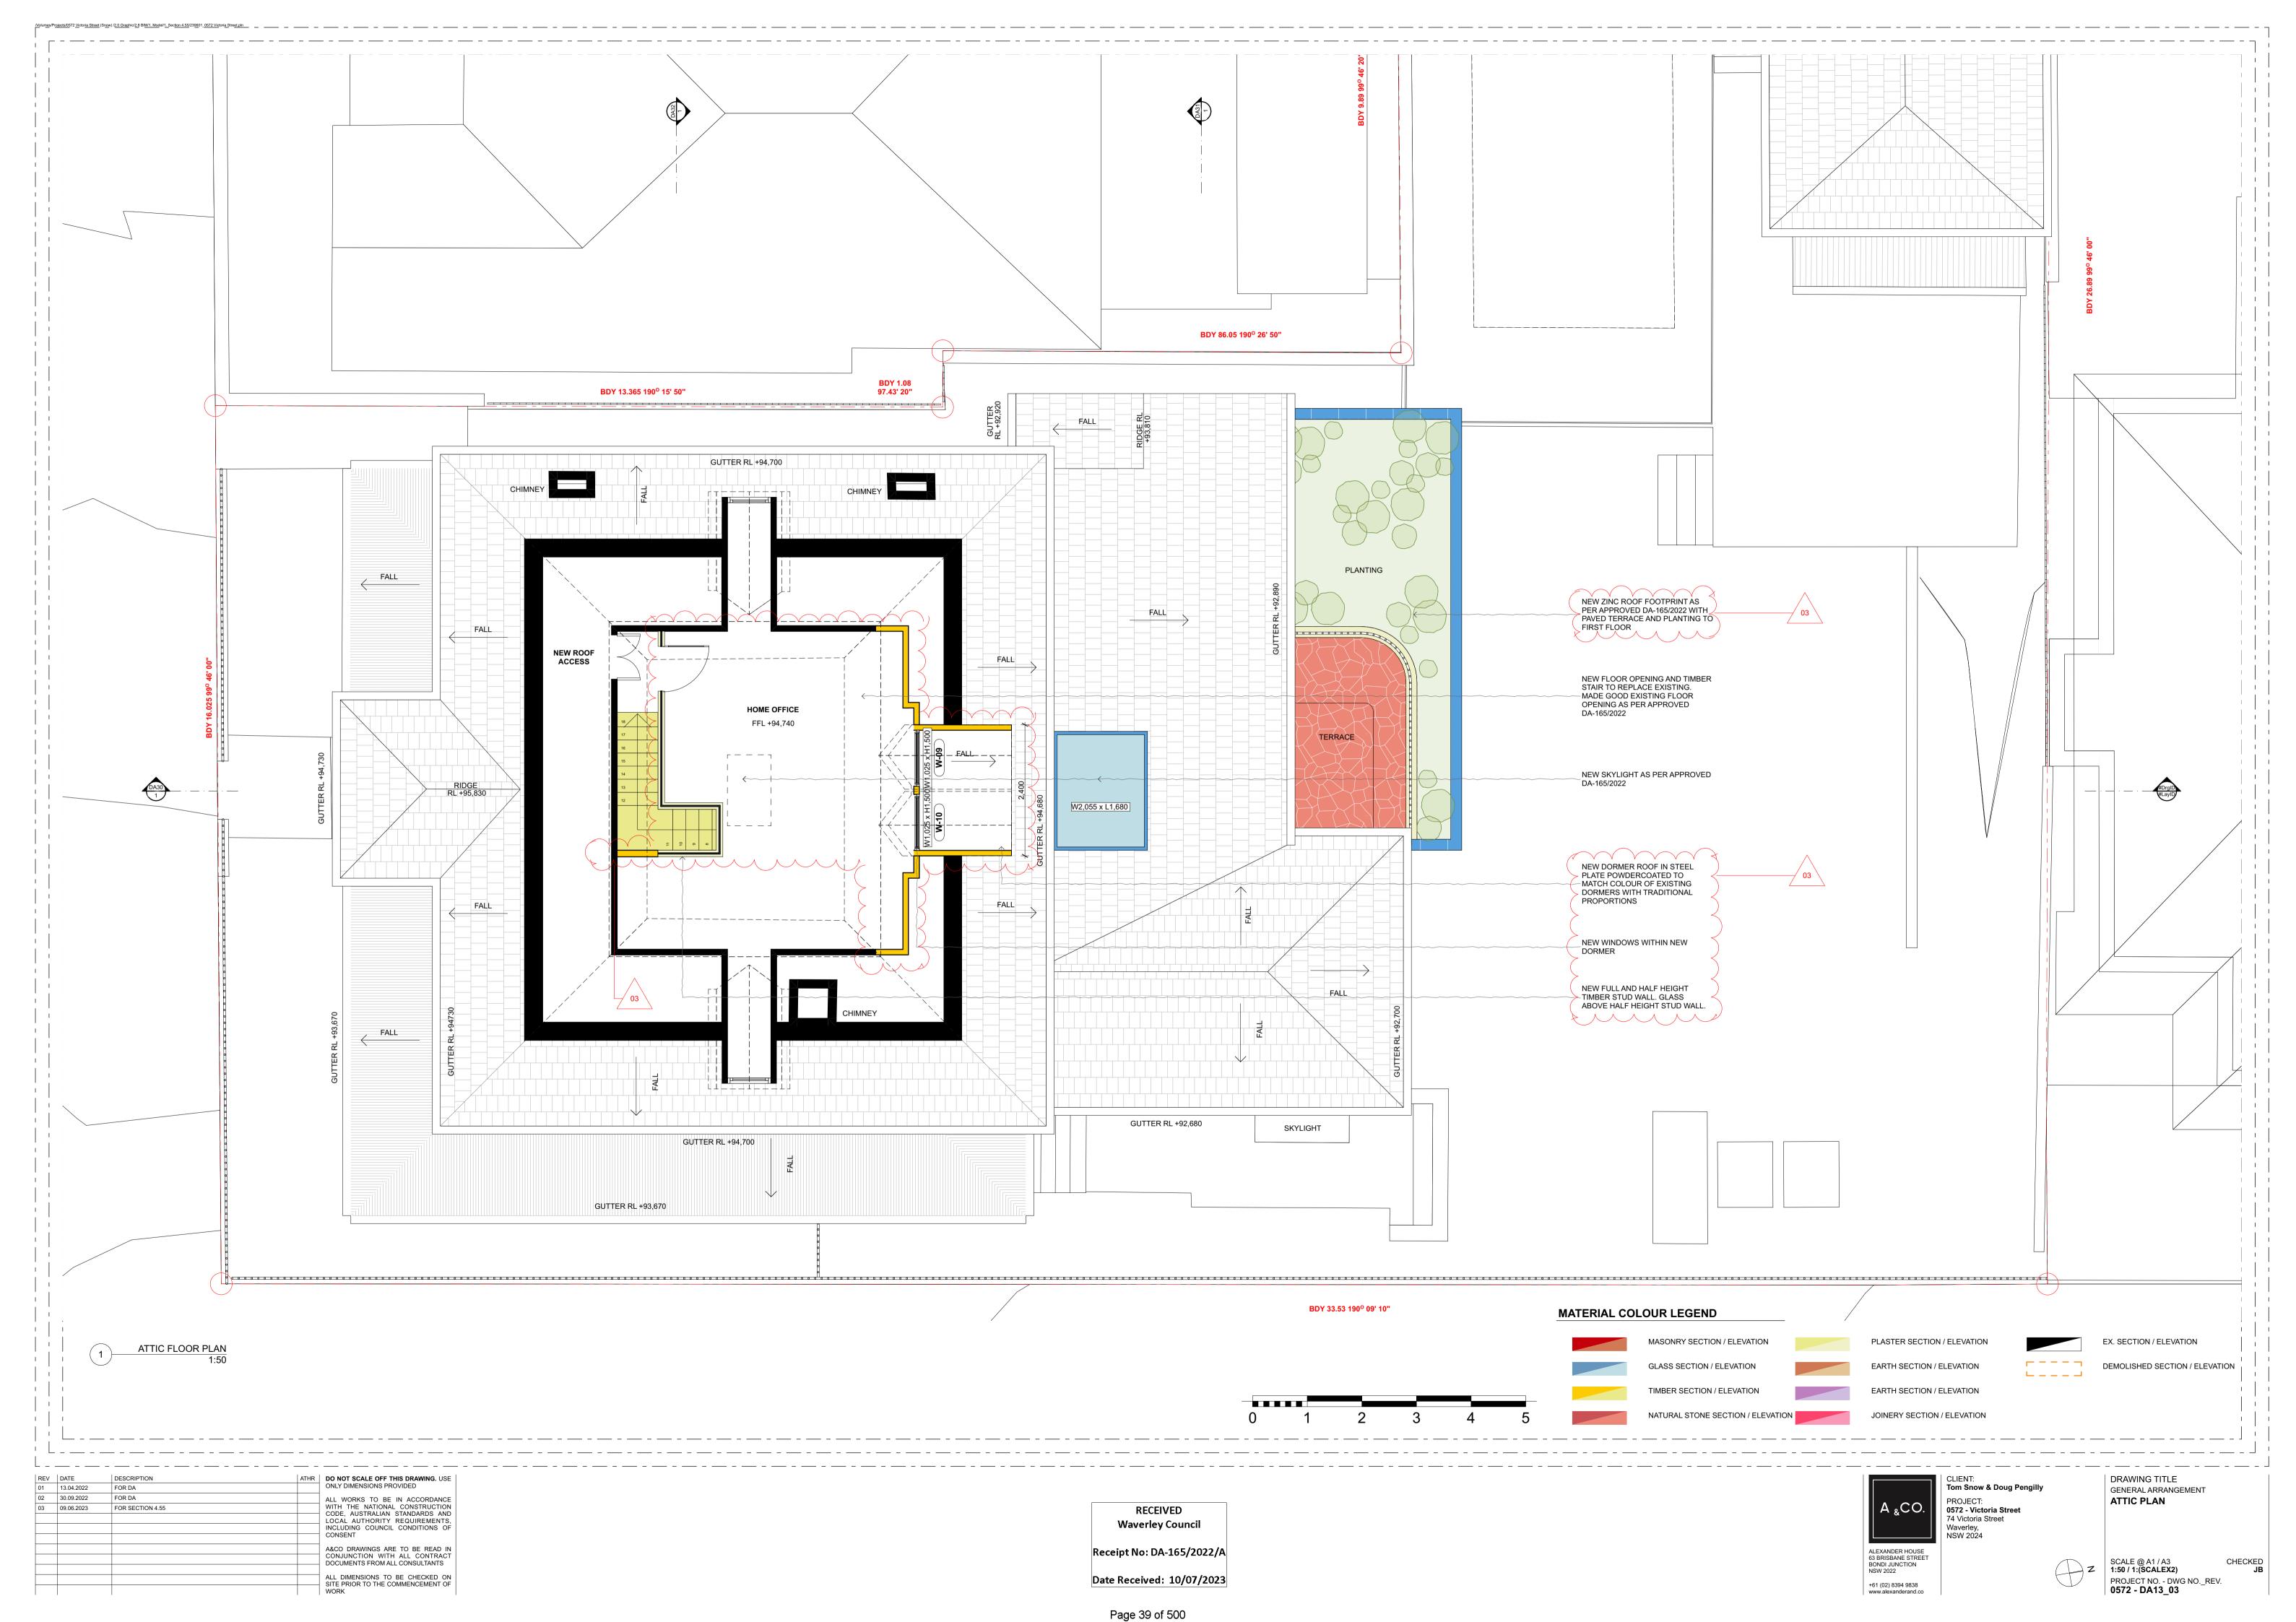

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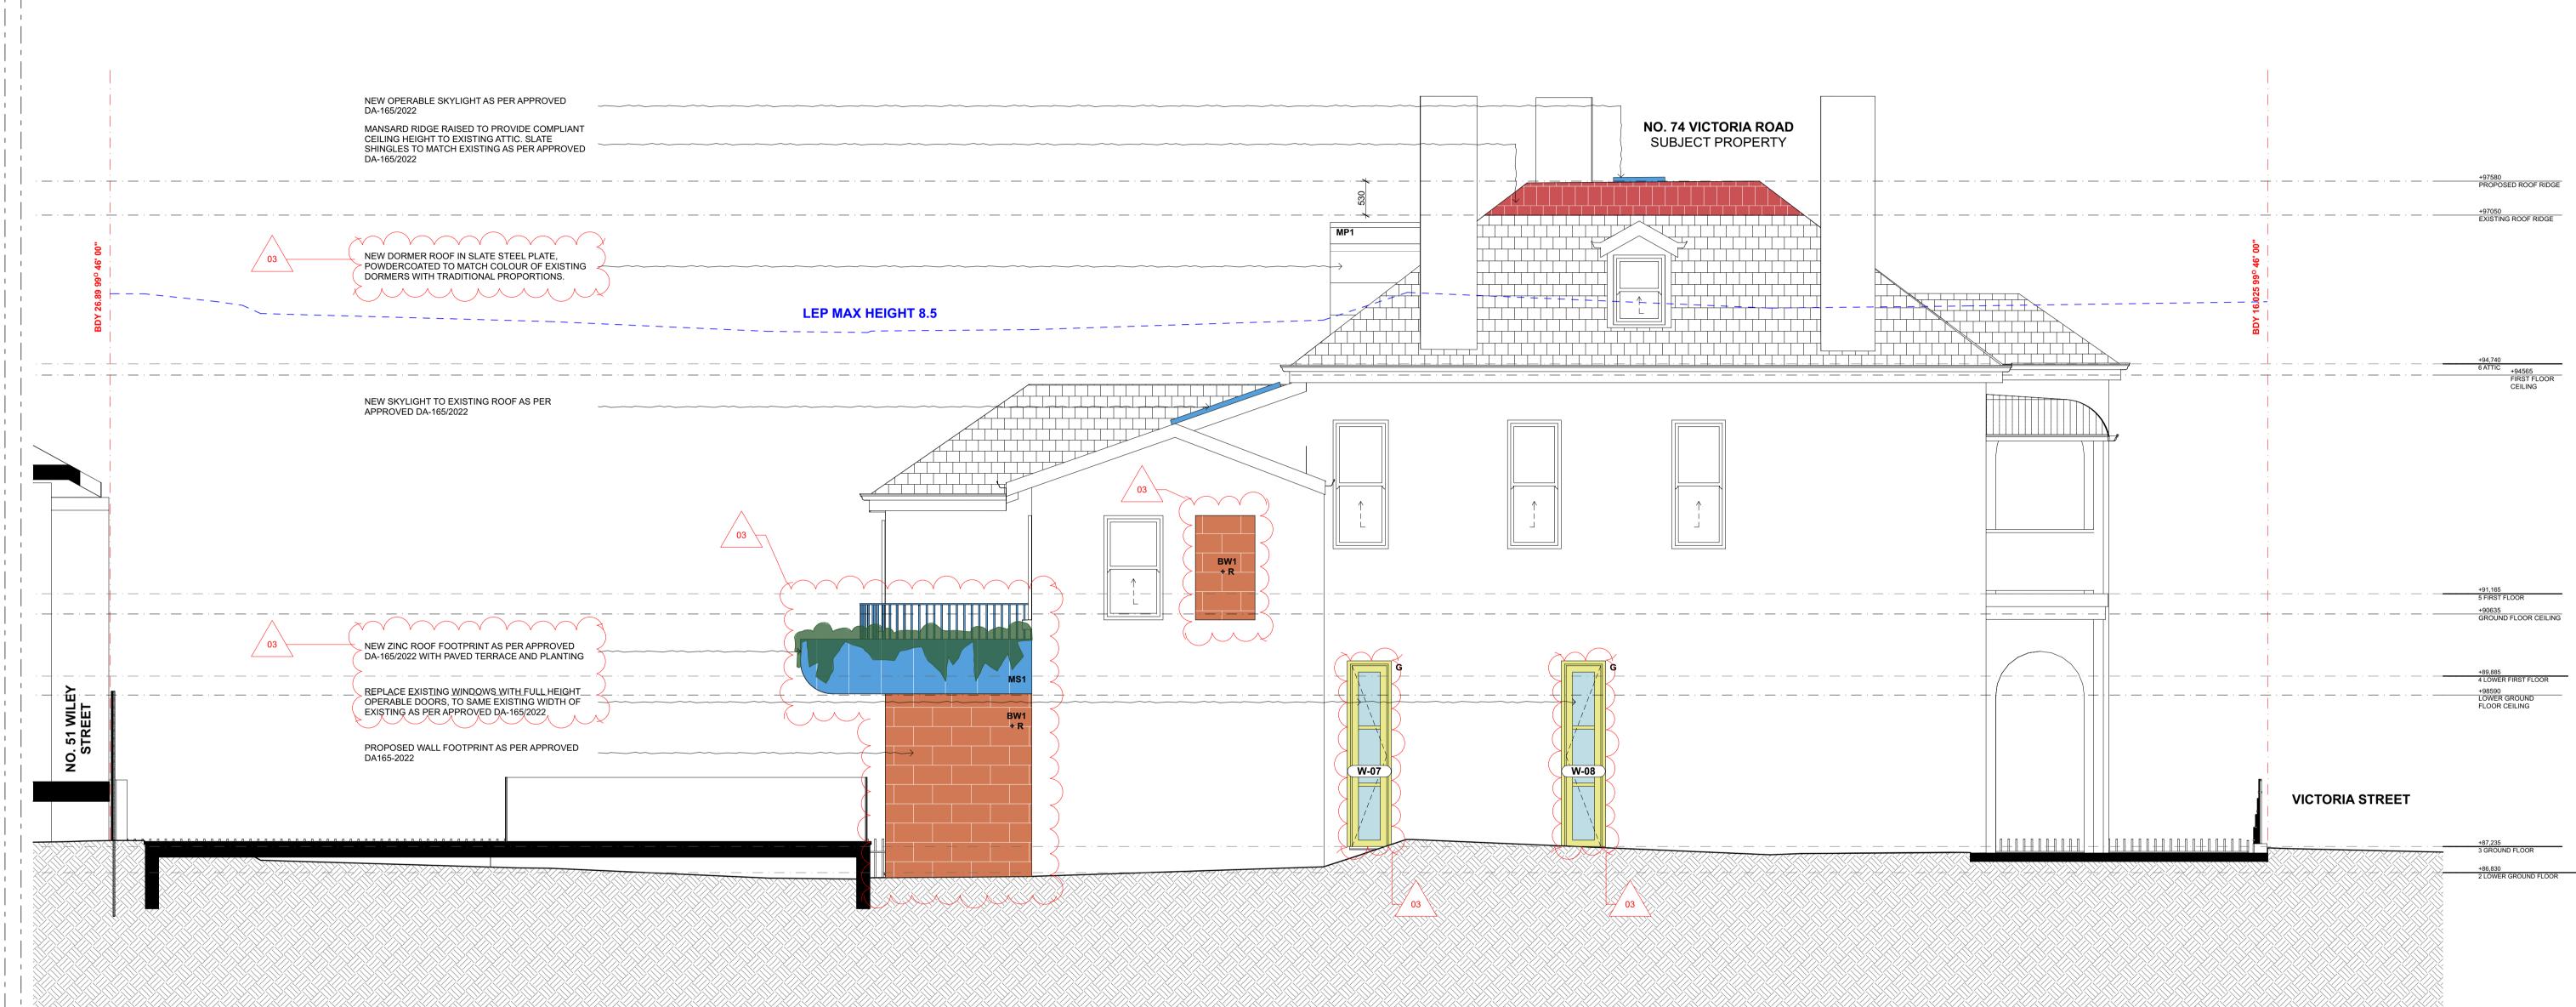
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Tom Snow & Doug Pengilly

PROJECT: 0572 - Victoria Street

74 Victoria Street Waverley, NSW 2024

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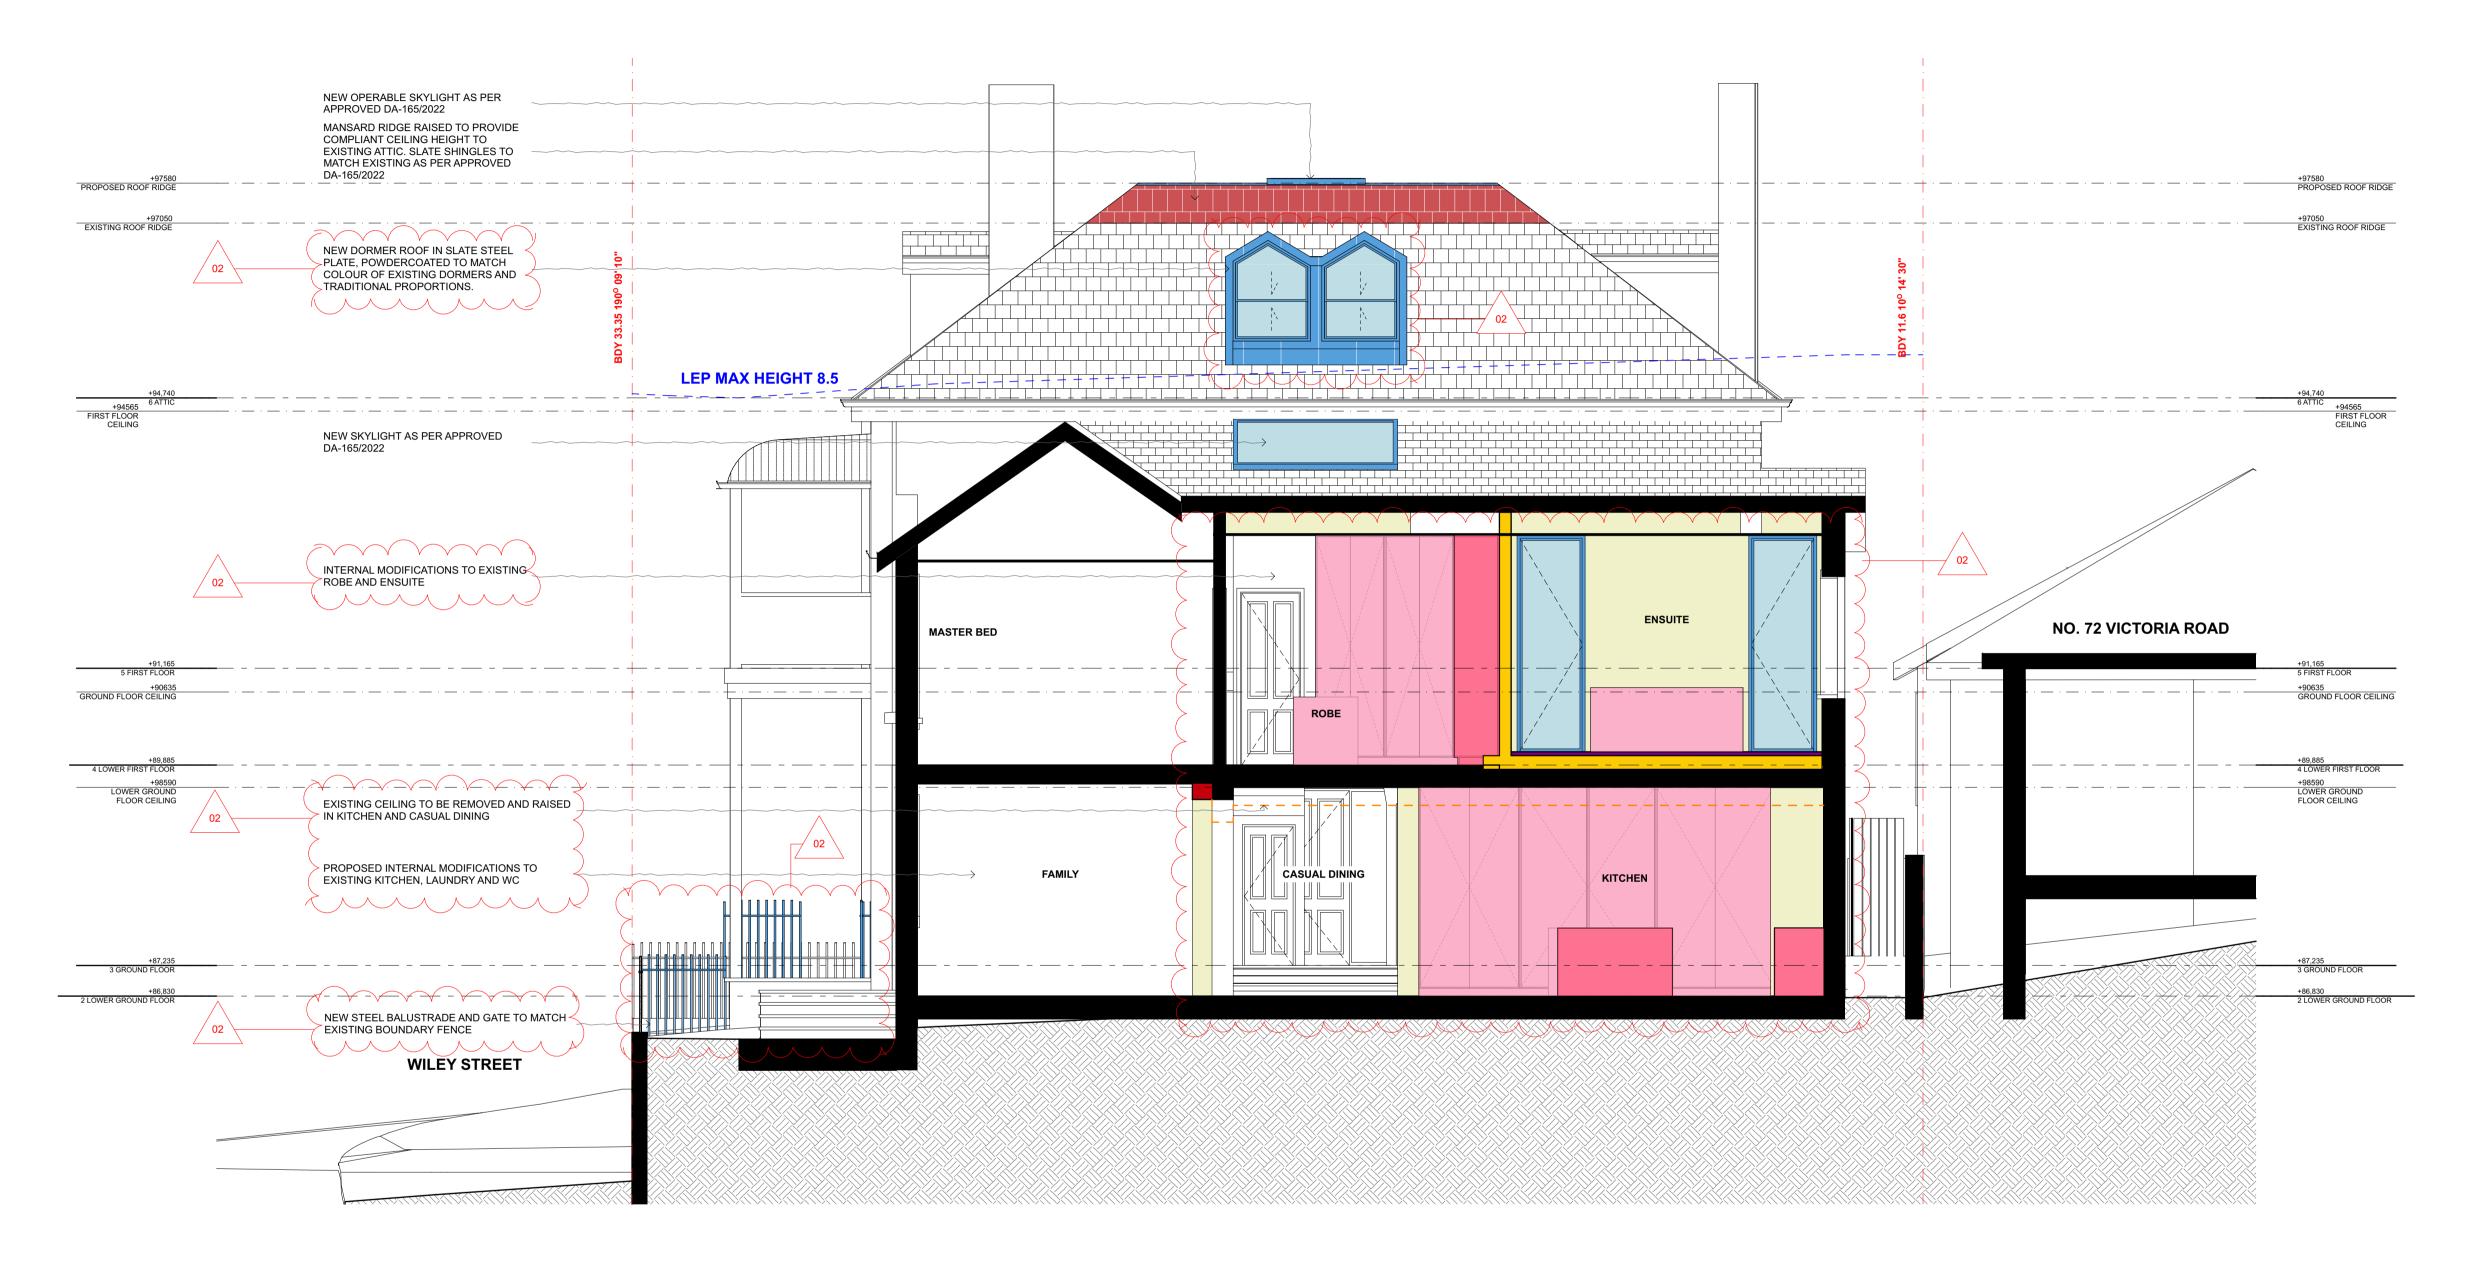
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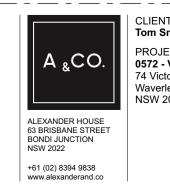
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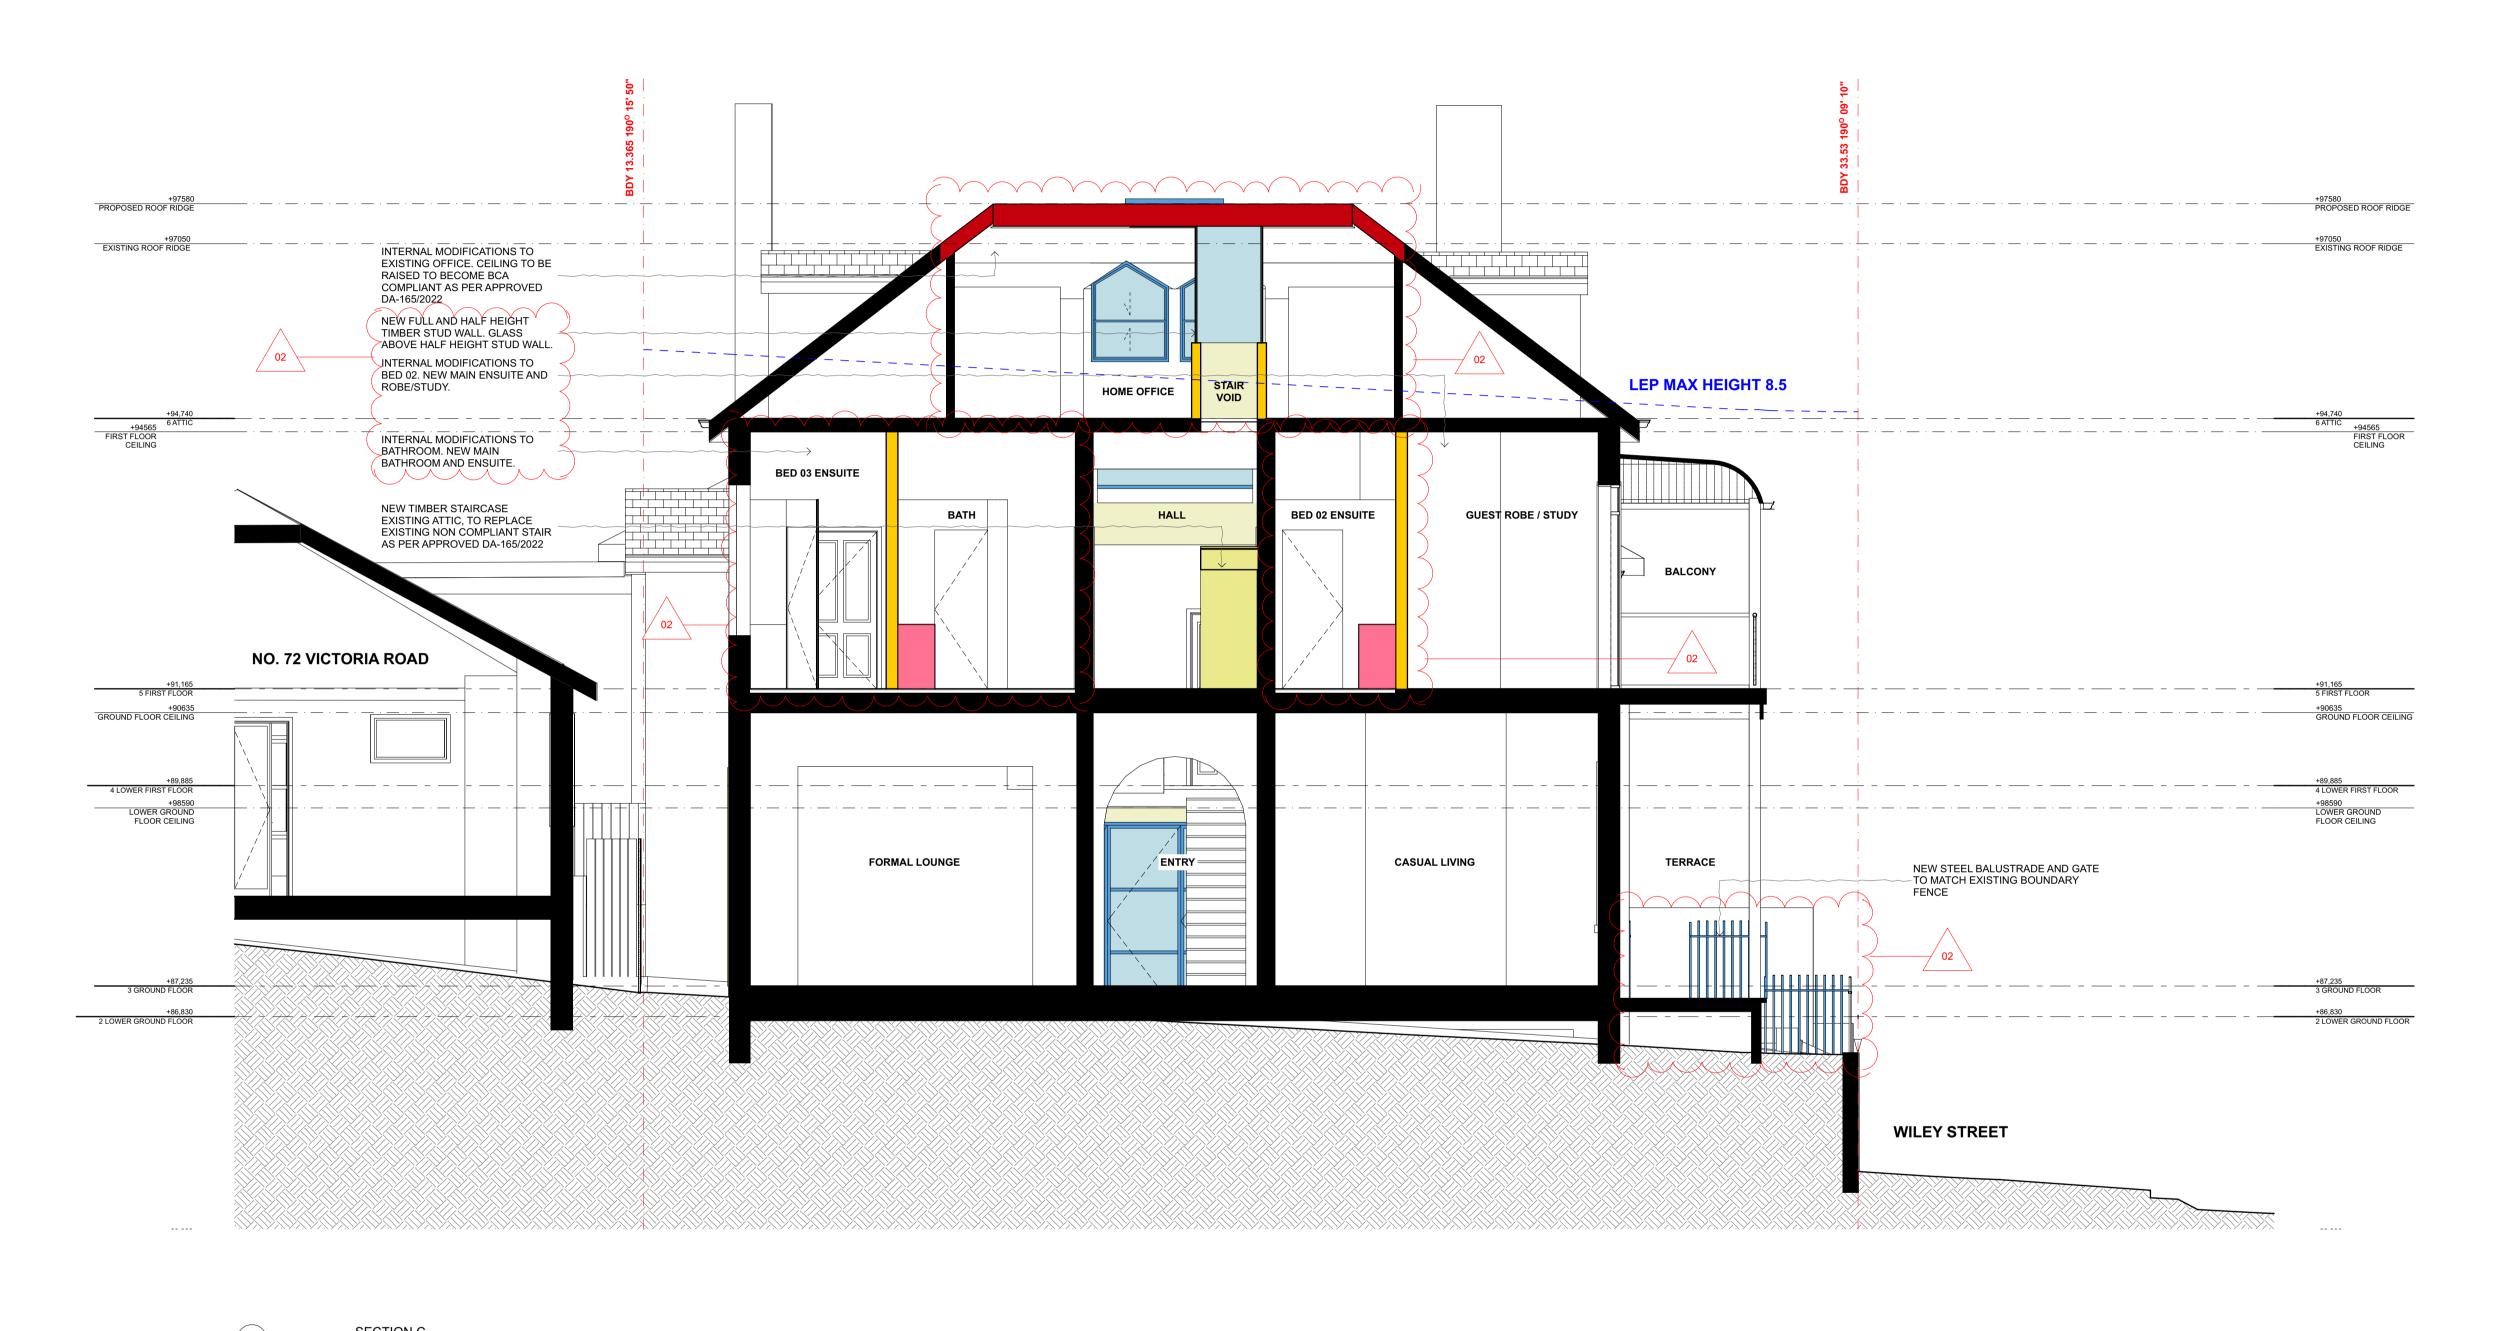
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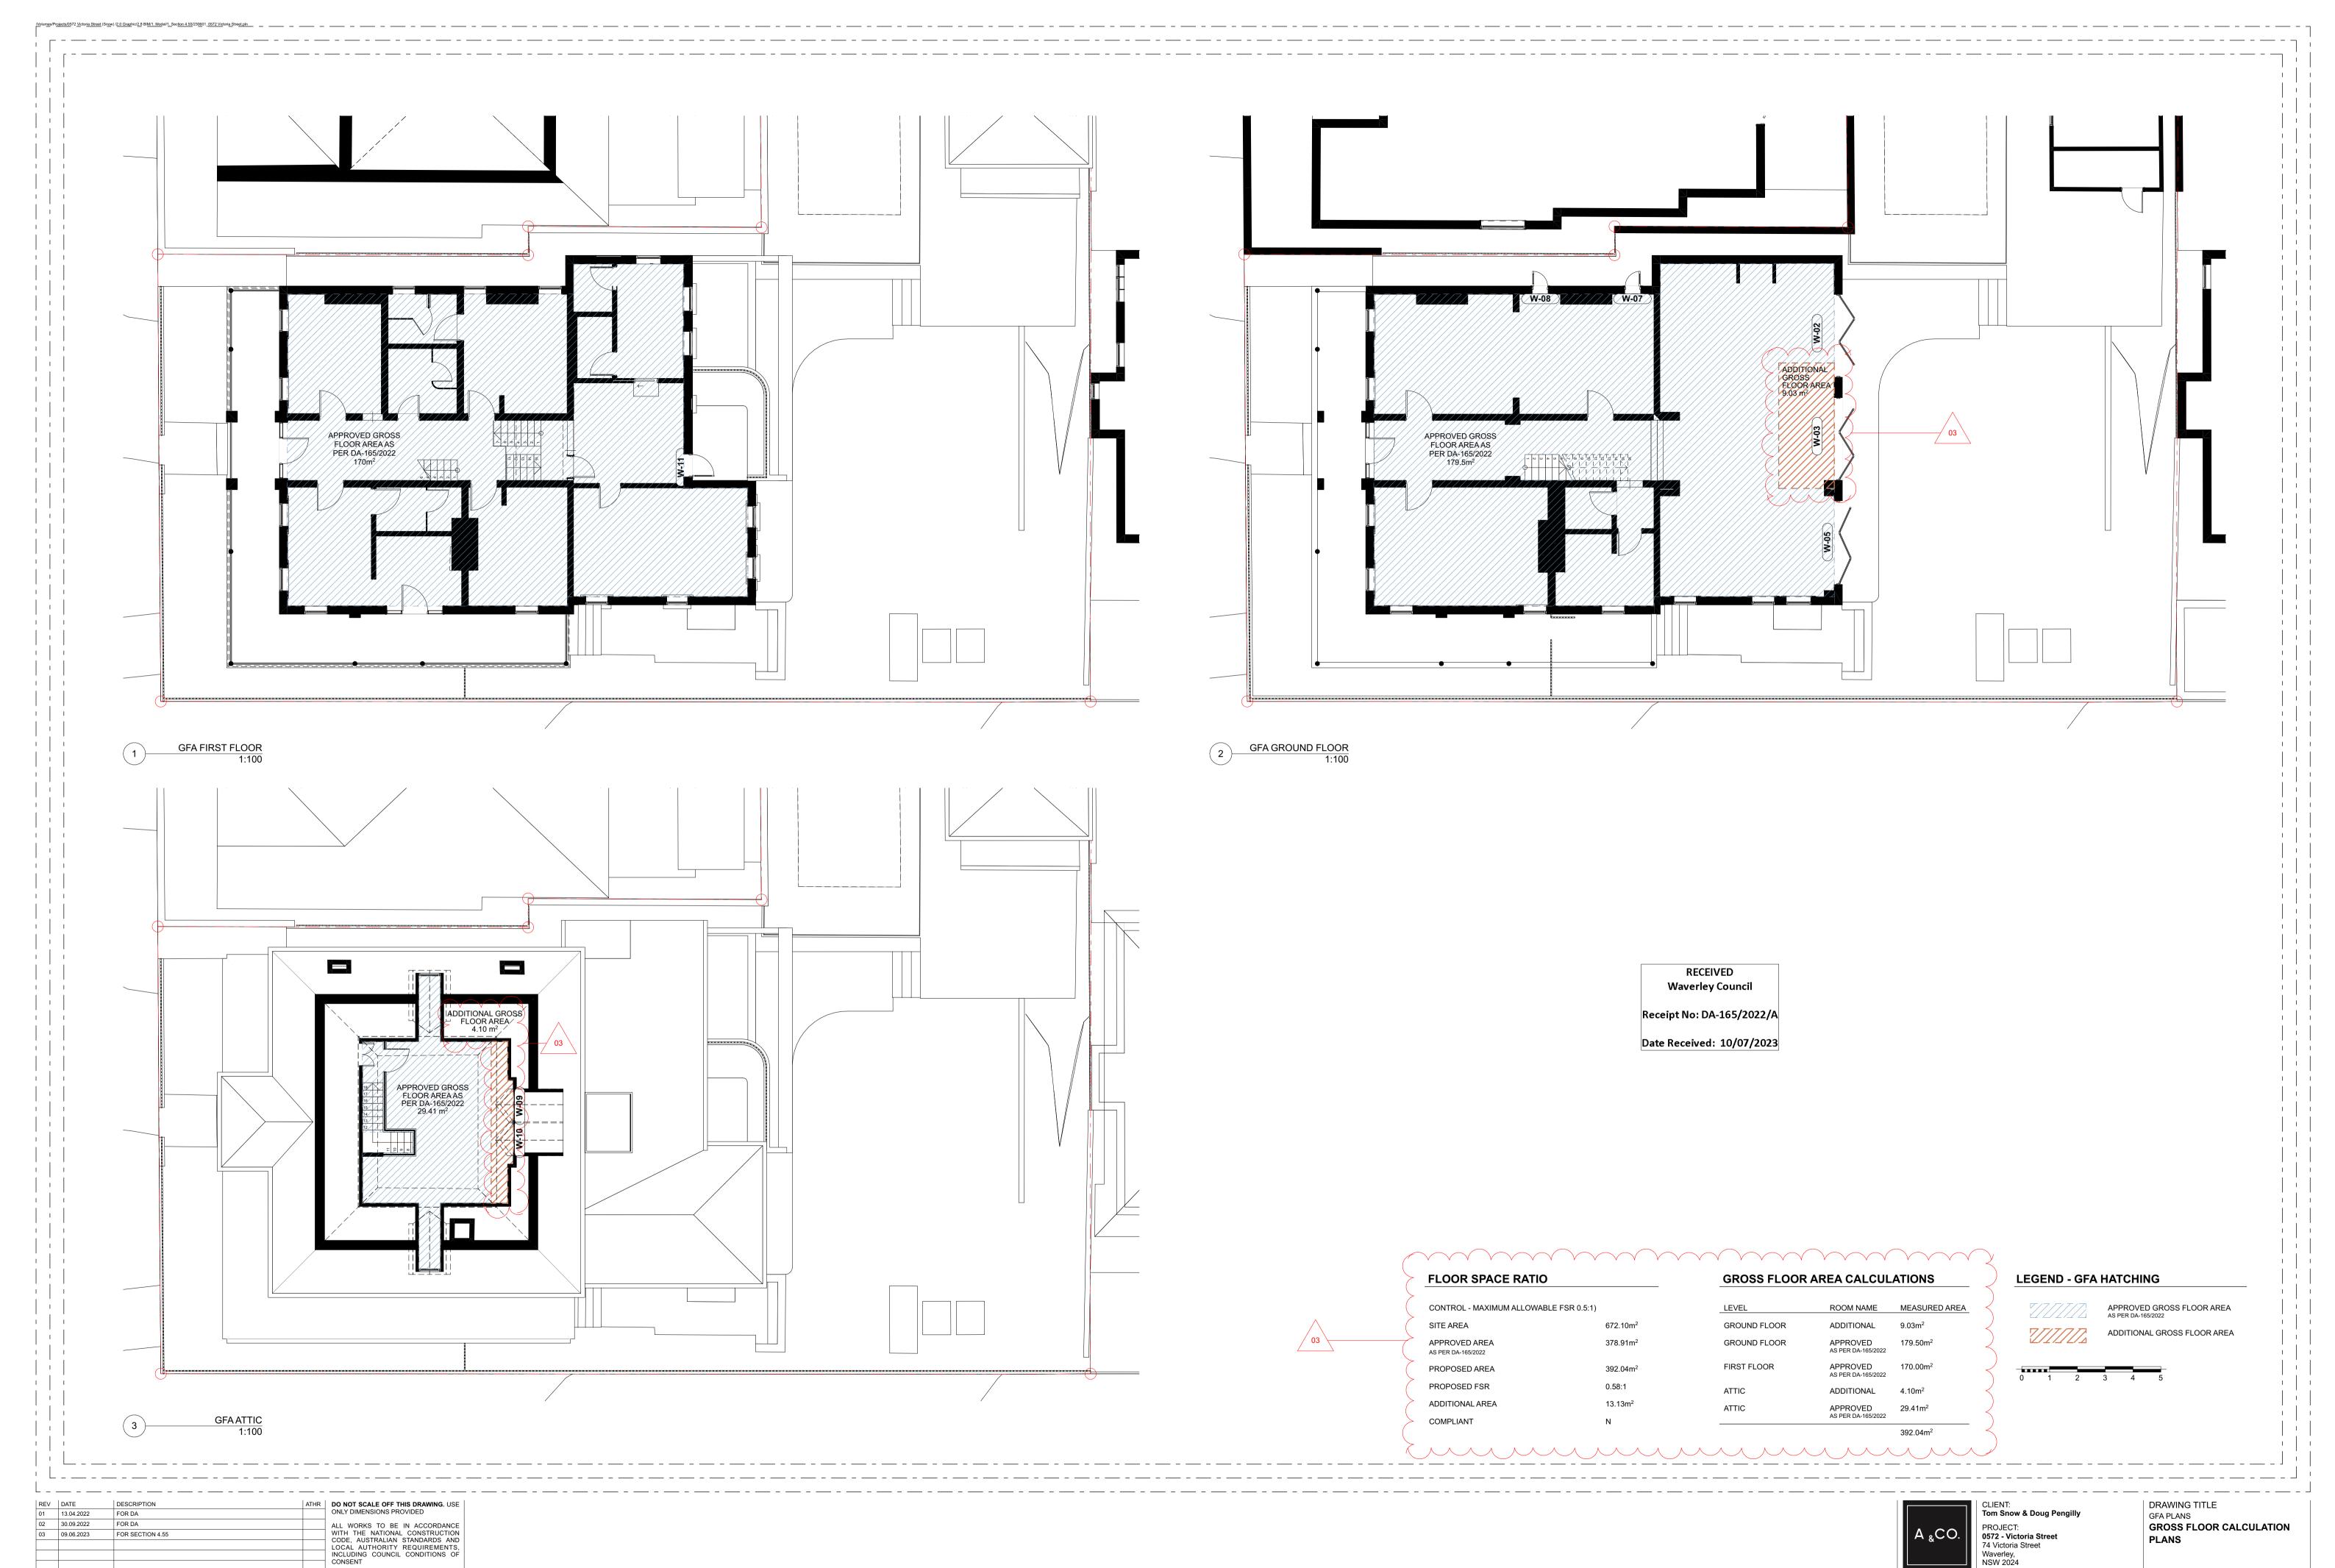


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VEGETATION 11.42m² VEGETATION 41 A1m² LANDSCAPE PLAN 1:100

CONTROL - MINIMUM OPEN SPACE (40% OF TOTAL SITE AREA)

672.10m²

268.84m²

 $359.27 m^2$

90.43m²

OPEN SPACE

ALLOWABLE AREA

PROPOSED OPEN SPACE

SITE AREA

DIFFERENCE


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Receipt No: DA-165/2022/A

Date Received: 10/07/2023



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672.10m²

100.86m²

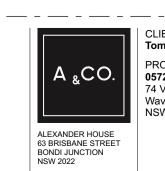198.95m²

98.04m²

SOFT LANDSCAPE AREA

SITE AREA

ALLOWABLE AREA

PROPOSED AREA

DIFFERENCE

COMPLIANT

CONTROL - MINIMUM LANDSCAPE (15% OF TOTAL SITE AREA)

Tom Snow & Doug Pengilly PROJECT: 0572 - Victoria Street 74 Victoria Street Waverley, NSW 2024

LANDSCAPE CALCULATION

LEGEND - LANDSCAPE HATCHING

LANDSCAPE OVER STRUCTURE

DRAWING TITLE

LANDSCAPE PLANS

SCALE @ A1 / A3 1:100 / 1:(SCALEX2) PROJECT NO. - DWG NO._REV. **0572 - DA81_02**





Report to the Waverley Local Planning Panel

Application number	DA-99/2023		
Site address	12A-14 Wilga Street, BONDI NSW 2026		
Proposal	Alterations to replace main roof membrane and Unit 11 roof top stair enclosure and terrace to residential flat building		
Date of lodgement	27 April 2023		
Owner	T J Simpson		
Applicant	Burton Architecture		
Submissions	None		
Cost of works	\$908,750		
Principal Issues	 Overall height of building development standard Floor space ratio development standard 		
Recommendation	That the application be APPROVED in accordance with the conditions contained in the report		

SITE MAP



1. PREAMBLE

1.1. Executive Summary

The development application seeks consent for alterations to replace the main roof membrane and Unit 11 roof top stair enclosure and terrace to the existing residential flat building at the site known as 12A-14 Wilga Street, BONDI.

The principal issues arising from the assessment of the application are as follows:

- Non-compliance with the overall height of buildings development standard
- Non-compliance with the floor space ratio (FSR) development standard

The assessment finds these issues acceptable as the overall height and FSR are not proposed to change from the existing height on site.

No submissions were received.

The application has been assessed against the relevant matters for consideration under section 4.15(1) of the *Environmental Planning and Assessment Act 1979*. It is recommended for approval subject to conditions of consent.

1.2. Site and Surrounding Locality

A site visit was carried out on 15 June 2023.

The site is identified as Lot 11 in SP2433, known as 12A-14 Wilga Street, BONDI.

The site is rectangular in shape with a frontage to Wilga Street measuring 35.1m. The site has an area of approximately 1,439m² and falls from the west towards the eastern side boundary by approximately 6.5m.

The site is occupied by a seven (7) storey residential flat building with vehicular access to a carpark from Wilga Street.

The site is adjoined by a residential flat building to the east and semi-detached dwellings facing Sandridge Street to the west. The locality is characterised by a mix of low and medium density residential development.

Figures 1 to 4 are photos of the site and its context.



Figure 1: Subject site viewed from Wilga Street

Figure 2: Subject site viewed from Wilga Street



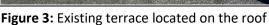




Figure 4: Existing terrace located on the roof

1.3. Relevant Development History

A search of Council's records revealed the following recent and relevant development history of the site:

- DA-007/1998: New Roof Terrace to the existing residential flat building, approved on 6 May 1998; and
- DA-237/2009: Alterations and roof level addition to Unit 11, refused on 24 November 2009. This
 application proposed to increase the size of the existing terrace and associated deck area.

1.4. Proposal

The development application seeks consent for alterations and additions to a residential flat building, specifically the demolition and reconstruction of the existing roof of the entire building and a roof top terrace and stair enclosure for Unit 11. The reconstruction of the terrace and stair enclosure is proposed to remain the same size as existing, including length, height and width. The reason for the reconstruction is due to inadequate waterproofing during its construction in 1998.

The only modifications included in this proposal that differ to the existing structure on site are as follows:

- The existing rendered balustrade is proposed to be constructed of glass; and
- The frosted glass screen on the western edge is proposed to be removed.

1.5. Background

The development application was lodged on 27 April 2023 and was notified on 18 May 2023. On 16 June 2023, the applicant submitted amended plans to replace the proposed rendered balustrade on the rooftop deck with a glass balustrade.

A deferral letter was issued on 5 July 2023 requesting a Clause 4.6 for the non-compliance with the FSR. A Clause 4.6 written request, along with floor plans for each level, were submitted on 21 July 2023.

The architectural plans submitted on 16 June 2023 form the basis of this assessment.

2. ASSESSMENT

The following matters are to be considered in the assessment of this development application under section 4.15 of the *Environmental Planning and Assessment Act 1979* (the Act).

2.1. Planning Instruments and Development Control Plans

The following is an assessment against relevant legislation, environmental planning instruments, including State Environmental Planning Policies (SEPPs), and development control plans.

2.1.1. State Environmental Planning Policies (SEPPs)

The following SEPPs apply from the 1st March 2022 and have been considered acceptable in the assessment of this development application:

SEPP (Building Sustainability Index – BASIX) 2004

2.1.2. Waverley Local Environmental Plan 2012 (Waverley LEP 2012)

The relevant matters to be considered under the Waverley LEP 2012 for the proposed development are outlined below:

Table 1: Waverley LEP 2012 Compliance Table

Provision	Compliance	Comment		
Part 1 Preliminary				
1.2 Aims of plan	Yes	The development is consistent with the aims		
	res	of the plan		

Part 2 Permitted or prohibited development				
R3 Medium Density Residential Zone	Yes	The proposal is defined as alterations and additions to a residential flat building, which is permitted with consent in the R3 zone.		
Part 4 Principal development star	ndards			
4.3 Height of buildings ■ 9.5m	No	The works are proposed to sit 26m above the existing ground level, which does not comply with the development standard.		
4.4 Floor space ratio 0.6:1 or 861m ²	No	Whilst the development does not propose to increase the existing GFA on site, the development does not comply with the maximum permissible		
4.6 Exceptions to development standards	See discussion	The application is accompanied by a written request pursuant to clause 4.6 of Waverley LEP 2012 to vary the height of buildings and FSR development standards. A detailed discussion of the variation to the development standards is presented below this table.		
Part 6 Additional local provisions				
6.1 Acid sulfate soils	Yes	All works are located on the roof of the existing building and therefore will not have an impact on acid sulfate soils.		
6.9 Design excellence	Yes	The building works are proposed to replace the existing built form on site and will therefore not change the existing character or design currently viewed from Wilga Street.		

The following is a detailed discussion of the issues identified in the compliance table above in relation to the Waverley LEP 2012.

Clause 4.6 Exceptions to Development Standards - Height

The application seeks to vary the height of buildings development standard in clause 4.3 under Waverley LEP 2012.

The site is subject to a maximum height of buildings development standard of 9.5m. The proposed development has a maximum building height of 26m (as existing), exceeding the standard by 16.5m equating to a 173% variation.

A written request has been submitted to Council in accordance with clause 4.6(3)(a) and (b) of Waverley LEP 2012 seeking to justify the contravention of the development standard by demonstrating:

- (a) That compliance with the development standard is unreasonable or unnecessary in the circumstances of the case; and
- (b) That there are sufficient environmental planning grounds to justify contravening the standard.

A copy of the applicant's written request has been provided to the Waverley Local Planning Panel for consideration.

Applicant's Written Request - Clause 4.6(3)(a) and (b)

The applicant seeks to justify the contravention of the height of buildings development standard on the following basis:

- (a) That compliance with the development standard is unreasonable or unnecessary in the circumstances of the case:
 - (i) The proposed works are remedial works to an existing building, with the rebuilding of a rooftop element within its existing envelope that does not increase the height or bulk of the development.
 - (ii) There are no form or material changes to the existing building.
- (b) That there are sufficient environmental planning grounds to justify contravening the standard:
 - (i) The subject building is existing and the proposed development application is for remedial replacement works only.
 - (ii) The remedial works are within the existing envelope of the existing building structure.
 - (iii) There will be no discernible visual change to the existing building after the remedial works.
 - (iv) The remedial works are critical to be carried out as soon as possible to limit further deterioration.

Consideration of Applicant's Written Request - Clause 4.6(4) (a) (i) and (ii)

Development consent must not be granted unless the consent authority is satisfied that:

- (a) The applicant's written request has adequately addressed the matters required to be demonstrated by subclause 3 of clause 4.6 being that compliance with the development standard is unreasonable or unnecessary in the circumstances of the case, and that there are sufficient environmental planning grounds to justify contravening the standard; and
- (b) The proposed development will be in the public interest because it is consistent with the objectives of the particular development standard and the objectives for development within the zone in which the development is proposed to be carried out.

Does the written request adequately address those issues at clause 4.6(3)(a)?

It is considered that the applicant has adequately addressed that compliance with the standard is unreasonable or unnecessary in the circumstances of the case and has referenced one or more of the following justifications as set out in *Wehbe v Pittwater Council* (2007) 156 LGERA 446:

- (a) the objectives of the development standard are achieved notwithstanding non-compliance with the standard;
- (b) to establish that the underlying objective or purpose is not relevant to the development with the consequence that compliance is unnecessary;
- (c) to establish that the underlying objective or purpose would be defeated or thwarted if compliance was required with the consequence that compliance is unreasonable;
- (d) to establish that the development standard has been virtually abandoned or destroyed by the Council's own actions in granting consents departing from the standard and hence compliance with the standard is unnecessary and unreasonable; and
- (e) to establish that "the zoning of particular land" was "unreasonable or inappropriate" so that "a development standard appropriate for that zoning was also unreasonable or unnecessary as it applied to that land" and that "compliance with the standard in that case would also be unreasonable or unnecessary.

The applicant specifically relies upon justification (a) outlined above to address clause 4.6(3)(a) of Waverley LEP 2012. The development proposes to remove and replace the existing roof terrace with a built form that is similar in style, design and character. The overall height or size of the building is not proposed to change from what currently exists on site. Therefore, there will be no additional amenity impacts to the subject site and surrounding properties.

Does the written request adequately address those issues at clause 4.6(3)(b)?

The applicant has adequately addressed that there are sufficient environmental planning grounds to justify contravening the development standard. As the overall height of the building is not proposed to change, there will be no additional environmental impacts to the subject site or surrounding properties.

Is the development in the public interest?

The proposed development will be in the public interest because it is consistent with both the objectives of the particular development standard and the objectives for development within the zone in which the development is proposed to be carried out.

The relevant objectives of the height of buildings development standard are as follows:

- (a) to ensure building heights preserve the environmental amenity of neighbouring properties and public spaces and, if appropriate, the sharing of views......
- (c) to maintain satisfactory solar access to existing buildings and public areas,
- (d) to establish building heights that are consistent with the desired future character of the locality.

The proposal has demonstrated that notwithstanding the variation to the height of buildings development standard, the amenity of adjoining properties is preserved as there are no additional

impacts on view loss, solar access or privacy. The proposed height matches the existing on site and therefore is compatible in bulk and scale to surrounding developments within the area.

The objectives of the R3 zone are as follows:

- To provide for the housing needs of the community within a medium density residential environment.
- To provide a variety of housing types within a medium density residential environment.
- To enable other land uses that provide facilities or services to meet the day to day needs of residents.
- To maximise public transport patronage and encourage walking and cycling.
- To increase or preserve residential dwelling density.
- To encourage the supply of housing, including affordable housing, that meets the needs
 of the population, particularly housing for older people and people with disability.
- To provide development that is compatible with the desired future character and amenity of the surrounding neighbourhood.
- To promote development that incorporates planning and design measures that reduce the urban heat island effect.
- To improve the urban tree canopy by providing high levels of deep soil planting and additional landscaping.

The proposal has adequately demonstrated that the objectives of the R3 Medium Density Residential zone are achieved as the use of the existing residential flat building is maintained and is consistent with the medium density residential character of the locality. The proposed alterations and additions will enhance the functionality of Unit 11 and contribute to the amenity of its occupants.

Conclusion

For the reasons provided above the requested variation to the height of buildings development standard is supported as the applicant's written request has adequately addressed the matters required to be addressed by clause 4.6 of the Waverley LEP 2012 and the proposed development would be in the public interest because it is consistent with the objectives of the height of buildings development standard and the R3 zone.

Clause 4.6 Exceptions to Development Standards - FSR

The application seeks to vary the floor space ratio (FSR) development standard in clause 4.4 under Waverley LEP 2012.

The site is subject to a maximum FSR development standard of 0.6:1. The proposed development has an FSR of 1.64:1, exceeding the standard by 1,500m², equating to a 273% variation (as existing).

A written request has been submitted to Council in accordance with clause 4.6(3)(a) and (b) of Waverley LEP 2012 seeking to justify the contravention of the development standard by demonstrating:

- (a) That compliance with the development standard is unreasonable or unnecessary in the circumstances of the case; and
- (b) That there are sufficient environmental planning grounds to justify contravening the standard.

A copy of the applicant's written request has been provided to the Waverley Local Planning Panel for consideration.

Applicant's Written Request - Clause 4.6(3)(a) and (b)

The applicant seeks to justify the contravention of the FSR development standard on the following basis:

- That compliance with the development standard is unreasonable or unnecessary in the circumstances of the case:
 - (i) The rooftop pavilion is rebuilt to the same envelope. There are no other changes to the existing building and the remedial works are contained with the existing building fabric and envelope. Materials and structures are replaced like for like.
 - (ii) The proposed works are remedial works to an existing building, with the rebuilding of a rooftop element within its existing envelope that does not increase the height or bulk of the development.
 - (iii) The subject building that is breaching the FSR control is existing. There are no form or material changes to the existing building. The works are remedial replacement works.
- That there are sufficient environmental planning grounds to justify contravening the standard:
 - (i) The subject building is existing and the proposed development application is for remedial replacement works only.
 - (ii) The remedial works are within the existing envelope of the existing building structure.
 - (iii) There will be no discernible visual change to the existing building after the remedial works.
 - (iv) The remedial works are critical to be carried out as soon as possible to limit further deterioration.

Consideration of Applicant's Written Request - Clause 4.6(4) (a) (i) and (ii)

Development consent must not be granted unless the consent authority is satisfied that:

(a) The applicant's written request has adequately addressed the matters required to be demonstrated by subclause 3 of clause 4.6 being that compliance with the development standard

- is unreasonable or unnecessary in the circumstances of the case, and that there are sufficient environmental planning grounds to justify contravening the standard; and
- (b) The proposed development will be in the public interest because it is consistent with the objectives of the particular development standard and the objectives for development within the zone in which the development is proposed to be carried out.

Does the written request adequately address those issues at clause 4.6(3)(a)?

It is considered that the applicant has adequately addressed that compliance with the standard is unreasonable or unnecessary in the circumstances of the case and has referenced one or more of the following justifications as set out in *Wehbe v Pittwater Council* (2007) 156 LGERA 446:

- (a) the objectives of the development standard are achieved notwithstanding non-compliance with the standard;
- (b) to establish that the underlying objective or purpose is not relevant to the development with the consequence that compliance is unnecessary;
- (c) to establish that the underlying objective or purpose would be defeated or thwarted if compliance was required with the consequence that compliance is unreasonable;
- (d) to establish that the development standard has been virtually abandoned or destroyed by the Council's own actions in granting consents departing from the standard and hence compliance with the standard is unnecessary and unreasonable; and
- (e) to establish that "the zoning of particular land" was "unreasonable or inappropriate" so that "a development standard appropriate for that zoning was also unreasonable or unnecessary as it applied to that land" and that "compliance with the standard in that case would also be unreasonable or unnecessary.

The applicant specifically relies upon justification (a) outlined above to address clause 4.6(3)(a) of Waverley LEP 2012. The development proposes to remove and replace the existing roof terrace with a restored roof terrace that is like for like. The overall FSR is not proposed to change from what currently exists on site. Therefore, there will be no additional amenity impacts to the subject site and surrounding properties.

Does the written request adequately address those issues at clause 4.6(3)(b)?

The applicant has adequately addressed that there are sufficient environmental planning grounds to justify contravening the development standard. As the overall FSR of the building is not proposed to change, there will be no additional environmental impacts to the subject site or surrounding properties.

Is the development in the public interest?

The proposed development will be in the public interest because it is consistent with both the objectives of the particular development standard and the objectives for development within the zone in which the development is proposed to be carried out.

The objectives of the FSR development standard are as follows:

- (a) to ensure sufficient floor space can be accommodated within the Bondi Junction Centre to meet foreseeable future needs,
- (b) to provide an appropriate correlation between maximum building heights and density controls,
- (c) to ensure that buildings are compatible with the bulk and scale of the desired future character of the locality,
- (d) to establish limitations on the overall scale of development to preserve the environmental amenity of neighbouring properties and the locality.

The proposal has adequately demonstrated that the extent of the new addition that seeks variation to the FSR development standard is appropriate for the site as it does not result in an increase in bulk or scale when compared to the existing building, as the works are proposed to replace the roof terrace like for like. The proposal has a built form that is compatible with surrounding developments and the character of the streetscape. Notwithstanding the variation to the development standard, the proposal satisfies the objective to preserve the environmental amenity impacts to surrounding properties and is acceptable.

The objectives of the R3 zone are as follows:

- To provide for the housing needs of the community within a medium density residential environment.
- To provide a variety of housing types within a medium density residential environment.
- To enable other land uses that provide facilities or services to meet the day to day needs of residents.
- To maximise public transport patronage and encourage walking and cycling.
- To increase or preserve residential dwelling density.
- To encourage the supply of housing, including affordable housing, that meets the needs of the population, particularly housing for older people and people with disability.
- To provide development that is compatible with the desired future character and amenity of the surrounding neighbourhood.

- To promote development that incorporates planning and design measures that reduce the urban heat island effect.
- To improve the urban tree canopy by providing high levels of deep soil planting and additional landscaping.

The proposal has adequately demonstrated that the objectives of the R3 Medium Density Residential zone are achieved as the use of the existing residential flat building is maintained and is consistent with the medium density residential character of the locality. The proposed alterations and additions will enhance the functionality of Unit 11 and contribute to the amenity of its occupants.

Conclusion

For the reasons provided above the requested variation to the FSR development standard is supported as the applicant's written request has adequately addressed the matters required to be addressed by clause 4.6 of the Waverley LEP 2012 and the proposed development would be in the public interest because it is consistent with the objectives of FSR development standard and the R3 Medium Density Residential zone.

2.1.3. Waverley Development Control Plan 2022 (Waverley DCP 2022)

The relevant matters to be considered under the Waverley DCP 2022 for the proposed development are outlined below:

Table 2: Waverley DCP 2022 – Part B General Provisions Compliance Table

Development Control	Compliance	Comment
11. Design Excellence	Yes	Satisfactory.

Table 3: Waverley DCP 2022 – Part C2 Other Residential Development Compliance Table

Development Control	Compliance	Comment	
2.2 Height			
 Maximum external wall height: 7m 	No	Whilst the external wall height would not comply with the control, it is noted that the terrace and stair enclosure on the rooftop is already existing. The proposal will not increase the existing external wall height on site. Therefore, the development should be supported.	
2.3 Setbacks			
2.3.1 Street setbacksConsistent street setback	Yes	The works are proposed 5.1m from the street boundary. As this is already existing on site, no concerns are raised.	
2.3.2 Side and rear setbacks	Yes	The development will maintain a 9m setback from the western side boundary and an 18.6m	

Development Control	Compliance	Comment
 Minimum side setback: 2.5m Minimum rear setback: 6m or predominant rear building line, whichever is the greater setback 2.5 Building design and street Respond to streetscape Sympathetic external finishes Corner sites to address both streets as primary frontages Removal of original architectural features 		setback from the eastern side boundary, which complies with the control. The rear maintains a 27m setback, which complies with the control. The reconstruction of the terrace and stair enclosure is proposed to replace the existing built form with similar materials and design. The proposed replacement of the rendered balustrade to glass will improve the visual bulk when viewed from the street.
not supported		
 Roof design should contribute to the architectural design and the environmental performance of the development. Roof design should respond to the streetscape character of the area. Alteration and additions must consider existing streetscape and the impact on neighbouring views. Contemporary roof forms are permitted to minimise bulk and scale, and respond appropriately to the context 	Yes	The roof is proposed to be replaced like for like and will not change the outlook of what is existing onsite. The rooftop will not be visible from the street as it is a flat roof design. The reason for the replacement is due to waterproofing issues of the building.
2.11 Private Open Space		
 2.11.2 – Balconies/decks Balcony additions to match the character of the building Should not dominate the façade No wrap around balconies Located to maximise solar access and privacy 	Yes	The deck area is proposed to match the existing deck area on site in relation to size, style, design and character. The deck area will therefore match the existing character of the building and should be supported.

Development Control	Compliance	Comment
Balustrades to allow views and casual surveillance of the street & privacy		
2.13 Solar access and overshad	lowing	
 New development should maintain at least 2 hours of sunlight to solar collectors on adjoining properties in mid winter Direct sunlight to north facing windows of habitable rooms on all private open space areas of adjacent dwellings to less than 3 hours of sunlight on 21 June 	N/A	As the overall height and size of the works are not proposed to change from the existing on site, there will be no additional overshadowing as a result of the development.
2.14 Views and view sharing		
 Minimise view loss through design Landscaping on sites adjacent to a Council Park or reserve should be sympathetic to soften the public/private interface Views from public spaces to be maintained 	Yes	The development will not impact on existing views as the works are proposed to replicate the existing built form on site. The removal of the frosted glass screen along the western edge of the deck will slightly improve views from neighbouring properties located further west.

2.2. Other Impacts of the Development

The proposal is considered to have no significant detrimental effect relating to environmental, social or economic impacts on the locality, subject to appropriate conditions being imposed.

2.3. Suitability of the Site for the Development

The site is considered suitable for the proposal.

2.4. Any Submissions

The application was notified for 14 days between 18 May and 2 June 2023 in accordance with the *Waverley Community Development Participation and Consultation Plan*.

Following receipt of amended plans, the application was not notified as the amended form of the proposal did not result in any impacts to surrounding properties.

No submissions were received.

2.5. Public Interest

The proposal is considered to have no detrimental effect on the public interest, subject to appropriate conditions being imposed.

3. REFERRALS

3.1. Stormwater

The application was referred to Council's Stormwater Engineer who provided the following comments:

From a stormwater drainage perspective, there are objections to the DA in its current form. However, should the development be approved then conditions are to be imposed.

Recommended conditions have been included in Appendix A.

4. CONCLUSION

The development application seeks consent for alterations to replace the main roof membrane and Unit 11 roof top stair enclosure and terrace to the existing residential flat building at the site known as 12A-14 Wilga Street, BONDI.

The principal issues arising from the assessment of the application are as follows:

- Non-compliance with the overall height of buildings development standard
- Non-compliance with the FSR development standard

The assessment finds these issues acceptable as the overall height and FSR are not proposed to change from the existing.

No submissions were received.

The application has been assessed against the relevant matters for consideration under section 4.15(1) of the Act. It is recommended for approval subject to conditions of consent.

5. RECOMMENDATION TO WAVERLEY LOCAL PLANNING PANEL

That the development application be **APPROVED** by the Waverley Local Planning Panel subject to the conditions in Appendix A.

Report prepared by:	Application reviewed and agreed by:	Application reviewed and agreed by:
Ap.	JZancanaso	
Katie Johnstone	Jo Zancanaro	Angela Rossi
Senior Development	Acting Manager, Development	Executive Manager,
Assessment Planner	Assessment	Development Assessment
Date: 27 July 2023	Date: 31 July 2023	Date: 9 August 2023

Reason for WLPP referral:

3. Departure from any development standard in an EPI by more than 10%

OFFICE USE ONLY

Clause 4.6 register entry required	173% variation to height (Clause 4.3)	
	273% variation to FSR (Clause 4.4)	
	X Pre-existing non-compliance	
	No change to overall building height	
	No change to overall building	
	envelope	
	Variation limited to the	
	[lift/plant/parapet/attic] only	
	X No unreasonable impacts on the	
	amenity of adjoining properties or	
	streetscape	
	X Sufficient environmental planning	
	grounds	
	Consistent with the objectives of the	
	standard	
	X Height variation associated with	
	replacement roof (being less than	
	overall building height) but over	
	height standard	
	X No change to FSR (preexisiting)	
Determining Authority	Local Planning Panel	
(Concurrence Authority for Clause 4.6 variation)		
Affordable Rental Housing Units?	No	

Secondary Dwelling	No
Boarding House	No
Group Home	No
Trial Period database entry required	No
VPA submitted – follow up actions required	No
Refer to compliance for investigation	No
Commercial/liquor operational conditions	No
Other (please specify):	No

APPENDIX A – CONDITIONS OF CONSENT

A. APPROVED DEVELOPMENT

1. APPROVED PLANS AND DOCUMENTATION

The development must be in accordance with:

(a) Architectural Plans prepared by Burton Architects of Project No. BA2217 including the following:

Plan Number	Plan description	Plan Date	Date received by
and Revision			Council
A002 Rev. B	Site Analysis Plan	15/05/2023	16/06/2023
A003 Rev. D	Legend and Materials	16/06/2023	16/06/2023
A011 Rev. D	Roof Plan	16/06/2023	16/06/2023
A012 Rev. D	Top Roof Level Plan	16/06/2023	16/06/2023
A030 Rev. D	South Elevation	16/06/2023	16/06/2023
A031 Rev. D	West Elevation	16/06/2023	16/06/2023
A032 Rev. D	North Elevation	16/06/2023	16/06/2023
A033 Rev. D	East Elevation	16/06/2023	16/06/2023
A050 Rev. E	Unit 11 Terrace Plan	16/06/2023	16/06/2023
A051 Rev. E	Unit 11 Roof Plan	16/06/2023	16/06/2023
A060 Rev. E	Sections AA/BB	16/06/2023	16/06/2023
A061 Rev. E	Sections CC/DD	16/06/2023	16/06/2023
A062 Rev. E	Sections 11/44	16/06/2023	16/06/2023
A063 Rev. E	Sections 22/33	16/06/2023	16/06/2023

- (b) BASIX Certificate
- (c) Schedule of external finishes and colours received by Council on 16 June 2023
- (d) The Site Waste and Recycling Management Plan (SWRMP) Part 1 received by Council on 27 April 2023

Except where amended by the following conditions of consent.

B. PRIOR TO THE ISSUE OF A CONSTRUCTION CERTIFICATE

GENERAL REQUIREMENTS

2. NO BUILDING OR DEMOLITION WORKS PRIOR TO RELEASE OF CONSTRUCTION CERTIFICATE

The building work, or demolition work, must not be commenced until:

- (a) a Construction Certificate has been obtained from Council or an Accredited Certifier in accordance with the Environmental Planning & Assessment Act, 1979 and
- (b) a Principal Certifying Authority has been appointed and Council has been notified of the appointment in accordance with the Environmental Planning & Assessment Act, 1979 and Environmental Planning and Assessment Regulation 2000 and
- (c) Council is given at least two days' notice in writing of the intention to commence the building works.

CONTRIBUTIONS, FEES & BONDS

3. SECTION 7.12 CONTRIBUTION

A cash contribution is payable to Waverley Council pursuant to section 7.12 of the *Environmental Planning and Assessment Act 1979* and Waverley Council Development Contributions Plan 2006 in accordance with the following:

- (a) A cost report indicating the itemised cost of the development shall be completed and submitted to Council:
 - (i) Where the total development cost is less than \$500,000: "Waverley Council Cost Summary Report"; or,
 - (ii) Where the total development cost is \$500,000 or more:
 "Waverley Council Registered Quantity Surveyor's Detailed Cost Report".

A copy of the required format for the cost reports are in the Waverley Council Contributions Plan 2006, available on Council's website.

- (b) As legislated in section 25K of the Environmental Planning and Assessment Regulation 2000, the levy must be paid in accordance with the following;
 - (i) A development valued at \$100,000 or less will be exempt from the levy.
 - (ii) A development valued at \$100,001 \$200,000 will attract a levy of 0.5% OR
 - (iii) A development valued at \$200,001 or more will attract a levy of 1% based on the <u>full</u> cost of the development.

Prior to the issue of any Construction Certificate, evidence must be provided that the levy has been paid to Council in accordance with this condition or that the cost of works is less than \$100,000.

4. SECURITY DEPOSIT

A deposit (cash or cheque) or guarantee for the amount of **\$26,260** must be provided to Council for any damage caused to any property of the consent authority (ie. public land) as a consequence of the works and completing any public work (such as road work, kerbing and guttering, footway construction, stormwater drainage and environmental controls) required in connection with the consent.

This deposit (cash or cheque) or guarantee must be established prior to the issue of any Construction Certificate. The full amount of the difference after recovery of Council's cost for any repair of damage to Council property or rectification of unauthorised works on Council property will be refunded after satisfactory completion all of works associated with this consent (including the required public works) to the person who paid the deposit.

5. LONG SERVICE LEVY

A long service levy, as required under Section 34 of the *Building and Construction Industry Long Service Payments Act, 1986*, is to be paid in respect to this building work. In this regard, proof that the levy has been paid is to be submitted to the Principal Certifying Authority prior to the issue of any Construction Certificate.

<u>Note</u>: Council acts as an agent for the Long Service Payment Corporation and the levy may be paid at Council's office. The levy rate is 0.35% of building work costing \$25,000 or more.

CONSTRUCTION & SITE MATTERS

6. HOARDING

To ensure the site is contained during construction, a hoarding is required for the approved works which is to be designed and constructed in accordance with the requirements of Safe Work NSW. Where the hoarding is to be erected over the footpath or any public place, the approval of Council's Compliance Unit must be obtained and applicable fees paid, prior to the erection of the hoarding.

7. EROSION & SEDIMENT CONTROL

A Soil and Water Management Plan (SWMP), also known as an Erosion and Sediment Control Plan shall be prepared in accordance with Waverley Council's Water Management Technical Manual be installed and maintained until construction activities have been completed and the site is fully stabilised. A copy of the SWMP must be kept on site at all times and made available to Council officers upon request.

8. ENGINEERING DETAILS

Structural details are to be prepared and certified by a practicing Structural Engineer in connection with all structural components of the approved works, prior to the issue of the relevant Construction Certificate.

TRAFFIC MANAGEMENT

9. CONSTRUCTION TRAFFIC MANAGEMENT PLAN (CTMP)

The applicant is to submit a Construction Traffic Management Plan (CTMP) for the approval of Council's Executive Manager, Infrastructure Services, or delegate prior to the issue of any Construction Certificate. For further information on what is required in the CTMP, please refer to Council's website at:

https://www.waverley.nsw.gov.au/building/development_applications/post_determination/development_applications - conditions of consent

ENERGY EFFICIENCY & SUSTAINABILITY

10. BASIX

All requirements of the BASIX Certificate documentation are to be shown on the Construction Certificate plans and documentation.

WASTE

11. SITE WASTE AND RECYCLING MANAGEMENT PLAN

A Site Waste and Recycling Management Plan (SWRMP) - Part 2 is to be submitted to the Principal Certifying Authority prior to the issue of the relevant Construction Certificate, which outlines materials to be reused and/or recycled as a result of demolition and construction works. At least one copy of the SWRMP Part 2 is to be available on site at all times during construction. Copies of demolition and construction waste dockets that verify the facility that received the material for recycling or disposal and the quantity of waste received, must be retained on site at all times during construction.

STORMWATER

12. STORMWATER MANAGEMENT

Certification by a qualified and practicing Engineer that any new roof (inclusive of guttering and downpipes) has drainage designed in accordance with AS/NZS3500.3:2018 and be submitted to the Principle Certifying Authority.

Notes:

- The checklist as set out on pages 68-76 on Council's Water Management Technical Manual (October 2021) available online shall be completed and submitted with any revision of Construction Certificate Plan Submission.
- The Applicant is advised to consider the finished levels of the public domain, including new or existing footpaths and pavement prior to setting the floor levels for the proposed development.
- Waverley Council standard drawings for public domain infrastructure assets are available upon request. Details that are relevant may be replicated in the Engineering design submissions however, Council's title block shall not be replicated.

- Prior to commencement of works a security deposit will be made payable to Council to ensure any additional damage or unauthorised works within the Council property, not conditioned above. Council will reserve the right to withhold the cost of restoring the damaged assets from the security deposit should the applicant fail to restore the defects to the satisfaction of Council.
- Council's contact for infrastructure assessment: E-mail: assets@waverley.nsw.gov.au or Phone: 9083 8886 (operational hours between 9.30am to 4pm Monday to Friday). The expected duration to review and approve the stormwater management plan may take at least 15 working days from the date of submission.

C. COMPLIANCE PRIOR TO WORK COMMENCING AND DURING CONSTRUCTION

The requirements outlined in this section are to be provided to the satisfaction of the Principal Certifying Authority in all instances, except where a condition explicitly specifies the approval of Council or a Council Officer is required.

PRIOR TO ANY WORKS

13. CONSTRUCTION SIGNS

Prior to commencement of any works on the site and during construction a sign shall be erected on the main frontage of the site detailing the name, address and contact details (including a telephone number) of the Principal Certifying Authority and principal contractor (the coordinator of the building works). The sign shall be clearly legible from the adjoining street/public areas and maintained throughout the building works.

DEMOLITION

14. DEMOLITION – ASBESTOS AND HAZARDOUS MATERIALS

The demolition, removal, storage, handling and disposal of products and materials containing asbestos must be carried out in accordance with the relevant requirements of SafeWork NSW and the NSW Environment Protection Authority (EPA), including:

- Work Health and Safety Act 2011;
- Work Health and Safety Regulation 2017;
- SafeWork NSW Code of Practice for the Safe Removal of Asbestos;
- Australian Standard 2601 (2001) Demolition of Structures;
- The Protection of the Environment Operations Act 1997;

At least 5 days prior to the demolition, renovation work or alterations and additions to any building, the person acting on the consent shall submit a Work Plan to the Principal Certifying Authority in accordance with Australian Standard AS 2601-2001, Demolition of Structure and a Hazardous Materials Assessment prepared by a person with suitable expertise and experience. The Work Plan and Hazardous Materials Assessment shall:

- (a) Outline the identification of any hazardous materials, including surfaces coated with lead paint;
- (b) Confirm that no asbestos products are present on the subject land; or
- (c) Particularise a method of safely disposing of the asbestos in accordance with the Code of Practice on how to safely remove asbestos published by SafeWork NSW (catalogue WC03561)
- (d) Describe the method of demolition;
- (e) Describe the precautions to be employed to minimise any dust nuisance; and
- (f) Describe the disposal methods for hazardous materials.

15. CONTROL OF DUST ON CONSTRUCTION SITES

The following requirements apply to demolition and construction works on site:

- (a) Hazardous dust is not to be allowed to escape from the site. The use of fine mesh dust proof screens or other measures are recommended. Any existing accumulations of dust (e.g.: ceiling voids and wall cavities) must be removed by the use of an industrial vacuum fitted with a high efficiency particle air (HEPA) filter. All dusty surfaces and dust created from work are to be suppressed by a fine water spray. Water must not be allowed to enter the street and stormwater systems. Demolition is not to be performed during adverse winds, which may cause dust to spread beyond the site boundaries.
- (b) All contractors and employees directly involved in the removal of hazardous dusts and substances are to wear protective equipment conforming to Australian Standard AS1716 Respiratory Protective Devices.

CONSTRUCTION MATTERS

16. CONSTRUCTION HOURS

Demolition and building work must only be undertaken between the hours of 7am and 5pm on Mondays to Fridays and 8am to 3pm on Saturdays with no work to be carried out on:

- (a) Sundays and public holidays;
- (b) Excavation works involving the use of heavy earth movement equipment including rock breakers and the like must only be undertaken between the hours of 7am and 5pm on Mondays to Fridays with no such work to be carried out on Saturday, Sunday or a public holiday.

Noise from construction activities shall comply with the Protection of the Environmental Operations (Noise Control) Regulation 2017.

17. WORK OUTSIDE PROPERTY BOUNDARY

This consent does not authorise any work outside the property boundary.

18. STOCKPILES, STORAGE OF MATERIALS AND LOCATION OF BUILDING OPERATIONS

All building materials and any other items associated with the development are to be stored within the property. No materials are to be stored on Council's footpath, nature strip, or road reserve without prior Council approval.

19. CONSTRUCTION INSPECTIONS

The building works are to be inspected during construction by the Principal Certifying Authority (PCA) in accordance with the Building Legislation Amendment (Quality of Construction) Act 2002 and 162A Critical stage inspections for building work of the Environmental Planning and Assessment Regulation 2000.

20. CERTIFICATE OF SURVEY - LEVELS

All construction works are to be in accordance with the Reduced Levels (RLs) as shown on the approved plans. Certification from a Registered Surveyor certifying ground, upper floors and finished ridge levels

is to be submitted to the Principal Certifying Authority during construction and prior to continuing to a higher level of the building.

21. CERTIFICATE OF SURVEY - BOUNDARIES AND LOCATION OF BUILDING

A Certificate of Survey prepared by a Registered Surveyor setting out the boundaries of the site and the location of the building on the site is to be submitted to the Principal Certifying Authority to certify the building is located in accordance with the development consent plans. The Certificate is to be submitted prior to the construction of the external walls above the ground floor level of the building.

TREE PROTECTION AND REMOVAL

22. STREET TREES TO BE RETAINED/TREE PROTECTION

No existing street trees shall be removed without Council approval. Precautions shall be taken when working near trees to ensure their retention, including the following:

- (a) Do not store harmful or bulk materials or spoil under or near trees;
- (b) event damage to bark and root system;
- (c) Do not use mechanical methods to excavate within root zones;
- (d) Do not add or remove topsoil from under the drip line;
- (e) Do not compact ground under the drip line;
- (f) Do not mix or dispose of liquids within the drip line of the tree; and
- (g) All trees marked for retention must have a protective fence/guard placed around a nominated perimeter in accordance with AS4970-2009 "Protection of trees on construction sites.

D. PRIOR TO THE ISSUE OF AN OCCUPATION CERTIFICATE

The requirements outlined in this section are to be provided to the satisfaction of the Principal Certifying Authority in all instances, except where a condition explicitly specifies the approval of Council or a Council Officer is required, prior to the issue of an Occupation Certificate or Subdivision Certificate, whichever applies.

CERTIFICATES, LICENCES, EASEMENTS AND RESTRICTIONS

23. FINAL OCCUPATION CERTIFICATE

Prior to occupation or use of the development, the Principal Certifying Authority must issue an Occupation Certificate. The Principal Certifying Authority must be satisfied that the requirements of the Environmental Planning & Assessment Act, 1979 have been satisfied including all critical stage inspections. Documentary evidence of all required inspections is to be submitted to Council.

24. CERTIFICATION OF BASIX COMMITMENTS

The Principal Certifying Authority shall certify that the all the undertakings in the approved BASIX certificate have been completed.

25. CERTIFICATION OF RETAINED STORMWATER DRAINAGE SYSTEM

Prior to issue of any Occupation Certificate, certification is to be provided from a suitably qualified and practising Engineer or Plumber, that any retained stormwater drainage system is unblocked, in good working order and to be repaired/replaced in accordance with Council's Water Management Technical Manual and Development Control Plan and all applicable Codes, Policies, Plans, Standards and good engineering practice. A copy of the aforementioned letter of certification must be submitted to Council.

ADVISORY MATTERS

The following advisory matters are provided as additional information to ensure compliance with the relevant legislation and requirements. You must also check other Commonwealth and NSW Acts and Regulations which may apply to the works or use approved in this application.

AD1. POST CONSENT CONDITIONS REQUIRING COUNCIL INPUT

Various conditions require further input, review or approval by Council in order to be satisfied following the determination of the application (that is, post consent). In those instances, please adhere to the following process to avoid delays:

- Please read your conditions carefully.
- Information to be submitted to Council should be either via email to info@waverley.nsw.gov.au, in person (at Council's Customer Service Centre) or via post service.
- Attention the documentation to the relevant officer/position of Council (where known/specified in condition)
- Include DA reference number
- Include condition number/s seeking to be addressed
- Where multiple conditions need Council input, please try to group the documentation / email/s into relevant subjects (multiple emails for various officers may be necessary, for example).
- Information to be submitted in digital format refer to 'Electronic lodgement guidelines' on Council's website. Failure to adhere to Council's naming convention may result in documentation being rejected.
- Where files are too large for email, the digital files should be sent to Council via CD/USB. Council does not support third party online platforms (data in the cloud) for receipt of information.
- Please note in some circumstances, additional fees and/or additional documents (hard copy) may be required.
- Council's standard for review (from date the relevant officer receives documentation) is 14days. Times may vary or be delayed if information is not received in this required manner.
- Any queries, please contact Council's Duty Planner on duty.planner@waverley.nsw.gov.au

AD2. DIAL BEFORE YOU DIG

Underground assets may exist in the area that is subject to your application. In the interests of health and safety and in order to protect damage to third party assets please contact Dial before you dig at www.1100.com.au or telephone on 1100 before excavating or erecting structures (This is the law in NSW). If alterations are required to the configuration, size, form or design of the development upon contacting the Dial before You Dig service, an amendment to the development consent (or a new development application) may be necessary. Individuals owe asset owners a duty of care that must be observed when working in the vicinity of plant or assets. It is the individual's responsibility to anticipate and request the nominal location of plant or assets on the relevant property via contacting the Dial before you dig service in advance of any construction or planning activities.

AD3. TELECOMMUNICATIONS ACT 1997 (COMMONWEALTH)

Telstra (and its authorised contractors) are the only companies that are permitted to conduct works on Telstra's network and assets. Any person interfering with a facility or installation owned by Telstra is committing an offence under the Criminal Code Act 1995 (Cth) and is liable for prosecution. Furthermore, damage to Telstra's infrastructure may result in interruption to the provision of essential

services and significant costs. If you are aware of any works or proposed works which may affect or impact on Telstra's assets in any way, you are required to contact: Telstra's Network Integrity Team on Phone Number 1800810443.

AD4. BONDI - ROSE BAY SAND BODY

This site may be located within the Bondi - Rose Bay Sand Body as identified in Council's Aboriginal Cultural Heritage Study 2009. Should an object of potential Aboriginal or archaeological significance be discovered during the demolition, excavation or construction period associated with this development, works are to immediately cease and the NSW National Parks and Wildlife Service must be contacted.

Waverley Council must be notified of any referral to the NSW National Parks and Wildlife Service and be provided with a copy of any subsequent response.

AD5. TREE REMOVAL/PRESERVATION

Any trees not identified for removal in this application have not been assessed and separate approval may be required. Any pruning of trees on adjoining properties required for the erection of scaffolding and/or the construction of the building may also require approval.

	Regulated Design Record					
Projec	Project Address: 12A-14 WILGA STREET BONDI NSW 2026					
Projec	ct Title: RE	MEDIAL WORK TO ROOF				
Conse	ent No: N//	A	Body Corp. Reg No): -		
Drawing Title: COVER PAGE/LOCATION			Drawing No:	A000		
Rev	Date dd.mm.yy	Description	DP Full Name	Reg No		
-	-/-/-	-	Robert Burton	DEP0001740		

drw no	rev	title	scale
GENER	٩L		
A000	E	COVER PAGE/LOCATION PLAN	NTS
A002	В	SITE ANALYSIS PLAN	1:500 at A3
A003	D	LEGEND AND MATERIALS	NTS
A004	С	SPECIFICATIONS 1	NTS
A005	В	SPECIFICATIONS 2	NTS
PLANS			
A010	С	UNIT 11 LEVEL PLAN	1:200 at A3
A011	D	MAIN ROOF LEVEL PLAN	1:200 at A3
A012	D	TOP ROOF LEVEL PLAN	1:200 at A3
ELEVAT	IONS		
A030	D	SOUTH ELEVATION (TO WILGA ST)	1:200 at A3
A031	D	WEST ELEVATION	1:200 at A3
A032	D	NORTH INTERNAL ELEVATION	1:200 at A3
A033	D	EAST ELEVATION	1:200 at A3
DETAIL	5		
A040	В	UNIT 11 - HOB PROFILE PLAN	1:50 at A3
A050	E	UNIT 11 - TERRACE PLAN	1:50 at A3
A051	Е	UNIT 11 - PAVILION ROOF PLAN	1:50 at A3
A060	E	UNIT 11 - SECTION AA, BB	1:50 at A3
A061	E	UNIT 11 - SECTION CC, DD	1:50 at A3
A062	E	UNIT 11 - SECTION 11, 44	1:50 at A3
A063	E	UNIT 11 - SECTION 22, 33	1:50 at A3
A070	С	EXTERNAL WALL DETAILS	1:5 at A3
A071	C	EXTERNAL WALL DETAILS 2	1:5 at A3
A072	C	EXTERNAL WALL DETAILS 3	1:5 at A3
A073	C	EXTERNAL WALL DETAILS 4	1:5 at A3
A074	C	JAMB DETAILS	1:5 at A3
-	 B	WALL FLASHING	1:2 at A3

DA DRAWING LIST

BASIX CERTIFICATE No: A491076

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B 18/04/23 Drawing list updated for BASI) C 15/05/23 Tender issue D 22/05/23 Update	rev	date	notes
C 15/05/23 Tender issue D 22/05/23 Update	A	17/03/23	DA ISSUE
D 22/05/23 Update	В	18/04/23	Drawing list updated for BASIX
5 22700720 Opadio	С	15/05/23	Tender issue
T 1//0//00 H	D	22/05/23	Update
E 16/06/23 Update	E	16/06/23	Update



LOCATION PLAN

courtesy of Six Maps NSW

PLANS AMENDED

SUTECH REMEDIAL WORK TO ROOF 12A-14 WILGA STREET BONDI NSW 2026 LOT:25 DP:SP4233

scale	NTS
drawn	RB
project no	BA2217
drawing title	COVER PAGE/LOCATION

A000

burtonarchitecture.com ABN 25 457 669 610 NSW Registered Architect Rob Burton 9224

	Regulated Design Record				
Projec	Project Address: 12A-14 WILGA STREET BONDI NSW 2026				
Projec	ct Title: RE	MEDIAL WORK TO ROOF			
Conse	ent No: N/A	J	Body Corp. Reg No): -	
Drawing Title: SITE ANALYSIS PLAN Draw			Drawing No:	A002	
Rev	Date dd.mm.yy	Description	DP Full Name	Reg No	
-	-/-/-	-	Robert Burton	DEP0001740	

AMENDED **PLANS**

DOTTED LINE INDICATES OUTLINE OF PROPOSED REBUILT PAVILION STRUCTURE, BALUSTRADE AND

RECEIVED **Waverley Council**

Application No: DA-99/2023

Date Received: 16/06/2023



VIEW A FROM WILGA STREET



PRIVACY SCREEN REDUCED IN HEIGHT TO 1700mm


VIEW B FROM WILGA STREET



VIEW C FROM UPPER LEVEL COURTYARD DECK ACCESS



VIEW D FROM ROOF LOOKING WEST TO ROOF PAVILION

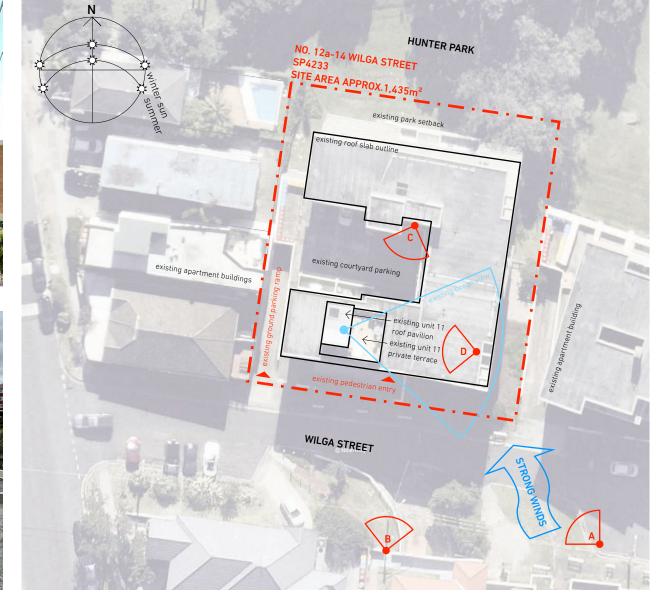

SITE ANALYSIS PLAN 1:500

EXISTING PHOTOS

BASIX CERTIFICATE No: A491076

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rev	date	notes
Α	17/03/23	DA ISSUE
В	15/05/23	Tender issue

	client	SUTECH
	project	REMEDIAL WORK TO R
		12A-14 WILGA STREET
-		BONDI NSW 2026
		LOT:25 DP:SP4233

client	SUTECH	
project	REMEDIAL WORK TO ROOF	
12A-14 WILGA STREET		TREET
	BONDI NSW 2026	
	LOT:25 DP:SP423	33

scale	NTS
drawn	RB
project no	BA2217
drawing title	SITE ANALYSIS PLAN

A002

drawing no

burtonarchitecture.com ABN 25 457 669 610 NSW Registered Architect Rob Burton 9224

		Regulated Design Re	ecord	
Projec	ct Address: 12	A-14 WILGA STREET BONDI NS	SW 2026	
Projec	ct Title: RE	MEDIAL WORK TO ROOF		
Conse	ent No: N/	A	Body Corp. Reg No): -
Drawing Title: LEGEND/MATERIALS			Drawing No:	A003
Rev	Date dd.mm.yy	Description	DP Full Name	Reg No
-	-/-/-	-	Robert Burton	DEP0001740
1	1		1	I

REFER TO SEPARATE HYDRAULIC AND STRUCTURAL PLANS/SPECIFICATIONS

GENERAL LEGEND:

BED BEDROOM BRICKWORK BK BATHROOM BALCONY CENTRE CONCRETE FINISH CONTROL JOINT CHECK ON SITE FC CLADDING GREY FC CLADDING OFF WHITE CT CERAMIC TILING CT·01 TERRACE FLOOR TILING EXPANSION JOINT EJ EXISTING EX

FALL FFL FINISHED FLOOR LEVEL TO AHD

FINISHED PAVING LEVEL

GB:01 FRAMELESS CLEAR GLASS BALUSTRADE

WITH STAINLESS STEEL HANDRAIL

GLC GLAZING CLEAR GLT GLAZING TRANSLUCENT

KIT KITCHEN

LIVING ROOM / DINING

OVER FLOW PLANTING PLT

RF:01 COLORBOND STEEL CAPPING

PROFILED STEEL CASSETTE ROOFING RF:02

WINDSPRAY

RELATIVE LEVEL TO AHD RENDER FINISH RAINWATER OUTLET ROOF VENT

STORMWATER DRAIN

STRUCTURAL JOINT SETTING OUT POINT SP SERVICES PEDESTAL

TILE JOINT UP STEPS VOID VENT PIPE

WATERPROOF MEMBRANE

WINDOW



AMENDED PLANS

FC CLADDING TO MATCH EXISTING OFF WHITE COLOUR

FC CLADDING TO MATCH EXISTING GREY COLOUR



FRAMELESS CLEAR GLASS BALUSTRADE: with stainless steel capping handrail and

> **RECEIVED Waverley Council**

Application No: DA-99/2023

Date Received: 16/06/2023

BASIX CERTIFICATE No: A491076

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rev	date	notes
Α	17/03/23	DA ISSUE
В	15/05/23	Tender issue
С	22/05/23	Update
D	16/06/23	Clear glass balustrade

	client	SUTECH
	project	REMEDIAL WORK TO ROO
		12A-14 WILGA STREET
		BONDI NSW 2026
		LOT:25 DP:SP4233

	scale	NTS
	drawn	RB
	project no	BA2217
WORK TO ROOF	drawing title	LEGEND/MAT
LGA STREET		
V 2026		
SP4233	drawing no	A003

scale	NTS
drawn	RB
project no	BA2217
drawing title	LEGEND/MATERIALS

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		Regulated Design Re	ecord		
Projec	ct Address: 12	A-14 WILGA STREET BONDI NS	SW 2026		
Projec	ct Title: RE	MEDIAL WORK TO ROOF			
Conse	ent No: N//	t e	Body Corp. Reg No); -	
Drawing Title: UNIT 11 LEVEL PLAN Drawing No: A010			A010		
Rev	Date dd.mm.yy	Description	DP Full Name	Reg No	
-	-/-/-	-	Robert Burton	DEP0001740	
	1			I	

REFER TO SEPARATE HYDRAULIC AND STRUCTURAL

PLANS/SPECIFICATIONS

GENERAL LEGEND:

BED BEDROOM BRICKWORK BATHROOM BALCONY CENTRE CONCRETE FINISH CONTROL JOINT CHECK ON SITE PAINTED FC CLADDING

LIGHTWEIGHT STEEL FRAMED WALL

WITH MIN R1.3 INSULATION CERAMIC TILING CT:01 TERRACE FLOOR TILING FΙ EXPANSION JOINT

EX EXISTING

FFI FINISHED FLOOR LEVEL TO AHD FINISHED PAVING LEVEL FPL

FW FLOOR WASTE

GLAZED DOOR FRAMELESS CLEAR GLASS BALUSTRADE WITH STAINLESS STEEL HANDRAIL GLAZING CLEAR

GLAZING TRANSLUCENT

KIT KITCHEN

LIVING ROOM / DINING OVER FLOW

PA·01 PAINT FINISH - TO MATCH EXISTING GREY

PAINT FINISH - TO MATCH EXISTING WHITE PA·N2

PLT PI ANTING RF:01 COLORBOND STEEL CAPPING

PROFILED STEEL CASSETTE ROOFING RF:02

WINDSPRAY RELATIVE LEVEL TO AHD

RENDER FINISH

RAINWATER OUTLET

ROOF VENT

STRUCTURAL JOINT SETTING OUT POINT

SP SERVICES PEDESTAL

SWD STORMWATER DRAIN

TILE JOINT UP STEPS

VOID

VENT PIPE

WINDOW

TOILET

WATERPROOF MEMBRANE

KEY:

AREA OF REMEDIAL BUILDING WORK ELEMENT TO BE REMOVED

BASIX CERTIFICATE No: A491076

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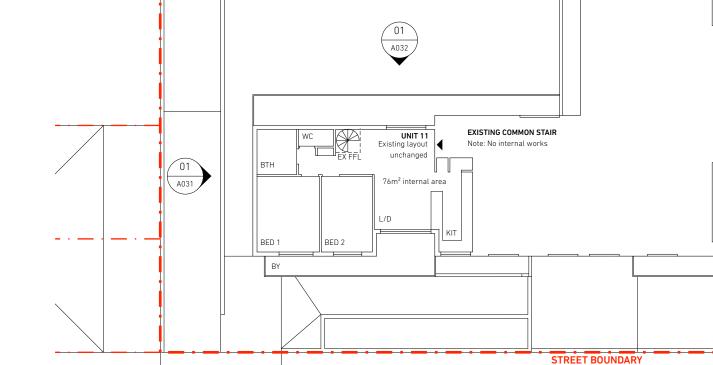


rev date 17/03/23 DA ISSUE B 15/05/23 Tender issue 16/06/23 Clear glass balustrade

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Application No: DA-99/2023

Date Received: 16/06/2023



REAR BOUNDARY TO HUNTER PARK

EXISTING COMMON STAIR

Note: No internal works

WILGA STREET

LIFT SHAFT

PLANS

AMENDED



	client	SUTECH	- -
	project	REMEDIAL WORK TO ROOF	-
		12A-14 WILGA STREET	
		BONDI NSW 2026	
		LOT:25 DP:SP4233	
			project REMEDIAL WORK TO ROOF 12A-14 WILGA STREET BONDI NSW 2026

scale	1:200 at A3
drawn	RB
project no	BA2217
drawing title	UNIT 11 LEVEL PLAN


A010

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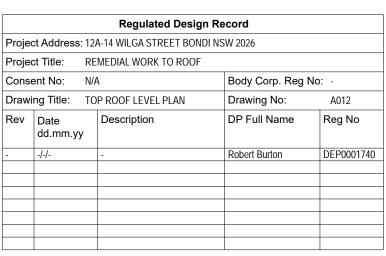
01 A033

BURTON /c ARCHITECTURE

Page 131 of 500

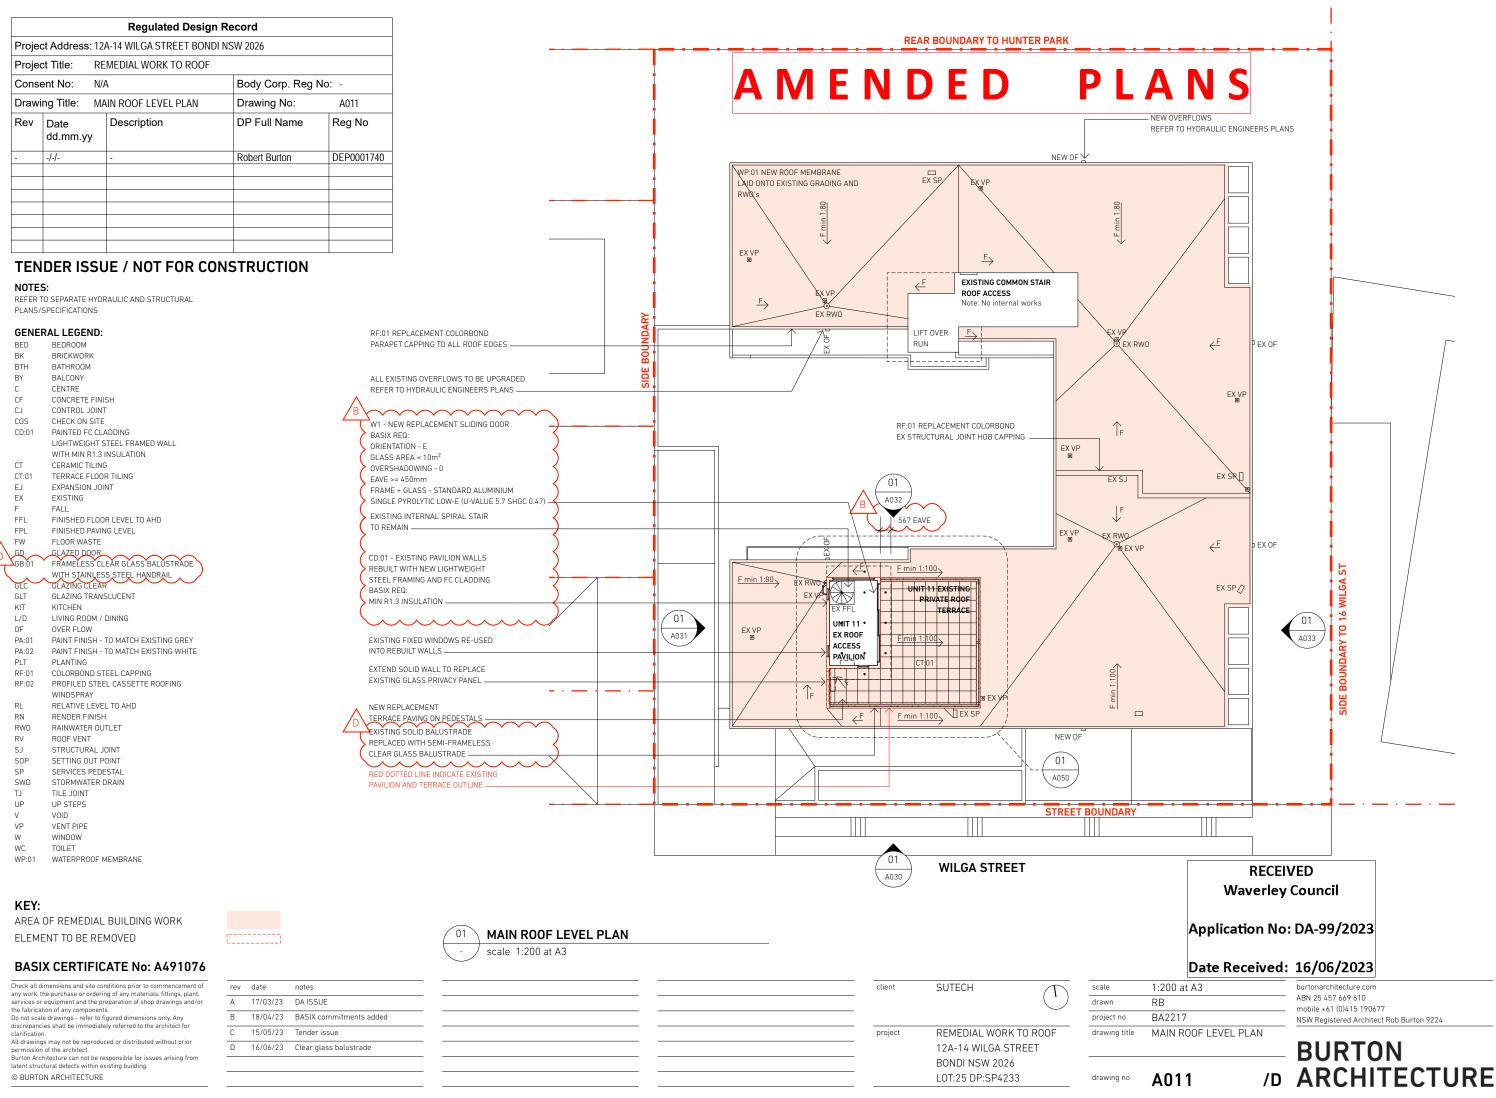

Page 132 of 500



REFER TO SEPARATE HYDRAULIC AND STRUCTURAL

PLANS/SPECIFICATIONS

GENERAL LEGEND:

BED BEDROOM BRICKWORK BATHROOM BTH BALCONY CENTRE CONCRETE FINISH CONTROL JOINT CHECK ON SITE PAINTED FC CLADDING

LIGHTWEIGHT STEEL FRAMED WALL WITH MIN R1.3 INSULATION CERAMIC TILING CT:01 TERRACE FLOOR TILING

FΙ EXPANSION JOINT EX EXISTING FALL

FINISHED FLOOR LEVEL TO AHD FFI FINISHED PAVING LEVEL FPL FW FLOOR WASTE

GLAZED DOOR FRAMELESS CLEAR GLASS BALUSTRADE

WITH STAINLESS STEEL HANDRAIL GLAZING CLEAR GLAZING TRANSLUCENT

KIT KITCHEN

LIVING ROOM / DINING ΩF OVER FLOW

PA·01

PAINT FINISH - TO MATCH EXISTING GREY

PAINT FINISH - TO MATCH EXISTING WHITE PA·N2

PLT PI ANTING RF:01 COLORBOND STEEL CAPPING

PROFILED STEEL CASSETTE ROOFING RF:02

WINDSPRAY

RELATIVE LEVEL TO AHD

RENDER FINISH RAINWATER OUTLET

ROOF VENT STRUCTURAL JOINT

SETTING OUT POINT

SP SERVICES PEDESTAL

SWD STORMWATER DRAIN TILE JOINT

UP STEPS

VOID

VENT PIPE

WINDOW

TOILET

WATERPROOF MEMBRANE

ELEMENT TO BE REMOVED

KEY:

AREA OF REMEDIAL BUILDING WORK

BASIX CERTIFICATE No: A491076

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TOP ROOF LEVEL PLAN

scale 1:200 at A3

RED DOTTED LINE INDICATE EXISTING

EXISTING SKYLIGHT REMOVED

EXISTING UNIT 11 PAVILION STEEL

FRAMED ROOF REPLACED WITH NEW

MIN 50mm FOIL BACKED POLYSTYRENE

PAVILION PROFILE

GUTTER AND DP BASIX REQ:

FOAM INSULATION

RECEIVED

Waverley Council

Application No: DA-99/2023

Date Received: 16/06/2023

SOLAR ABSORPTION < 0.47

rev	date	notes
Α	17/03/23	DA ISSUE
В	18/04/23	BASIX commitments added
С	15/05/23	Tender issue
D	16/06/23	Clear glass balustrade

	-
	-

A031

client	SUTECH	scale
	·	drawn
		project no
project	REMEDIAL WORK TO ROOF	drawing title
	12A-14 WILGA STREET	
	BONDI NSW 2026	
	LOT:25 DP:SP4233	drawing no

WILGA STREET

A051

STREET BOUNDARY

REAR BOUNDARY TO HUNTER PARK

PLANS

AMENDED

EXISTING CORE ROOF

A032

·-----

scale 1:200 at A3 drawn RB project no BA2217 drawing title TOP ROOF LEVEL PLAN		
project no BA2217	scale	1:200 at A3
	drawn	RB
drawing title TOP ROOF LEVEL PLAN	project no	BA2217
	drawing title	TOP ROOF LEVEL PLAN

A012

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A033

		Regulated Design Re	ecord	
Projec	ct Address: 12	A-14 WILGA STREET BONDI NS	SW 2026	
Projec	ct Title: RI	EMEDIAL WORK TO ROOF		
Conse	ent No: N/	A	Body Corp. Reg No): -
Drawi	ng Title: S0	OUTH ELEVATION	Drawing No:	A030
Rev	Date dd.mm.yy	Description	DP Full Name	Reg No
-	-/-/-	-	Robert Burton	DEP0001740

NOTES:

REFER TO SEPARATE HYDRAULIC AND STRUCTURAL

PLANS/SPECIFICATIONS

GENERAL LEGEND:

 BED
 BEDROOM

 BK
 BRICKWORK

 BTH
 BATHROOM

 BY
 BALCONY

 C
 CENTRE

 CF
 CONCRETE FINISH

 CJ
 CONTROL JOINT

 COS
 CHECK ON SITE

 CD:01
 PAINTED FC CLADDING

LIGHTWEIGHT STEEL FRAMED WALL WITH MIN R1.3 INSULATION

CT CERAMIC TILING
CT:01 TERRACE FLOOR TILING
EJ EXPANSION JOINT
EX EXISTING
F FALL

FFL FINISHED FLOOR LEVEL TO AHD
FPL FINISHED PAVING LEVEL
FW FLOOR WASTE

GD GLAZED DOOR GB:01 FRAMELESS CLEAR GLASS BALUSTRADE

WITH STAINLESS STEEL HANDRAIL
GLAZING CLEAR

GLT GLAZING TRANSLUCENT KIT KITCHEN

L/D LIVING ROOM / DINING
OF OVER FLOW

PA:01 PAINT FINISH - TO MATCH EXISTING GREY

PA:02 PAINT FINISH - TO MATCH EXISTING WHITE PLT PLANTING

RF:01 COLORBOND STEEL CAPPING
RF:02 PROFILED STEEL CASSETTE ROOFING

WINDSPRAY

RL RELATIVE LEVEL TO AHD

RN RENDER FINISH

RWO RAINWATER OUTLET

RV ROOF VENT

SJ STRUCTURAL JOINT

SOP SETTING OUT POINT

SP SERVICES PEDESTAL

SWD STORMWATER DRAIN

SWD STORMWATE
TJ TILE JOINT
UP UP STEPS
V VOID
VP VENT PIPE
W WINDOW
WC TOILET

WP:01 WATERPROOF MEMBRANE

KEY:

AREA OF REMEDIAL BUILDING WORK ELEMENT TO BE REMOVED

BASIX CERTIFICATE No: A491076

rev date

17/03/23 DA ISSUE

15/05/23 Tender issue

D 16/06/23 Clear glass balustrade

18/04/23 BASIX commitments added

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clarification.
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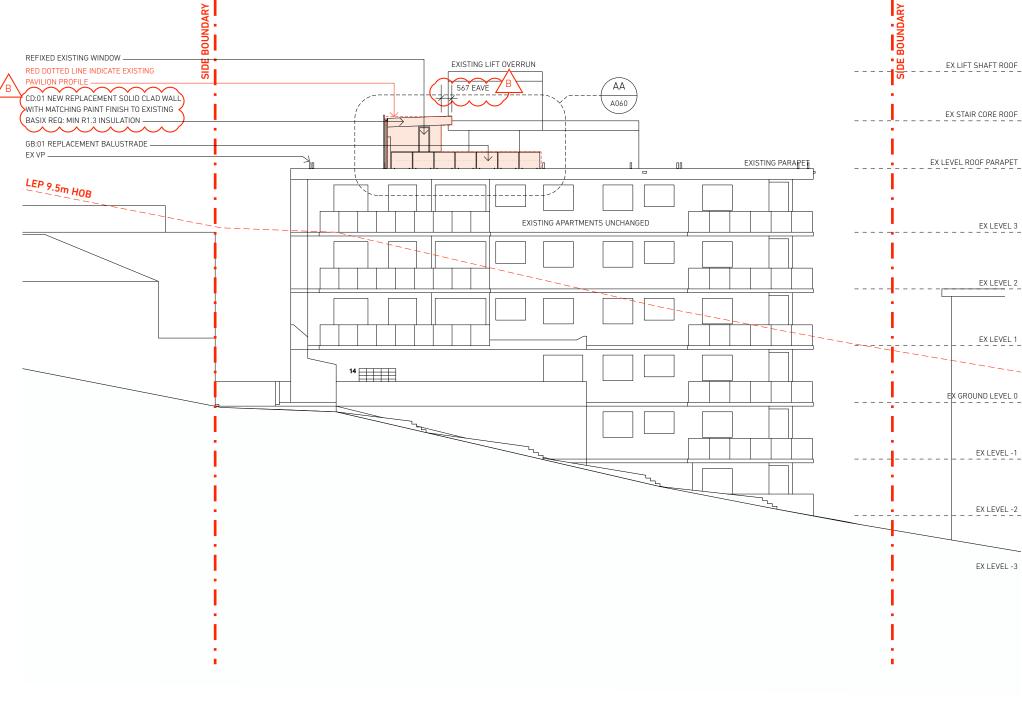
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Waverley Council

Application No: DA-99/2023

Date Received: 16/06/2023

AMENDED PLANS





project REMEDIAL WORK TO ROOF
12A-14 WILGA STREET
BONDI NSW 2026
LOT:25 DP:SP4233

 scale
 1:200 at A3

 drawn
 RB

 project no
 BA2217

 drawing title
 SOUTH ELEVATION

A030

drawing no

burtonarchitecture.com ABN 25 457 669 610 mobile +61 (0)415 190677 NSW Registered Architect Rob Burton 9224

BURTON
/D ARCHITECTURE

Page 134 of 500

		Regulated Design Re	cord	
Projec	ct Address: 12/	A-14 WILGA STREET BONDI NS	W 2026	
Projec	t Title: RE	MEDIAL WORK TO ROOF		
Conse	ent No: N/A	1	Body Corp. Reg No	: -
Drawing Title: WEST ELEVATION Drawing No: A031			A031	
Rev	Date dd.mm.yy	Description	DP Full Name	Reg No
-	-/-/-	-	Robert Burton	DEP0001740

REFER TO SEPARATE HYDRAULIC AND STRUCTURAL

PLANS/SPECIFICATIONS

GENERAL LEGEND:

BED BEDROOM BRICKWORK BATHROOM BTH BALCONY CENTRE CONCRETE FINISH CONTROL JOINT CHECK ON SITE PAINTED FC CLADDING

LIGHTWEIGHT STEEL FRAMED WALL

WITH MIN R1.3 INSULATION CERAMIC TILING

CT:01 TERRACE FLOOR TILING FΙ EXPANSION JOINT

EX EXISTING FALL

FFI FINISHED FLOOR LEVEL TO AHD FPL FINISHED PAVING LEVEL

FW FLOOR WASTE

GLAZED DOOR FRAMELESS CLEAR GLASS BALUSTRADE WITH STAINLESS STEEL HANDRAIL GLAZING CLEAR

GLAZING TRANSLUCENT KIT KITCHEN

LIVING ROOM / DINING

OVER FLOW

PAINT FINISH - TO MATCH EXISTING GREY PA·01

PAINT FINISH - TO MATCH EXISTING WHITE PA·N2

PI ANTING RF:01

COLORBOND STEEL CAPPING

PROFILED STEEL CASSETTE ROOFING RF:02

WINDSPRAY RELATIVE LEVEL TO AHD

RENDER FINISH

RAINWATER OUTLET

ROOF VENT

STRUCTURAL JOINT SETTING OUT POINT

SP SERVICES PEDESTAL

SWD STORMWATER DRAIN TILE JOINT

UP STEPS

VOID

VENT PIPE WINDOW

TOILET

WATERPROOF MEMBRANE

KEY:

AREA OF REMEDIAL BUILDING WORK ELEMENT TO BE REMOVED

BASIX CERTIFICATE No: A491076

rev date

17/03/23 DA ISSUE

C 15/05/23 Tender issue

D 16/06/23 Clear glass balustrade

18/04/23 BASIX commitments added

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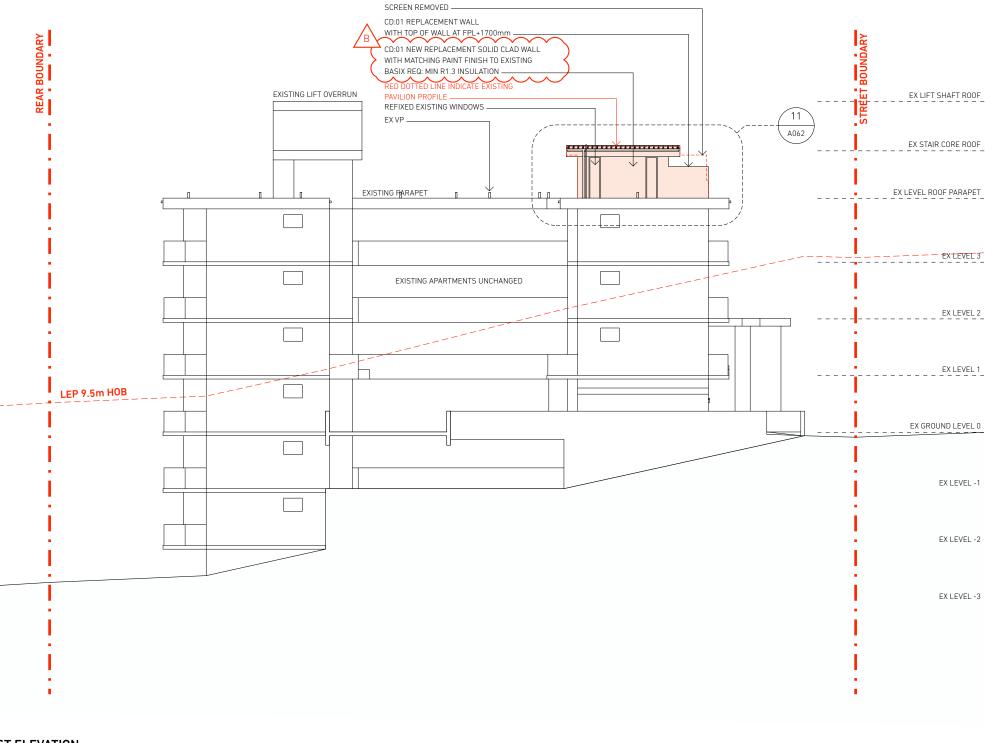
Application No: DA-99/2023

Waverley Council

Date Received: 16/06/2023

AMENDED PLANS

EXISTING SANDBLASTED GLASS PRIVACY





	 client	SUTECH
	project	REMEDIAL WORK TO ROOF
		12A-14 WILGA STREET
		BONDI NSW 2026
		LOT:25 DP:SP4233
-		

scale	1:200 at A3
drawn	RB
project no	BA2217
drawing title	WEST ELEVATION

A031

burtonarchitecture.com ABN 25 457 669 610 NSW Registered Architect Rob Burton 9224

BURTON /D ARCHITECTURE

Page 135 of 500

	Regulated Design Record				
Project Address: 12A-14 WILGA STREET BONDI NSW 2026					
Projec	Project Title: REMEDIAL WORK TO ROOF				
Conse	Consent No: N/A Body Corp. Reg No: -				
Drawi	ng Title: NC	ORTH ELEVATION	Drawing No:	A032	
Rev	Date dd.mm.yy	Description	DP Full Name	Reg No	
-	-/-/-	-	Robert Burton	DEP0001740	

REFER TO SEPARATE HYDRAULIC AND STRUCTURAL

PLANS/SPECIFICATIONS

GENERAL LEGEND:

BEDROOM BRICKWORK BATHROOM BALCONY CENTRE CONCRETE FINISH CONTROL JOINT CHECK ON SITE

LIGHTWEIGHT STEEL FRAMED WALL

WITH MIN R1.3 INSULATION

CERAMIC TILING CT:01 TERRACE FLOOR TILING FΙ EXPANSION JOINT

EX EXISTING

FINISHED FLOOR LEVEL TO AHD FFI FINISHED PAVING LEVEL FPI

FW FLOOR WASTE

GLAZED DOOR FRAMELESS CLEAR GLASS BALUSTRADE

WITH STAINLESS STEEL HANDRAIL GLAZING CLEAR GLAZING TRANSLUCENT

KITCHEN

LIVING ROOM / DINING

OVER FLOW

PA·01 PAINT FINISH - TO MATCH EXISTING GREY

PAINT FINISH - TO MATCH EXISTING WHITE PA·N2

PI ANTING RF:01

COLORBOND STEEL CAPPING PROFILED STEEL CASSETTE ROOFING RF:02

WINDSPRAY

RELATIVE LEVEL TO AHD

RENDER FINISH RAINWATER OUTLET

ROOF VENT STRUCTURAL JOINT

SETTING OUT POINT

SERVICES PEDESTAL SWD STORMWATER DRAIN

TILE JOINT

UP STEPS VOID

VENT PIPE

WINDOW TOILET

WATERPROOF MEMBRANE

KEY:

AREA OF REMEDIAL BUILDING WORK ELEMENT TO BE REMOVED

BASIX CERTIFICATE No: A491076

rev date

17/03/23 DA ISSUE

15/05/23 Tender issue

D 16/06/23 Clear glass balustrade

18/04/23 BASIX commitments added

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RECEIVED

Waverley Council

Application No: DA-99/2023

Date Received: 16/06/2023

NORTH ELEVATION (THROUGH COURTYARD)

scale 1:200 at A3



client	SUTECH
project	REMEDIAL WORK TO ROOF
	12A-14 WILGA STREET
	BONDI NSW 2026
	LOT:25 DP:SP4233

AMENDED PLANS

567 EAVE

EXISTING APARTMENTS UNCHANGED

DD)

√ A061

CD:01 NEW REPLACEMENT SOLID CLAD WALL WITH MATCHING PAINT FINISH TO EXISTING

BASIX REQ: MIN R1.3 INSULATION -

PAVILION PROFILE -

REFIXED EXISTING WINDOW -

RED DOTTED LINE INDICATE EXISTING

GB:01 REPLACEMENT BALUSTRADE

scale	1:200 at A3
drawn	RB
project no	BA2217
drawing title	NORTH ELEVATION

NSW Registered Architect Rob Burton 9224

EX LIFT SHAFT ROOF

EX STAIR CORE ROOF

EX LEVEL ROOF PARAPET

EX LEVEL 3

EX LEVEL 2

EX LEVEL 1

EX GROUND LEVEL 0

EX LEVEL -1

EX LEVEL -2

EX LEVEL -3

BURTON /D ARCHITECTURE A032

burtonarchitecture.com ABN 25 457 669 610

Regulated Design Record **Waverley Council** Project Address: 12A-14 WILGA STREET BONDI NSW 2026 REMEDIAL WORK TO ROOF Application No: DA-99/2023 Body Corp. Reg No: Consent No: Drawing Title: EAST ELEVATION Drawing No: Date Received: 16/06/2023 Rev Description DP Full Name Reg No Date dd.mm.yy AMENDED **PLANS** DEP0001740 Robert Burton TENDER ISSUE / NOT FOR CONSTRUCTION EXISTING LIFT OVERRUN EX LIFT SHAFT ROOF REFER TO SEPARATE HYDRAULIC AND STRUCTURAL PLANS/SPECIFICATIONS EXISTING SANDBLASTED GLASS PRIVACY A063 **GENERAL LEGEND:** EX STAIR CORE ROOF RED DOTTED LINE INDICATE EXISTING BED BEDROOM PAVILION PROFILE -BRICKWORK CD:01 NEW REPLACEMENT SOLID CLAD WALL BTH BATHROOM WITH TOP OF WALL AT FPL+1700mm BALCONY EX LEVEL ROOF PARAPET CENTRE W1 REPLACEMENT SLIDING GLASS DOORS CONCRETE FINISH BASIX REQ: CONTROL JOINT ORIENTATION - F CHECK ON SITE GLASS AREA < 10m² PAINTED FC CLADDING OVERSHADOWING - 0 EXISTING APARTMENTS UNCHANGED LIGHTWEIGHT STEEL FRAMED WALL EX LEVEL 3 EAVE >= 450mm WITH MIN R1.3 INSULATION FRAME + GLASS - STANDARD ALUMINIUM CERAMIC TILING SINGLE PYROLYTIC LOW-E (U-VALUE 5.7 SHGC 0.47) CT:01 TERRACE FLOOR TILING FΙ EXPANSION JOINT EX EXISTING GB:01 REPLACEMENT BALUSTRADE EX LEVEL 2 FFI FINISHED FLOOR LEVEL TO AHD FPI FINISHED PAVING I EVEL FW FLOOR WASTE GLAZED DOOR FRAMELESS CLEAR GLASS BALUSTRADE EX LEVEL 1 WITH STAINLESS STEEL HANDRAIL GLAZING CLEAR GLAZING TRANSLUCENT KIT KITCHEN EX GROUND LEVEL 0 LIVING ROOM / DINING OVER FLOW PA:01 PAINT FINISH - TO MATCH EXISTING GREY PAINT FINISH - TO MATCH EXISTING WHITE PA·N2 PIT PI ANTING RF:01 COLORBOND STEEL CAPPING EX LEVEL -1 PROFILED STEEL CASSETTE ROOFING RF:02 WINDSPRAY RELATIVE LEVEL TO AHD RENDER FINISH RAINWATER OUTLET EX LEVEL -2 ROOF VENT STRUCTURAL JOINT SETTING OUT POINT SP SERVICES PEDESTAL SWD STORMWATER DRAIN EX LEVEL -3 TILE JOINT UP STEPS VOID VENT PIPE WINDOW TOILET WATERPROOF MEMBRANE KEY: AREA OF REMEDIAL BUILDING WORK **EAST ELEVATION** ELEMENT TO BE REMOVED scale 1:200 at A3 **BASIX CERTIFICATE No: A491076** Check all dimensions and site conditions prior to commencement of any work, the purchase or ordering of any materials, fittings, plant, SUTECH 1:200 at A3 rev date client scale burtonarchitecture.com ABN 25 457 669 610 17/03/23 DA ISSUE RB drawn services or equipment and the preparation of shop drawings and/or mobile +61 (0)415 190677 the fabrication of any components. Do not scale drawings - refer to figured dimensions only. Any discrepancies shall be immediately referred to the architect for 18/04/23 BASIX commitments added BA2217 project no NSW Registered Architect Rob Burton 9224 REMEDIAL WORK TO ROOF EAST ELEVATION 15/05/23 Tender issue project drawing title clarification.
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12A-14 WILGA STREET BONDI NSW 2026

drawing no

A033

LOT:25 DP:SP4233

BURTON

/D ARCHITECTURE

D 16/06/23 Clear glass balustrade

	Regulated Design Record				
Projec	ct Address: 12/	A-14 WILGA STREET BONDI NS	SW 2026		
Projec	Project Title: REMEDIAL WORK TO ROOF				
Conse	ent No: N/A	1	Body Corp. Reg No): -	
Drawing Title: UNIT 11 TERRACE PLAN Drawing No: A			A050		
Rev	Date dd.mm.yy	Description	DP Full Name	Reg No	
-	-/-/-	-	Robert Burton	DEP0001740	

REFER TO SEPARATE HYDRAULIC AND STRUCTURAL

PLANS/SPECIFICATIONS

GENERAL LEGEND:

BED BEDROOM BRICKWORK BTH BATHROOM BALCONY CENTRE CONCRETE FINISH CONTROL JOINT

CHECK ON SITE FC CLADDING LIGHTWEIGHT STEEL FRAMED WALL

WITH MIN R1.3 INSULATION CERAMIC TILING CT:01 TERRACE FLOOR TILING

FΙ EXPANSION IOINT EX FXISTING

FALL FFI FINISHED FLOOR LEVEL TO AHD FPI FINISHED PAVING LEVEL

FW FLOOR WASTE

GLAZED DOOR FRAMELESS CLEAR GLASS BALUSTRADE

WITH STAINLESS STEEL HANDRAIL GLAZING CLEAR GLAZING TRANSLUCENT

KIT KITCHEN L/D LIVING ROOM / DINING

OVER FLOW

PAINT FINISH - TO MATCH EXISTING GREY PA:01 PAINT FINISH - TO MATCH EXISTING WHITE PA·N2

PIT PI ANTING RF:01 COLORBOND STEEL CAPPING

PROFILED STEEL CASSETTE ROOFING RF:02 WINDSPRAY RELATIVE LEVEL TO AHD

RENDER FINISH RAINWATER OUTLET ROOF VENT

STRUCTURAL JOINT SETTING OUT POINT SP

SERVICES PEDESTAL SWD STORMWATER DRAIN TILE JOINT UP STEPS VOID

VENT PIPE WINDOW TOILET

WATERPROOF MEMBRANE

KEY:

AREA OF REMEDIAL BUILDING WORK ELEMENT TO BE REMOVED

BASIX CERTIFICATE No: A491076

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RECEIVED

rev date

17/03/23 DA ISSUE

22/05/23 Updated

15/05/23 Issued for tender

16/06/23 Clear balustrade

18/04/23 BASIX commitments added

Waverley Council

ROOF EAVE OVERHANG

TO MATCH EXISTING EXISTING OVERFLOW SPOUT

Application No: DA-99/2023

Date Received: 16/06/2023

F EX 02 REFIX EXISTING WINDOW SLOT IN HOB FOR DRAINAGE EXISTING RWO -EX STAIR REPLACEMENT DP ANDING 00 EXISTING VP OFF-SET TO AVOID WINDOW AND DISCHARGE ABOVE ROOF TBC ON-SITE LT:01 F min 1:100 REFIX EXISTING FIXED WINDOW -EXISTING SPIRAL STAIR -CD:01 - NEW REPLACEMENT WALL CONSTRUCTION UNIT 11 EXISTING PRIVATE UNIT 11 FROM INSIDE: ROOF TERRACE EXISTING ROOF ACCESS PAVILION 1. 10mm P/B0ARD REBUILT TO EXISTING ENVELOPE ALIGN TOP 2. 92mm LIGHT STEEL FRAMING FPL FX FFI PAVING ON BUZON PEDESTALS TO STRUCTURAL ENGINEERS C/S + STRAP BRACING WITH MEMBRANE TO FALLS UNDER + R2.5 GOLD INSULATION BATTS 3. ENVIROSEAL PROCTOR WRAP CW-IT LT:01⊕′\ LT:01 WITH TAPED JOINTS 4. DUAL LAYER OF DCTECH NV9 ALUMINIUM CAVITY F EX CLADDING RAILS EX FFL 5. 9mm CEMINTEL EDGE BOND BASIX REQ: MIN R1.3 INSULATION SLOT IN HOB FOR DRAINAGE -REFIX EXISTING FIXED WINDOW -EXISTING WALLS REBUILT WITH LIGHTWEIGHT 01 LT:01 TO SAME PROFILE TO SUIT EXISTING WINDOWS A074 REFER TO STRUCTURAL ENGINEERS DETAILS FOR FRAMING AND BASE PLATES SLOT IN HOB FOR DRAINAGE -REFIX EXISTING FIXED WINDOW -EXTEND WALL TO FORM PRIVACY SCREEN UP TO HEIGHT OF FPL+1700mm REMOVE EXISTING FROSTED GLASS SCREEN : F min 1:100 F min 1:10 SLOT IN HOB FOR PRAINAGE EXISTING SOLID BALUSTRADE REPLACED WITH HOB AND SEMI-FRAMELESS GLASS BALUSTRADES -O EX VP WP:01 - NEW MEMBRANE AND SCREED TO FALLS ON EXISTING STRUCTURAL SLAB. 2510 | ← FEX FEX 7760 200 160 RF:01 - NEW PARAPET ROOF CAPPING -

567 EAVE



CT:01 NEW LEVEL TERRACE PORCELAIN PAVING ON PEDESTALS WITH WP:01 UNDER TO FALLS -

A062

SUTECH client REMEDIAL WORK TO ROOF project 12A-14 WILGA STREET BONDI NSW 2026 LOT:25 DP:SP4233

44

A062

1:50 at A3 scale RB drawn BA2217 project no UNIT 11 TERRACE PLAN drawing title

A050

drawing no

AMENDED

burtonarchitecture.com ABN 25 457 669 610 mobile +61 (0)415 190677 NSW Registered Architect Rob Burton 9224

BURTON /E ARCHITECTURE

PLANS

		Regulated Design	Record	
Proje	ct Address: 12	A-14 WILGA STREET BONDI	NSW 2026	
Proje	ct Title: RE	MEDIAL WORK TO ROOF		
Cons	ent No: N//	I	Body Corp. Reg	No: -
Draw	ing Title: UN	IIT 11 ROOF PLAN	Drawing No:	A051
Rev	Date dd.mm.yy	Description	DP Full Name	Reg No
-	-/-/-	-	Robert Burton	DEP0001740
TEN	IDER ISSU	JE / NOT FOR CON	NSTRUCTION	
NOTE REFER	S:	RAULIC AND STRUCTURAL		
GENE BED BK BTH	BEDROOM BRICKWORK BATHROOM			

BALCONY CENTRE CONCRETE FINISH CONTROL JOINT CHECK ON SITE

FC CLADDING LIGHTWEIGHT STEEL FRAMED WALL

WITH MIN R1.3 INSULATION CERAMIC TILING CT:01 TERRACE FLOOR TILING FΙ EXPANSION JOINT

EXISTING FALL FFL FINISHED FLOOR LEVEL TO AHD FPL

EX

FINISHED PAVING LEVEL FW FLOOR WASTE

GLAZED DOOR FRAMELESS CLEAR GLASS BALUSTRADE WITH STAINLESS STEEL HANDRAIL GLAZING CLEAR

GLAZING TRANSLUCENT KIT KITCHEN

L/D LIVING ROOM / DINING

ΩF OVER FLOW

PA·01 PAINT FINISH - TO MATCH EXISTING GREY PAINT FINISH - TO MATCH EXISTING WHITE PA·N2 PI ANTING

PLT RF:01 COLORBOND STEEL CAPPING

PROFILED STEEL CASSETTE ROOFING RF:02

WINDSPRAY RELATIVE LEVEL TO AHD RENDER FINISH RAINWATER OUTLET

ROOF VENT STRUCTURAL JOINT SETTING OUT POINT SP SERVICES PEDESTAL

SWD STORMWATER DRAIN TILE JOINT TJ UP STEPS VOID VENT PIPE WINDOW TOILET

WATERPROOF MEMBRANE

KEY: AREA OF REMEDIAL BUILDING WORK

ELEMENT TO BE REMOVED

BASIX CERTIFICATE No: A491076


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UNIT 11 ROOF PLAN scale 1:50 at A3

rev	date	notes
Α	17/03/23	DA ISSUE
В	18/04/23	BASIX commitments added
С	15/05/23	Issued for tender
D	22/05/23	Updated
E	16/06/23	Clear balustrade

	client	SUTECH	$\overline{\mathcal{T}}$
	project	REMEDIAL WORK TO) R00F
		12A-14 WILGA STRE	EET
 		BONDI NSW 2026	
		LOT:25 DP:SP4233	

scale	1:50 at A3	
drawn	RB	
project no	BA2217	
drawing title	UNIT 11 ROOF PLAN	

A051
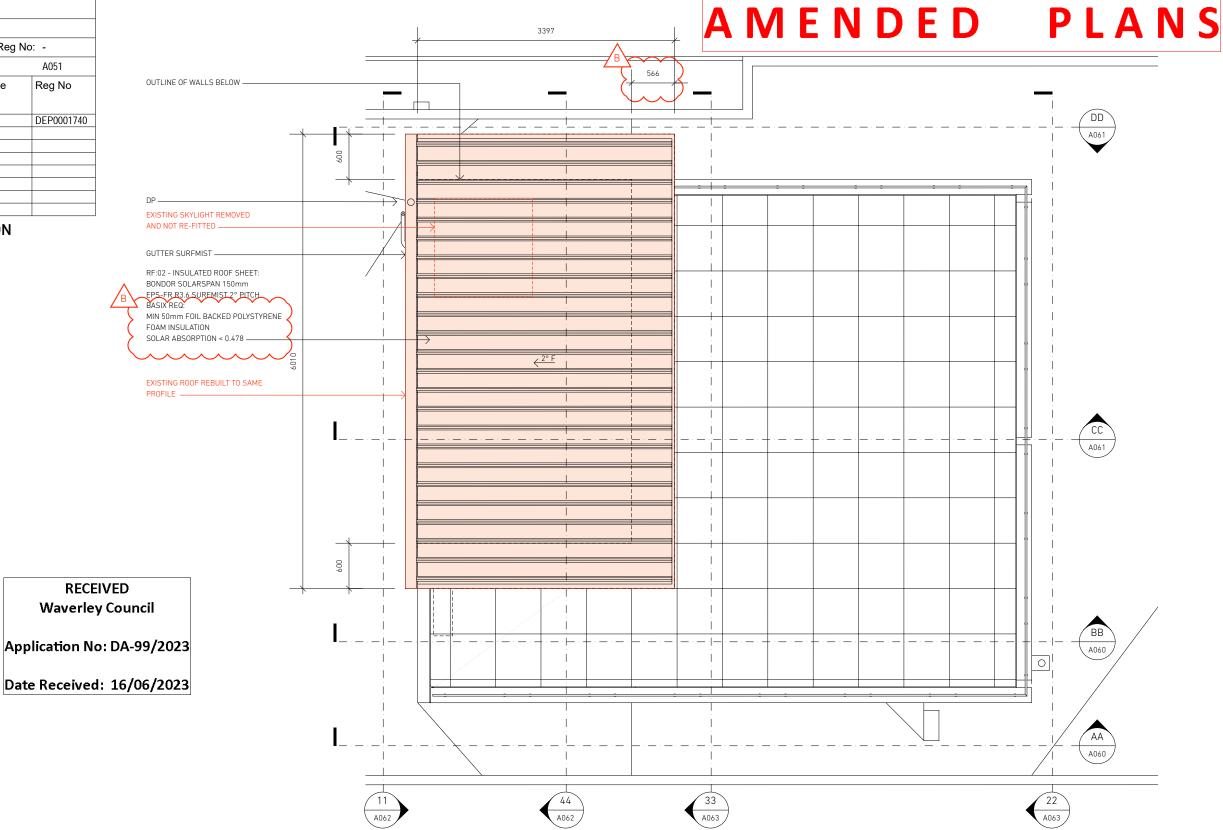
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	Regulated Design Record				
Projec	ct Address: 12	A-14 WILGA STREET BONDI N	SW 2026		
Projec	ct Title: RE	MEDIAL WORK TO ROOF			
Conse	Consent No: N/A Body Corp. Reg No: -				
Drawi	ing Title: UN	IIT 11 SECTIONS AA/BB	Drawing No:	A060	
Rev	Date dd.mm.yy	Description	DP Full Name	Reg No	
-	-1-1-	-	Robert Burton	DEP0001740	
	Date dd.mm.yy	Description	DP Full Name	Reg No	

REFER TO SEPARATE HYDRAULIC AND STRUCTURAL

PLANS/SPECIFICATIONS

GENERAL LEGEND:

BED BEDROOM BRICKWORK BATHROOM BTH BALCONY CENTRE CONCRETE FINISH CONTROL JOINT

CHECK ON SIT

LIGHTWEIGHT STEEL FRAMED WALL WITH MIN R1.3 INSULATION

CÉRAMIS TICHIC CT:01 TERRACE FLOOR TILING

FΙ EXPANSION JOINT EX EXISTING

FALL FFL FINISHED FLOOR LEVEL TO AHD FPL FINISHED PAVING LEVEL

FW FLOOR WASTE

GLAZED DOOR FRAMELESS CLEAR GLASS BALUSTRADE

WITH STAINLESS STEEL HANDRAIL GLAZING CLEAR

GLAZING TRANSLUCENT

KIT KITCHEN

LIVING ROOM / DINING ΩF OVER FLOW

PA:01 PAINT FINISH - TO MATCH EXISTING GREY

PAINT FINISH - TO MATCH EXISTING WHITE PA·N2

PLT PI ANTING

RF:01 COLORBOND STEEL CAPPING

PROFILED STEEL CASSETTE ROOFING RF:02 WINDSPRAY

RELATIVE LEVEL TO AHD RENDER FINISH

RAINWATER OUTLET

ROOF VENT

STRUCTURAL JOINT

SETTING OUT POINT SP

SERVICES PEDESTAL SWD STORMWATER DRAIN

TILE JOINT TJ UP STEPS

VOID

VENT PIPE

WINDOW

TOILET

WATERPROOF MEMBRANE

ELEMENT TO BE REMOVED

KEY:

AREA OF REMEDIAL BUILDING WORK

BASIX CERTIFICATE No: A491076

rev date

A 17/03/23 DA ISSUE

D 22/05/23 Updated

C 15/05/23 Issued for tender

16/06/23 Clear balustrade

18/04/23 BASIX commitments added


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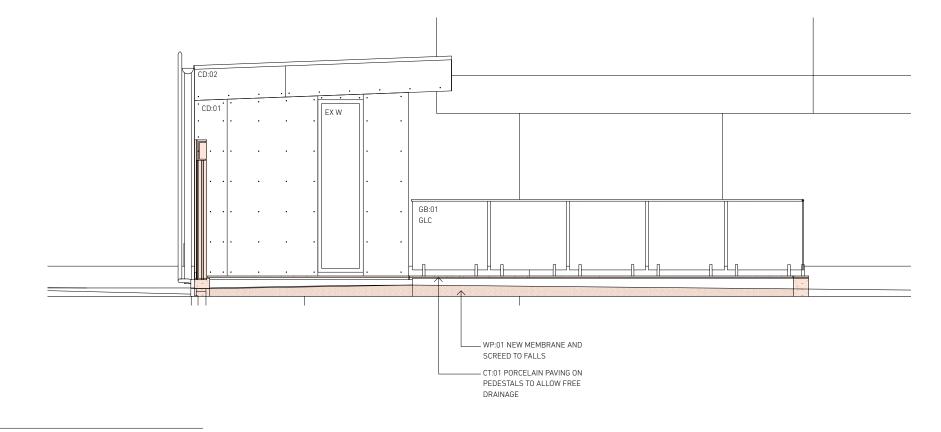
SECTION AA

scale 1:50 at A3

RECEIVED Waverley Council

Application No: DA-99/2023

Date Received: 16/06/2023

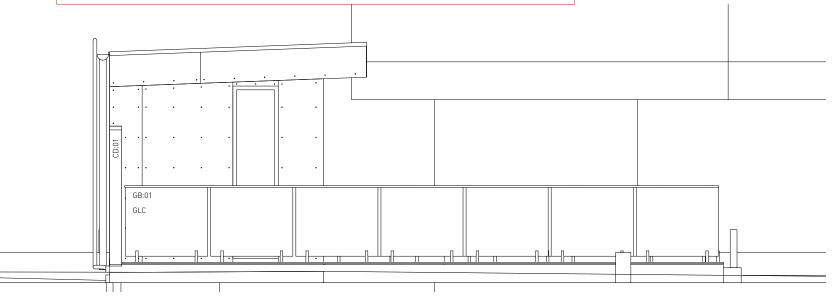



SECTION BB

scale 1:50 at A3

client	SUIECH
project	REMEDIAL WORK TO ROOF
	12A-14 WILGA STREET
	BONDI NSW 2026
	LOT:25 DP:SP4233

CLITECLI

scale	1:50 at A3
drawn	RB
project no	BA2217
drawing title	UNIT 11 SECTIONS AA/BB

A060

drawing no

burtonarchitecture.com ABN 25 457 669 610 mobile +61 (0)415 190677 NSW Registered Architect Rob Burton 9224

		Regulated Design	Record	
Projec	Project Address: 12A-14 WILGA STREET BONDI NSW 2026			
Projec	ct Title: RE	MEDIAL WORK TO ROOF		
Conse	Consent No: N/A Body Corp. Reg No: -			
Drawing Title: UNIT 11 SECTIONS CC/DD		Drawing No:	A061	
Rev	Date dd.mm.yy	Description	DP Full Name	Reg No
-	-/-/-	-	Robert Burton	DEP0001740

REFER TO SEPARATE HYDRAULIC AND STRUCTURAL

PLANS/SPECIFICATIONS

GENERAL LEGEND:

BED BEDROOM BRICKWORK BATHROOM BTH BALCONY CENTRE CONCRETE FINISH CONTROL JOINT CHECK ON SIT

LIGHTWEIGHT STEEL FRAMED WALL WITH MIN R1.3 INSULATION

CFRAMIC THINKS

CT:01 TERRACE FLOOR TILING FΙ EXPANSION JOINT EX EXISTING

FINISHED FLOOR LEVEL TO AHD FFI

FPL FINISHED PAVING LEVEL FW FLOOR WASTE

GLAZED DOOR FRAMELESS CLEAR GLASS BALUSTRADE WITH STAINLESS STEEL HANDRAIL GLAZING CLEAR

GLAZING TRANSLUCENT

KIT KITCHEN LIVING ROOM / DINING

ΩF OVER FLOW

PA:01

PAINT FINISH - TO MATCH EXISTING GREY

PAINT FINISH - TO MATCH EXISTING WHITE PA·N2 PIT PI ANTING

RF:01 COLORBOND STEEL CAPPING

PROFILED STEEL CASSETTE ROOFING RF:02

WINDSPRAY

RELATIVE LEVEL TO AHD

RENDER FINISH RAINWATER OUTLET

ROOF VENT

STRUCTURAL JOINT

SETTING OUT POINT SP SERVICES PEDESTAL

SWD STORMWATER DRAIN

TILE JOINT UP STEPS

VOID

VENT PIPE

WINDOW

TOILET

WATERPROOF MEMBRANE

KEY:

AREA OF REMEDIAL BUILDING WORK ELEMENT TO BE REMOVED

BASIX CERTIFICATE No: A491076

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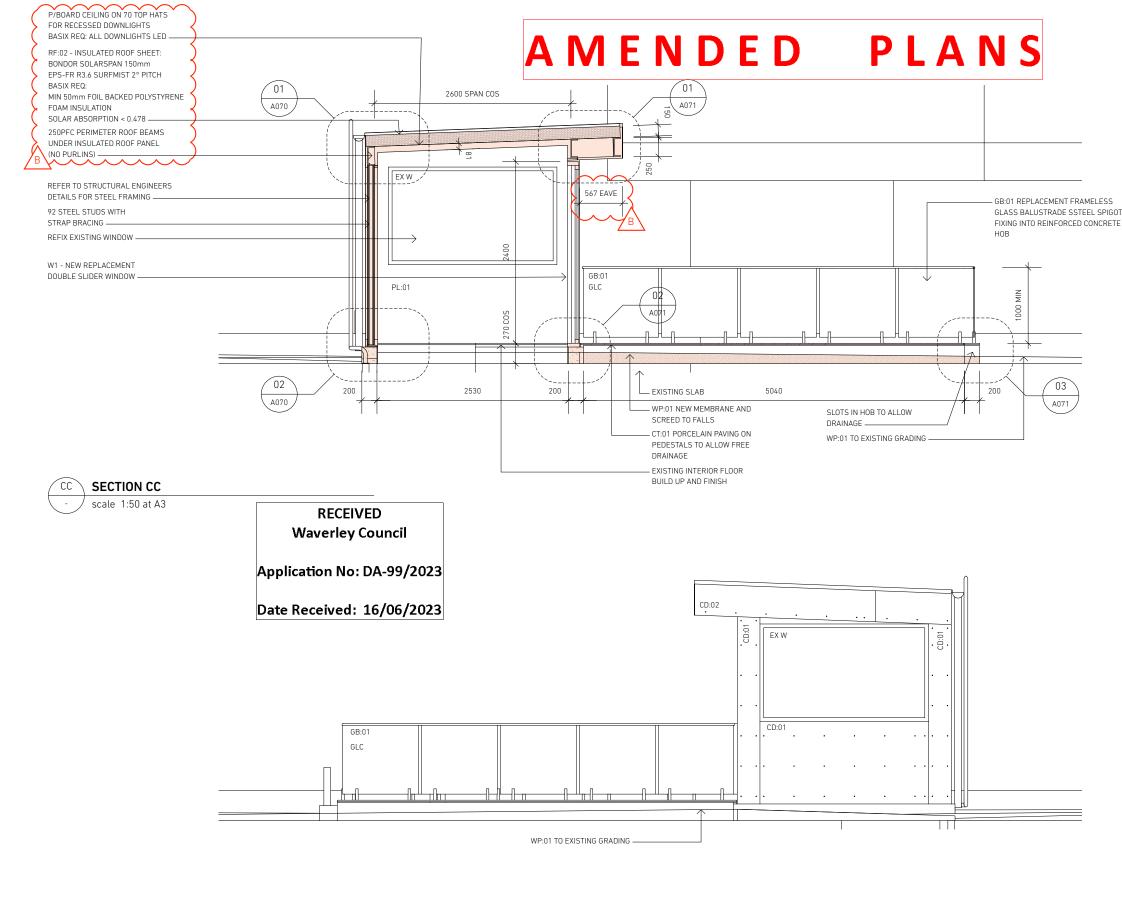
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15/05/23 Issued for tender

22/05/23 Updated 16/06/23 Clear balustrade





client project

SUTECH 1:50 at A3 scale RB drawn BA2217 project no UNIT 11 SECTIONS CC/DD REMEDIAL WORK TO ROOF drawing title 12A-14 WILGA STREET

drawing no

A061

BONDI NSW 2026

LOT:25 DP:SP4233

burtonarchitecture.com ABN 25 457 669 610 mobile +61 (0)415 190677 NSW Registered Architect Rob Burton 9224

	Regulated Design Record			
Projec	ct Address: 1	2A-14 WILGA STREET BONDI N	SW 2026	
Projec	Project Title: REMEDIAL WORK TO ROOF			
Conse	ent No: N	/A	Body Corp. Reg No): -
Drawi	Drawing Title: UNIT 11 SECTIONS 11/44		Drawing No:	A062
Rev	Date dd.mm.yy	Description	DP Full Name	Reg No
-	-1-1-	-	Robert Burton	DEP0001740

REFER TO SEPARATE HYDRAULIC AND STRUCTURAL

PLANS/SPECIFICATIONS

GENERAL LEGEND:

BED BEDROOM BRICKWORK BATHROOM BTH BALCONY CENTRE CONCRETE FINISH CONTROL JOINT CHECK ON SIT

LIGHTWEIGHT STEEL FRAMED WALL

WITH MIN R1.3 INSULATION CÉRAMIS TICING

CT:01 TERRACE FLOOR TILING FΙ EXPANSION JOINT

EX EXISTING FALL

FFL FINISHED FLOOR LEVEL TO AHD FPL FINISHED PAVING LEVEL

FW FLOOR WASTE

GLAZED DOOR FRAMELESS CLEAR GLASS BALUSTRADE

WITH STAINLESS STEEL HANDRAIL GLAZING CLEAR GLAZING TRANSLUCENT

KIT KITCHEN

LIVING ROOM / DINING ΩF OVER FLOW

PA·01 PAINT FINISH - TO MATCH EXISTING GREY

PAINT FINISH - TO MATCH EXISTING WHITE PA·N2

PLT PI ANTING

RF:01 COLORBOND STEEL CAPPING

PROFILED STEEL CASSETTE ROOFING RF:02

WINDSPRAY RELATIVE LEVEL TO AHD

RENDER FINISH

RAINWATER OUTLET ROOF VENT

STRUCTURAL JOINT

SETTING OUT POINT SP SERVICES PEDESTAL

SWD STORMWATER DRAIN TILE JOINT TJ

UP STEPS

VOID VENT PIPE

WINDOW

TOILET

WATERPROOF MEMBRANE

KEY:

AREA OF REMEDIAL BUILDING WORK ELEMENT TO BE REMOVED

BASIX CERTIFICATE No: A491076

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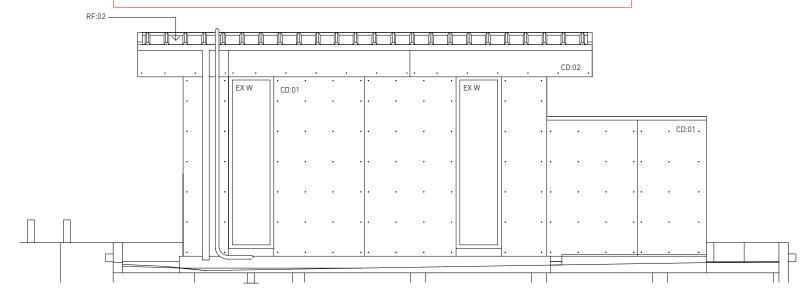
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17/03/23 DA ISSUE 18/04/23 BASIX commitments added 15/05/23 Issued for tender 22/05/23 Updated 16/06/23 Clear balustrade

rev date

AMENDED **PLANS**




SECTION 11 scale 1:50 at A3

RECEIVED Waverley Council

Application No: DA-99/2023

Date Received: 16/06/2023

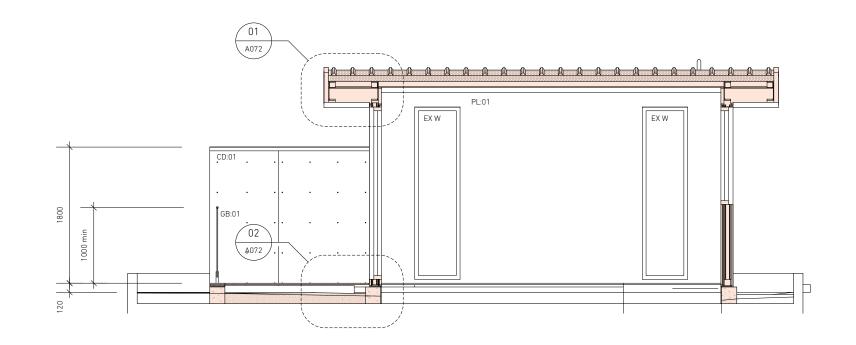

LOT:25 DP:SP4233



	client
	projec

t	SUTECH	scale	1:50 at A3
		drawn	RB
		project no	BA2217
ect	REMEDIAL WORK TO ROOF	drawing title	UNIT 11 SECTION
	12A-14 WILGA STREET		
	BONDI NSW 2026		

drawing no

scale	1:50 at A3
drawn	RB
project no	BA2217
drawing title	UNIT 11 SECTIONS 11/44

A062

burtonarchitecture.com ABN 25 457 669 610 mobile +61 (0)415 190677 NSW Registered Architect Rob Burton 9224

	Regulated Design Record			
Projec	ct Address: 12	A-14 WILGA STREET BONDI NS	SW 2026	
Projec	Project Title: REMEDIAL WORK TO ROOF			
Conse	ent No: N/	A	Body Corp. Reg No): -
Drawi	ng Title: Ut	NIT 11 SECTIONS 22/33	Drawing No:	A063
Rev	Date dd.mm.yy	Description	DP Full Name	Reg No
-	-/-/-	-	Robert Burton	DEP0001740

REFER TO SEPARATE HYDRAULIC AND STRUCTURAL

PLANS/SPECIFICATIONS

GENERAL LEGEND:

BED BEDROOM BRICKWORK BATHROOM BTH BALCONY CENTRE CONCRETE FINISH CONTROL JOINT CHECK ON SIT

LIGHTWEIGHT STEEL FRAMED WALL WITH MIN R1.3 INSULATION

CÉRAMIS TICING

CT:01 TERRACE FLOOR TILING FΙ EXPANSION JOINT EX EXISTING

FALL FFL FINISHED FLOOR LEVEL TO AHD

FPL FINISHED PAVING LEVEL FW FLOOR WASTE

GLAZED DOOR FRAMELESS CLEAR GLASS BALUSTRADE

WITH STAINLESS STEEL HANDRAIL GLAZING CLEAR GLAZING TRANSLUCENT

KIT KITCHEN LIVING ROOM / DINING

ΩF OVER FLOW

PA·01 PAINT FINISH - TO MATCH EXISTING GREY

PAINT FINISH - TO MATCH EXISTING WHITE PA·N2

PLT PI ANTING

COLORBOND STEEL CAPPING RF:01

PROFILED STEEL CASSETTE ROOFING RF:02

WINDSPRAY RELATIVE LEVEL TO AHD

RENDER FINISH RAINWATER OUTLET

ROOF VENT

STRUCTURAL JOINT SETTING OUT POINT

SP SERVICES PEDESTAL

SWD STORMWATER DRAIN

TILE JOINT

UP STEPS

VOID

VENT PIPE

WINDOW

TOILET

WATERPROOF MEMBRANE

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17/03/23 DA ISSUE

22/05/23 Updated 16/06/23 Clear balustrade

15/05/23 Issued for tender

18/04/23 BASIX commitments added


Check all dimensions and site conditions prior to commencement of any work, the purchase or ordering of any materials, fittings, plant, services or equipment and the preparation of shop drawings and/or the fabrication of any components.

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AMENDED PLANS




RECEIVED

Application No: DA-99/2023

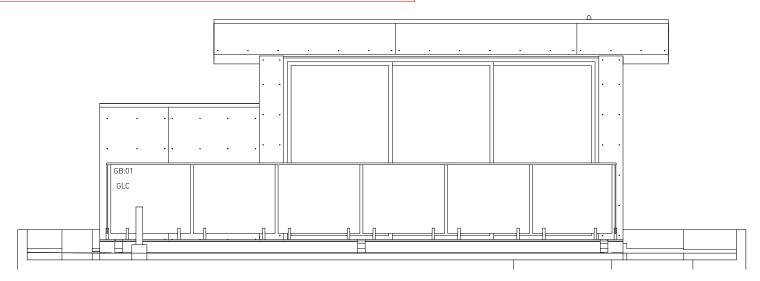Waverley Council

Date Received: 16/06/2023

SECTION 22 scale 1:50 at A3

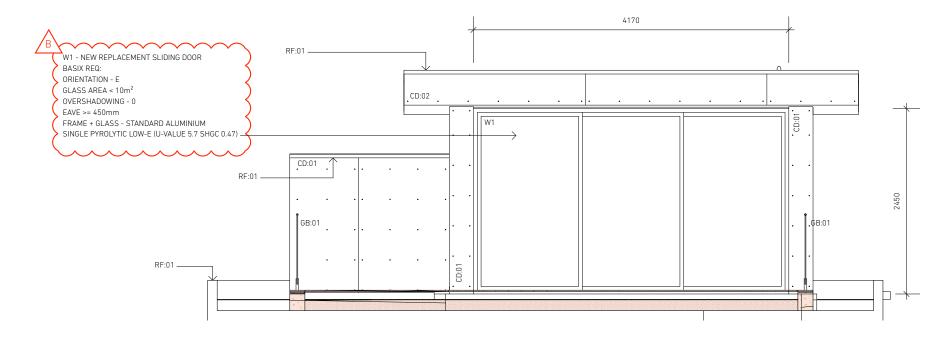



SECTION 33

scale 1:50 at A3

project	REMEDIAL WORK TO ROOF
	12A-14 WILGA STREET
	BONDI NSW 2026
	LOT:25 DP:SP4233

SUTECH

scale	1:50 at A3	
drawn	RB	
project no	BA2217	
drawing title	UNIT 11 SECTIONS 22/33	
	drawn project no	

A063

drawing no

burtonarchitecture.com ABN 25 457 669 610 mobile +61 (0)415 190677 NSW Registered Architect Rob Burton 9224





Report to the Waverley Local Planning Panel

Application number	DA-50/2023 (PAN-308974)
Site address	396 Bronte Road BRONTE
Proposal	Alterations and additions to detached dwelling including new first floor addition and swimming pool to the rear
Date of lodgement	9 March 2023
Owner / Applicant	Ms L S Medina
Submissions	Fifteen submissions
Cost of works	\$485,000
Principal Issues	Privacy
Recommendation	That the application be APPROVED in accordance with the conditions contained in the report.

SITE MAP



1. PREAMBLE

1.1. Executive Summary

The development application seeks consent for alterations and additions to the existing detached dwelling including a new first floor addition and swimming pool at the rear at 396 Bronte Road, Bronte.

The proposal complies with the FSR and height development standards of the LEP and is consistent with the objectives and controls of the DCP including the key built form controls of setbacks, open space and landscaping and wall height. As discussed throughout this report, the proposal will not harm the character of the street or impact unreasonably upon the amenity of surrounding properties, subject to conditions regarding the privacy treatment of windows.

A total number of 15 submissions from 10 properties were received and the issues raised in the submissions have been considered and addressed in this report and in the recommendation.

The application has been assessed against the relevant matters for consideration under section 4.15(1) of the *Environmental Planning and Assessment Act 1979*. It is recommended for approval subject to conditions of consent.

1.2. Site and Surrounding Locality

A site visit was carried out on 1 May 2023.

The site is identified as Lot 1 in DP 950296, known as 396 Bronte Road, Bronte.

The site is rectangular in shape with a frontage to Bronte Road measuring 9.145m. It has an area of 446m² and falls from the front towards the rear by approximately 2m.

The site is occupied by a two-storey detached dwelling with vehicular access provided from Bronte Road to a carport built up to the front boundary of the site.

The site is adjoined by three-storey residential flat building to the west and a two-storey dwelling to the east. The locality is characterised by a variety of low and medium density residential development including dwelling houses and residential flat buildings.

Figures 1 to 6 are photos of the site and its context.



Figure 1: Front elevation as viewed from Bronte Road



Figure 2: Rear elevation of the dwelling



Figure 3: Western elevation of the subject site as viewed from driveway of adjoining residential flat building to the west



Figure 4: Rear yard as viewed from existing rear balcony



Figure 5: Streetscape to the west



Figure 6: Streetscape to the east

1.3. Relevant Development History

A search of Council's records revealed the following recent and relevant development history of the site:

• **CD-139/2020** for modification of the existing garage to widen the garage door, installation of a new pedestrian gate and demolition of part of the front porch and new replacement was approved by a Private Certifier on 21 October 2020.

1.4. Proposal

The development application seeks consent for alterations and additions to dwelling house, specifically involving the following:

- Replacement and extension of the existing carport at the front of the site.
- Extension of the existing rear elevated balcony at the ground floor level and new timber stairs to the rear yard.
- New front entry and porch on the eastern side of the dwelling.
- New upper floor addition containing bedrooms, living room, bathrooms and a balcony extending from the main bedroom at the rear.
- Internal alterations and new windows on all elevations.
- Excavation of the rear yard to align with the lower level of the dwelling.
- New swimming pool within the rear yard.

1.5. Background

The development application was lodged on 9 March 2023 and a request for further information was made on 15 March 2023 for the following reason (summarised):

1. Incorrect gross floor area (GFA) calculations as the existing storage rooms at the lower ground floor level have not been included.

Amended plans were received on 30 March 2023 which nominate these areas as plant rather than storage (which is excluded from GFA/FSR calculations). The remaining lower ground floor storage areas continue to be included in GFA/FSR calculations, excluding only those areas nominated as plant.

After preliminary assessment and notification, the application was deferred on 18 May 2023 to address the following matters (summarised):

- 1. Inaccurate/insufficient plans and documentation.
- 2. Design changes:
 - The rear first floor balcony exceeds the maximum controls of Development Control Plan 2022 (DCP) for elevated balconies being a maximum of 10m² area and depth of 1.5m. Given that the balcony will be directly opposite the principal balcony on the upper floor level at 394 Bronte Road,

this balcony is to be deleted or reduced in size to comply with the maximum provisions of the DCP (refer to additional comments below regarding rear setback).

- The proposed rear ground level deck has a depth of 4m and area of $21m^2$ exceeding the DCP maximum controls. Acknowledging that there are other large decks to surrounding properties within the immediate vicinity of the site and the deck is accessed via a living room, a variation to the maximum controls of the DCP may be acceptable in this area provided that privacy impacts upon adjoining properties are minimised through appropriate screening where necessary and the depth is reduced to 2.5m.
- The proposed staggered rear setback of the upper floor level between the reduced setback of the properties to the west and the increased setback of the properties to the east is considered appropriate. However, the balcony extending from the rear is considered to extend beyond this setback line. In this regard, the balcony is to be removed or set back to extend no further than the currently proposed rear wall of the dwelling at this level (noting that this will result in a reduction in gross floor area).
- The extent of the proposed garage is excessive and results in loss of landscaping at the front of the site. The expansion of the carport beyond a single space is not supported as double spaces fronting the street are not characteristic of the streetscape and does not allow for adequate landscaping within the front setback of the site. The proposal does not comply with the controls of DCP 2022 that 50% of the front setback be open space and 50% of that is to be landscaped area. In this regard, the front landscaped area is to be increased by moving the bins storage to the rear of the garage/carport and reducing the width of the garage/carport at the street accordingly. At present, the structure is a carport however if this is to be enclosed and converted to a garage, the additional space beyond the car space is included in gross floor area (GFA) calculations (including bin storage). Please note that no variation to the FSR development standard will be supported on this site.
- DCP 2022 requires fans for all habitable rooms and prohibits the use of gas for heating and cooking. Please indicate on the plans.

Amended plans were provided on 21 June 2023 which corrected inaccuracies in the plans, changed the proposed garage to a carport with an associated reduction in size, included a privacy screen to the rear ground level deck, reduced the size of the balcony at the first floor level and reduced the size of the first floor level by 2.5m² through a slightly increased rear setback (approximately 1m).

2. ASSESSMENT

The following matters are to be considered in the assessment of this development application under section 4.15 of the *Environmental Planning and Assessment Act 1979* (the Act).

2.1. Planning Instruments and Development Control Plans

The following is an assessment against relevant legislation, environmental planning instruments, including State Environmental Planning Policies (SEPPs), and development control plans.

2.1.1. State Environmental Planning Policies (SEPPs)

The following SEPPs apply from 1 March 2022 and have been considered acceptable in the assessment of this development application:

- SEPP (Building Sustainability Index BASIX) 2004
- SEPP (Biodiversity and Conservation) 2021
- SEPP (Resilience and Hazards) 2021

2.1.2. Waverley Local Environmental Plan 2012 (Waverley LEP 2012)

The relevant matters to be considered under the Waverley LEP 2012 for the proposed development are outlined below:

Table 1: Waverley LEP 2012 Compliance Table

Provision	Compliance	Comment
Part 1 Preliminary		
1.2 Aims of plan	Yes	The proposal is consistent with the aims of the LEP.
Part 2 Permitted or prohibited de	velopment	
R3 Medium Density Residential Zone	Yes	The proposal is defined as a dwelling house, which is permitted with consent in the R3 zone.
Part 4 Principal development star	dards	
4.3 Height of buildings ● 9.5m	Yes	The proposal has a maximum height of 8.9m complying with the development standard.
 4.4 Floor space ratio and 4.4A Exceptions to floor space ratio 0.61:1 Site Area: 446m² 	Yes	The proposal has an FSR of 0.6:1 complying with the development standard.
Part 5 Miscellaneous provisions		
5.10 Heritage conservation	Yes	The site is not heritage listed or contained within a heritage conservation area. The site adjoins a heritage conservation area at the rear of the site however the proposal will not impact upon the character or significance of this conservation area with the works predominantly being contained over the existing dwelling and at the front of the site.

Part 6 Additional local provisions		
6.2 Earthworks	Yes	Excavation is contained to the lowering of the rear yard immediately adjoining the existing dwelling and the swimming pool. All standard conditions in relation to excavation are included in the consent conditions and the works are considered acceptable in this regard.

2.1.3. Waverley Development Control Plan 2022 (Waverley DCP 2022)

The relevant matters to be considered under the Waverley DCP 2022 for the proposed development are outlined below:

Table 2: Waverley DCP 2022 – Part B General Provisions Compliance Table

Development Control	Compliance	Comment
WasteGarbage bins are to be stored in an appropriate location.	Yes	Satisfactory – bins are to be stored in the carport adjacent to the front boundary from where collection will occur.
 2. Ecologically Sustainable Development Ceiling or wall mounted fans Gas cooktops, gas ovens or gas internal space heating systems. 	Yes (subject to conditions)	The proposal is generally consistent with the objectives and controls within this part of the DCP as outlined within the BASIX Certificate. An advisory condition regarding gas heating and cooking is included in Appendix A.
3. Landscaping, Biodiversity and Vegetation Preservation	Yes	The proposal does not include the removal of trees, with only various hedging plants to be removed however with the majority retained. Council's Tree Management Officer has inspected the site and is satisfied with the proposal subject to conditions regarding the protection of the existing street tree at the front of the site.
5.Water Management	Yes	Satisfactory
7. Transport 7.1 Streetscape	Yes	The amended proposal will increase the size of the existing carport structure at the front of the site built up to the front boundary providing sufficient area for the parking of one vehicle (as existing) and a motorcycle space. This is
7.2 On-Site Parking 7.2.1 Vehicle Access		considered acceptable. The subject site is located within Parking Zone 2. The proposal does not exceed the maximum rate

Development Control	Compliance	Comment
7.2.2 Parking Rates Minimum parking rate: Nil Maximum parking rate: Two		of parking allowable under the DCP (maximum of 2 vehicle spaces). The driveway crossover is acceptable.
8. Heritage	Yes	Satisfactory
11. Design Excellence	Yes	Satisfactory
13. Excavation	Yes	The proposal does not include excavation within the footprint of the building. All storage spaces and plant rooms at the lower ground floor level are existing. As previously discussed in Table 1, the excavation is for the swimming pool and the lowering of the rear yard to allow level access to the lower ground floor level. The proposal does not exceed the maximum permitted excavation controls of the DCP.

Table 31: Waverley DCP 2022 – Part C1 Low Density Residential Development Compliance Table

Development Control	Compliance	Comment
1.0 General Objectives		
	Yes	The proposal does not contravene the general objectives of this part of the DCP.
1.1 Height		
Flat roof dwelling house • Maximum wall height of 7.5m *The roof pitch is approximately 6° and as such is classified as a flat roof.	Yes	The wall height is a maximum of 6.3m as the upper floor level is inset from the levels below. The setting in of the upper level lessens the bulk of the structure when viewed from surrounding properties and provides articulation to all facades.
1.2 Setbacks		
 1.2.1 Front and rear building lines Predominant front building line (adjacent three neighbours on either side) Predominant rear building line at each floor 	Yes	The proposal maintains the existing front building alignment at the street boundary. Refer to discussion below this table in relation to rear setbacks.

Development Control	Compliance	Comment
level (adjacent three neighbours or either side) 1.2.2 Side setbacks • Minimum of 0.9m for ground floor and first floors) • Minimum 1.5m for second floor	No	The proposal maintains the lower ground and ground floor level setbacks of the existing dwelling. The proposed upper floor addition will be setback 1.445m from the western boundary and 2.454m from the eastern boundary. The minor variation from the western side boundary is considered acceptable as it is only 5cm which will have no discernible impact upon the appearance of the dwelling or surrounding properties. Given that the design of the upper floor addition is a mansard style, the setback increases from the base to the roof of the upper floor addition due to the slight slope to the side walls.
1.3 Streetscape and visual imp	nact	
 New development to be compatible with streetscape context Replacement windows to complement the style and proportions of existing dwelling Significant landscaping to be maintained. 	Yes	The proposed alterations to the existing building will result in a contemporary dwelling within the streetscape. The proposal will present to the street as a two-storey building with a contemporary mansard style roof. The proposal is not out of character with the mixed typologies of buildings within the area. The amended proposal retains landscaping within the front setback contributing to the character of the street.
1.4 Fences		
Front: Maximum height of 1.2m Solid section no more than 0.6m in height Side and Rear: Maximum height of 1.8m	Yes	The existing dwelling contains a high front boundary fence (approximately 1.5m). The proposal retains the front fence however includes the relocation of the timber entry gate. This is considered acceptable given the height of the existing front fence. The plans indicate standard 1.8m high fencing in the rear yard where replacement fencing is required.
1.5 Visual and acoustic privace	У	
Habitable windows are not to directly face habitable windows or open space of neighbouring dwellings unless direct views are	No	Refer to detailed discussion following this table.

Development Control	Compliance	Comment
screened or other appropriate measures are incorporated into the design External stairs are not acceptable. Maximum size of balconies: 10m² in area 1.5m deep Roof tops to be non- trafficable unless predominant in the immediate vicinity		
 Minimum of 3 hours of sunlight to 50% of living areas and principal open space areas on 21 June to subject site Minimum of 3 hours of sunlight maintained to at least 50% of principal open space areas of adjoining properties on 21 June. Avoid unreasonably overshadowing of solar collectors (including habitable windows). 	Yes	Living area windows and the principal area of private open space are oriented to the north with optimal solar access. The additional overshadowing caused by the proposed development will principally fall over the street in front of the site however there may be some additional overshadowing of adjoining sites. Despite this, the reasonableness of the overshadowing impact is considered based on the performance and compliance of the development with relevant built form development standards and controls as well as the site's orientation. As demonstrated in this report, the development complies with the building height and FSR development standards under the LEP and with setbacks and open space/landscaped area controls under the DCP. Based on the proposal's compliance with the key built form controls, any additional overshadowing impact caused by the proposed development is deemed reasonable and non-adverse and anticipated for any compliant redevelopment of the subject site.
Views Views from the public domain are to be maintained Development to be designed and sited so as to enable a sharing of views with surrounding	Yes	No known significant views from surrounding properties will be impacted by the proposal.

Development Control	Compliance	Comment
dwellings particularly from habitable rooms and decks.		
1.8 Car parking		
 1.8.1 Design Approach Parking only allowed where site conditions permit Designed to complement the building and streetscape Car parking structures to be behind the front building line Driveways are to be located to minimise the loss of on street parking Parking to be provided from secondary streets or lanes where possible. 	Yes (existing)	The proposal replaces an existing single carport built up to the street alignment extending by 900mm to the west to provide an additional motorcycle space. The carport will also be extended toward the dwelling to provide a covered area for the storage of bins. The enlargement of the existing carport is not considered unreasonable as the impact upon the streetscape of a parking structure within the front setback already exists. The proposal will not result in a loss of on-street parking as the existing kerb and gutter crossing is to be retained.
1.8.2 Parking rates	Yes	The proposal is consistent with the maximum parking rate of the DCP.
 1.8.3 Location Parking to be behind front building line for new dwellings Existing development to be in accordance with the hierarchy of preferred car parking locations 	Yes	Although not behind the front building line, the front carport is existing. The marginal expansion of the carport will not result in unreasonable additional impacts upon the streetscape.
 1.8.4 Design Complement the style, massing and detail of the dwelling Secondary in area and appearance to the design of the residences No part of the façade is to be demolished to accommodate car parking 	Yes	The design and style of the replacement carport is consistent with the style of the proposed additions presenting a cohesive design to the streetscape. The carport has a secondary appearance to the dwelling. The façade of the building is not being demolished to accommodate a parking space as sufficient area is already provided in the existing front carport.
1.8.5 Dimensions • 5.4m x 2.4m per vehicle	Yes	The proposed carport meets the minimum dimensions required.
1.8.6 Driveways	Yes	The proposal retains and utilises the existing driveway and kerb and gutter crossing.

Development Control	Compliance	Comment
 Maximum of one per property Maximum width of 3m at the gutter (excluding splay) Crossings not permitted where 2 on street spaces are lost 		
1.9 Landscaping and open spa	ce	
Overall open space: 40% of site area	Yes	49% of the site as open space.
Overall landscaped area: 20% of site area, with at least half deep soil	Yes	33% of the site as landscaped area with 100% as deep soil.
Minimum area of 25m² for private open space	Yes	Rear yard is 160m²
Front open space: 50% of front building setback area	Yes	50% of the front setback is retained as open space.
 Front landscaped area: 50% of front open space provided 	Yes	75% of the front open space is landscaped area.
Outdoor clothes drying area to be provided	Yes	The existing outdoor clothes drying area within the side setback is to be retained.
1.10 Swimming pools and spa	pools	
 Located in the rear of property Pool decks on side boundaries must consider visual privacy All pool equipment to be enclosed within an acoustically treated enclosure 	Yes	The proposed swimming pool is located at the rear of the site. The area surrounding the pool is at ground level and will not have privacy impacts upon surrounding properties. The proposal includes an enclosed area for pool plant and an appropriate condition is imposed regarding acoustic treatment.

The following is a detailed discussion of the issues identified in the compliance tables above in relation to the Waverley DCP 2022.

Rear setbacks

DCP 2022 requires that extensions to existing buildings are to extend no further than the rear predominant building line. The predominant building line can be considered to be the three adjacent neighbours on either side. Notwithstanding this control, the DCP requires that development at first floor level and above shall be set back from the rear building line of the ground floor level in order to minimise bulk and scale impacts and provide visual relief for the open space and living areas at adjacent properties.

The ground and lower ground floor levels are retained. The proposed upper floor level will extend over most of the ground level footprint retaining a 1.1m setback from the level below at the rear.

Figure 7 demonstrates the rear building lines of properties surrounding the site and indicates that the properties to the east have greater setbacks than the properties to the west which extend much further into the site. **Figure 7** also demonstrates that the existing rear setback of the subject building responds to the reduced setbacks of the properties located to the west of the site, rather than those to the east. It is clear that there is no predominant rear setback to surrounding properties. In response to this the proposed upper floor addition has been designed to provide a staggered setback between the greater setback of No. 394 Bronte Road to the west and the reduced setback of No. 398 Bronte Road to the east. Amended plans have increased the rear setback of the upper floor level to provide a setback from the lower level lessening the perceived bulk of the building from adjoining properties and the rear.



Figure 7: Aerial imagery of the subject site (outlined in red) and surrounding properties (Source: NearMap)

It should be noted that the proposed upper floor addition has been designed to be contained over the footprint of the existing building on the site and comply with the FSR development standard applicable to the site. As such, the rear setback is considered acceptable.

Privacy

New windows at the upper floor level are to bedrooms and non-habitable rooms which are rooms of low use with fewer associated privacy impacts. No unreasonable privacy impacts upon adjoining properties are anticipated as a result of these windows.

The proposal includes the infilling of existing windows and provision of new windows on all elevations at the ground and lower ground floor levels. The new windows at the lower ground floor level will have no privacy impacts upon adjoining properties being obscured by boundary fencing.

New windows at the ground floor level are generally opposite the driveway and lower level garages at the residential flat building to the west and as such will not have unreasonable privacy impacts.

There is no side boundary fence between the subject property and the dwelling to the east, No. 398 Bronte Road and as such, windows along both side elevations of these buildings have outlook to each other as shown in **Figures 8 to 11** below. Notwithstanding, the proposal has designed windows to be largely offset from windows on the adjoining property. The two new dining room windows (W108 and W109) are located opposite a balcony (refer to **Figure 10**) on the adjoining property however these have raised sill heights of 1.2m. Notwithstanding there is the potential for cross-viewing and the opportunity to improve existing privacy impacts between the sites and as such a condition will require that these windows are screened or provided with obscure glazing.

The same is true for the two new living area windows (W110 and W111) with the potential for overlooking of the rear yard of No. 398. Although at present, there is vegetation which blocks the views into this property, this should not be relied upon as the only means of protecting privacy from living area windows. Given that these are secondary windows, with the main light source being via glazed doors on the rear elevation, screening or obscure glazing is not considered to be an onerous requirement.

The remaining windows are considered acceptable in relation to privacy impacts particularly as cross-viewing between windows is already high (refer to figures below) and exacerbated by the lack of side boundary fencing between the two sites.



Figure 8: Existing eastern side boundary setback looking toward the front of the site (south) showing windows on the subject site (right) and opposing windows on the side elevation of 398

Bronte Road



Figure 9: Existing eastern side boundary setback looking toward the rear of the site (north) showing windows on the subject site (left) and opposing windows on the side elevation of 398 Bronte Road



Figure 10: View from existing windows into the rear balcony of the adjoining property at No. 398

Bronte Rd



Figure 11: View from existing windows into the windows on the side elevation of the adjoining property at No. 398 Bronte Rd

The proposal also includes a Juliet balcony on the eastern side elevation at the ground floor level from the proposed office which is opposite a window on the adjoining property at No. 398 Bronte Road. The plans appear to show that the lower balustrade to the Juliet balcony is solid however this is not clear. The Juliet balcony will have balustrades flush with the window (ie, it is not strictly a balcony as a person cannot stand external to the room) and if the balustrade is solid, this would have no greater impact than a standard window. As such, a condition to this effect is recommended.

The proposal also includes new rear balconies at the ground and first floor levels. The first floor level balcony has been reduced in size to comply with the controls of the DCP with an area of 6.6m² and depth of 1.5m. This balcony is accessed from a bedroom which is a room of low use with reduced privacy impacts as compared to living areas. The balcony also has enclosed sides and privacy screening to ensure overlooking of adjoining properties is reduced. This balcony is considered acceptable and will not result in adverse privacy impacts.

The proposed balcony at the ground floor level extends an existing balcony in this location and will exceed the controls of the DCP having an area of $23m^2$ and depth of 4m. Although elevated above the rear yard, the balcony is contained at the ground floor level and includes a privacy screen along the eastern boundary to prevent overlooking of the property to the east. To the west, the side boundary contains high, dense hedges and the stairs to the ground level. The setback provided by the stairs and the dense vegetation will inhibit views into the adjoining property (refer to **Figures 12 and 13** below). There are also numerous balconies with the potential to overlook the subject site from both the residential flat building to the west and the dwelling to the east. As such, elevated balconies are characteristic of surrounding properties and the area and there is a degree of mutual overlooking between sites. The proposed ground level balcony is therefore considered acceptable.



Figure 12: View from the existing rear balcony towards the west



Figure 13: View from the existing rear balcony toward the north-east

The proposal also provides external stairs from the ground floor deck to the rear yard. These stairs are simply a reorientation of existing stairs to the rear yard from the main dwelling. The stairs will be located along the screened western boundary of the site as demonstrated in **Figure 12** above. The reorientated stairs are unlikely to result in unreasonable additional privacy impacts.

The proposal is for a low density development in an area which permits medium density residential development (ie, residential flat buildings). The noise generated from the use of a dwelling house within a residential zone is expected and reasonable.

Given the above analysis and subject to the imposition of recommended conditions, it is considered that the proposal will not result in unreasonable privacy impacts upon surrounding properties.

2.2. Other Impacts of the Development

The proposal is considered to have no significant detrimental effect relating to environmental, social or economic impacts on the locality, subject to appropriate conditions being imposed.

2.3. Suitability of the Site for the Development

The site is considered suitable for the proposal.

2.4. Any Submissions

The application was notified for 14 days from 30 March 2023 until 17 April 2023 in accordance with the *Waverley Community Development Participation and Consultation Plan*. Seven submissions were received.

Following receipt of amended plans and additional information, the application was re-notified for 14 days from 10 July 2023 in accordance with the *Waverley Community Development Participation and Consultation Plan*. Eight submissions were received.

In all, fifteen submissions from 10 properties were received as listed in **Table 4** below.

Table 4: Number of and where submissions were received from.

Count	Property Address
1.	388 Bronte Road BRONTE
2.	1/394 Bronte Road BRONTE
3.	3/394 Bronte Road BRONTE (two submissions)
4.	4/394 Bronte Road BRONTE (two submissions)
5.	7/394 Bronte Road BRONTE
6.	8/394 Bronte Road BRONTE (two submissions)
7.	398 Bronte Road BRONTE (four submissions)
8.	400 Bronte Road BRONTE
9.	402 Bronte Road BRONTE
10.	39 Gipps Street BRONTE

The following issues raised in the submissions have already been discussed and addressed in the body of this report and/or the recommendation:

- Height and FSR (bulk and scale)
- Overshadowing
- Views
- Visual and acoustic privacy
- Rear setback
- Streetscape impact
- Noise impact of the pool plant

All other issues raised in the submissions are summarised and discussed below.

Issue: Height could be lowered by lowering the excessive ceiling height of 3.1m in the living area to 2.8m

to match the remainder of this level reducing overshadowing of adjoining properties.

Response: The proposal is lower than the height development standard applicable to the site.

Overshadowing has been discussed in this report previously.

Issue: The cladding of the upper floor level is too light – visual impact; consider the colour of the materials

used in the proposed development to facilitate as much indirect light and glare as possible.

Response: Objections have been received that the roof colour is too light and alternatively that the

proposed colour should facilitate indirect light and glare, suggesting the preference for a light colour.

There are no controls that require certain colours in the DCP other than in a conservation area. Given

the site is not located within a conservation area, there are no controls which apply.

Notwithstanding, materials and finishes have been provided which are considered acceptable. The upper

floor level is to be a light grey tone ('southerly' colorbond) noting that light roofing colours absorb less

heat contributing to a more environmentally sustainable building.

Issue: Wood burning fireplace will result in environmental and health impacts; BBQ structure may cause

heat damage to hedge screening and smoke pollution.

Response: Council does not permit solid fuel burning for heating and a condition to this effect is included

in Appendix A. A BBQ is exempt development under the provision of State Environmental Planning Policy

(Exempt and Complying Development Codes) 2008 and subject to certain criteria, consent is not required.

The proposed BBQ would comply with the exempt criteria except for the height as it exceeds 1.8m, at

3.5m. In this regard, smoke from the use of a BBQ outdoors is a reasonable expectation within a

residential area. Given that the height is over 1.8m, a condition will require a setback of 900mm to limit

impacts upon the adjoining property.

Issue: No site notice and notification during Easter period while people are away.

Response: A site notice is not required for the subject development. The application was notified twice

in accordance with the Waverley Community Development Participation and Consultation Plan.

Issue: Loss of property value.

Response: This is not a planning issue.

Issue: Loss of views.

Response: The objector has provided photographs demonstrating the view from their property which indicate that the proposal will not impact upon 'significant' views (water, ocean, icons) from the objector's property but will encroach upon district views. The photographs show views of trees, roofscapes and structures on adjoining properties which can be classified as district views or outlook which are not a consideration under the Tenacity View Sharing Planning Principles of the Land and Environment Court. Notwithstanding, the proposal complies with the development standards of the LEP and key built form controls of the DCP and as such, any impact upon views and outlook is not considered unreasonable.

Issue: Shadow diagrams should be more detailed and prepared by an independent third party.

Response: There is no requirement that the shadow diagrams be prepared by a third party. Highly detailed shadow diagrams are required where a development exceeds a development standard where they must demonstrate that the amenity of surrounding properties is preserved beyond a compliant form (ie. one that complies with the development standards of FSR and height). The subject proposal complies with the FSR development standard and is lower than the maximum permitted by the height development standard. In this regard, the shadow diagrams submitted are sufficient for assessment of this application. Overshadowing has been discussed previously in this report.

Issue: Out of character with the bulk and scale of surrounding dwellings.

Response: The character of the street is comprised of a mixture of residential dwellings and residential flat buildings. The zoning of the property and surrounding sites as R3 suggest a medium density scale as the appropriate desired future character of the area. Notwithstanding, the proposal will present to the street as a two-storey dwelling with a single garage fronting the street. Although of modern design, the proposal will present to the street as a low-density residential dwelling and is not out of character with the streetscape.

Issue: The new sunken patio /outdoor entertaining area off the lower ground storage spaces and the internal connecting stair all imply a use other than storage and therefore has implications on the FSR. Furthermore, if it is a "storage space", we question why new windows W002, glazed to ground level are required facing East towards our private outdoor dining space.

Response: The lower ground floor level storage areas have been included in GFA and FSR calculations. The new windows will have no unreasonable privacy impacts upon the adjoining property being located at the lower ground floor level.

Issue: Inaccuracies and discrepancies in the submitted plans and documentation.

Response: Amended plans have been provided which rectify the discrepancies and these have been notified to surrounding properties. The submitted plans and documentation are considered acceptable for assessment purposes.

Issue: Construction issues (noise, disturbance, parking, concurrent building works within the street, potential damage to vegetation due to works etc).

Response: Council cannot refuse an application due to impacts during construction. All standard conditions in relation to construction are included in the consent conditions.

Issue: Noise disturbance from the location of the outdoor pool pump.

Response: A condition of consent requires that the pool pump be housed in a soundproof enclosure and shall only operate for limited hours to ensure any disturbance is minimised.

Issue: Loss of green space at the rear.

Response: The proposal complies with the landscaping controls of the DCP as discussed within this report. The site is extensively landscaped with the majority of vegetation being retained including the high hedging along the western side and rear boundary of the site.

Issue: The GFA calculations are incorrect as they do not include the enclosed terrace at first floor level and the additional area within the garage.

Response: The first floor level terrace is open on the rear elevation and as such is not enclosed on all sides. This area is therefore excluded from GFA/FSR. Additionally, the amended proposal has reduced the size of the vehicular parking and has retained the structure as a carport rather than an enclosed garage. The carport is enclosed by fencing however this is not an external 'wall' for the purposes of calculating GFA.

Issue: The proposal does not retain the Federation style of the dwelling and those adjoining on Bronte Road, including a heritage listed building to the east.

Response: The property sits at the end of a row of traditional dwellings to the east, including a heritage listed building at 402 Bronte Road. However, the subject site is itself is not a heritage item and it is not contained within a conservation area. The proposal is separated from the heritage item by two properties and will not harm the significance of the item itself. Although the alterations and additions have a contemporary design, this is not out of keeping with other modern buildings and additions within the streetscape.

Issue: Potential damage to vegetation on the adjoining site through the excavation for the lowering of the rear yard and the pool and the outdoor BBQ.

Response: The proposal includes a new swimming pool within the rear yard adjacent to the swimming pool on the neighbouring property at No. 394 Bronte Road. **Figures 14 and 15** below show the existing side boundary fence between the two properties. It is clear that the fencing is not compliant with the Swimming Pools Act and as such will need to be replaced with the construction of the proposed pool at the subject site which will generally impact upon vegetation that is on the boundary. The impact of trees and vegetation encroaching upon the subject site is a civil matter between the two property owners. Notwithstanding, a condition will require that the BBQ is set back 900mm from the boundary given it is of a larger size than a standard BBQ.



Figure 14: Existing side boundary fence between adjoining property (swimming pool located at adjoining property)

Issue: The landscaping plans and calculations are incorrect as it is showing vegetation on adjoining properties.

Response: The landscaping calculations within this report differ from those shown on the plans as the Council's Assessment Planner has carried out a separate calculation. The calculations of the Assessment Planner do not include the landscaping shown on the boundary along the eastern side setback of the dwelling as this does not appear to be located on the subject site. The landscaping calculations are contained to the rear and front yards and the western side setback and complies with the requirements of the DCP.

2.5. Public Interest

The proposal is considered to have no detrimental effect on the public interest, subject to appropriate conditions being imposed.

REFERRALS

The following internal referral comments were sought:

3.1. Traffic and Development

Comments were provided in relation to the original proposal including that the width of the garage door is to be reduced to a maximum of 3.9m. The amended plans reduce the width from 4.6m to 3.8m satisfying this requirement. Conditions were recommended which are included in Appendix A.

3.2. Stormwater

Conditions were provided which are included in the consent conditions.

3.3. Tree Management

Conditions were provided in regard to the protection of a street tree in front of the site which are included in the consent conditions.

4. CONCLUSION

The application has been assessed against the relevant matters for consideration under section 4.15(1) of the Act. It is recommended for approval subject to conditions of consent.

5. RECOMMENDATION TO WAVERLEY LOCAL PLANNING PANEL

That the development application be **APPROVED** by the Waverley Local Planning Panel subject to the conditions in Appendix A.

Report prepared by:	Application reviewed and agreed by:	Application reviewed and agreed by:
douce	JZancanaw	
Kylie Lucas	Jo Zancanaro	Angela Rossi
Senior Development	Acting Manager,	A/Executive Manager,
Assessment Planner	Development Assessment	Development Assessment
Date: 2 August 2023	Date: 3 August 2023	Date: 14 August 2023

Reason for WLPP referral:

2. Contentious development (10 or more objections)

OFFICE USE ONLY

Clause 4.6 register entry required (For the purposes of reporting to the planning portal, if the % approved is different to the % proposed in the original submission, please state what the variation initially proposed was – Planning Portal Requirement)	No
Determining Authority (Concurrence Authority for Clause 4.6 variation)	Local Planning Panel
Affordable Rental Housing Units? *This is a planning portal reporting requirement	No
Secondary Dwelling *This is a planning portal reporting requirement	No
Boarding House *This is a planning portal reporting requirement	No
Group Home *This is a planning portal reporting requirement	No
Trial Period database entry required	No
VPA submitted – follow up actions required	No
Refer to compliance for investigation	No
Commercial/liquor operational conditions	No
Other (please specify):	No

APPENDIX A – CONDITIONS OF CONSENT

A. APPROVED DEVELOPMENT

1. APPROVED PLANS AND DOCUMENTATION

The development must be in accordance with:

(a) Architectural Plans prepared by A77 Designs of Project No: 21-004 including the following:

Plan Number	Plan description	Plan Date	Date received by
and Revision			Council
DA-103 Rev. C	DEMOLITION PLANS & EXISTING	05/05/2023	21/06/2023
	FLOOR PLANS		
DA-201 Rev. C	LOWER GROUND FLOOR PLAN	27/05/2023	21/06/2023
DA-202 Rev. B	GROUND FLOOR PLAN	27/05/2023	21/06/2023
DA-203 Rev. B	FIRST FLOOR PLAN	27/05/2023	21/06/2023
DA-204 Rev. B	ROOF PLAN	27/05/2023	21/06/2023
DA-205 Rev. B	POOL PLAN	27/05/2023	21/06/2023
DA-301 Rev. B	EASTERN ELEVATION & WESTERN	27/05/2023	21/06/2023
	ELEVATION		
DA-302 Rev. C	SECTIONS AA & BB; NORTH &	27/05/2023	21/06/2023
	SOUTH ELEVATIONS		
DA-401 Rev. A	MATERIAL AND COLOURS	06/12/2022	08/03/2023

- (b) BASIX Certificates
- (c) The Site Waste and Recycling Management Plan (SWRMP) Part 1

Except where amended by the following conditions of consent.

2. GENERAL MODIFICATIONS

The application is approved subject to the following plan amendments:

- (a) The outdoor BBQ is to be set back from the eastern side boundary by a minimum of 900mm.
- (b) To protect the privacy of the adjoining property to the east of the site, No. 394 Bronte Road, the following privacy measures are to be implemented to windows on the eastern elevation:
 - (i) The new dining room windows defined as W108 and W109 on the plans are to be obscure glazed or fitted with a fixed external privacy screen to a minimum height of 1.6m above finished floor level.
 - (ii) The new living area windows defined as W110 and W111 on the plans are to be obscure glazed or fitted with a fixed external privacy screen to a minimum height of 1.6m above finished floor level.
 - (iii) The balustrade to the flush balcony (ie, 'Juliet' balcony) defined as D107 on the plans is to be solid.

The amendments are to be approved by the **Principal Certifying Authority** prior to the issue of any Construction Certificate.

3. DOMESTIC HEATERS

The provision of solid fuel heating is prohibited.

B. PRIOR TO THE ISSUE OF A CONSTRUCTION CERTIFICATE

The requirements outlined in this section are to be provided to the satisfaction of the Principal Certifying Authority in all instances, except where a condition explicitly specifies the approval of Council or a Council Officer is required.

GENERAL REQUIREMENTS

4. NO BUILDING OR DEMOLITION WORKS PRIOR TO RELEASE OF CONSTRUCTION CERTIFICATE

The building work, or demolition work, must not be commenced until:

- (a) a Construction Certificate has been obtained from Council or an Accredited Certifier in accordance with the *Environmental Planning and Assessment Act 1979*;
- (b) a Principal Certifying Authority has been appointed and Council has been notified of the appointment in accordance with the *Environmental Planning and Assessment Act 1979* and *Environmental Planning and Assessment Regulation 2000*; and
- (c) Council is given at least two days' notice in writing of the intention to commence the building works.

5. HOME BUILDING ACT

The builder or person who does the residential building work shall comply with the applicable requirements of Part 6 of the *Home and Building Act 1989*. In this regard a person must not contract to do any residential building work unless a contract of insurance that complies with this Act is in force in relation to the proposed work. It is the responsibility of the builder or person who is to do the work to satisfy the Principal Certifying Authority that they have complied with the applicable requirements of Part 6, before any work commences.

CONTRIBUTIONS, FEES & BONDS

6. SECTION 7.12 CONTRIBUTION

A monetary development contribution is payable to Waverley Council pursuant to section 7.12 of the *Environmental Planning and Assessment Act 1979* and the Waverley Council Development Contributions Plan 2006 in accordance with the following:

- (a) A cost report indicating the itemised cost of the development shall be completed and submitted to Council:
 - (i) Where the total development cost is less than \$500,000:
 - "Waverley Council Cost Summary Report"; or,
 - (ii) Where the total development cost is \$500,000 or more:
 - "Waverley Council Registered Quantity Surveyor's Detailed Cost Report".

A copy of the required format for the cost reports are provided in the Waverley Council Contributions Plan 2006, available on Council's website.

- (b) As legislated in section 25K of the Environmental Planning and Assessment Regulation 2000, the levy must be paid in accordance with the following;
 - (i) A development valued at \$100,000 or less will be exempt from the levy;
 - (ii) A development valued at \$100,001 \$200,000 will attract a levy of 0.5% of the full cost of the development; or
 - (iii) A development valued at \$200,001 or more will attract a levy of 1% of the <u>full</u> cost of the development.

Prior to the issue of any Construction Certificate, evidence must be provided that the levy has been paid to Council in accordance with this condition or that the cost of works is less than \$100,000.

7. SECURITY DEPOSIT

A deposit (cash or cheque) for the amount of **\$12 880** must be provided to Council for any damage caused to any property of the consent authority (ie. public land) as a consequence of the works and completing any public work (such as road work, kerbing and guttering, footway construction, stormwater drainage and environmental controls) required in connection with the consent.

This deposit (cash or cheque) must be provided to Council prior to the issue of any Construction Certificate. The full amount of the deposit, minus Council's costs for any repair of damage to Council property or rectification of unauthorised works on Council property, will be refunded after satisfactory completion all of works associated with this consent (including the required public works) to the person who paid the deposit.

8. LONG SERVICE LEVY

A long service levy, as required under section 34 of the *Building and Construction Industry Long Service Payments Act, 1986*, is to be paid in respect of this building work. Evidence that the levy has been paid is to be submitted to the Principal Certifying Authority prior to the issue of any Construction Certificate.

<u>Note</u>: Council acts as an agent for the Long Service Payment Corporation and the levy may be paid at Council's office. The levy rate is 0.25% of building work costing \$250,000 or more.

9. TREE BOND

A bond of \$5,000 is to be lodged with Council either as cash or by way of an unconditional bank guarantee to ensure the protection and maintenance of the one (1 Tristaniopsis laurina (Kanooka or Water Gum) on Scott Street.

The bond is to be lodged prior to the issue of a Construction Certificate.

The sum will be forfeited to the Council at its discretion for a breach of these requirements and will be refunded twelve (12) months from the issue of the Occupation Certificate subject to the satisfaction of Council.

CONSTRUCTION MATTERS

10. HOARDING

To ensure the site is contained during construction, a hoarding is required for the approved works, which is to be designed and constructed in accordance with the requirements of Safe Work NSW. Where the hoarding is to be erected over the footpath or any public place, the approval of Council's Compliance Unit must be obtained and the applicable fees paid, prior to the erection of the hoarding.

11. EROSION & SEDIMENT CONTROL

A Soil and Water Management Plan (SWMP), also known as an Erosion and Sediment Control Plan must be prepared in accordance with Waverley Council's Water Management Technical Manual.

The SWMP must be approved by the Principal Certifying Authority prior to the issue of a Construction Certificate. A copy of the SWMP must be kept on site at all times and made available to Council officers upon request.

The recommendations of the SWMP must be implemented and maintained during all construction activities and until the site is fully stabilised following construction.

12. DETAILS OF EXCAVATION, SHORING OR PILE CONSTRUCTION

A report shall be prepared by a suitably qualified and practising Structural Engineer/Geotechnical Engineer detailing the proposed methods of bulk excavation, shoring or pile construction, including details of vibration emissions and any possible damage which may occur to adjoining or nearby properties as a result of the proposed building and excavation works.

Any practices or procedures specified in the Structural Engineer's report in relation to the avoidance or minimisation of structural damage to adjoining properties are to be fully complied with and incorporated into the plans and specifications together with the Construction Certificate.

13. ENGINEERING DETAILS

Structural details are to be prepared and certified by a practicing Structural Engineer in connection with all structural components of the approved works, prior to the issue of the relevant Construction Certificate.

14. ENGINEERING CERTIFICATE OF ADEQUACY

A Certificate of Adequacy prepared by a practicing Structural Engineer is to be provided certifying the adequacy of the existing building structure to carry the extra load of the proposed additions, prior to the issue of the relevant Construction Certificate.

STORMWATER & FLOODING

15. STORMWATER AND PUBLIC INFRASTRUCTURE MANAGEMENT

To ensure that stormwater runoff from the development is drained in an appropriate manner, without impact to neighbouring properties and downstream systems, a detailed plan and certification of the development's stormwater management system must be submitted and approved by the Executive Manager, Infrastructure Services (or delegate) prior to the issue of the relevant Construction Certificate.

The submitted Water Management Plan prepared by E2 Civil and Structural Design, Project/Job No. 22.257, REV 0, Drawing No. SW1, SW2, SW3, dated 21/11/2022 is considered concept only.

The applicant must submit plans and specifications to comply with the Waverley Council Water Management Technical Manual October 2021 and Development Control Plan 2022 (DCP 2022). The submitted plans shall be prepared by a suitably qualified and practising Civil Engineer and address the following:

- a) Discharge points to the kerb must use the following galvanised steel box-section equivalent to pipe diameters as follows: 100 mm DIA outlet pipe use 1 x 125 mm x 75 mm x 4 mm (w x h x t).
- b) Any new downpipes are to be located wholly within the property's boundary.
- c) Provide calculations for gutter sizing for 1% AEP storm event and minimum number of downpipes required.
- d) Provide pits / risers at all junctions, change of gradient, change of direction, change in diameter, reflux valves, flat valves, orifice plates, debris screenings for maintenance access.
- e) A grated trench drain shall be provided across the (garage entrance/driveway/street boundary) within private property. Unless otherwise sized by a suitably qualified and practising Engineer, the dimensions of the trench grate shall be no less than 300mm wide by 100mm deep at the shallow end and have a "bottom" slope of 2%. This trench drain shall be connected to an approved drainage system.
- f) Pump-out pit can not be located in the ground drainage plan.
- g) Overland flow path
- h) Ensure stormwater is collected at rear of property
- i) Charged line:
 - i. There must be a minimum difference in height between the roof gutter and the surface level of the discharge pit at the property boundary of 2.0 metres. Where a minimum 2.0 metres of hydraulic head is not provided, hydraulic grade line (HGL) calculations for the 1% AEP storm event are required to demonstrate there is sufficient head to drive the system.
 - ii. A cleaning eye must be provided at the low point in the system within a pit that can be drained to an onsite dispersal system.
 - iii. Sealed cleaning eyes must be placed at 20-meter intervals, at critical bends in the pipeline and at the lowest point in the drainage system.
 - iv. A dribble pit incorporating a pipe with a screw cap on the end and a hole in the cap, shall be provided at the lowest point in the charged system. The base of the pit shall have weep holes which drain into an aggregate bed underneath the pit. The location of the dribble pit is to be shown on the engineering plans.

j) Pump Out System:

- i. The discharge rate from the site should not exceed the PSD. A full hydraulic design is required to determine the necessary storage requirements for a range of events up to and including the 1% AEP.
- ii. An overland flow path and/or surcharge and pondage in a suitably visible area must be provided.
- iii. In circumstances where no overland path exists, pondage may be approved in a suitable area. These areas must be sited with a view to minimising the cost of damage to occupiers of the property and include signage warning residents that inundation of the area may occur in the event of a pump failure.
- iv. Screening details must be provided. All electrical fittings and supply must be located to have at least 300 mm freeboard above the maximum water level and/or any overland flow path.
- k) The stormwater management plan must specify any components of the existing system to be retained and certified during construction to be in good condition and of adequate capacity to convey additional runoff and be replaced or upgraded if required.
- The design must make provision for the natural flow of stormwater runoff from uphill/upstream properties/lands. The design must include the collection of such waters and discharge to the Council drainage system (independent of any OSD system).

m) Any affected Council's infrastructure as the result of construction activities within the public domain area, inclusive of stormwater, stormwater outlet/s, kerb and gutter, pavement, grass verges and vehicle crossovers within the extent works shall be replaced as per Waverley Council Public Domain Technical Manual. All associated costs shall be borne by the applicant.

Notes:

- The checklist as set out on pages 68-76 on Council's Water Management Technical Manual (Oct 2021) available online shall be completed and submitted with any revision of Construction Certificate Plan Submission.
- The Applicant is advised to consider the finished levels of the public domain, including new or existing footpaths and pavement prior to setting the floor levels for the proposed development.
- Waverley Council standard drawings for public domain infrastructure assets are available upon request. Details that are relevant may be replicated in the Engineering design submissions however, Council's title block shall not be replicated.
- Prior to commencement of works a security deposit will be made payable to Council to ensure any
 additional damage or unauthorised works within the Council property, not conditioned above.
 Council will reserve the right to withhold the cost of restoring the damaged assets from the security
 deposit should the applicant fail to restore the defects to the satisfaction of Council.
- Council's contact for infrastructure assessment: E-mail: <u>assets@waverley.nsw.gov.au</u> or Phone: 9083 8886 (operational hours between 9.30am to 4pm Monday to Friday). The expected duration to review and approve the stormwater management plan may take at least 15 working days from the date of submission.

ENERGY EFFICIENCY & SUSTAINABILITY

16. BASIX

All requirements of the BASIX Certificate and NatHERS documentation are to be shown on the Construction Certificate plans and documentation.

WASTE

17. SITE WASTE AND RECYCLING MANAGEMENT PLAN

A Site Waste and Recycling Management Plan (SWRMP) - Part 2 is to be submitted to the Principal Certifying Authority prior to the issue of the relevant Construction Certificate, which outlines materials to be reused and/or recycled as a result of demolition and construction works. At least one copy of the SWRMP Part 2 is to be available on site at all times during construction. Copies of demolition and construction waste dockets that verify the facility that received the material for recycling or disposal and the quantity of waste received, must be retained on site at all times during construction.

TRAFFIC MANAGEMENT

18. CONSTRUCTION TRAFFIC MANAGEMENT PLAN (CTMP)

The applicant is to submit a Construction Traffic Management Plan (CTMP) for the approval of Council's Executive Manager, Infrastructure Services, or delegate, prior to the issue of any Construction Certificate. For further information on what is required in the CTMP, please refer to Council's website at:

nt_applications	conditions of	consent	evelopment		

C. COMPLIANCE PRIOR TO WORK COMMENCING AND DURING CONSTRUCTION

The requirements outlined in this section are to be provided to the satisfaction of the Principal Certifying Authority in all instances, except where a condition explicitly specifies the approval of Council or a Council Officer is required.

PRIOR TO ANY WORKS

19. CONSTRUCTION SIGNS

Prior to commencement of any works on the site and during construction a sign shall be erected on the main frontage of the site detailing the name, address and contact details (including a telephone number) of the Principal Certifying Authority and principal contractor (the coordinator of the building works). The sign shall be clearly legible from the adjoining street/public areas and maintained throughout the building works.

DEMOLITION & EXCAVATION

20. DEMOLITION – ASBESTOS AND HAZARDOUS MATERIALS

The demolition, removal, storage, handling and disposal of products and materials containing asbestos must be carried out in accordance with the relevant requirements of SafeWork NSW and the NSW Environment Protection Authority (EPA), including:

- Work Health and Safety Act 2011;
- Work Health and Safety Regulation 2017;
- SafeWork NSW Code of Practice for the Safe Removal of Asbestos;
- Australian Standard 2601 (2001) Demolition of Structures;
- Protection of the Environment Operations Act 1997.

At least 5 days prior to the demolition, renovation work or alterations and additions to any building, the person acting on the consent shall submit a Work Plan to the Principal Certifying Authority in accordance with Australian Standard AS 2601-2001, Demolition of Structure and a Hazardous Materials Assessment prepared by a person with suitable expertise and experience. The Work Plan and Hazardous Materials Assessment shall:

- (a) Outline the identification of any hazardous materials, including surfaces coated with lead paint;
- (b) Confirm that no asbestos products are present on the subject land, or
- (c) particularise a method of safely disposing of the asbestos in accordance with the Code of Practice on how to safely remove asbestos published by SafeWork NSW (catalogue WC03561);
- (d) Describe the method of demolition;
- (e) Describe the precautions to be employed to minimise any dust nuisance; and
- (f) Describe the disposal methods for hazardous materials.

21. CONTROL OF DUST ON CONSTRUCTION SITES

The following requirements apply to demolition and construction works on site:

- (a) Hazardous dust is not to be allowed to escape from the site. The use of fine mesh dust proof screens or other measures are recommended. Any existing accumulations of dust (e.g. ceiling voids and wall cavities) must be removed by the use of an industrial vacuum fitted with a high efficiency particle air (HEPA) filter. All dusty surfaces and dust created from work are to be suppressed by a fine water spray. Water must not be allowed to enter the street and stormwater systems. Demolition is not to be performed during adverse winds, which may cause dust to spread beyond the site boundaries.
- (b) All contractors and employees directly involved in the removal of hazardous dusts and substances are to wear protective equipment conforming to Australian Standard AS1716 Respiratory Protective Devices.

22. CLASSIFICATION OF WASTE/ DISPOSAL OF EXCAVATED SOILS

Prior to the exportation of waste (including fill or soil) from the site the material must be classified in accordance with the provisions of the Protection of the Environment Operations Act, 1997 and the NSW EPA Waste Classification Guidelines 2014.

23. EXCAVATION AND BACKFILLING

All excavations and backfilling associated with the erection or demolition of a building must be executed safely and in accordance with the appropriate professional standards and must be properly guarded and protected to prevent them from being dangerous to life or property.

If an excavation associated with the erection or demolition or a building extends below the level of the footings of a building on an adjoining allotment of land, the excavation is to be managed by a practising structural engineer.

CONSTRUCTION MATTERS

24. CONSTRUCTION HOURS

Demolition and building work must only be undertaken between the hours of 7am and 5pm on Mondays to Fridays and 8am to 3pm on Saturdays, with no work to be carried out on Sundays and public holidays.

Excavation works involving the use of heavy earth movement equipment, including rock breakers and the like, must only be undertaken between the hours of 7am and 5pm on Mondays to Fridays, with no such work to be carried out on Saturday, Sunday or a public holiday.

Noise from construction activities shall comply with the *Protection of the Environmental Operations* (Noise Control) Regulation 2017.

25. STOCKPILES, STORAGE OF MATERIALS AND LOCATION OF BUILDING OPERATIONS

All building materials and any other items associated with the development are to be stored within the property. No materials are to be stored on Council's footpath, nature strip, or road reserve without prior Council approval.

26. CONSTRUCTION INSPECTIONS

The building works are to be inspected during construction by the Principal Certifying Authority (PCA) in accordance with the Building Legislation Amendment (Quality of Construction) Act 2002 and 162A Critical stage inspections for building work of the Environmental Planning and Assessment Regulation 2000.

27. CERTIFICATE OF SURVEY - LEVELS

All construction works are to be in accordance with the Reduced Levels (RLs) as shown on the approved plans. Certification from a Registered Surveyor certifying ground, upper floor/s and finished ridge levels is to be submitted to the Principal Certifying Authority during construction and prior to continuing to a higher level of the building.

28. WORK OUTSIDE PROPERTY BOUNDARY

This consent does not authorise any work outside the property boundary.

29. CONSTRUCTION OF SWIMMING POOLS AND OUTDOOR SPAS

The following applies to the construction of swimming pools and outdoor spas:

- (a) Reinforcement of the swimming pool/outdoor spa is to be inspected by an Accredited Officer or other suitably qualified person prior to the pouring of concrete
- (b) The electrical wiring system for any proposed underwater artificial lighting installation to the pool/spa is to be installed in accordance with the requirements of Australian Standard 3000, Part 1 Wiring Rules
- (c) The swimming pool/outdoor spa water is to be treated by an approved water treatment and filtration unit
- (d) To prevent noise nuisance to surrounding properties, the swimming pool/outdoor spa filtration motor and pump unit is to be housed within a ventilated soundproof enclosure
- (e) Waste waters from the swimming pool/outdoor spa are to be discharged into Sydney Water's sewerage system and in this regard, approved plans MUST be submitted to Sydney Water at least 14 days prior to commencement of building operations.

TREE PROTECTION AND REMOVAL

30. TREE PROTECTION

All trees on site and adjoining properties, including street trees, are to be retained and protected in accordance with AS4970-2009 'Protection of Trees on Construction Sites' and to be certified by an Arborist with AQF level 5 qualification or above, unless approved to be removed in this development consent.

Precautions shall be taken when working near trees to ensure their retention, including the following:

- (a) Do not store harmful or bulk materials or spoil under or near trees;
- (b) Prevent damage to bark and root system;
- (c) Do not use mechanical methods to excavate within root zones;
- (d) Do not add or remove topsoil from under the drip line;
- (e) Do not compact ground under the drip line;
- (f) Do not mix or dispose of liquids within the drip line of the tree; and

(g) All trees marked for retention must have a protective fence/guard placed around a nominated perimeter.

Trunk protection as per AS 4970 – 2009, Section 4.5.3 is to be installed.

Padding to be used shall be non-absorbing or free draining to prevent moisture build up around the part being protected.

The trunk protection shall consist of a layer of carpet underfelt (or similar) wrapped around the trunk, followed by 1.8 metre lengths of softwood timbers (90 x 45mm in section) aligned vertically and spaced evenly around the trunk at 150mm centres (i.e. with a 50mm gap) and secured together with 2mm galvanised wire or galvanised hoop strap. The timbers shall be wrapped around the trunk (over the carpet underfelt), but not fixed to the tree to avoid mechanical injury or damage to the trunk. Trunk protection must be installed prior to any site works including demolition and maintained in good condition for the duration of the construction period.

- (a) Trunk protection to be removed at the issue of the Occupation Certificate subject to the satisfaction of Council.
- (b) TPZ A 1.8m chain link wire fence or the like shall be erected around the above trees to be retained to protect them from damage during construction. Fencing is not to be removed until all building work has been completed. Fencing to be installed to the dimensions outlined in the table above.
- (c) If any tree roots are exposed during any approved works then roots smaller than 30mm are to be pruned as per the specifications below. Any roots greater than 30mm are to be assessed by a qualified arborist before any pruning is undertaken.
- (d) If tree roots are required to be removed for the purposes of constructing the approved works, they shall be cut cleanly by hand, by an experienced Arborist/Horticulturist (with a minimum of the Horticulture Certificate or Tree Surgery Certificate).
- (e) It is the arborist's responsibility to determine if such root pruning is suitable. If there are any concerns regarding this process, then Waverley Council's Tree Management Officer is to be contacted to make final determination.
- (f) If any trees on neighboring properties require pruning, then permission must be gained from the owner of the tree(s) and an Application to Prune or Remove Trees on Private Property is then to be presented to Council for processing.
- (g) If any trees on Council owned land require pruning, the applicant is to supply an tree pruning report from an Arborist with AQF level 5 qualification or above with photos showing the branches that need to be removed.
- (h) If approval is granted the applicant may prune the tree at their expense, by an experienced Arborist/Horticulturist (with a minimum of the Horticulture Certificate or Tree Surgery Certificate).

31. HEADROOM CLEARANCE

The headroom clearance on the entry and within the garage is to be a minimum of 2.2 metres.

D. PRIOR TO THE ISSUE OF AN OCCUPATION CERTIFICATE

The requirements outlined in this section are to be provided to the satisfaction of the Principal Certifying Authority in all instances, except where a condition explicitly specifies the approval of Council or a Council Officer is required, prior to the issue of an Occupation Certificate or Subdivision Certificate, whichever applies.

32. FINAL OCCUPATION CERTIFICATE

Prior to occupation or use of the development, an Occupation Certificate must be obtained.

The Principal Certifying Authority must be satisfied that the requirements of the *Environmental Planning & Assessment Act 1979* have been satisfied including all critical stage inspections. Documentary evidence of all required inspections is to be submitted to Council.

33. CERTIFICATION OF BASIX COMMITMENTS

The Principal Certifying Authority shall certify that the all the undertakings in the approved BASIX certificate have been completed.

34. CERTIFICATION OF NEWLY CONSTRUCTED AND RETAINED STORMWATER DRAINAGE SYSTEM

Prior to issue of any Occupation Certificate, certification is to be provided from a suitably qualified and practising Engineer or Plumber, that any new stormwater drainage system has been constructed in accordance with the Development Consent, Water Management Technical Manual October 2021, all applicable Codes, Policies, Plans, Standards, and good engineering practice. Similarly, any retained stormwater drainage system is unblocked, in good working order and to be repaired/replaced to best practice. A copy of the certification must be submitted to Council.

35. CERTIFICATION OF SWIMMING POOL/OUTDOOR SPA

Prior to the pool being used, the following must be provided;

- (a) Certification that the pool has been constructed in accordance with the consulting engineers design;
- (b) Evidence that the swimming pool/outdoor spa has been registered on the State Government Swimming Pool Register (http://www.swimmingpoolregister.gov.au);
- (c) A sign outlining details of resuscitation techniques for adults, children and infants has been placed in a prominent position, close to the pool/outdoor spa. Signs are available from Council;
- (d) A copy of the occupation certificate must be submitted to Council.

Note: Swimming/spa pool pumps are restricted from use between 8pm to 7am weekdays and Saturdays, 8pm to 8am on Sundays and public holidays in accordance with the requirements of the Protection of the Environment Operations (Noise Control) Regulation 2017.

36. WORKS-AS-EXECUTED DRAWINGS – STORMWATER DRAINAGE SYSTEM

- a. A Works-As-Executed drawing (WAED) of the stormwater drainage system must be prepared, stamped, and signed by a Registered Surveyor. This drawing must detail the alignment of all pipelines, pits, basement pump-out facility, rainwater harvesting facility and other drainage-related infrastructure. An original or a colour copy must be submitted to Waverley Council. Where changes have occurred, the Council-approved plans shall be marked-up in red ink and shall include levels and locations for the drainage structures and works.
- b. A suitably qualified and practicing Engineer must provide certification of the WAED of the stormwater drainage system that the stormwater drainage works and basement pump-out facility were constructed to their satisfaction and in accordance with the Development Consent, Water Management Technical Manual, all applicable Codes, Policies, Plans, Standards, and good engineering practice. A copy of the aforementioned letter of certification must be submitted to Council.

37. CREATION OF POSITIVE COVENANT AND RESTRICTION FOR PUMP OUT SYSTEM

Prior to the issue of an Occupation Certificate, a "Positive Covenant" and "Restriction on the Use of Land" shall be created for the On-Site Stormwater Detention (OSD) system, under Section 88E of the Conveyancing Act 1919. This is to place a restriction on the Title that the OSD system is maintained and kept free of debris/weed to allow unobstructed passage of stormwater through the site and underneath the residence. The property owner/occupant shall not modify or remove the OSD system without consent from Council.

The wording of the Instrument shall be submitted to and approved by Executive Manager, Infrastructure Services (or delegate) prior to lodgement at NSW Land Registry Services.

Where a Title exists, the Positive Covenant and Restriction on the Use of Land is to be created via an application to the NSW Land Registry Services using forms 13PC and 13RPA. Accompanying this form is the requirement for a plan to scale showing the relative location of the OSD system, including its relationship to the building footprint. Electronic color photographs of the OSD system shall accompany the application for the Positive Covenant and Restriction on the Use of Land.

The Instrument shall be registered, and a registered copy of the document shall be submitted to and approved by the consent authority prior to the issue of an Occupation Certificate or use of the building. All associated costs shall be borne by the applicant.

38. PLANNED PREVENTATIVE MAINTENANCE SCHEDULE FOR PUMP OUT SYSTEM

The registered proprietor shall be required to submit written intent to establish and maintain a Planned Preventative Maintenance (PPM) schedule of the pump out system prior to the issue of Occupation Certificate. Council will not be liable for any claims for damages arising from the failure of the pump out system. Evidence shall be submitted to the Executive Manager, Infrastructure Services or delegate prior to the issue of the Occupation Certificate.

E. ADVISORY MATTERS

The following advisory matters are provided as additional information to ensure compliance with the relevant legislation and requirements. You must also check other Commonwealth and NSW Acts and Regulations which may apply to the works or use approved in this application.

AD1. POST CONSENT CONDITIONS REQUIRING COUNCIL INPUT

Various conditions require further input, review or approval by Council in order to be satisfied following the determination of the application (that is, post consent). In those instances, please adhere to the following process to avoid delays:

- Please read your conditions carefully.
- Information to be submitted to Council should be either via email to info@waverley.nsw.gov.au or via the NSW Planning Portal (if required).
- Attention the documentation to the relevant officer/position of Council (where known/specified in condition).
- Include DA reference number.
- Include condition number/s seeking to be addressed.
- Where multiple conditions need Council input, please try to group the documentation / email/s into relevant subjects (multiple emails for various officers may be necessary, for example).
- Information to be submitted in digital format refer to 'Electronic lodgement guidelines' on Council's website. Failure to adhere to Council's naming convention may result in documentation being rejected.
- Where files are too large for email, the digital files should be sent to Council via CD/USB. Council does not support third party online platforms (data in the cloud) for receipt of information.
- Please note, in some circumstances, additional fees and/or additional documents (hard copy) may be required.
- Council's standard for review (from date the relevant officer receives documentation) is 14 days. Times may vary or be delayed if information is not received in this required manner.

AD2. DIAL BEFORE YOU DIG

Underground assets may exist in the area that is subject to your application. In the interests of health and safety and in order to protect damage to third party assets please contact Dial Before You Dig at www.1100.com.au or telephone on 1100 before excavating or erecting structures (this is the law in NSW). If alterations are required to the configuration, size, form or design of the development upon contacting the Dial Before You Dig service, an amendment to the development consent (or a new development application) may be necessary. Individuals owe asset owners a duty of care that must be observed when working in the vicinity of plant or assets. It is the individual's responsibility to anticipate and request the nominal location of plant or assets on the relevant property via contacting the Dial Before You Dig service in advance of any construction or planning activities.

AD3. TELECOMMUNICATIONS ACT 1997 (COMMONWEALTH)

Telstra (and its authorised contractors) are the only companies that are permitted to conduct works on Telstra's network and assets. Any person interfering with a facility or installation owned by Telstra is committing an offence under the Criminal Code Act 1995 (Cth) and is liable for prosecution. Furthermore, damage to Telstra's infrastructure may result in interruption to the provision of essential services and significant costs. If you are aware of any works or proposed works which may affect or impact on Telstra's assets in any way, you are required to contact: Telstra's Network Integrity Team on Phone Number 1800810443.

AD4. ALTERATIONS AND ADDITIONS ONLY

This consent is for alterations and additions to the existing building only and should during the course of construction a significant amount of the remaining fabric of the building be required to be removed, works must cease immediately and a new development application will be required to be submitted for assessment.

AD5. EXCAVATION TO BE LIMITED

Excavation shall be limited to that shown in the approved plans. Any further excavation will require Council approval.

AD6. BONDI - ROSE BAY SAND BODY

This site may be located within the Bondi - Rose Bay Sand Body as identified in Council's Aboriginal Cultural Heritage Study 2009. Should an object of potential Aboriginal or archaeological significance be discovered during the demolition, excavation or construction period associated with this development, works are to immediately cease and the NSW National Parks and Wildlife Service must be contacted.

Waverley Council must be notified of any referral to the NSW National Parks and Wildlife Service and be provided with a copy of any subsequent response.

AD7. TREE REMOVAL/PRESERVATION

Any trees not identified for removal in this application have not been assessed and separate approval may be required. Any pruning of trees on adjoining properties required for the erection of scaffolding and/or the construction of the building may also require approval.

AD8. ENGINEERING PLANS ASSESSMENT AND WORKS INSPECTION FEES

The applicant is to pay to Council fees for assessment of all engineering plans and inspection of the completed works in the public domain inclusive of all stormwater assessment, in accordance with Council's Schedule of Fees & Charges at the time of engineering plan approval, prior to such approval being granted by Council.

An invoice will be issued to the applicant for the amount payable, which will be calculated based on the design plans for the subject development.

AD9. ONGOING MAINTENANCE - STORMWATER DRAINAGE SYSTEM

Council will need to be provided with a pump systems maintenance activity. At a minimum, the pump system must be:

- Kept clean and free from silt, rubbish, and debris.
- Be maintained so that it functions in a safe and efficient manner.
- Not be altered without prior consent in writing of the Council.

AD10. RAINWATER HARVESTING AND REUSE

The operation of all devices or appliances installed within the development approved by this consent as required by conditions pertinent to rainwater harvesting and rainwater reuse must be maintained in good operating order at all times.

AD11. ECOLOGICALLY SUSTAINABLE DEVELOPMENT RECOMMENDATIONS

- a) Indoor air quality: Council strongly encourages the use of electrical cooktops, ovens and internal heating systems within residential developments to ensure that ambient indoor air quality levels specified in the National Environmental Protection Measure (Ambient Air Quality) are met.
- b) Ventilation: Council strongly encourages the installation of ceiling or wall mounted fans or Heat Recovery Ventilation (HRV) Units within residential developments to enable adequate ventilation of habitable rooms.
- c) Domestic hot water: Council strongly encourages the installation of electric hot water systems. If an electrical system is not installed it is suggested to include specific provisions to enable the future installation.



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Application No: DA-50/2023

Date Received: 21/06/2023

396 BRONTE ROAD BRONTE

LIST OF DRAWINGS	RE
DA_001 - Cover Sheet	В
DA_103 - Demolition Plan - Existing Floor Plans	C
DA_104 - GFA Calculations	C
DA_105 - Basix Commitments	В
DA_201 - Lower Ground Floor Plan	В
DA_202 - Ground Floor Plan	В
DA_203 - First Floor Plan	В
DA 204 - Roofs Plan	В
DA 301 - Eastern Elevation & Western Elevation	В
DA 302 - Sections AA' & BB' & South & North Elevations	C
DA_601 - Landscape Plan	В





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PROJECT
396 BRONTE ROAD
BRONTE 2024

NATHAN MOORE & LORENA MEDINA

DEVELOPMENT CONCEPT
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COVER	SHEET

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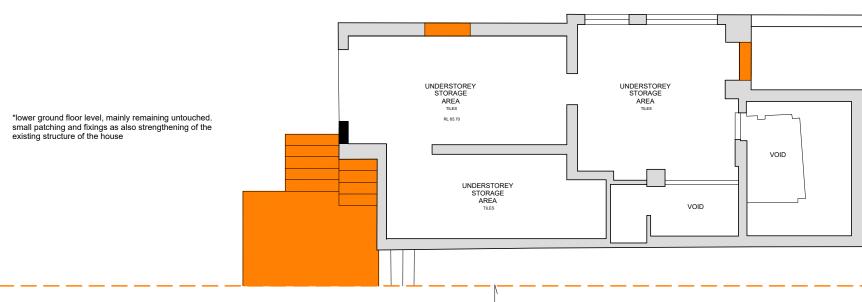
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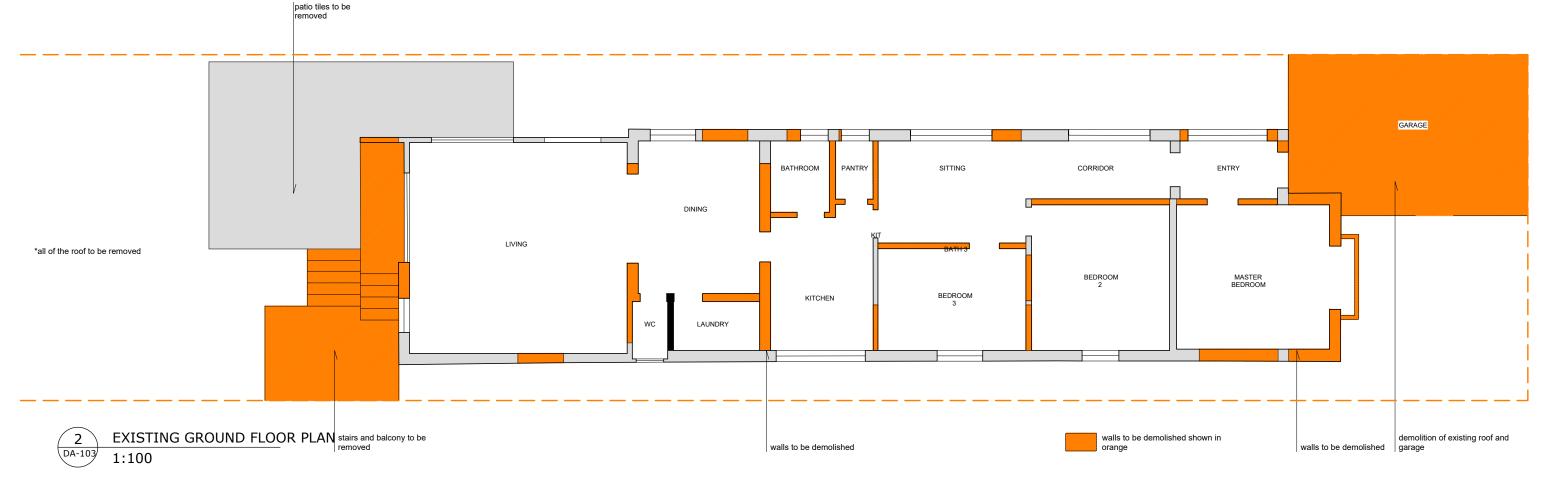
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1 DA-103 EXISTING LOWER GROUND FLOOR PLAN replace boundary fences 1:100







396 BRONTE ROAD BRONTE 2024

NATHAN MOORE & LORENA MEDINA DEVELOPMENT CONCEPT

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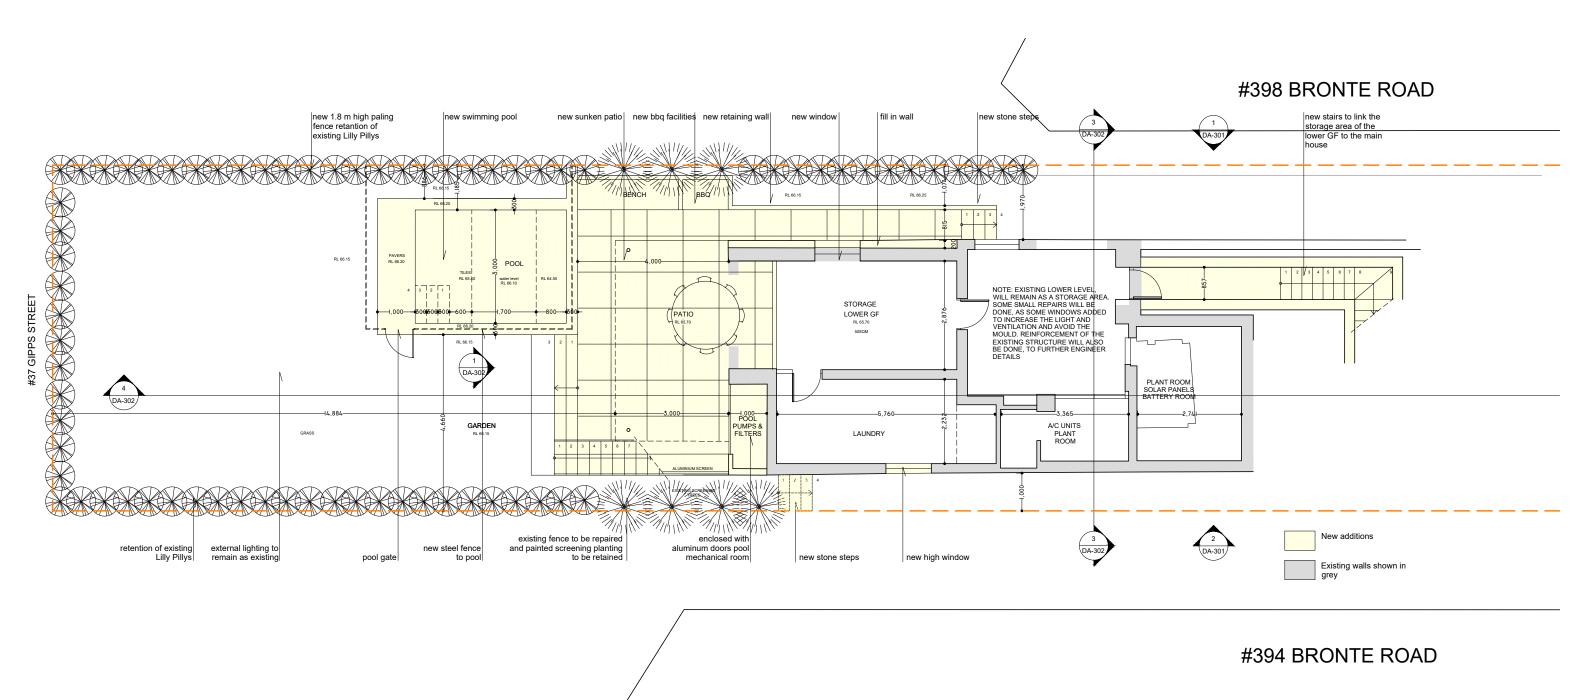
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NO FOR CONSTRUCTION Page 185 of 500

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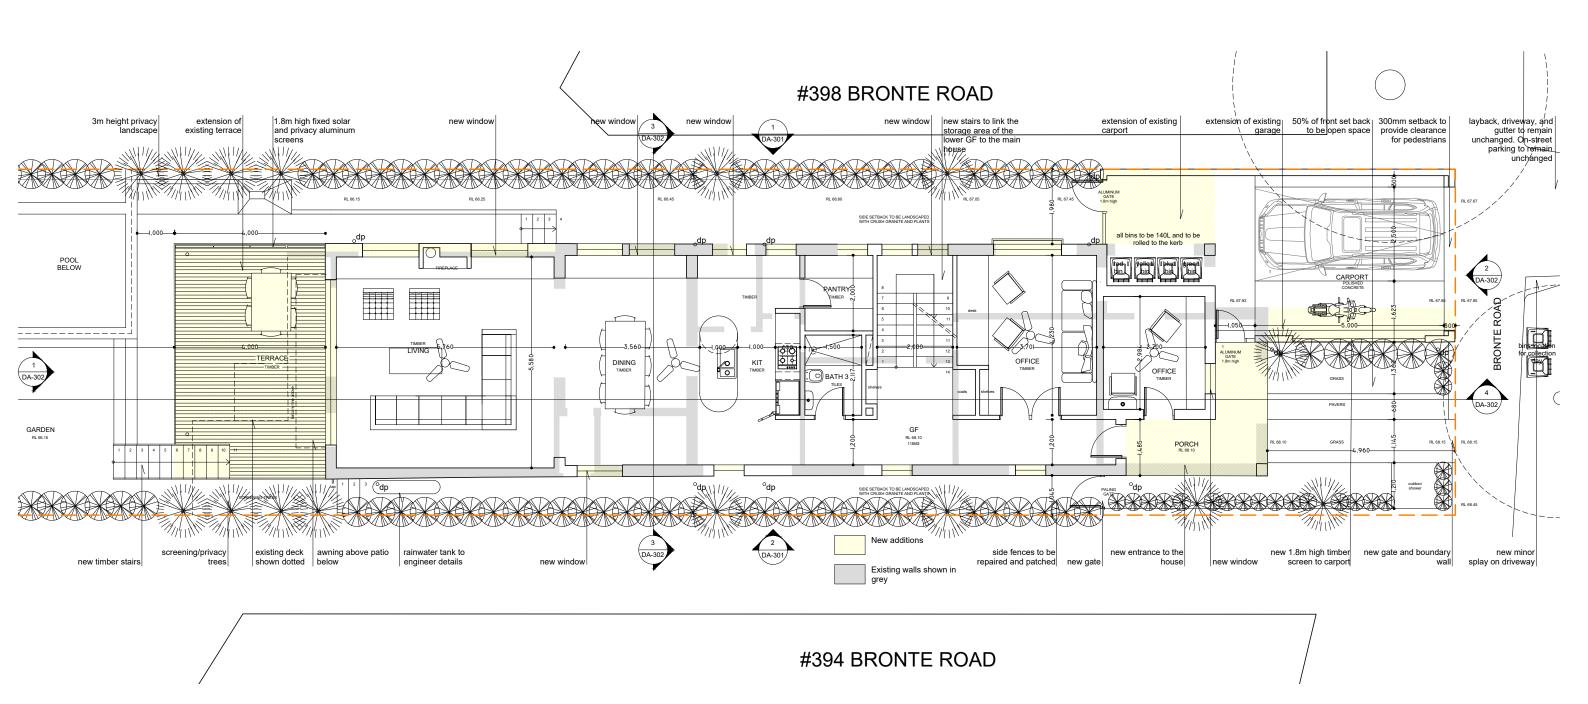
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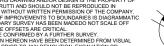
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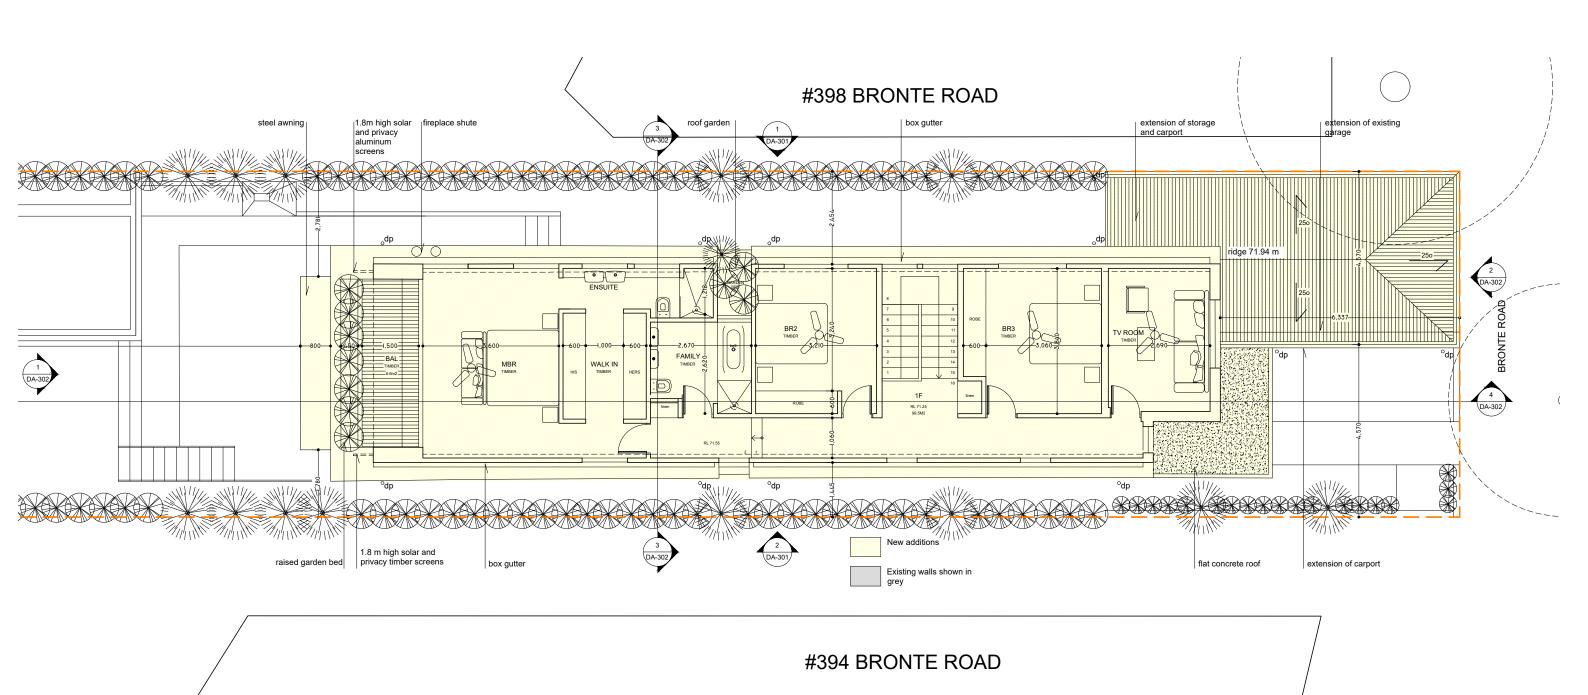
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FIRST FLOOR PLAN

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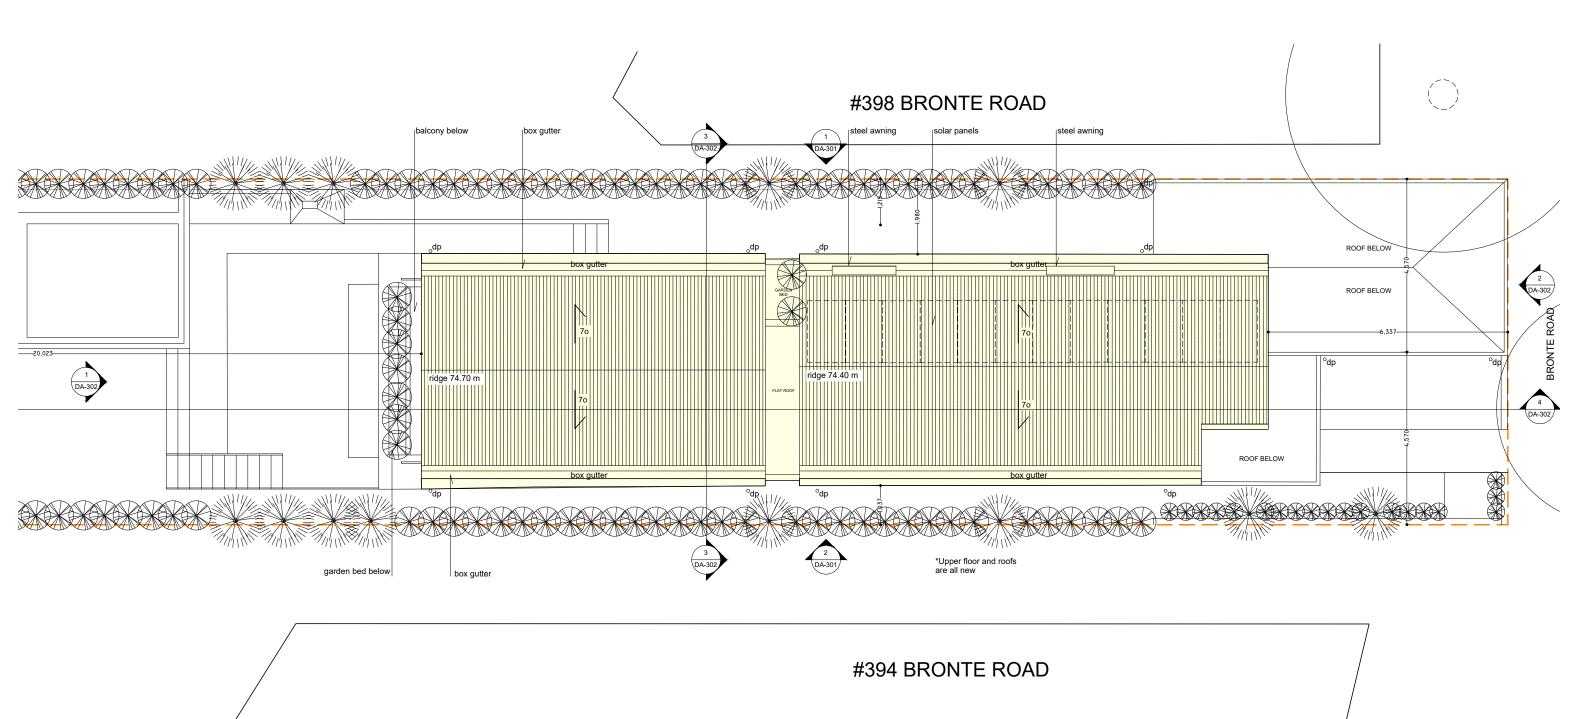
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ROOFS PLAN

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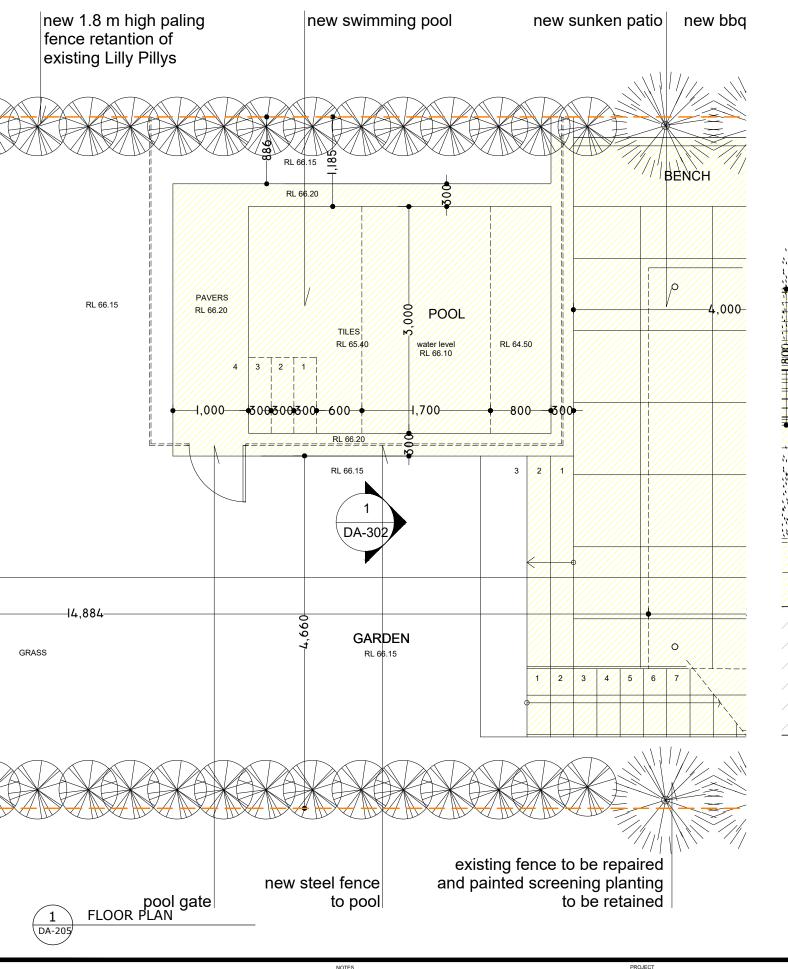
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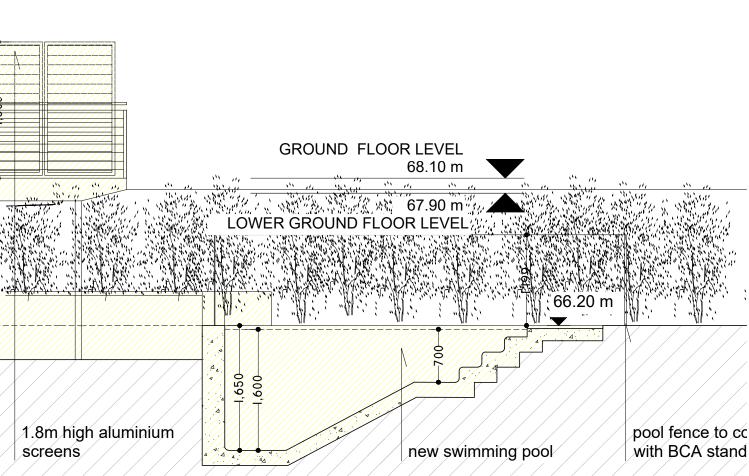
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FIRST FLOOR LEVEL 71.55 m





2. RELATIONSHIP OF I

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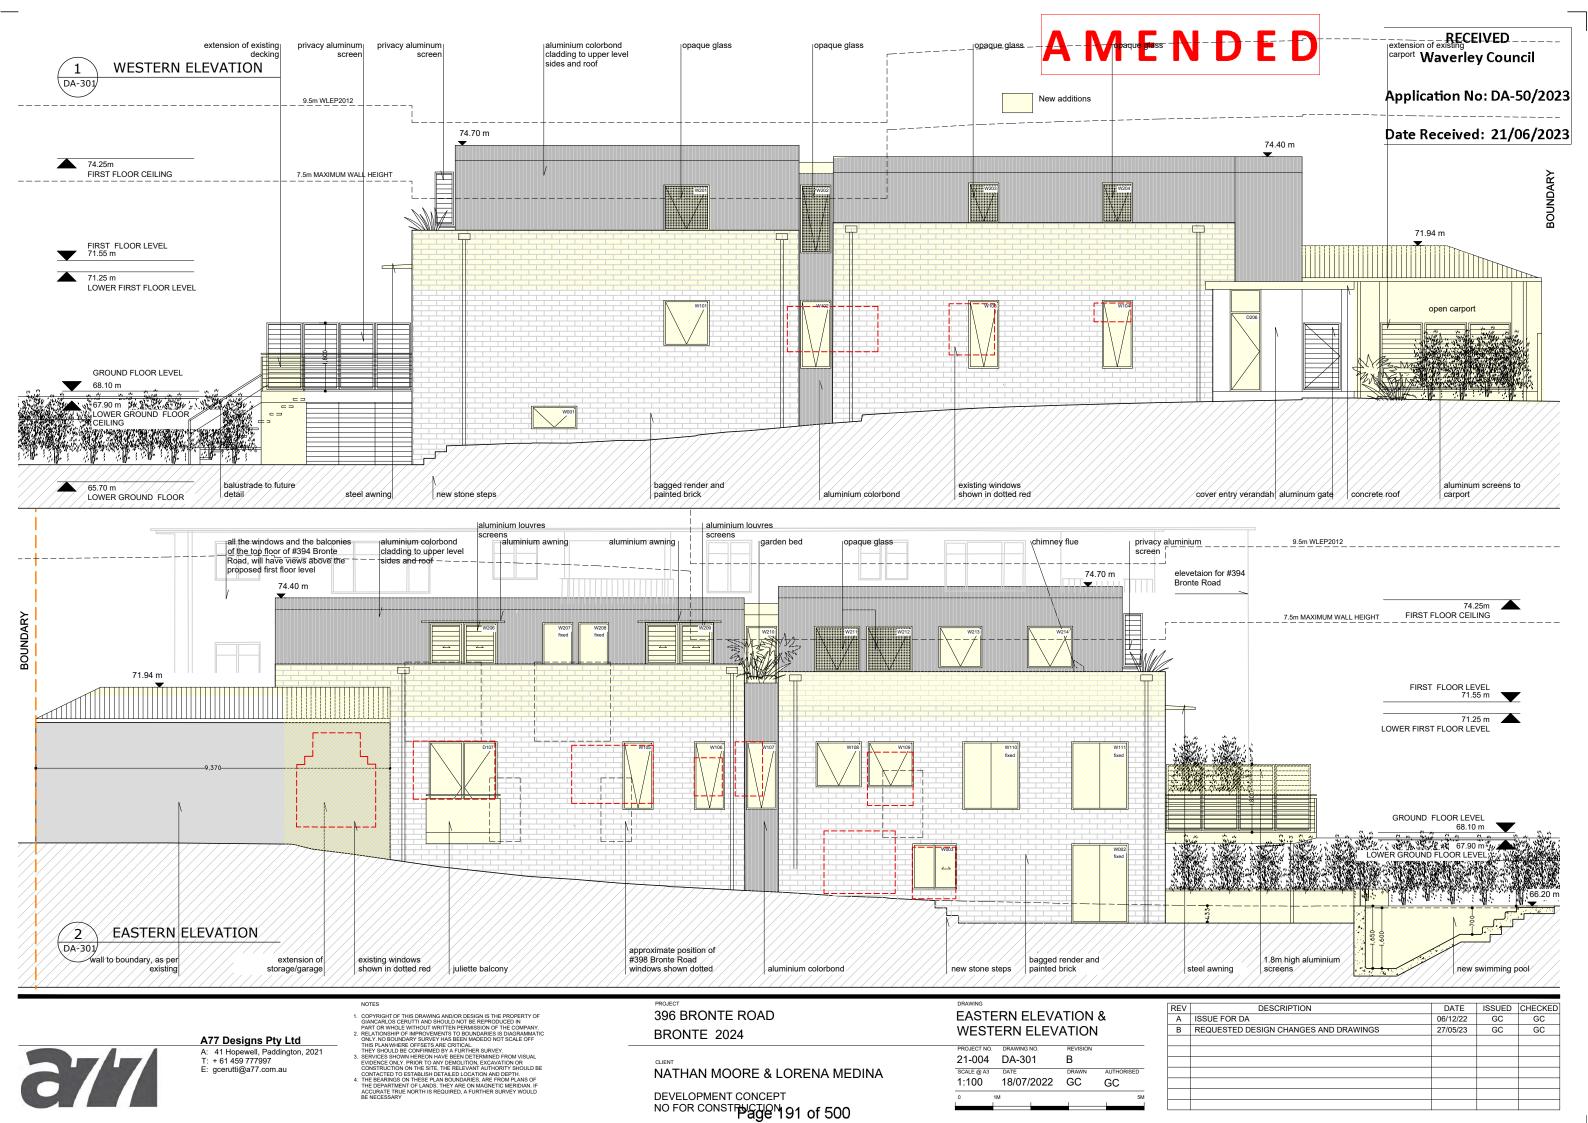
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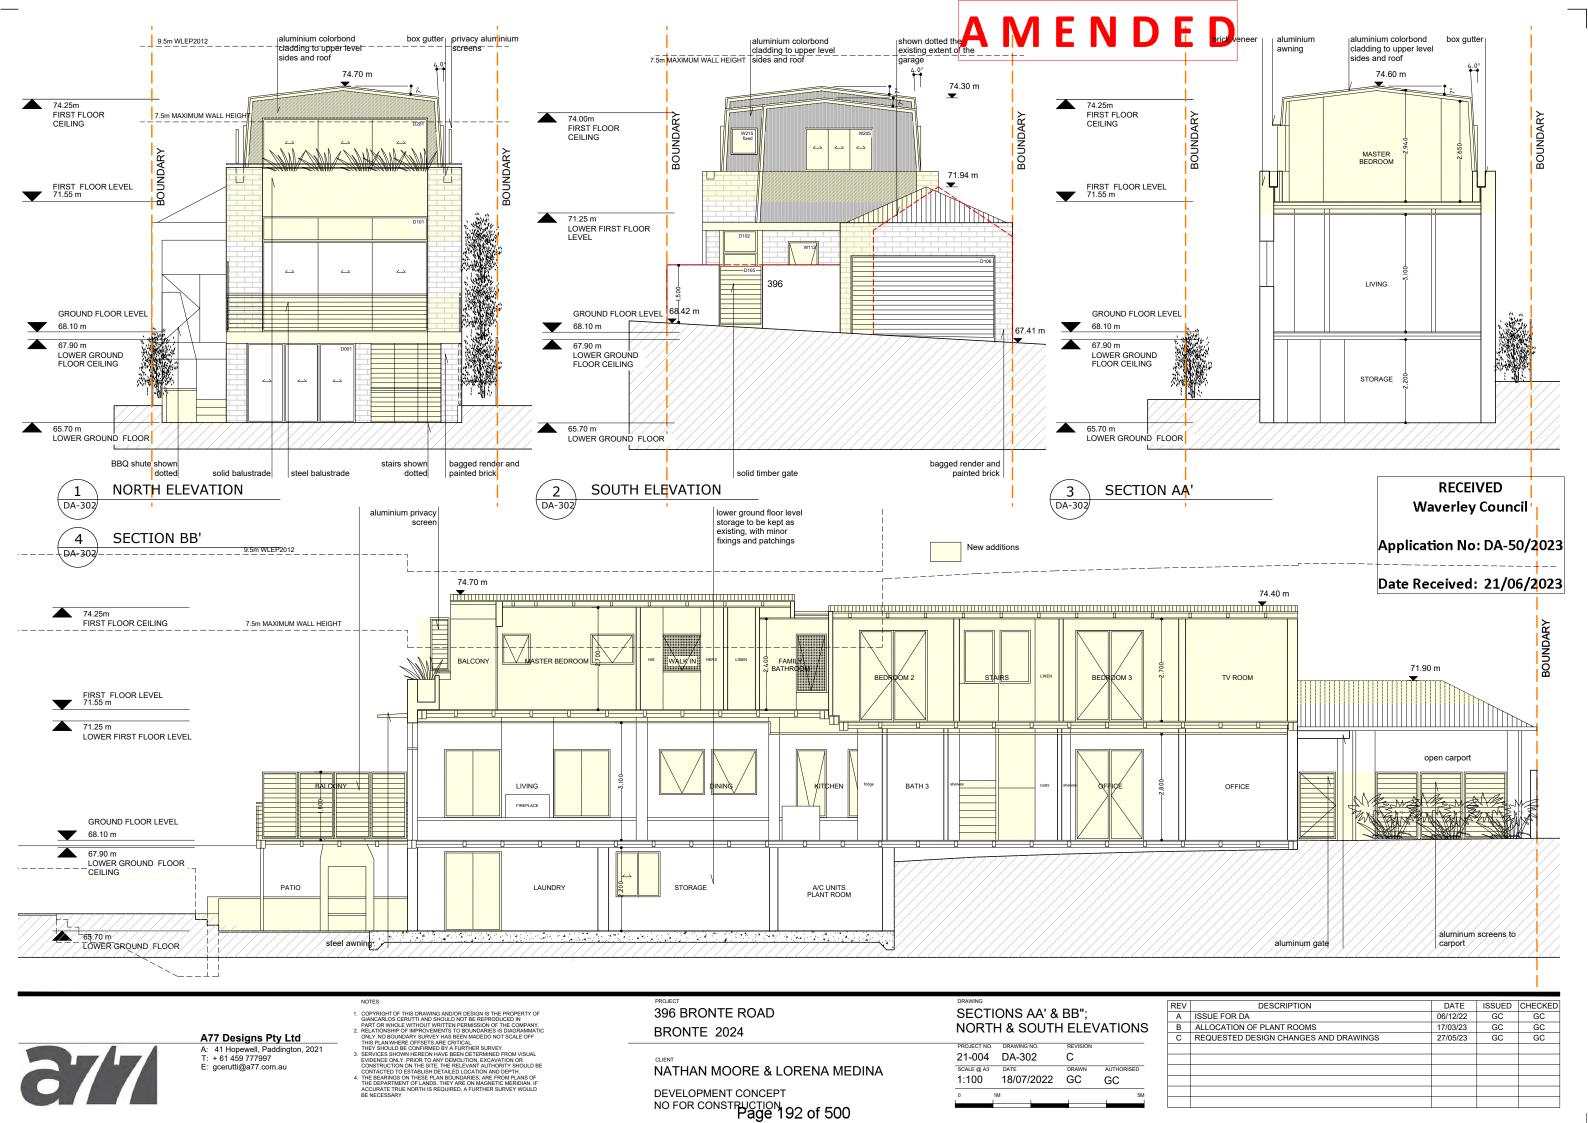
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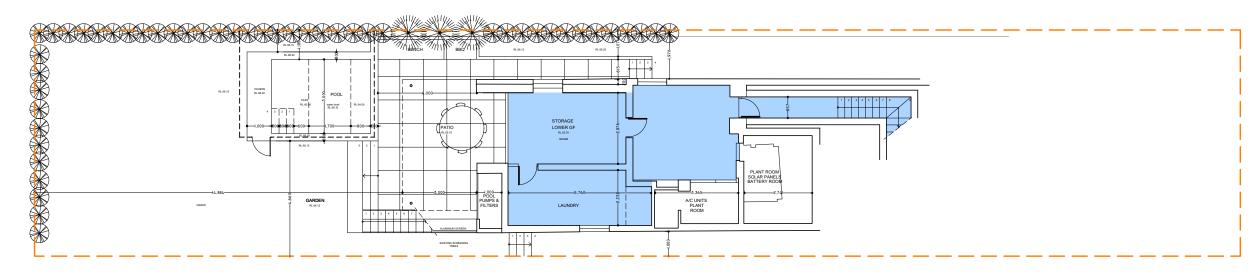
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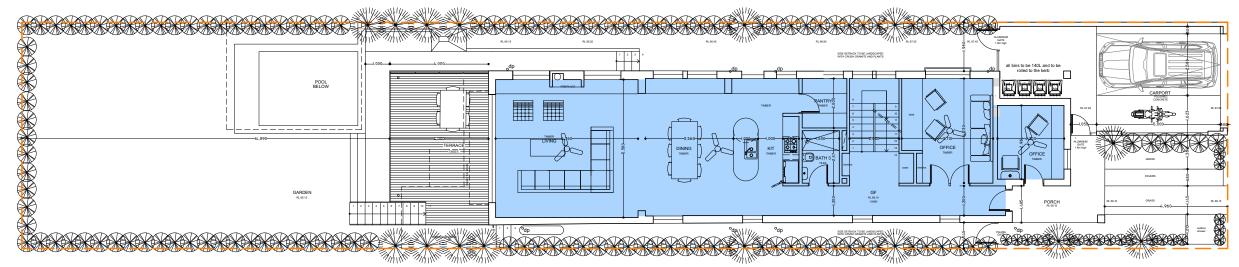
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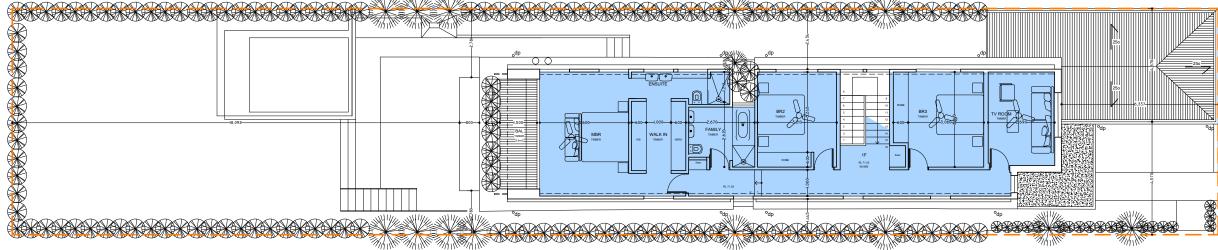




LOWER GROUND FLOOR PLAN DA-104 NTS



GROUND FLOOR PLAN DA-104



FIRST FLOOR PLAN DA-104 NTS

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GFA CALCULATIONS

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GROSS FLOOR AREA CALCULATIONS

LOWER GROUND FLOOR AREA - 50SQM

GROUND FLOOR AREA - 120SQM FIRST FLOOR AREA - 95.5SQM

SITE AREA - 446SQM

TOTAL - 265.5SQM

LANDSCAPE - 177SQM

PROPOSED FSR -.595 = 1

DEEP SOIL - 110SQM

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Date Received: 21/06/2023



1 Roofs & side taped walls sample



1 Roofs & side taped walls sample



Southerly*



Woodland Grey®

- 2 Colour for Roofing
- 3 Colour for windows and downpipes



4 Whitewash brick



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Date Received: 08/03/2023



5 Balcony





7 BBQ



8 Aluminium Windows




9 Pool fence



DETAIL ELEVATION



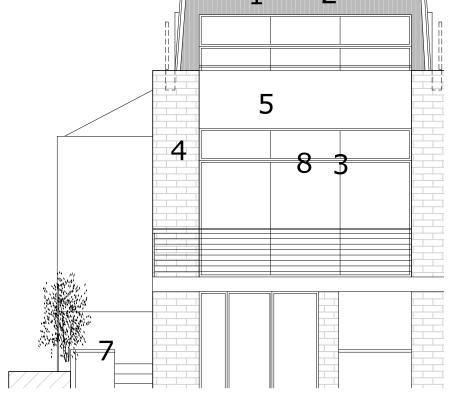

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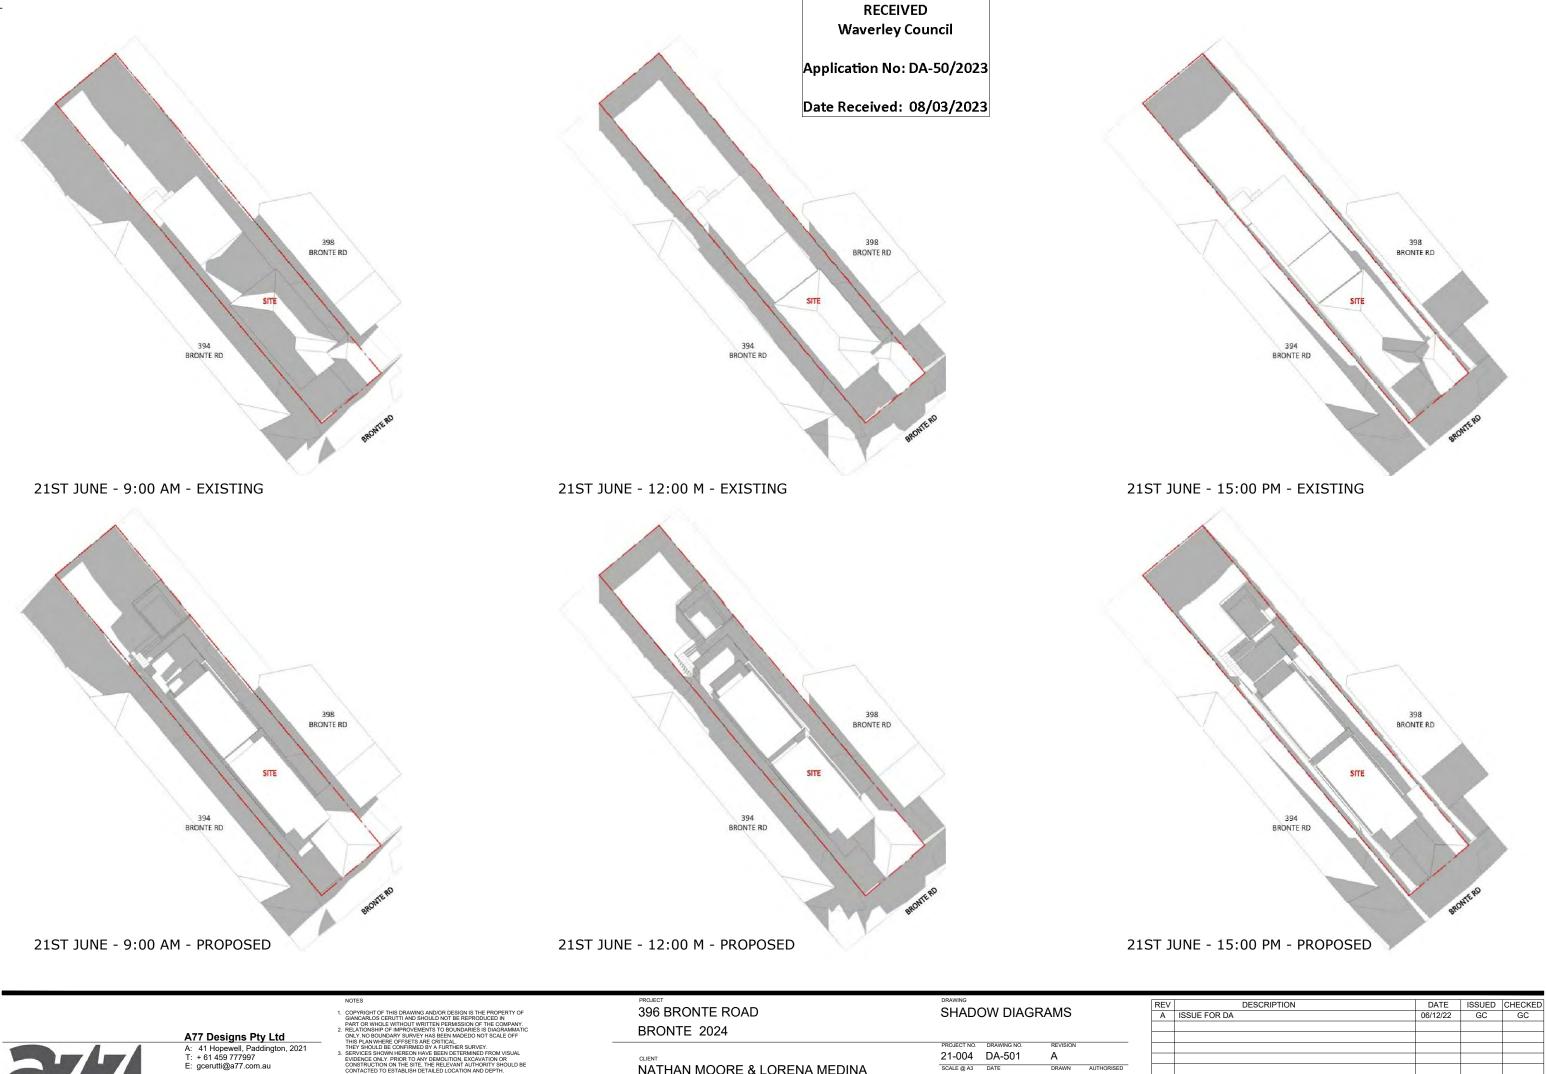
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MATERIALS AND COLOURS

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6 Pool





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Report to the Waverley Local Planning Panel

Application number	DA-19/2023	
Site address	134 Hewlett Street, Bronte	
Proposal	Demolition of the existing dwelling and construction of a new part- two, part-three storey dwelling house, garage, landscaping works and swimming pool	
Date of lodgement	1 February 2023	
Owner	Ms D R Lewis	
Applicant	Ms D R Lewis	
Submissions	One submission	
Cost of works	\$ 1,716,190.00	
Principal Issues	Building height and view sharing;Excavation;Balconies.	
Recommendation	That the application be APPROVED in accordance with the conditions contained in the report	

SITE MAP



1. PREAMBLE

1.1. Executive Summary

The development application seeks consent for demolition of the existing dwelling and construction of a new part-two, part-three storey dwelling house, including garage, landscaping works and swimming pool at the site known as 134 Hewlett Street, Bronte.

The principal issues arising from the assessment of the application are as follows:

- Building height and view sharing;
- Excavation;
- Balconies.

The assessment finds these issues acceptable because the exceedance of the building height development standard would not unreasonably impact on the environmental amenity of neighbouring properties with respect to solar access, privacy, and the sharing of views. The applicant's Clause 4.6 written request adequately addresses the matters required to be addressed under clause 4.6 of the Waverley LEP 2012.

The proposed exceedance to the excavation control is justified on the basis of the sloping site and the additional excavation is not considered to contribute to the overall bulk and scale of the development. The lower levels of excavated area have been reduced from the original application and the proposal includes setbacks from the side boundaries up to 1.2m. A Geotechnical Report was submitted with the latest amended plan set which concluded that the site is suitable for the proposed works and that excavation and construction may be carried out safely provided that the recommendations of the report are implemented. A condition of consent is recommended to require the development to be undertaken in accordance with the Geotechnical Report.

The proposed balconies have been assessed against the variation controls for larger balconies, which concluded that the larger balconies may be supported in this instance as they are not likely to impact on privacy or solar access and have been appropriately treated with privacy screening to mitigate potential impacts. In addition, there is a prevalence of larger elevated terraces and balconies in the vicinity of the site, and therefore the proposal is considered satisfactory.

Conditions of consent are recommended to require the landscape plan to be updated to comply with the relevant controls for sites within a biodiversity habitat corridor and for the mature trees within the site's frontage to be replaced elsewhere on the site in an appropriate location and species to ensure tree canopy is maintained on the site.

One submission was received, and the issues raised have been considered and addressed in this report and in the Recommendation.

The application has been assessed against the relevant matters for consideration under section 4.15(1) of the Act. It is recommended for approval subject to conditions of consent.

1.2. Site and Surrounding Locality

A site visit was carried out on 4 April 2023.

The site is identified as Lot 22 in DP 18413, known as 134 Hewlett Street, Bronte. The site is rectangular in shape with a slight irregular angle in the south-western front boundary to Hewlett Street, measuring 2.085m. The remaining front boundary measures 12.99m. It has an area of 401.7m² and falls from the north-eastern rear boundary to the south-western frontage by approximately 11m.

The site is occupied by a stepped two storey dwelling house, comprising a garage level with vehicular access provided from Hewlett Street, as well as ground, first and second floor levels.

The site is adjoined by a three storey dwelling to the east and a residential flat building (RFB) to the west of the site. The locality is characterised by a variety of low and medium density residential developments.

Figures 1 to **6** are photos of the site and its context.



Figure 1: Subject site frontage, facing north



Figure 2: Neighbouring RFB to the west at No. 132 Hewlett Street, facing north



Figure 3: Neighbouring RFB to the west at No. 132 Hewlett Street, facing west



Figure 4: Neighbouring dwelling to the east at No. 136 Hewlett Street, facing north-east



Figure 5: RFB opposite the site at No. 99 Hewlett Street, facing south-east



Figure 6: Dwelling opposite the site at No. 97 Hewlett Street, facing south

1.3. Relevant Development History

A search of Council's records revealed the following recent (last ten years) and relevant development history of the site:

 DA-48/2021 - Alterations and additions to the dwelling house, including a rear third floor addition and third level balcony fronting Hewlett Street, was refused by Council on 8 July 2021 and subsequently approved by the Land and Environment Court (LEC) on 4 February 2022. These works are yet to commence.

1.4. Proposal

The development application seeks consent for demolition of the existing dwelling and construction of a new part-two, part-three storey dwelling house, specifically the following:

- Garage level:
 - Car parking for two vehicles;

- Bin storage;
- Mechanical services room;
- Storage room;
- Internal circulation stairs and lift;
- New entrance portico and stairs along western side of dwelling;
- Lower ground floor level:
 - Rumpus room;
 - Study;
 - Laundry;
 - Front terrace;
 - Internal stairs and lift;
 - External stairs along western side setback from garage level to dwelling entrance;
- Ground floor level:
 - Three bedrooms (one with walk-in-robe and ensuite);
 - Bathroom;
 - Internal stairs and lift;
 - Front terrace;
 - Pool mechanical plant room;
- First floor level:
 - Open plan living and dining;
 - Kitchen area and butlers pantry;
 - Powder room;
 - Front terrace;
 - Internal stairs and lift.

1.5. Background

The development application was lodged on 1 February 2023 and deferred on 5 April 2023 for the following reasons (summarised):

1. Calculation of gross floor area (GFA) / floor space ratio (FSR) and proposed excavation area

Part of the sub-floor level is not less than 1m above the existing ground level and therefore does not meet the definition of a basement.

The proposal includes extensive excavation that exceeds the maximum area permitted under the Waverley DCP 2022.

It is recommended that the plans are amended as follows:

- a) Include the area of sub-floor storage in the calculation of GFA, that does not meet the definition of a basement.
- b) Reduce the extent of excavation and rationalise the area identified for mechanical/plant at the garage level.

c) Review the GFA /FSR across each floor level and recalculate the floor space to ensure calculations are accurate.

2. Height and view impacts

The SEE and Clause 4.6 Written Request refer to adjoining properties to the north and west of the site, at No 132 Hewlett Street and No. 2 Andrew Street. Both properties have approved developments that are not represented on the proposed plans or included in the assessment.

It is recommended that the following amendments are made:

- a) Update the plans to show the approved developments at No. 132 Hewlett Street and No. 2 Andrew Street. Consider the potential for view impacts from both properties and the approved developments on these sites. Update the Clause 4.6 Written Request and SEE accordingly.
- b) Include the RL of the lift overrun, skylight and PV solar panels on the section plans and update the view angles and the assessment to take account of these elements.
- c) Lower floor to ceiling heights of the garage level, which currently exceed the minimum requirement of 2.2m, with the view of lowering the overall development and minimising view impacts from the rear.
- d) Provide a separate plan/s with the extent of the previous approved development on the site. The current plan set is confusing with the number of annotations to the previous approval.

3. Shadow diagrams

...the diagrams demonstrate that the proposed development will give rise to additional shadowing in the front setback of No. 95 Hewlett Street in the morning and on the side elevation of No. 136 Hewlett Street at midday on 21 June. Given the exceedance to the height of building development standard, no additional shadowing of neighbouring properties will be accepted.

It is recommended that the following amendments are made:

- a) Amend the proposal to remove shadowing on neighbouring properties.
- b) Amend the shadow diagrams to include existing and proposed shadowing only.
- c) Hourly shadow diagrams are to be provided.

4. Landscape plans and swimming pool detail

It is recommended that the following amendments are made:

- a) A minimum of 50% of proposed trees, 50% of proposed shrubs and 50% of proposed grasses and groundcovers (not including turfed areas) are to be native plants, as listed in Annexure B3-1. The landscape plan is to include a planting schedule that lists all plant species proposed, the number of plants of each species proposed, and indicate whether each plant species proposed is listed in Annexure B3-1.
- b) Three strata of vegetation are required to be included in landscape design (i) tree or tall shrub canopy, (ii) mid-storey and (ii) groundcover layer.
- c) Provide further details for the proposed swimming pool on section plans.

Amended plans were received on 3 May 2023 however a number of issues remained unresolved, and a second deferral letter was sent to the applicant on 24 May 2023, for the following reasons (summarised):

1. Height and FSR development standards and view loss

Council remains concerned with the height of the proposed development, particularly at its frontage where it is likely that the height exceedance will result in view loss from the eastern side elevation windows of No. 132 Hewlett Street, as shown on the Section A2 (DA301).

It is recommended that the following amendments /additional information are provided;

- a) Increase the front setback to align more closely with the existing front building alignment.
- b) Reduce the height at the frontage and the bulk and scale of the balcony parapets. These elements are attributable to the likely view impacts to the east. Consider amending the materiality of parapets and privacy screening to enable views to the east to be maintained from No. 132 Hewlett Street.
- c) Consider further reductions to the generous floor ceiling heights throughout the development.
- d) As noted in Council's previous deferral letter (5 April 2023), no additional shadowing will be accepted. An increase in the front setback may alleviate the additional shadowing to the east elevation of No. 132 Hewlett Street, resulting from the height non-compliance.
- e) Review the calculation of gross floor area (GFA) across each of the floors. The calculations provided in the Compliance Table (DA500) differ slightly from Council's calculations of GFA.
- f) Provide further view loss analysis of the affected views from No. 132 Hewlett Street, in accordance with the Tenacity principles.

2. Excavation and plant

The site is permitted a maximum excavated area volume of 130m³ under Part B13 of the Waverley DCP 2022. While the amended plans provide a reduction across the site, the overall extent of excavation is still considered excessive.

It is recommended that the following amendments /additional information are provided;

- a) Reduce the extent of excavation to more closely align with the Waverley DCP 2022, Part B13. Rationalise the space identified for mechanical plant and services and include the approximate location and size of plant room equipment on the plans.
- b) Given the extent of excavation across the site, a Geotechnical Engineering Report is required to be prepared and provided to Council. Please also include an excavation calculation plan demonstrating the extent of excavation.

3. Biodiversity

The property lies within a recognised biodiversity habitat corridor. The relevant controls for biodiversity habitat corridors are provided in Part B3, Section 3.3.2 Habitat Corridors & Recognised Habitat...

The amended landscape plans received by Council on 4 May 2023 do not comply with the relevant controls, as the planting schedule identifies cultivars and hybrids as being listed in Annexure B3-1, which is incorrect. Accordingly, the Tree and Shrubs categories on the planting schedule contain 0% plants listed in Annexure B3-1.

Further amended plans, seeking to address the above matters were received by Council on 14 June 2023. On 4 July 2023, the applicant was advised that the amended plans did not fully address the matters raised in Council's second deferral letter and therefore the amended plans would not be accepted, noting the following residual issues:

- a) A View Impact Analysis (VIA) has not been provided for the neighbouring RFB at No. 132 Hewlett Street, as requested. It is likely that the proposal will impact on views from the approved attic/dormer windows/balcony and therefore without a VIA considering the views currently obtainable from No. 132 Hewlett Street, it is not clear whether the proposal meets objective (a) of Clause 4.3 and therefore a Clause 4.6 Variation cannot be supported.
- b) The design amendments and further reduction to height are noted however amendment to these elements alone is not sufficient in managing potential view loss to the east.
- c) The mechanical/services space is still excessive at garage level.
- d) No geotechnical engineering report has been provided to date. This is a minimum requirement for a development proposing this level of excavation.
- e) The landscape plan is still not compliant with the relevant control for habitat corridors. The requirement is that a minimum of 50% of the proposed trees, 50% of the proposed shrubs and 50% of the proposed grasses and groundcovers listed in Annexure B3-1 are to be locally indigenous, not 50% overall.
- f) The amended application did not include an updated SEE or Clause 4.6 Variation as requested in the deferral letter and required for further assessment of the application.

On 5 July 2023, the applicant advised that it would submit the necessary documentation to satisfy Council's residual concerns, as listed above.

On 11 August 2023, the applicant provided the following additional information to satisfy the request:

- Amended Architectural Plans;
- Amended Landscape Plan;
- Schematic services Plan;
- Services spatial compliance statement;
- Amended shadow diagrams;
- View Impact Assessment; and
- Amended Clause 4.6 Written Request.

The amended plans received on 11 August 2023 were accepted and form the basis of the assessment.

2. ASSESSMENT

The following matters are to be considered in the assessment of this development application under section 4.15 of the *Environmental Planning and Assessment Act 1979* (the Act).

2.1. Planning Instruments and Development Control Plans

The following is an assessment against relevant legislation, environmental planning instruments, including State Environmental Planning Policies (SEPPs), and development control plans.

2.1.1. State Environmental Planning Policies (SEPPs)

The following SEPPs apply from the 1st March 2022 and have been considered acceptable in the assessment of this development application:

- SEPP (Building Sustainability Index BASIX) 2004
- SEPP (Biodiversity and Conservation) 2021
- SEPP (Resilience and Hazards) 2021.

A detailed discussion is provided for SEPP (Resilience and Hazards) as follows:

SEPP (Resilience and Hazards) 2021

The subject site has historically been used for residential purposes and there is no known history of contamination on the site. Accordingly, site land contamination is considered unlikely, and no further investigation is necessary.

A small portion of the site's frontage falls within the coastal use area. Clause 2.11(1) states that development consent must not be granted for development on land within the coastal use area unless the consent authority;

(a) has considered whether the proposed development is likely to cause an adverse impact on the following:

Ma	atters for consideration	Compliance
(i)	existing, safe access to and along the foreshore, beach, headland or rock platform for members of the public, including persons with a disability,	No public access ways would be affected by the proposal.

Matters for consideration	Compliance
(ii) overshadowing, wind funnelling and the loss of views from public places to foreshores,	The dwelling is orientated south to north with the public foreshore located to the south and east of the site. The proposal would not give rise to overshadowing, wind funnelling or the loss of views from public places to the foreshore.
(iii) the visual amenity and scenic qualities of the coast, including coastal headlands,	The visual amenity from the coastal use area would not be affected as a result of the proposal.
(iv) Aboriginal cultural heritage, practices and places,	N/A
(v) cultural and built environment heritage, and	N/A

(b) is satisfied that:

Matters for consideration	Compliance
(i) the development is designed, sited and will be managed to avoid an adverse impact referred to in paragraph (a), or	Given that only a small portion of the site is within the coastal use area, approval of the development would not result in adverse impacts to the coastal use area.

(c) has taken into account the surrounding coastal and built environment, and the bulk, scale and size of the proposed development.

The proposal would not have a direct impact on the surrounding coastal area. The built form of the proposed development is consistent in bulk, scale, and size with neighbouring dwellings to the east, a number of which fall wholly within the coastal use area.

2.1.2. Waverley Local Environmental Plan 2012 (Waverley LEP 2012)

The relevant matters to be considered under the Waverley LEP 2012 for the proposed development are outlined below:

Table 1: Waverley LEP 2012 Compliance Table

Provision	Compliance	Comment		
Part 1 Preliminary				
1.2 Aims of plan	Yes	The proposal is not inconsistent with the aims		
	162	of the Waverley LEP 2012.		

Part 2 Permitted or prohibited de	velopment	
Land Use Table R2 Low Density Residential Zone	Yes	The proposal is defined as a 'dwelling house', which is permitted with consent in the R2 zone.
Part 4 Principal development star	ndards	
4.3 Height of buildings● 8.5m	No	The proposal has a maximum height of 13.55m (RL 50.600) owing to the lift overrun and PV panels. The parapet of the dwelling has a maximum height of 13.25m (RL50.300) measured at the site's frontage. The proposal exceeds the height of buildings development standard by 5.05m.
 4.4 Floor space ratio and 4.4A Exceptions to floor space ratio 0.66313:1 (266.37m²) 	Yes	The proposal has a total GFA of 266.3m ² and an FSR of 0.6629:1.
4.6 Exception to development standards	See discussion	The application is accompanied by a written request pursuant to clause 4.6 of Waverley LEP 2012 to vary the height of buildings development standard. A detailed discussion of the variation to the development standard is presented below this table.
Part 5 Miscellaneous provisions		
5.10 Heritage conservation	Yes	The site adjoins the Hewlett Street Landscape Conservation Area (C47), applicable to the Hewlett Street road reserve. The development is set back from the road reserve and is in keeping with the built form and scale of neighbouring dwellings. The proposal is not likely to impact on the landscape conservation area.
Part 6 Additional local provisions		
6.1 Acid sulfate soils	Yes	The site is within a Class 5 acid sulfate area, however it is not within 500m of a Class 1,2,3 or 4 acid sulfate class. Conditions of consent are recommended to manage disturbance during excavation.
6.2 Earthworks	Yes	The proposal includes excavation to accommodate the garage level and under croft at the ground floor level. A Geotechnical Report was submitted with the application and recommendations are to be implemented in full, including the requirement for additional investigations prior to works commencing.

The following is a detailed discussion of the issues identified in the compliance table above in relation to the Waverley LEP 2012.

Clause 4.6 Exceptions to Development Standards - Height

The application seeks to vary the height of buildings development standard in clause 4.3 under Waverley LEP 2012.

The site is subject to a maximum height of building development standard of 8.5m. The proposed development has a height of 13.55m, exceeding the standard by 5.05m equating to a 59% variation.

A written request has been submitted to Council in accordance with clause 4.6(3)(a) and (b) of Waverley LEP 2012 seeking to justify the contravention of the development standard by demonstrating:

- (a) That compliance with the development standard is unreasonable or unnecessary in the circumstances of the case; and
- (b) That there are sufficient environmental planning grounds to justify contravening the standard.

A copy of the applicant's written request has been provided to the Waverley Local Planning Panel for consideration.

Applicant's Written Request - Clause 4.6(3)(a) and (b)

The applicant seeks to justify the contravention of the height of buildings development standard on the following basis:

- (a) That compliance with the development standard is unreasonable or unnecessary in the circumstances of the case:
 - (i) The proposed development is consistent with the objectives of the height development standard.
 - (ii) Despite the proposed development's non-compliance with the height standard, the proposal is consistent with the desired future character of the area. The proposal provides a height, bulk and scale that is generally consistent with that envisaged by Council's controls.
 - (iii) Strict compliance with the development standard on the steeply sloping site would effectively inhibit any FSR compliant built form with a first floor level. The proposed extent of the height variation will occur at the frontage of the ground and first floor levels of the building and result in a well articulated three storey built form above a garage level to Hewlett Street.
 - (iv) The proposal has been designed with a priority to preserve the amenity of neighbouring properties and to ensure the building height above the development standard maintains views, privacy, solar access and compatibility with the streetscape character of the locality.

- (b) That there are sufficient environmental planning grounds to justify contravening the standard:
 - (i) There are sufficient environmental planning grounds to justify the building height noncompliance, in particular given the existing dwelling exceeds the development standard, as well as the previously approved built form on site.
 - (ii) The environmental planning grounds which justify the height breach in the circumstances of this particular case include the sloping topography, compatibility with the desired future character of the area, the existing built form on site, orderly and economic development of the land, and the better planning outcome the proposed height variation offers for the site and surrounding development:
 - a. <u>Topography</u>: The site is characterised by a steep topography resulting in a fall of 9.78m from the rear boundary down to the street frontage...this challenging topography requires a stepped built form...While the proposal provides a stepped built form...portions of the ground and first floor levels at the street frontage exceed the development standard due to the existing garage level..(see **Figure 7** below).
 - b. <u>Compatibility with Desired Future Character</u>: The proposal achieves consistency with the character of the locality and is of a height and scale similar to both existing and emerging developments in the area which is recognised as an environmental planning ground in Initial Action v Woollahra Municipal Council [2019] NSWLEC 1097 [47].
 - c. Existing built form on the site: The existing dwelling on the subject site has a maximum height of 11.82m (RL 51.20 AHD) which exceeds the LEP height limit by 3.32m, being a 39% variation to the development standard...The proposal results in a reduced number of storeys and a reduced maximum roof ridge height when compared to the existing built form and previous LEC approval for the site, and will result in a better planning outcome when compared to the previous approval.
 - d. <u>Orderly and Economic Development of Land</u>: The proposal maintains the sites single dwelling use, with a new contemporary dwelling house which will enhance the overall amenity and functionality of the site for future occupants, whilst ensuring compliance with the FSR development standard...
 - e. <u>Better Planning Outcome</u>: The proposal provides a better planning outcome for the site, future occupants of the site and the neighbourhood through an enhanced design and streetscape appearance, enhanced amenity for future occupants and neighbouring development and most importantly a reduced roof ridge height when compared to the previous approval...proposal has been skilfully designed with a priority to maintain view corridors from No. 2 Andrew Street which would not be available under the previously approved development.

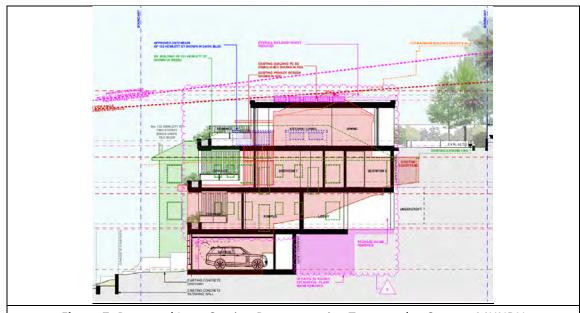


Figure 7: Proposed Long Section Demonstrating Topography, Source: MHNDU







Figure 9: Proposal (prior to first floor balcony amendment)

Consideration of Applicant's Written Request - Clause 4.6(4) (a) (i) and (ii)

Development consent must not be granted unless the consent authority is satisfied that:

- (a) The applicant's written request has adequately addressed the matters required to be demonstrated by subclause 3 of clause 4.6 being that compliance with the development standard is unreasonable or unnecessary in the circumstances of the case, and that there are sufficient environmental planning grounds to justify contravening the standard; and
- (b) The proposed development will be in the public interest because it is consistent with the objectives of the particular development standard and the objectives for development within the zone in which the development is proposed to be carried out.

Does the written request adequately address those issues at clause 4.6(3)(a)?

It is considered that the applicant has adequately addressed that compliance with the standard is unreasonable or unnecessary in the circumstances of the case and has referenced one or more of the following justifications as set out in *Wehbe v Pittwater Council* (2007) 156 LGERA 446:

- (a) the objectives of the development standard are achieved notwithstanding non-compliance with the standard;
- (b) to establish that the underlying objective or purpose is not relevant to the development with the consequence that compliance is unnecessary;
- (c) to establish that the underlying objective or purpose would be defeated or thwarted if compliance was required with the consequence that compliance is unreasonable;
- (d) to establish that the development standard has been virtually abandoned or destroyed by the Council's own actions in granting consents departing from the standard and hence compliance with the standard is unnecessary and unreasonable; and
- (e) to establish that "the zoning of particular land" was "unreasonable or inappropriate" so that "a development standard appropriate for that zoning was also unreasonable or unnecessary as it applied to that land" and that "compliance with the standard in that case would also be unreasonable or unnecessary.

The applicant specifically relies upon justification (a) outlined above to address clause 4.6(3)(a) of Waverley LEP 2012. The applicant has demonstrated that the objectives of the standard are achieved notwithstanding the non-compliance, by providing an assessment of impact on environmental amenity, including provision of a detailed view impact analysis, as well an assessment of privacy and solar access impacts.

Views

The applicant's Clause 4.6 Written Request provides an assessment of views (referred to hereafter as the VIA) in accordance with the Tenacity Planning Principle. The assessment identifies surrounding properties that currently benefit from views and those properties that would potentially be impacted as a result of the proposal, including No. 132 Hewlett Street, the immediate neighbour to the west and No. 2 Andrew Street, located to the north (rear of the site). In both cases, views obtained from these properties are side boundary views, the extent of which vary depending on the room location.

No. 2 Andrew Street

Partial obstructed views are obtained from two bedrooms within the dwelling and elevated external side balcony. The property also has approval for a new loft level, which will provide views towards Bronte Beach from the southern window and south facing balcony.

Figure 10 demonstrates the extent of view impact from the first floor level side balcony. The blue denotes the proposed massing and the yellow is the extent of a maximum compliant building envelope at the rear. The VIA notes that the removal of the existing height non-compliant pitched roof (maximum

RL 51.20 AHD) and replacement with a flat roof (maximum RL 50.45 AHD) will assist in maintaining similar horizontal views from rooms where views are obtained. In addition, the LEC approval of DA-48/2021 (see **Figure 8**), approved a second floor level at the rear with a maximum RL 52.11 AHD and therefore the proposal would result in a more favourable outcome, in terms of view loss when compared to the approved development on the subject site. **Figure 10** shows a minor view impact in the eastern section, which would also include the lift overrun, PV panels and skylight that are situated 300mm above the height plane, but 300mm lower than the existing pitched roof, as can be seen in **Figure 11**.

Views obtained from the other room in the dwelling locations yield a similar result with respect to impact, with the majority of the views being retained in some form. Views that will be obtainable from the approved loft level of the dwelling (see **Figure 11**) are unlikely to be impacted given the elevation of this part of the dwelling. Overall, the proposal is considered to have a minor impact on existing views but would enable view sharing to be maintained.



Figure 10: Views from the first floor level side balcony at No. 2 Andrew Street (proposed massing in blue, compliant envelope [at rear] in yellow), **Source**: MHNDU

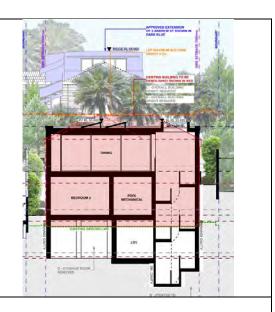


Figure 11: Section B showing location of lift overrun and PV panels, **Source**: MHNDU

No. 132 Hewlett Street

The VIA considered the viewpoints shown in **Figure 11**. The building has an approved development application (DA-205/2020) for internal alterations and additions to the building and a new attic level including side dormers (viewpoint 01) and a front balcony facing Hewlett Street accessed via the attic level (viewpoint 03). Views are currently obtained from the first floor level eastern window (viewpoint 04). Views may also be obtainable from the first floor level windows (the outline of which can be seen in the **Figure 7** above) however, the applicant's survey identifies these windows as obscured glazing and therefore views would not be possible from these windows unless they were open. The approved DA architectural plans do not show any amendments to the first floor windows and no change to the glazing of the windows, therefore these windows were excluded from the VIA. It is also noted that the views that may be impacted from these windows would be as a result of a compliant height envelope. Only impacted views are considered hereon.



Figure 12: Views considered from No. 132 Hewlett Street, Source: Urbaine Design Group

Figure 12 shows the view that would be obtainable from the approved east facing dormer (viewpoint 01). The image includes the 1.6m privacy screen that was conditioned under DA-205/2020 to manage potential overlooking and privacy concerns for the neighbouring dwelling (subject site). The location and height of the approved privacy screen would reduce the extent of eastward views that may have otherwise been obtained. The amended architectural plans include a new western side planter to the upper floor terrace, which was included to ensure any upward outlook/view from the small portion of the approved dormer window (see circle below) would be maintained. The additional western setback of the upper level terrace will also enhance privacy for both properties.



Figure 13: Views from the approved east facing dormer (viewpoint 01), height variation shown in green **Source**: Urbaine Design Group

Figure 13 shows the view from the front eastern window. The green denotes the height variation and from this living room window, views eastward would be unimpacted. Similarly, **Figure 14** shows the view that will be obtainable from the DA approved front facing balcony. While the height variation would impede views marginally, the figures demonstrate that the proposed development would enable view

sharing to be maintained and the predominant views received from No. 132 Hewlett Street would be maintained under the proposal.



Figure 14: Views from first floor eastern window (viewpoint 04), height variation in green

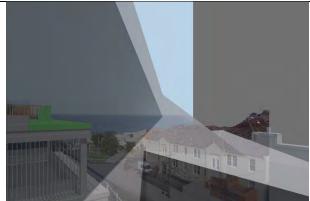


Figure 15: Views from DA approved front balcony (viewpoint 03), height variation in green

Source: Urbaine Design Group

Importantly, the primary views obtained towards the street frontage, habitable room and the balcony will be maintained irrespective of the height breach. Figures 12-14 demonstrate that the proposal maintains view sharing and while the approved dormer (viewpoint 01) would have enabled eastward views to be obtained, the approved privacy screen (see Figure 12) will reduce the extent of this view. The amendments to the first floor level balcony and planter will assist in maintaining any upward outlook or horizon view that is not screened. View impacts are therefore acceptable and view sharing would be maintained.

Privacy

The applicant's Clause 4.6 Written Request considers potential privacy impacts insofar as they relate to the height variation, noting that privacy is likely to be preserved as the extent of height variation is limited to the frontage and the proposed street facing balconies.

The applicant notes that the street frontage windows are unlikely to result in adverse overlooking or acoustic privacy impacts as they are orientated to the street and substantially separated from the development on the southern side of Hewlett Street.

Council notes that window openings to the side elevations are minimal, with openings provided on the eastern elevation at ground and first floor levels adjacent to the stair landing. However, these windows do not directly face window openings on the neighbouring dwelling at No. 136 Hewlett Street. The front facing balconies, of which the first floor level encompasses the height con-compliance, are fitted with privacy screening on the eastern and western sides of the balconies. The screening would manage potential privacy concerns and in particular the increased western side setback would further mitigate any potential privacy concerns for the neighbouring RFB at No. 132 Hewlett Street and the subject site. The main opportunity for overlooking would be facing south however, given the elevation of the dwelling above the street level and the separation distance of the dwelling to the properties on the southern side

of Hewlett Street, privacy impacts are considered negligible. Accordingly, Council is of the view that the environmental amenity of neighbouring properties, with respect to privacy has been satisfactorily preserved.

Solar Access

The applicant's Clause 4.6 Written Request states that although the proposal partially exceeds the building height development standard, the variation does not result in any additional shadowing to neighbouring windows or private open space when compared to the existing shadowing or the previous approval.

The proposed height non-compliance will result in a minor shadow being cast to the garage roof and front setback of No. 95 Hewlett Street and to the roof of No. 132 Hewlett Street at 9:00am. The applicant notes that additional shadow is offset by a reduction of shadow when compared to the approved development on the site, with the attic windows to No. 132 Hewlett Street receiving increased sunlight compared to the previous approval on the site.

At 10:00am the proposal will shadow four windows on the eastern elevation to No. 132 Hewlett Street. The southern most window on the eastern elevation, is already shadowed by the roof eaves above, with a very small amount of solar gain when compared to the current approved DA on the subject site (see **Figure 15**).

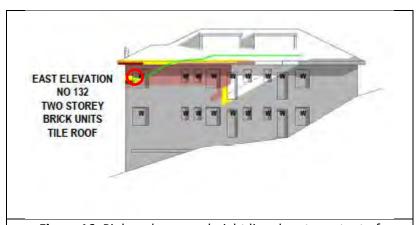


Figure 16: Pink under green height line denotes extent of shadowing from compliant building height envelope. The area of minor solar gain is circled, **Source**: Cad Draft P/L

From 11:00am shadowing shifts to the Hewlett Street frontage and from midday to 3:00pm shadowing to the western elevation of No. 136 Hewlett Street would be mostly as a result of a compliant height envelope. Any shadowing cast to the western elevation of No. 136 Hewlett Street would not impact habitable windows or areas of private open space, with some reduction in shadowing across the diagrams as a result of the flat roof form and lowered height plane across the site when compared to the approval under DA-48/2021.

Council is satisfied that shadowing to the eastern elevation, at 10:00am is as a result of a compliant building height envelope, with a small amount of solar gain to the top of the southernmost window on the eastern elevation. At 9:00am the eastern elevation of No. 132 Hewlett Street is already in shadow. Accordingly, the extent of impact is minor, is as a result of a compliant building height and would not unreasonably impact on the environmental amenity of the neighbouring property.

Does the written request adequately address those issues at clause 4.6(3)(b)?

As set out above, the applicant has adequately addressed and demonstrated that there are sufficient environmental planning grounds to justify contravening the development standard, with consideration to the topography of the site, compatibility with the desired future character and consideration of the existing built form on the site. The applicant also provided a number of recent examples within the vicinity of the site with similar built form and height non-compliances, noting that the proposal would not be dissimilar to a number of developments in the area.

The applicant has demonstrated that the proposal would provide for a better planning outcome for the site, future occupants of the site and the neighbourhood through an enhanced design and streetscape appearance, noting that enforcing strict compliance would result in a streetscape presentation that is inconsistent with the existing and emerging character of Hewlett Street, reducing the potential for increased building height and compliant floor space on the subject site.

For the reasons set out above, Council is satisfied that the applicant has demonstrated sufficient environmental planning grounds to justify contravention of the standard.

Is the development in the public interest?

.....

The proposed development will be in the public interest because it is consistent with both the objectives of the particular development standard and the objectives for development within the zone in which the development is proposed to be carried out.

The relevant objectives of the height of buildings development standard are as follows:

- (a) to ensure building heights preserve the environmental amenity of neighbouring properties and public spaces and, if appropriate, the sharing of views,
- (c) to maintain satisfactory solar access to existing buildings and public areas,
- (d) to establish building heights that are consistent with the desired future character of the locality.

As set out above, despite the height non-compliance, the proposal would preserve the environmental amenity of neighbouring properties, by enabling view sharing to be maintained and for solar access to existing neighbouring buildings to be maintained. The subject site and surrounding area is characterised by detached dwellings and RFB development of various architectural styles from various eras. The non-

compliant building height of part of the ground and first floor levels at the site's frontage would be compatible with the height, scale, and form of development to the east of the subject site. The proposal is therefore considered to be consistent with the desired future character of the locality.

The relevant objectives of the R2 zone are as follows:

- To provide for the housing needs of the community within a low density residential environment.
- To maximise public transport patronage and encourage walking and cycling.
- To ensure dwelling character, landscape character, neighbourhood character, streetscapes and amenity are maintained or enhanced over time.
- To encourage the supply of housing that meets the needs of the population, particularly housing for older people and people with a disability.
- To promote development that incorporates planning and design measures that reduce the urban heat island effect.
- To improve the urban tree canopy by providing high levels of deep soil planting and additional landscaping.

The proposal would continue to provide for the housing needs of the community and occupants of the site and is well located with respect to public transport, footpaths and cycling paths. The proposal is architecturally designed and would contribute positively to the existing and future character of the neighbourhood and streetscape. The application was accompanied by a BASIX Certificiate and the plans include the commitments to ensure full compliance with the identified measures. The proposal would achieve good cross ventilation and incorporates passive design. The application includes increased landscaped area, a number of mature trees will be retained and any identified for removal are to be replaced as part of the landscaping works on the site.

The proposal is considered to provide a more cohesive design response for this site when compared to similar developments in the vicinity and in comparison to the LEC approved development, and notwithstanding the height non-compliance, is considered to be a better planning outcome for the site.

Conclusion

For the reasons provided above the requested variation to the height of building development standard is supported as the applicant's written request has adequately addressed the matters required to be addressed by clause 4.6 of the Waverley LEP 2012 and the proposed development would be in the public interest because it is consistent with the objectives of the height of buildings development standard and the R2 zone.

2.1.3. Waverley Development Control Plan 2022 (Waverley DCP 2022)

The relevant matters to be considered under the Waverley DCP 2022 for the proposed development are outlined below:

Table 2: Waverley DCP 2022 – Part B General Provisions Compliance Table

Development Control	Compliance	Comment
1. Waste	Yes	Satisfactory.
		A BASIX and NatHERS Certificate were submitted with the application, setting out energy efficiency and water conservation targets as required under the SEPP.
2. Ecologically Sustainable Development	Yes	The proposal incorporates passive design, providing openings to all facades with good cross ventilation and solar penetration.
		An advisory note is included in the recommendation stating that gas should not be used for all cooktops, ovens and heating and to provide ceiling or wall mounted fans in all habitable rooms.
3. Landscaping, Biodiversity and Vegetation Preservation	No (acceptable by condition)	The site is within an identified habitat corridor, which requires a minimum of 50% of proposed trees, shrubs, and grasses/groundcovers to be native plants listed in Annexure B3-1. Council's Biodiversity Officer reviewed the Landscape Plan submitted with the application and requested amendments to comply with this requirement. After several iterations, the landscape plan still does not comply with the control, therefore a condition of consent is recommended to require the landscape plan to be amended to comply with the control. The proposal includes the removal and retention of several trees on the site. Council's Tree Management Officer reviewed the proposal and noted support to remove the identified trees subject to trees being replaced. The street tree (Ficus rubiginosa) growing out from the sandstone shelf in front of the subject site must be retained and protected during construction. Conditions of consent are recommended and a tree bond payable for the protection of the street tree during construction is required.

Development Control	Compliance	Comment
5.Water Management	Yes	Satisfactory. Refer to section 3 of this report on referral commentary in relation to stormwater.
7. Transport 7.1 Streetscape	Yes	The proposal seeks to maintain the garage in the existing location, which is appropriate. The garage would present to the streetscape as the existing garage does.
7.2 On-Site Parking	Yes	The parking spaces comply with the minimum dimension requirements and the Australian Standards.
7.2.1 Vehicle Access	Yes	The driveway crossover is acceptable.
7.2.2 Parking Rates	Yes	The development provides two off-street parking spaces which complies with the development standard.
11. Design Excellence	Yes	The proposal has been designed to a high architectural standard and is in keeping with the bulk and massing of neighbouring dwellings to the east. The proposal is considered to achieve design excellence.
13. Excavation	No (acceptable on merit)	The site is subject to a maximum excavation volume of 130.34m³. The application proposes 455m³ of excavation, which has been reduced from the original application through design development. See below Table 3 for further discussion.

Table 31: Waverley DCP 2022 – Part C1 Low Density Residential Development Compliance Table

Development Control	Compliance	Comment	
1.0 General Objectives			
	Yes	The proposal does not contravene the general objectives of this part of the DCP.	
1.1 Height			
 Flat roof dwelling house Maximum wall height of 7.5m Buildings on steep sites to be stepped down to avoid high columns, elevated platforms and large under croft areas 	No	The proposal has a non-compliant wall height up to 13.25m. See below the table for further discussion.	
1.2 Setbacks			
1.2.1 Front and rear building lines	Yes	The subject site is situated behind the front building line of the neighbouring RFB to the west. The front building lines of the sites to the east are	

Development Control	Compliance	Comment
 Predominant front building line (adjacent three neighbours on either side) Predominant rear building line at each floor level (adjacent three neighbours or either side) 	Yes	slightly varied due to a curve in the road in the approach to the Mirimar Avenue and Hewlett Street intersection. The same applies at the rear. The subject site aligns with the rear building line of the RFB to the west. The proposal is appropriately sited at the rear. The sites to the east comprise irregular rear boundaries of which the buildings lines vary. The proposal is not inconsistent with the predominant front and rear building lines at all levels.
 1.2.2 Side setbacks Minimum 1.5m for second floor, noting that where a brand new three storey structure is proposed, all floors must be setback by 1.5m. Third floor assessed on merit. 	Yes	The proposal provides a 1.5m eastern and western side setback.
1.3 Streetscape and visual imp	pact	
 New development to be compatible with streetscape context Significant landscaping to be maintained. 	Yes	The proposal is compatible with the built form and scale of surrounding development. The front street tree is to be retained and several trees to the rear of the site are to be retained.
1.4 Fences	<u> </u>	
Front: Maximum height of 1.2m Solid section no more than 0.6m in height Side and Rear: Maximum height of 1.8m	No (acceptable on merit) Yes	The proposal includes a front boundary wall that aligns with the garage entry, consistent with the existing site features. Given the sloping site, the existing frontage and the predominance of garage entries along this section of Hewlett Street, the variation to the fence control is appropriate in this instance. The side and rear boundary fences and retaining
		walls will be built to replace existing fence levels as noted on the plans.
1.5 Visual and acoustic privace		
Habitable windows are not to directly face habitable windows or open space of neighbouring dwellings unless direct views are screened or other appropriate measures	Yes	The proposal includes two window openings at ground and first floor levels on the eastern elevation and minimal openings on the western elevation, each being screened to manage potential privacy concerns. The neighbouring dwelling to the east does not contain west facing windows that would be impacted by the proposal. The proposed screening of the western

Development Control	Compliance	Comment
are incorporated into the design • Maximum size of balconies: 10m² in area 1.5m deep	No	elevation windows would obscure views for the neighbouring RFB and mitigate potential privacy concerns for both properties. A detailed discussion of potential privacy impacts resulting from the front facing balconies and windows is provided in section 2.1.2. The proposal includes balconies at each level, all of which exceed the 10m² and 1.5m width control. See below the table for further discussion.
1.6 Solar access		
 Minimum of 3 hours of sunlight to 50% of living areas and principal open space areas on 21 June to subject site Minimum of 3 hours of 	Yes Yes	The shadow diagrams submitted with the application demonstrate that the rear yard of the site is mostly in shadow as a result of the existing surrounding development to the rear. Given the sites north-south orientation, the proposal would not alter the provision of solar access at the rear.
sunlight maintained to at least 50% of principal open space areas of adjoining properties on 21 June.	Voc	The proposal would not reduce sunlight access to the principal open spaces of any adjoining properties on 21 June.
 Avoid unreasonably overshadowing of solar collectors (including habitable windows). 	Yes	In addition, the proposal would give rise to additional shadowing of the eastern elevation of No. 132 Hewlett Street at 10am and to a small section of window on the western elevation of No. 136 Hewlett Street at midday. For the remainder of the day, shadows would be cast on blank walls and the street frontage.
1.7 Views		
 Views from the public domain are to be maintained Development to be designed and sited so as to enable a sharing of views with surrounding dwellings particularly from habitable rooms and decks. 	Yes Yes	A detailed analysis of view impacts is provided in section 2.1.2. As set out above, the proposal and potential impacts to views has been assessed against the Tenacity principles, which concluded that the proposal would enable the sharing of views from surrounding properties and is therefore appropriate.
1.8 Car parking		
 1.8.1 Design Approach Parking only allowed where site conditions permit 	Yes	The proposal maintains the location of the existing garage, providing an increased area for the garage and other associated uses.
Designed to complement the building and streetscape	Yes	The design and location is consistent with the existing garage and its presentation to the streetscape. The properties located on the upper

Development Control		Compliance	Comment
•	Car parking structures to	As existing	level of Hewlett Street are characterised by
	be behind the front		garages at the lower level, with the dwellings
	building line		above.
•	Driveways are to be	As existing	There is no change to the driveway on the site. The driveway crossover is acceptable.
	located to minimise the loss of on street parking.		
	1.8.2 Parking rates	Yes	The development provides two off-street parking spaces which complies with the development control.
	1.8.3 Location	N/A	The proposal does not seek to change the
•	Parking to be behind		location of car parking.
	front building line for new dwellings		
•	Existing development to		
	be in accordance with the		
	hierarchy of preferred car		
	parking locations		
	1.8.4 Design	Yes	The design of the garage and door detailing is
•	Complement the style,		consistent with the existing site conditions.
	massing and detail of the dwelling		Alongside the garage door comprises louvred
	Secondary in area and		screening to allow ventilation into the
	appearance to the design		mechanical services plant area. The screen is
	of the residences		consistent in appearance with the garage door
•	No part of the façade is		and is appropriate.
	to be demolished to		
	accommodate car		The side entry gate is open so the entry passage
	parking		can be seen from the sites frontage.
•	Gates to have an open design		
	1.8.5 Dimensions	Yes	The proposal complies with the minimum
•	5.4m x 2.4m per vehicle		dimensions.
	1.8.6 Driveways	Yes	The driveway is as per the existing driveway and
•	Maximum of one per		crossover and complies with the maximum width.
	property Maximum width of 2m at		
•	Maximum width of 3m at the gutter (excluding		
	splay)		
1.9	9 Landscaping and open spa	ce	
•	Overall open space: 40%	Yes	The proposal provides approximately 122m² of
	of site area (160.68m²)		open space in the rear yard. The front facing
•	Overall landscaped area:	Yes	balconies provide additional open space that
	20% of site area, with at		extends out from the internal living spaces,
	least half deep soil		equating to more than 160m ² of open space across the site. The calculation includes the
	(80.34m²) Minimum area of 25m²	Yes	whole of the rear yard but excludes the front
	for private open space		setback that is used primarily for vehicular access
	j	Yes	and is not considered usable open space.

Develo	pment Control	Compliance	Comment
fro are		Existing non- compliance	The site comprises approximately 101m² of landscaped area, which is also deep soil.
509 pro • Ou	ont landscaped area: % of front open space ovided tdoor clothes drying ea to be provided	Yes	The whole of the front setback is open space but is predominantly utilised as a driveway and vehicular access point. The front setback does not currently comprise landscaping and this is not proposed to change under the proposal.
			The site comprises ample space to accommodate a clothes drying area.
1.10 Sv	wimming pools and spa	pools	
	cated in the rear of operty	Yes	The swimming pool is located along the north- eastern side of the rear yard. The pool is set in
boi	ol decks on side undaries must consider ual privacy	Yes	from the side and rear boundaries and includes landscaping around the eastern and northern perimeters.
• All	pool equipment to be	Yes	
acc	closed within an oustically treated closure		The pool equipment is located internally to the rear of the ground floor level and can be accessed through service doors on the northern side of the dwelling.

The following is a detailed discussion of the issues identified in the compliance tables above in relation to the Waverley DCP 2022.

Excavation

The proposal includes excavation at the garage and lower ground levels to accommodate internal circulation, mechanical and services space, bin storage and under croft support. The site is subject to a maximum excavation volume of 130.34m³ under the Waverley DCP 2022. The original application sought an excavation volume of 534m³, which Council requested be reduced and through design development was reduced to the proposed volume of 455m³. The total volume of excavation equates to 22m³ within the garage, 273m³ of circulation space at the garage and lower ground levels and an additional 160m³ at the lower ground level.

Part B13 control (c) states that the maximum volume of excavation for a plant room is the minimum required to meet Australian Standards, accommodate typical dimensions of equipment required and associated circulation space to access the equipment. The application was accompanied by a Services Spatial Compliance Statement (SCS) and layout plans indicating the positioning and spatial requirements for the dwelling.

While the area identified for plant and services is vast, much of the services space is provided at garage level, the footprint of which is largely existing. The excavation at the garage level is not considered to add to the visual bulk and scale of the building, in accordance with Part B13 control (d). In addition, a

spilt level design configuration has been adopted to suit the sloping topography and minimise the need for further excavation, in accordance with control (k). Excavation would not occur within 900mm of the side boundaries, with the proposal providing a minimum 1.2m setback to the side boundaries at the garage and lower ground floor levels, in accordance with control (o).

A Geotechnical Report was submitted with the application, which includes design recommendations and recommends further inspections be carried out during construction to confirm the geotechnical and hydrogeological model. The report concluded that the site is 'geotechnically suitable for the proposed works and that excavation and construction may be carried out safely provided that the recommendations of this report are implemented in the works.'

Accordingly, given the footprint of the dwelling and sloping site, a degree of flexibility to the extent of excavation is considered reasonable in this instance. Conditions of consent are recommended to require the development to be undertaken in accordance with the recommendations in the Geotechnical Report.

Wall height

The proposal has a non-compliant wall height of 12.6m, measured on the western elevation from existing ground level to 600mm below the top of the parapet.

The exceedance to the wall height is somewhat unavoidable given the overall height non-compliance and flat roof form, however the development has been appropriately stepped to follow the fall of the site and to avoid large areas of under croft, in accordance with Part C1.1 Height, control (d). The area of under croft and extent of excavation has been reduced through design development and the extent of built form and development in excavation areas is not considered to add to the visual bulk and scale of the dwelling, and is therefore consistent with Part C1.1, objective (f).

The wall height and overall scale of the development relates to the topography and street character, would not unreasonably impact on views enjoyed by neighbouring properties and does not result in unreasonable overshadowing of adjoining or other nearby properties, and is therefore consistent with the Part C1.1, objectives (b), (c) and (d). In this instance, the non-compliant wall height is acceptable.

Balconies

The proposal includes balconies at each level, all of which exceed the 10m² and 1.5m width control. Part C1.5 (e) sets out the controls relating to an elevated deck or balcony and provides additional matters for consideration where a larger area is proposed:

- (i) Compliance with the building height development standard;
- (ii) Compliance with setback controls;
- (iii) Efforts to mitigate visual and acoustic privacy impacts including the use of permanent screening devices, increased setbacks, and retention of existing vegetation;

(iv) Pre-existing pattern of development in the vicinity of elevated decks and balconies; and (v) The visual impact of the elevated deck or balcony and any proposed privacy screening in terms of bulk and scale as viewed from the private open space and living areas of adjoining properties and from the street.

The first floor level balcony and part of the parapet of the ground floor level balcony fall within the non-compliant building height envelope. As set out in section 2.1.2, while the breach to the height is considered acceptable, a variation to the balcony control is not supported by a compliant building height at first floor level in this instance. The proposal complies with the 1.5m side setback control on both sides. Mitigation measures in the form of permanent privacy screening are provided on both sides of each balcony across each level and landscape planters have been incorporated in the design. The first floor level balcony has been further setback from the western boundary, providing a 7m separation distance between the balcony and the eastern elevation of No. 132 Hewlett Street.

The proposal is consistent with the pre-existing pattern of development in the vicinity, which comprises a predominance of elevated terraces and balconies that exceed the control, particularly to the east. The proposed balconies are considered to form an integral part of the architectural design of the dwelling and are not considered to add substantial visual bulk and scale to the development, compared to if the façade did not include the balconies. This is in part due to the landscape planters that border the balcony and soften the appearance from the streetscape.

In summary, the balconies are set back behind the front building line of the neighbouring RFB and would not give rise to overlooking to the east or west, given the proposed screening. In this instance, the acceptability of the larger balconies is in part due to the split level of Hewlett Street in this location, whereby opportunities for overlooking directly into a neighbouring property is less likely given the orientation of the neighbours to the east, the increased setback to the west and separation distance and elevation between the site and the southern side neighbours. The impacts of the front facing balconies would not necessarily be less if these areas were to be reduced in size and therefore the assessment finds the balconies acceptable in this instance.

2.2. Other Impacts of the Development

The proposal is considered to have no significant detrimental effect relating to environmental, social or economic impacts on the locality, subject to appropriate conditions being imposed.

2.3. Suitability of the Site for the Development

The site is considered suitable for the proposal.

2.4. Any Submissions

The application was notified for 14 days between 13 February 2023 and 3 March 2023 in accordance with the *Waverley Community Development Participation and Consultation Plan*.

Following receipt of amended plans and additional information, the application was not renotified as the amended form of the proposal represents a lesser impact than that of the original form that was publicly notified, for the following reasons:

- The overall building height has been reduced by 550mm since submission of the original application.
- Additional information was submitted to support the Clause 4.6 Written Request to vary the
 height of building development standard, including a detailed VIA and a full assessment of the
 proposal and potential impacts on views in accordance with the view sharing Tenacity planning
 principle. The VIA demonstrates that the proposal would enable view sharing from surrounding
 developments.
- Shadowing as a result of the height breach has been removed from the proposal. Amended shadow diagrams demonstrate that the shadowing resulting from the proposal is only attributed to a compliant built form and would only impact the eastern elevation of No. 132 Hewlett at 10:00am on 21 June.
- The applicant clarified GFA and FSR calculations confirming the proposal is compliant with the maximum FSR development standard.
- The extent of excavation and the amount of storage space has been reduced across the site. Further engineering details have been provided including a Services Spatial Compliance Statement and layout plan, indicating the allocation of space for services and mechanical plant.
- A Geotechnical Report has been prepared and submitted with the application. The report provides recommendations to guide slab and foundation design and concludes that the site is geotechnically suitable for the proposed works and that excavation and construction may be carried out safely provided that the recommendations of the report are implemented in full. A condition of consent is recommended to require the development to be undertaken in accordance with the recommendations of the report.
- The Landscape Plan was updated several times throughout assessment of the application however the plan is still not compliant with the relevant biodiversity habitat corridor controls. A condition of consent is recommended to require the plan be updated to comply.

One unique submission was received from No. 2 Andrew Street, Bronte (located to the rear of the site), in response to notification of the original plans submitted.

The following issues raised in the submissions have already been discussed and addressed in the body of this report and/or the recommendation:

- Remove references to previous LEC approval.
- Excavation.
- Geotechnical advice is required.
- Storage.
- The front setback /driveway is not open space.
- View impacts.
- Wall height.

- Fencing details.
- Lift overrun details.
- Balconies.

2.5. Public Interest

The proposal is considered to have no detrimental effect on the public interest, subject to appropriate conditions being imposed.

3. REFERRALS

The following internal referral comments were sought:

3.1. Traffic and Development

The application was referred to Council's Traffic Engineer. No objections were raised subject to the recommended conditions of consent being imposed.

3.2. Stormwater

The application was referred to Council's Stormwater Engineer. No objections were raised subject to the recommended conditions of consent being imposed.

3.3. Tree Management

The application was referred to Council's Tree Management Officer (TMO). The proposal includes removal of a number of trees on the site. The TMO noted that there are 'no significant specimens growing on the property at 134 Hewlett Street as most of the trees and palms are growing in recent landscaping...'.

To the Hewlett Street frontage is one (1) *Ficus rubiginosa* (Port Jackson fig) growing out from the sandstone shelf. The tree is to be retained and protected. A Tree Bond condition is recommended. The mature trees proposed to be removed on the site (Tree 1 and Tree 3) are to be replaced with an appropriate species and planted in a location that would not impact on views but would maintain the tree canopy on site when mature.

No objections were raised subject to the recommended conditions of consent being imposed.

3.4. Biodiversity

The application was referred to Council's Biodiversity Officer. The site is within a recognised biodiversity habitat corridor and is subject to Part B3.3.2 of the Waverley DCP 2022. The submitted Landscape Plans to date do not comply with the relevant requirements of the DCP. Amended plans have been requested several times, with several iterations of the plans provided to Council for further review. The latest

Landscape Plans received by Council on 11 August 2023, still do not comply with the relevant controls, with the following provided from Council's Biodiversity Officer: 'The amended landscape plans (received 11 August 2023) are almost identical to those (received 22 June 2023) and do not comply with the above controls as the proportion of shrubs and the proportion of groundcovers listed in Annexure B3-1 as proposed is below 50%. 'Grey Box' Westringia is a cultivar and is not listed in Annexure B3-1. Myoporum parvifolium is not listed in Annexure B3-1'.

A condition of consent is recommended to require the Landscape Plans to be updated to comply with the relevant controls under Part B3.3.2 of the Waverley DCP 2022.

4. CONCLUSION

The development application seeks consent for demolition of the existing dwelling and construction of a new part-two, part-three storey dwelling house, including garage, landscaping works and swimming pool at the site known as 134 Hewlett Street, Bronte.

The principal issues arising from the assessment of the application are as follows:

- Building height and view sharing;
- Excavation;
- Balconies.

The assessment finds these issues acceptable because the exceedance of the building height development standard would not unreasonably impact on the environmental amenity of neighbouring properties with respect to solar access, privacy, and the sharing of views. The applicant's Clause 4.6 written request adequately addresses the matters required to be addressed under clause 4.6 of the Waverley LEP 2012.

A Geotechnical Report was submitted, concluding that the site is suitable for the proposed works and that excavation and construction may be carried out safely provided that the recommendations of the report are implemented. A condition of consent is recommended to require the development to be undertaken in accordance with the Geotechnical Report.

The proposed balconies are not anticipated to have an unacceptable impact on visual and acoustic privacy as they have been appropriately treated with privacy screening at the sides to mitigate overlooking and are considered satisfactory in this instance.

Conditions of consent are recommended to require the landscape plan to be updated to comply with the Waverley DCP 2022 and for the mature trees proposed to be removed in the site's frontage to be replaced elsewhere on the site in an appropriate location to ensure tree canopy is maintained.

One submission was received, and the issues raised have been considered and addressed in this report and in the Recommendation.

The application has been assessed against the relevant matters for consideration under section 4.15(1) of the Act. It is recommended for approval subject to conditions of consent.

5. RECOMMENDATION TO WAVERLEY LOCAL PLANNING PANEL

That the development application be **APPROVED** by the Waverley Local Planning Panel subject to the conditions in Appendix A.

Report prepared by:	Application reviewed and agreed by:	Application reviewed and agreed by:	
H	JZancanawo	**	
Alana Jelfs	Jo Zancanaro	Angela Rossi	
Senior Development	A/Manager, Development	A/ Executive Manager,	
Assessment Planner	Assessment	Development Assessment	
Date: 24 August 2023	Date: 29 August 2023	Date: 31 August 2023	

Reason for WLPP referral:

1. Departure from any development standard in an EPI by more than 10%

OFFICE USE ONLY

Clause 4.6 register entry required	59% variation to height (Clause 4.3)		
(For the purposes of reporting to the planning portal, if the %	X Pre-existing non-compliance		
approved is different to the % proposed in the original submission, please state what the variation initially proposed	No change to overall building height		
was – Planning Portal Requirement)	No change to overall building envelope		
	Variation limited to the		
	[lift/plant/parapet/attic] only		
	X No unreasonable impacts on the		
	amenity of adjoining properties or		
	streetscape		
	X Sufficient environmental planning		
	grounds		
	X Consistent with the objectives of the		
	standard		
	[insert another reason here if		
	required]		
Determining Authority	Local Planning Panel		
(Concurrence Authority for Clause 4.6 variation)			
Affordable Rental Housing Units?	No		
*This is a planning portal reporting requirement			
Secondary Dwelling *This is a planning portal reporting requirement	No		
Boarding House *This is a planning portal reporting requirement	No		
Group Home	No		
*This is a planning portal reporting requirement			
Trial Period database entry required	No		
VPA submitted – follow up actions required	No		
Refer to compliance for investigation	No		
Commercial/liquor operational conditions	No		
Other (please specify):	N/A		

APPENDIX A - CONDITIONS OF CONSENT

A. APPROVED DEVELOPMENT

1. APPROVED PLANS AND DOCUMENTATION

The development must be in accordance with:

(a) Architectural Plans prepared by 'MHNDUnion of Project No. 18-008, including the following:

Plan Number and	Plan description	Plan Date	Date received
Revision			by Council
DA000, Rev E	Cover Page	2908.2023	30.08.2023
DA100, Rev E	Site Analysis	29.08.2023	30.08.2023
DA200, Rev E	Garage Level Plan	29.08.2023	30.08.2023
DA201, Rev E	Lower Ground Floor Plan	29.08.2023	30.08.2023
DA202, Rev E	Ground Floor Plan	29.08.2023	30.08.2023
DA203, Rev E	First Floor Plan	29.08.2023	30.08.2023
DA204, Rev E	Roof Plan	29.08.2023	30.08.2023
DA300, Rev E	Section A	29.08.2023	30.08.2023
DA301, Rev E	Section A2	29.08.2023	30.08.2023
DA302, Rev E	Section B	29.08.2023	30.08.2023
DA303, Rev E	Pool Sections	29.08.2023	30.08.2023
DA400, Rev E	South Elevation	29.08.2023	30.08.2023
DA401, Rev E	North Elevation	29.08.2023	30.08.2023
DA402, Rev E	West Elevation	29.08.2023	30.08.2023
DA403, Rev E	East Elevation	29.08.2023	30.08.2023
DA602, Rev A	External Finishes Schedule	25.11.2022	31.01.2023

- (b) BASIX and NatHERS Certificates
- (c) Approved stormwater details and documentation prepared by JHA dated August 2022 and received by Council 31.01.2023
- (d) Arborist Report prepared by Dr. Treegood [no date] and received by Council on 31.01.2023
- (e) Schedule of External Materials and Finishes received by Council 31.01.2023
- (f) The Site Waste and Recycling Management Plan (SWRMP) Part 1 received by Council on 31.01.2023
- (g) Geotechnical Investigation prepared by Morrow Geotechnics Pty Ltd dated 3 August 2023 and received by Council 11.08.2023

Except where amended by the following conditions of consent.

2. GENERAL MODIFICATIONS

The application is approved subject to the following plan amendments:

- (a) The landscape plan is to be amended to show the replanting of trees on the subject site that have a minimum species growth maturity height of 5m, to replace Trees 1 and 3. The replacement trees must be a local native species selected from the list of *canopy trees in Annexure B3-1* of the Waverley Development Control Plan 2022 and have a minimum 45 Litre pot size.
- (h) The External Finishes Schedule (DA602) is to be updated to reflect the approved architectural plans listed in Condition 1.

The amendments are to be approved by the **Manager, Development Assessment or delegate** prior to the issue of any Construction Certificate. An electronic copy of the amended plans or additional information (see website for electronic document requirements) addressing this condition, including a covering letter shall be provided to Council for review.

3. LANDSCAPE PLAN

An amended landscape plan is to be submitted to and approved by Council's Executive Manager, Environmental Sustainability (or delegate) with a plant species list having a minimum of 50% of the proposed trees, 50% of the shrubs and 50% of the grasses and groundcovers (not including turfed areas) are to be indigenous or local native plants listed in Annexure B3-1 of the Waverley Development Control Plan 2022.

4. BALCONY PLANTER DETAILS

The construction certificate landscape plans are to comply with the controls for green roofs in Part B3.2.3 of the Waverley Development Control Plan 2022 including:

- (a) Comprise plants that are suitable for the site in relation to the environmental conditions (sun, wind and views) and include indigenous or local native plants to Waverley (see Annexure B3-1).
- (b) Have a minimum soil depth of 300mm and use lightweight soil mixes that are porous, able to drain freely, and suitable for the selected plant species;
- (c) The balcony planters are to be designed to be a non-trafficable area (with no balustrades) and must be irrigated without requiring frequent maintenance access. Any access to the roof planters is to be for servicing purposes only.

A qualified landscape architect must review the design and verify that it complies with the above requirements.

5. GEOTECHNICAL INVESTIGATION

The development is to be undertaken in accordance with the recommendations in the Geotechnical Investigation prepared by Morrow Geotechnics Pty Ltd dated 3 August 2023 and received by Council 11.08.2023.

6. HEADROOM CLEARANCE

The headroom clearance on the basement entry and within the garage is to be a minimum of 2.2 metres.

7. WORK OUTSIDE PROPERTY BOUNDARY

This consent does not authorise any work outside the property boundary.

B. PRIOR TO THE ISSUE OF A CONSTRUCTION CERTIFICATE

The requirements outlined in this section are to be provided to the satisfaction of the Principal Certifying Authority in all instances, except where a condition explicitly specifies the approval of Council or a Council Officer is required.

GENERAL REQUIREMENTS

8. NO BUILDING OR DEMOLITION WORKS PRIOR TO RELEASE OF CONSTRUCTION CERTIFICATE

The building work, or demolition work, must not be commenced until:

- (a) a Construction Certificate has been obtained from Council or an Accredited Certifier in accordance with the *Environmental Planning and Assessment Act 1979*;
- (b) a Principal Certifying Authority has been appointed and Council has been notified of the appointment in accordance with the *Environmental Planning and Assessment Act 1979* and *Environmental Planning and Assessment Regulation 2021*; and
- (c) Council is given at least two days' notice in writing of the intention to commence the building works.

9. SURRENDER OF DEVELOPMENT CONSENT

Development consent DA-48/2021 is to be surrendered by the applicant, in accordance with Clause 68 of the *Environmental Planning and Assessment Regulation 2021*. The surrender is to be received by Council prior to the issue of any Construction Certificate for works associated with this development consent. The surrender of the consent takes affect when Council receives the notice.

10. HOME BUILDING ACT

The builder or person who does the residential building work shall comply with the applicable requirements of Part 6 of the *Home and Building Act 1989*. In this regard a person must not contract to do any residential building work unless a contract of insurance that complies with this Act is in force in relation to the proposed work. It is the responsibility of the builder or person who is to do the work to satisfy the Principal Certifying Authority that they have complied with the applicable requirements of Part 6, before any work commences.

CONTRIBUTIONS, FEES & BONDS

11. SECTION 7.12 CONTRIBUTION

A monetary development contribution is payable to Waverley Council pursuant to section 7.12 of the *Environmental Planning and Assessment Act 1979* and the Waverley Council Development Contributions Plan in accordance with the following:

- (a) Where the total development cost is less than \$500,000:
 - a. a **Cost Summary Report** or **Building Contract** or similar is to be submitted to Council's Customer Service Centre to process payment.
- (b) Where the total development cost is \$500,000 or more:

- a. a Detailed Cost Report prepared by a registered Quantity Surveyor, Building Contract, or similar is to be submitted to and approved by Council's Executive Manager, Urban Planning, Policy and Strategy (or delegate). Please forward documents to info@waverley.nsw.gov.au attentioned to Strategic Planning, and reference the relevant application number, address and condition number to satisfy.
- D. Upon confirmation of the contribution amount by Council's Executive Manager, Urban Planning, Policy and Strategy (or delegate), payment is to be processed via the Customer Service Centre.
- c. Should there be a discrepancy between the cost of works approved in subclause (b)(i) and the DA fee nominated in the original DA, then additional DA Fees may be payable prior to the issue of a Construction Certificate.

A copy of the required format for the cost reports are provided in the Waverley Council Contributions Plan, available on Council's website.

- (c) As legislated in section 209 of the Environmental Planning and Assessment Regulation 2021, the levy must be paid in accordance with the following;
 - (i) A development valued at \$100,000 or less will be exempt from the levy;
 - (ii) A development valued at \$100,001 \$200,000 will attract a levy of 0.5% of the <u>full</u> cost of the development; or
- (iii) A development valued at more than \$200,000 will attract a levy of 1% of the <u>full</u> cost of the development.

Prior to the issue of any Construction Certificate, evidence must be provided that the levy has been paid to Council in accordance with this condition or that the cost of works is less than \$100,000.

12. TREE PRESERVATION BOND

A bond of \$5,000 is to be lodged with Council either as cash or by way of an unconditional bank guarantee to ensure the protection and maintenance of the one (1) *ficus rubiginosa* (Port Jackson fig) growing out from the sandstone shelf in front of the subject site on Hewlett Street. The bond is to be lodged prior to the issue of a Construction Certificate.

The sum will be forfeited to the Council at its discretion for a breach of these requirements and will be refunded twelve (12) months from the issue of the Final Occupation Certificate subject to the satisfaction of Council.

13. SECURITY DEPOSIT

A deposit (cash or cheque) or guarantee for the amount of \$34,324.00 must be provided to Council for any damage caused to any property of the consent authority (ie. public land) as a consequence of the works and completing any public work (such as road work, kerbing and guttering, footway construction, stormwater drainage and environmental controls) required in connection with the consent.

This deposit (cash or cheque) or guarantee must be provided to Council prior to the issue of any Construction Certificate. The full amount of the deposit, minus Council's costs for any repair of damage to Council property or rectification of unauthorised works on Council property, will be refunded after satisfactory completion all of works associated with this consent (including the required public works) to the person who paid the deposit.

14. LONG SERVICE LEVY

A long service levy, as required under section 34 of the *Building and Construction Industry Long Service Payments Act, 1986*, is to be paid in respect of this building work. Evidence that the levy has been paid is to be submitted to the Principal Certifying Authority prior to the issue of any Construction Certificate.

<u>Note</u>: Council acts as an agent for the Long Service Payment Corporation and the levy may be paid at Council's office. The levy rate is 0.35% of building work costing \$25,000 or more.

15. ENGINEERING PLANS ASSESSMENT AND WORKS INSPECTION FEES

The applicant is to pay to Council fees for the assessment of all engineering plans and inspection of the completed works in the public domain inclusive of all stormwater assessment, in accordance with Council's Schedule of Fees & Charges at the time of engineering plan approval, prior to such approval being granted by Council.

An invoice will be issued to the applicant for the amount payable, which will be calculated based on the design plans for the subject development.

CONSTRUCTION MATTERS

16. HOARDING

To ensure the site is contained during construction, a hoarding is required for the approved works, which is to be designed and constructed in accordance with the requirements of Safe Work NSW. Where the hoarding is to be erected over the footpath or any public place, the approval of Council's Compliance Unit must be obtained and the applicable fees paid, prior to the erection of the hoarding.

17. EROSION & SEDIMENT CONTROL

A Soil and Water Management Plan (SWMP), also known as an Erosion and Sediment Control Plan must be prepared in accordance with Waverley Council's Water Management Technical Manual.

The SWMP must be approved by the Principal Certifying Authority prior to the issue of a Construction Certificate. A copy of the SWMP must be kept on site at all times and made available to Council officers upon request.

The recommendations of the SWMP must be implemented and maintained during all construction activities and until the site is fully stabilised following construction.

18. DETAILS OF EXCAVATION, SHORING OR PILE CONSTRUCTION

A report shall be prepared by a suitably qualified and practising Structural Engineer/Geotechnical Engineer detailing the proposed methods of excavation, shoring or pile construction, including details of vibration emissions and any possible damage which may occur to adjoining or nearby properties as a result of the proposed building and excavation works.

Any practices or procedures specified in the Structural Engineer's report in relation to the avoidance or minimisation of structural damage to adjoining properties are to be fully complied with and incorporated into the plans and specifications together with the Construction Certificate.

19. ENGINEERING DETAILS

Structural details are to be prepared and certified by a practicing Structural Engineer in connection with all structural components of the approved works, prior to the issue of the relevant Construction Certificate.

20. ENGINEERING CERTIFICATE OF ADEQUACY

A Certificate of Adequacy prepared by a practicing Structural Engineer is to be provided certifying the adequacy of the existing building structure to carry the extra load of the proposed additions, prior to the issue of the relevant Construction Certificate.

21. DILAPIDATION REPORT

A Dilapidation report is to be prepared for any adjoining or nearby property that may be subject to potential damage as a result of any works being undertaken. The dilapidation report is be made available to affected property owners.

The report is to be dated, submitted to, and accepted by the Principal Certifying Authority, prior to any work commencing on the site.

Note: Any damage that may be caused is a civil matter. This consent does not allow or authorise any party to cause damage, trespass, or any other unlawful act and Council will not be held responsible for any damage that may be caused to adjoining buildings as a consequence of the development being carried out. Council will not become directly involved in disputes between the builder, owner, developer, its contractors and the owners of neighbouring buildings.

TRAFFIC MANAGEMENT

22. CONSTRUCTION TRAFFIC MANAGEMENT PLAN (CTMP)

The applicant is to submit a Construction Traffic Management Plan (CTMP) for the approval of Council's Executive Manager, Infrastructure Services, or delegate, prior to the issue of any Construction Certificate. For further information on what is required in the CTMP, please refer to Council's website at:

https://www.waverley.nsw.gov.au/building/development_applications/post_determination/development_applications - conditions of consent

STORMWATER & FLOODING

23. STORMWATER AND PUBLIC INFRASTRUCTURE MANAGEMENT

To ensure that stormwater runoff from the development is drained in an appropriate manner, without impact to neighbouring properties and downstream systems, a detailed plan and certification of the development's stormwater management system must be submitted and approved by the Executive Manager, Infrastructure Services (or delegate) prior to the issue of the relevant Construction Certificate.

The submitted Water Management Plan prepared by JHA, Drawing No. C-DA000 – C-DA600, received date: 31/01/2023 is considered concept only, and are deemed unsatisfactory.

The applicant must submit plans and specifications to comply with the current Waverley Council Water Management Technical Manual and Development Control Plan (DCP) at the time of engineering plan approval. The submitted plans shall be prepared by a suitably qualified and practising Civil Engineer and address the following:

- (a) Any new downpipes are to be located wholly within the property's boundary.
- (b) A sediment control stormwater pit must be installed inside the property, adjacent to the boundary, for all stormwater outlets.
- (c) An inspection opening or stormwater pit must be installed inside the property, adjacent to the boundary, for all stormwater outlets
- (d) Confirm site area and post developed impervious area, current BASIX and Stormwater Plans and Details provide different values.
- (e) A grated trench drain shall be provided across the (garage entrance/driveway/street boundary) within private property. Unless otherwise sized by a suitably qualified and practising Engineer, the dimensions of the trench grate shall be no less than 300mm wide by 100mm deep at the shallow end and have a "bottom" slope of 2%. This trench drain shall be connected to an approved drainage system.
- (f) Provide calculations for gutter sizing for 5% AEP storm event and minimum number of downpipes required.
- (g) Permissible site discharge (PSD) for new development is a 1 in 100-year storm event detained to a 5-minute, 1 in 5-year storm event with a fraction imperviousness of 0.1. Recalculate PSD accordingly.
- (h) A certificate from a registered structural engineer certifying the structural adequacy of the OSD tank structure is to be provided. Any below ground OSD tank structure shall be a cast in-situ concrete based.
- (i) Any affected Council's infrastructure as the result of construction activities within the public domain area, inclusive of stormwater, stormwater outlet/s, kerb and gutter, pavement, grass verges and vehicle crossovers within the extent works shall be replaced as per Waverley Council Public Domain Technical Manual. All associated costs shall be borne by the applicant.

Notes:

- The checklist as set out on pages 68-76 on Council's Water Management Technical Manual (Oct 2021) available online shall be completed and submitted with any revision of Construction Certificate Plan Submission.
- The Applicant is advised to consider the finished levels of the public domain, including new or
 existing footpaths and pavement prior to setting the floor levels for the proposed development.
- Waverley Council standard drawings for public domain infrastructure assets are available upon request. Details that are relevant may be replicated in the Engineering design submissions however, Council's title block shall not be replicated.
- Prior to commencement of works a security deposit will be made payable to Council to ensure
 any additional damage or unauthorised works within the Council property, not conditioned
 above. Council will reserve the right to withhold the cost of restoring the damaged assets from
 the security deposit should the applicant fail to restore the defects to the satisfaction of Council.

• Council's contact for infrastructure assessment: E-mail: assets@waverley.nsw.gov.au or Phone: 9083 8886 (operational hours between 9.30am to 4pm Monday to Friday). The expected duration to review and approve the stormwater management plan may take at least 15 working days from the date of submission.

ENERGY EFFICIENCY & SUSTAINABILITY

24. BASIX

All requirements of the BASIX Certificate are to be shown on the Construction Certificate plans and documentation.

WASTE

25. SITE WASTE AND RECYCLING MANAGEMENT PLAN

A Site Waste and Recycling Management Plan (SWRMP) — Part 2 is to be submitted to the Principal Certifying Authority prior to the issue of the relevant Construction Certificate, which outlines materials to be reused and/or recycled as a result of demolition and construction works. At least one copy of the SWRMP Part 2 is to be available on site at all times during construction. Copies of demolition and construction waste dockets that verify the facility that received the material for recycling or disposal and the quantity of waste received, must be retained on site at all times during construction.

C. COMPLIANCE PRIOR TO WORK COMMENCING AND DURING CONSTRUCTION

The requirements outlined in this section are to be provided to the satisfaction of the Principal Certifying Authority in all instances, except where a condition explicitly specifies the approval of Council, or a Council Officer is required.

PRIOR TO ANY WORKS

26. CONSTRUCTION SIGNS

Prior to commencement of any works on the site and during construction a sign shall be erected on the main frontage of the site detailing the name, address and contact details (including a telephone number) of the Principal Certifying Authority and principal contractor (the coordinator of the building works). The sign shall be clearly legible from the adjoining street/public areas and maintained throughout the building works.

DEMOLITION & EXCAVATION

27. DEMOLITION – ASBESTOS AND HAZARDOUS MATERIALS

The demolition, removal, storage, handling and disposal of products and materials containing asbestos must be carried out in accordance with the relevant requirements of SafeWork NSW and the NSW Environment Protection Authority (EPA), including:

- Work Health and Safety Act 2011;
- Work Health and Safety Regulation 2017;
- SafeWork NSW Code of Practice for the Safe Removal of Asbestos;
- Australian Standard 2601 (2001) Demolition of Structures;
- Protection of the Environment Operations Act 1997.

At least 5 days prior to the demolition, renovation work or alterations and additions to any building, the person acting on the consent shall submit a Work Plan to the Principal Certifying Authority in accordance with Australian Standard AS 2601-2001, Demolition of Structure and a Hazardous Materials Assessment prepared by a person with suitable expertise and experience. The Work Plan and Hazardous Materials Assessment shall:

- a) Outline the identification of any hazardous materials, including surfaces coated with lead paint;
- b) Confirm that no asbestos products are present on the subject land, or
- c) Particularise a method of safely disposing of the asbestos in accordance with the Code of Practice on how to safely remove asbestos published by SafeWork NSW (catalogue WC03561);
- d) Describe the method of demolition;
- e) Describe the precautions to be employed to minimise any dust nuisance; and
- f) Describe the disposal methods for hazardous materials.

28. CONTROL OF DUST ON CONSTRUCTION SITES

The following requirements apply to demolition and construction works on site:

- (a) Hazardous dust is not to be allowed to escape from the site. The use of fine mesh dust proof screens or other measures are recommended. Any existing accumulations of dust (e.g. ceiling voids and wall cavities) must be removed by the use of an industrial vacuum fitted with a high efficiency particle air (HEPA) filter. All dusty surfaces and dust created from work are to be suppressed by a fine water spray. Water must not be allowed to enter the street and stormwater systems. Demolition is not to be performed during adverse winds, which may cause dust to spread beyond the site boundaries.
- (b) All contractors and employees directly involved in the removal of hazardous dusts and substances are to wear protective equipment conforming to Australian Standard AS1716 Respiratory Protective Devices.

29. CLASSIFICATION OF WASTE/ DISPOSAL OF EXCAVATED SOILS

Prior to the exportation of waste (including fill or soil) from the site the material must be classified in accordance with the provisions of the *Protection of the Environment Operations Act, 1997* and the NSW EPA Waste Classification Guidelines 2014.

30. EXCAVATION AND BACKFILLING

All excavations and backfilling associated with the erection or demolition of a building must be executed safely and in accordance with the appropriate professional standards and must be properly guarded and protected to prevent them from being dangerous to life or property.

If an excavation associated with the erection or demolition or a building extends below the level of the footings of a building on an adjoining allotment of land, the excavation is to be managed by a practising structural engineer.

CONSTRUCTION MATTERS

31. CONSTRUCTION HOURS

Demolition and building work must only be undertaken between the hours of 7am and 5pm on Mondays to Fridays and 8am to 3pm on Saturdays, with no work to be carried out on Sundays and public holidays.

Excavation works involving the use of heavy earth movement equipment, including rock breakers and the like, must only be undertaken between the hours of 7am and 5pm on Mondays to Fridays, with no such work to be carried out on Saturday, Sunday or a public holiday.

Noise from construction activities shall comply with the *Protection of the Environmental Operations* (Noise Control) Regulation 2017.

32. STOCKPILES, STORAGE OF MATERIALS AND LOCATION OF BUILDING OPERATIONS

All building materials and any other items associated with the development are to be stored within the property. No materials are to be stored on Council's footpath, nature strip, or road reserve without prior Council approval.

33. CONSTRUCTION INSPECTIONS

The building works are to be inspected during construction by the Principal Certifying Authority (PCA) in accordance with the *Building Legislation Amendment* (Quality of Construction) Act 2002 and 162A Critical stage inspections for building work of the *Environmental Planning and Assessment Regulation 2021*.

34. CERTIFICATE OF SURVEY - LEVELS

All construction works are to be in accordance with the Reduced Levels (RLs) as shown on the approved plans. Certification from a Registered Surveyor certifying ground, upper floor/s and finished ridge levels is to be submitted to the Principal Certifying Authority during construction and prior to continuing to a higher level of the building.

35. CERTIFICATE OF SURVEY - BOUNDARIES AND LOCATION OF BUILDING

A Certificate of Survey prepared by a Registered Surveyor setting out the boundaries of the site and the location of the building on the site is to be submitted to the Principal Certifying Authority to certify the building is located in accordance with the development consent plans. The Certificate is to be submitted prior to the construction of the external walls above the ground floor level of the building.

36. CONSTRUCTION OF SWIMMING POOLS AND OUTDOOR SPAS

The following applies to the construction of swimming pools and outdoor spas:

- (a) Reinforcement of the swimming pool/outdoor spa is to be inspected by an Accredited Officer or other suitably qualified person prior to the pouring of concrete.
- (b) The electrical wiring system for any proposed underwater artificial lighting installation to the pool/spa is to be installed in accordance with the requirements of Australian Standard 3000, Part 1 - Wiring Rules.
- (c) The swimming pool/outdoor spa water is to be treated by an approved water treatment and filtration unit.
- (d) To prevent noise nuisance to surrounding properties, the swimming pool/outdoor spa filtration motor and pump unit is to be housed within a ventilated soundproof enclosure.
- (e) Waste waters from the swimming pool/outdoor spa are to be discharged into Sydney Water's sewerage system and in this regard, approved plans must be submitted to Sydney Water at least 14 days prior to commencement of building operations.

TREE PROTECTION AND REMOVAL

37. TREE PROTECTION

All trees on site and adjoining properties, including street trees, are to be retained and protected in accordance with AS4970-2009 'Protection of Trees on Construction Sites' and to be certified by an Arborist with AQF level 5 qualification or above, unless approved to be removed in this development consent.

38. TREES PERMITTED TO BE REMOVED

The following trees are permitted to be removed;

Tree Species and approximate	Location	To be replaced with
height		
Tree 1, Cordyline australis	Falls within proposed pathway	See condition 2(a)
(Cabbage Tree [4m])	footprint	
Tree 3, Coprosma (Bird of	Falls within proposed pathway	See condition 2(a)
paradise [6m])	footprint	
Trees 5-7, Howea forsteriana	Along eastern side setback	Landscape plan includes
(Kentia Palms [3m trunk])		planting that would offset
		removal of these trees.
Tree 10, Schefflera actinophylia	Rear north-eastern corner in	Landscape plan includes
(Umbrella Tree [3m]) – dead tree	proposed location of swimming	planting that would offset
	pool	removal of these trees.
Tree 12, Howea forsteriana	Rear north-eastern corner in	Landscape plan includes
(Kentia Palms [3m trunk]) – group	proposed location of swimming	planting that would offset
of 4 small palms	pool	removal of these trees.

39. STREET TREES TO BE RETAINED/TREE PROTECTION

No existing street trees shall be removed without Council approval. Precautions shall be taken when working near trees to ensure their retention, including the following:

- (a) Do not store harmful or bulk materials or spoil under or near trees;
- (b) Prevent damage to bark and root system;
- (c) Do not use mechanical methods to excavate within root zones;
- (d) Do not add or remove topsoil from under the drip line;
- (e) Do not compact ground under the drip line;
- (f) Do not mix or dispose of liquids within the drip line of the tree; and
- (g) All trees marked for retention must have a protective fence/guard placed around a nominated perimeter in accordance with AS4970-2009 "Protection of trees on construction sites.

Trunk protection as per AS 4970 – 2009, Section 4.5.3 is to be installed.

Padding to be used shall be non-absorbing or free draining to prevent moisture build up around the part being protected.

The trunk protection shall consist of a layer of carpet underfelt (or similar) wrapped around the trunk, followed by 1.8 metre lengths of softwood timbers (90 x 45mm in section) aligned vertically and spaced evenly around the trunk at 150mm centres (i.e. with a 50mm gap) and secured together with 2mm galvanised wire or galvanised hoop strap. The timbers shall be wrapped around the trunk (over the carpet underfelt), but not fixed to the tree to avoid mechanical injury or damage to the trunk. Trunk protection must be installed prior to any site works including demolition and maintained in good condition for the duration of the construction period.

- Trunk protection to be removed at the issue of the Occupation Certificate subject to the satisfaction of Council.
- TPZ A 1.8m chain link wire fence or the like shall be erected around the above trees to be retained to protect them from damage during construction. Fencing is not to be removed until all building work has been completed. Fencing to be installed to the dimensions outlined in the table above.
- If any tree roots are exposed during any approved works, then roots smaller than 30mm are to be pruned as per the specifications below. Any roots greater than 30mm are to be assessed by a qualified arborist before any pruning is undertaken.
- If tree roots are required to be removed for the purposes of constructing the approved works, they shall be cut cleanly by hand, by an experienced Arborist/Horticulturist (with a minimum of the Horticulture Certificate or Tree Surgery Certificate).
- It is the arborist's responsibility to determine if such root pruning is suitable. If there are any concerns regarding this process, then Waverley Council's Tree Management Officer is to be contacted to make final determination.
- If any trees on neighbouring properties require pruning, then permission must be gained from the owner of the tree(s) and an Application to Prune or Remove Trees on Private Property is then to be presented to Council for processing.
- If any trees on Council owned land require pruning, the applicant is to supply a tree pruning report from an Arborist with AQF level 5 qualification or above with photos showing the branches that need to be removed.
- If approval is granted the applicant may prune the tree at their expense, by an experienced Arborist/Horticulturist (with a minimum of the Horticulture Certificate or Tree Surgery Certificate).

D. PRIOR TO THE ISSUE OF AN OCCUPATION CERTIFICATE

The requirements outlined in this section are to be provided to the satisfaction of the Principal Certifying Authority in all instances, except where a condition explicitly specifies the approval of Council or a Council Officer is required, prior to the issue of an Occupation Certificate or Subdivision Certificate, whichever applies.

40. FINAL OCCUPATION CERTIFICATE

Prior to occupation or use of the development, an Occupation Certificate must be obtained.

The Principal Certifying Authority must be satisfied that the requirements of the *Environmental Planning & Assessment Act 1979* have been satisfied including all critical stage inspections. Documentary evidence of all required inspections is to be submitted to Council.

41. CERTIFICATION OF BASIX COMMITMENTS

The Principal Certifying Authority shall certify that the all the undertakings in the approved BASIX certificate have been completed.

42. CERTIFICATION OF NEWLY CONSTRUCTED AND RETAINED STORMWATER DRAINAGE SYSTEM

Prior to issue of any Occupation Certificate, certification is to be provided from a suitably qualified and practising Engineer or Plumber, that any new stormwater drainage system has been constructed in accordance with the Development Consent, Water Management Technical Manual, all applicable Codes, Policies, Plans, Standards and good engineering practice. Similarly, any retained stormwater drainage system is unblocked, in good working order and to be repaired/replaced to best practice. A copy of the certification must be submitted to Council.

43. WORKS-AS-EXECUTED DRAWINGS - STORMWATER DRAINAGE SYSTEM

- (a) A Works-As-Executed drawing (WAED) of the stormwater drainage system must be prepared, stamped, and signed by a Registered Surveyor. This drawing must detail the alignment of all pipelines, pits, rainwater harvesting facility and other drainage-related infrastructure. An original or a color copy must be submitted to Waverley Council. Where changes have occurred, the Council-approved plans shall be marked-up in red ink and shall include levels and locations for the drainage structures and works.
- (b) A suitably qualified and practicing Engineer must provide certification of the WAED of the stormwater drainage system that the stormwater drainage works were constructed to their satisfaction and in accordance with the Development Consent, Water Management Technical Manual, all applicable Codes, Policies, Plans, Standards, and good engineering practice. A copy of the aforementioned letter of certification must be submitted to Council.

44. CREATION OF POSITIVE COVENANT AND RESTRICTION FOR OSD

Prior to the issue of an Occupation Certificate, a "Positive Covenant" and "Restriction on the Use of Land" shall be created for the On-Site Stormwater Detention (OSD) system, under Section 88E of the *Conveyancing Act 1919*. This is to place a restriction on the Title that the OSD system is maintained and kept free of debris/weed to allow unobstructed passage of stormwater through the site and underneath

the residence. The property owner/occupant shall not modify or remove the OSD system without consent from Council.

The wording of the Instrument shall be submitted to and approved by Executive Manager, Infrastructure Services (or delegate) prior to lodgement at NSW Land Registry Services.

Where a Title exists, the Positive Covenant and Restriction on the Use of Land is to be created via an application to the NSW Land Registry Services using forms 13PC and 13RPA. Accompanying this form is the requirement for a plan to scale showing the relative location of the OSD system, including its relationship to the building footprint. Electronic color photographs of the OSD system shall accompany the application for the Positive Covenant and Restriction on the Use of Land.

The Instrument shall be registered and a registered copy of the document shall be submitted to and approved by the consent authority prior to the issue of an Occupation Certificate or use of the building. All associated costs shall be borne by the applicant.

45. CREATION OF POSITIVE COVENANT AND RESTRICTION FOR WATER QUALITY AND RAINWATER

Prior to the issue of an Occupation Certificate, a "Positive Covenant" and "Restriction on the Use of Land" shall be created for the Stormwater Quality Improvement Devices in accordance with the requirements of Council's Water Management Manual 2021. The Restriction to User and Positive Covenant must be registered with NSW Land Registry Services prior to the Final Occupation Certificate.

46. CERTIFICATION OF SWIMMING POOL/OUTDOOR SPA

Prior to the pool being used, the following must be provided;

- (a) Certification that the pool has been constructed in accordance with the consulting engineers design;
- (b) Evidence that the swimming pool/outdoor spa has been registered on the State Government Swimming Pool Register (http://www.swimmingpoolregister.gov.au);
- (c) A sign outlining details of resuscitation techniques for adults, children and infants has been placed in a prominent position, close to the pool/outdoor spa. Signs are available from Council;
- (d) A copy of the occupation certificate must be submitted to Council.

Note: Swimming/spa pool pumps are restricted from use between 8pm to 7am weekdays and Saturdays, 8pm to 8am on Sundays and public holidays in accordance with the requirements of the *Protection of the Environment Operations (Noise Control) Regulation 2017.*

47. LANDSCAPE PLAN

The site is to be landscaped and turfed in accordance with the approved landscaped plan with the landscape works completed and Certified by an Arborist with AQF level 5 qualification or above, prior to the issue of the Occupation Certificate.

E. ADVISORY MATTERS

The following advisory matters are provided as additional information to ensure compliance with the relevant legislation and requirements. You must also check other Commonwealth and NSW Acts and Regulations which may apply to the works or use approved in this application.

AD1. POST CONSENT CONDITIONS REQUIRING COUNCIL INPUT

Various conditions require further input, review or approval by Council in order to be satisfied following the determination of the application (that is, post consent). In those instances, please adhere to the following process to avoid delays:

- Please read your conditions carefully.
- Information to be submitted to Council should be either via email to info@waverley.nsw.gov.au or via the NSW Planning Portal (if required).
- Attention the documentation to the relevant officer/position of Council (where known/specified in condition).
- Include DA reference number.
- Include condition number/s seeking to be addressed.
- Where multiple conditions need Council input, please try to group the documentation / email/s into relevant subjects (multiple emails for various officers may be necessary, for example).
- Information to be submitted in digital format refer to 'Electronic lodgement guidelines' on Council's website. Failure to adhere to Council's naming convention may result in documentation being rejected.
- Where files are too large for email, the digital files should be sent to Council via CD/USB. Council does not support third party online platforms (data in the cloud) for receipt of information.
- Please note, in some circumstances, additional fees and/or additional documents (hard copy) may be required.
- Council's standard for review (from date the relevant officer receives documentation) is 14 days. Times may vary or be delayed if information is not received in this required manner.

AD2. SUSTAINABILITY AND INDOOR AIR QUALITY

Ceiling or wall mounted fans should be in all habitable rooms (main living areas and bedrooms).

Gas cooktops, gas ovens or gas internal space heating systems are not permitted in any residential development. Instead, electric systems should be installed.

AD3. SYDNEY WATER REQUIREMENTS

You may be required to submit your plans to the appropriate Sydney Water office to determine whether the development will affect Sydney Water's sewer and water mains, stormwater drains and/or easements.

Contact Sydney Water for more information.

AD4. ONGOING MAINTENANCE – STORMWATER DRAINAGE SYSTEM

Council will need to be provided with an OSD and Stormwater Quality Improvement Devices maintenance activities. At a minimum, the OSD and Stormwater Quality Improvement Devices must be:

- Kept clean and free from silt, rubbish and debris.
- Be maintained so that it functions in a safe and efficient manner.
- Not be altered without prior consent in writing of the Council.

AD5. RAINWATER HARVESTING AND REUSE

The operation of all devices or appliances installed within the development approved by this consent as required by conditions pertinent to rainwater harvesting and rainwater reuse must be maintained in good operating order at all times.

AD6. DIAL BEFORE YOU DIG

Underground assets may exist in the area that is subject to your application. In the interests of health and safety and in order to protect damage to third party assets please contact Dial Before You Dig at www.1100.com.au or telephone on 1100 before excavating or erecting structures (this is the law in NSW). If alterations are required to the configuration, size, form or design of the development upon contacting the Dial Before You Dig service, an amendment to the development consent (or a new development application) may be necessary. Individuals owe asset owners a duty of care that must be observed when working in the vicinity of plant or assets. It is the individual's responsibility to anticipate and request the nominal location of plant or assets on the relevant property via contacting the Dial Before You Dig service in advance of any construction or planning activities.

AD7. TELECOMMUNICATIONS ACT 1997 (COMMONWEALTH)

Telstra (and its authorised contractors) are the only companies that are permitted to conduct works on Telstra's network and assets. Any person interfering with a facility or installation owned by Telstra is committing an offence under the *Criminal Code Act 1995* (Cth) and is liable for prosecution. Furthermore, damage to Telstra's infrastructure may result in interruption to the provision of essential services and significant costs. If you are aware of any works or proposed works which may affect or impact on Telstra's assets in any way, you are required to contact: Telstra's Network Integrity Team on Phone Number 1800810443.

AD8. EXCAVATION TO BE LIMITED

Excavation shall be limited to that shown in the approved plans. Any further excavation will require Council approval.

AD9. TREE REMOVAL/PRESERVATION

Any trees not identified for removal in this application have not been assessed and separate approval may be required. Any pruning of trees on adjoining properties required for the erection of scaffolding and/or the construction of the building may also require approval.

AD10. SITE RECTIFICATION WORKS

The vacant site is to be maintained in a safe and secure manner. Fencing is to be erected around the permitter of the site once demolition has been completed to secure the site. The site is to be protected from windblown soil loss and stormwater erosion at all times.

If the site is commenced to be developed and there is suspension in activity for 6months (or suspensions of activity which in the aggregate exceed 6 months), resulting in a building site which has an appearance not acceptable to Council, then the Council will have the readily enforceable rights to:

- (i) Require certain works to be carried out, including but not limited to:
 - (a) Make the building/site safe and of an appearance acceptable to Council;
 - (b) Allow the ground level to be landscaped and of an appearance acceptable to Council from any public vantage point;
 - (c) For the hole to be covered to allow it to be landscaped and made attractive from any public vantage point.
 - (d) Council may call on any bank guarantee to cover the cost thereof.
- (ii) In the event of default, have the right to enter and carry out these works and to call upon security in the nature of a bank guarantee to cover the costs of the works.

134 HEWLETT STREET, BRONTE

PROPOSED DEMOLITION OF EXISTING DWELLING AND CONSTRUCTION OF A NEW DWELLING HOUSE.


DRAWING LIST		
DA000 COVER PAGE	(A1)	1:1000
DA100 SITE ANALYSIS PLAN	(A1)	1:500
DA200 GARAGE LEVEL PLAN	(A1)	1:100
DA201 LOWER GROUND FLOOR PLAN	(A1)	1:100
DA202 GROUND FLOOR PLAN	(A1)	1:100
DA203 FIRST FLOOR PLAN	(A1)	1:100
DA204 ROOF PLAN	(A1)	1:100
DA300 SECTION A	(A1)	1:100
DA301 SECTION A2	(A1)	1:100
DA302 SECTION B	(A1)	1:100
DA303 POOL SECTIONS	(A1)	1:50
DA400 SOUTH ELEVATION	(A1)	1:100
DA401 NORTH ELEVATION	(A1)	1:100
DA402 WEST ELEVATION	(A1)	1:100
DA403 EAST ELEVATION	(A1)	1:100
DA500 COMPLIANCE TABLE	(A1)	NTS
DA600 PHOTOMONTAGE 01	(A1)	NTS
DA601 PHOTOMONTAGE 02	(A1)	NTS
DA602 EXTERNAL FINISHES SCHEDULE	(A1)	NTS
DA603 SITE WASTE MANAGEMENT PLAN	(A1)	NTS
DA704 SURVEY - HIGH POLES 2	(A1)	1:50
DA705 VIEW DIAGRAMS	(A1)	NTS
DA706 VIEW DIAGRAMS	(A1)	NTS
DA707 VIEW DIAGRAMS	(A1)	NTS
DA708 VIEW DIAGRAMS	(A1)	NTS
DA709 VIEW DIAGRAMS	(A1)	NTS
DA710 VIEW DIAGRAMS	(A1)	NTS
DA711 VIEW DIAGRAMS	(A1)	NTS
DA712 VIEW DIAGRAMS	(A1)	NTS
DA800 FLOOR PLANS - EXISTING/APPROVED/PROPOSED	(A1)	1:100
DA801 FLOOR PLANS - EXISTING/APPROVED/PROPOSED	(A1)	1:100
DA802 SECTIONS - EXISTING/APPROVED/PROPOSED	(A1)	1:200
DA803 FLOOR PLANS - EXISTING/APPROVED/PROPOSED	(A1)	1:100









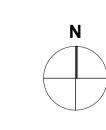

REV	NOTE	DATE	GENERAL NOTES
A B C D	DA SUBMISSION DA AMENDMENTS DA AMENDMENTS DA AMENDMENTS DA AMENDMENTS DA AMENDMENTS (SETBACK DIMENSIONS)	25.11.2022 03.05.2023 14.06.2023 11.08.2023 29.08.2023	1. ALL WORKS TO BE IN ACCORDANCE WITH THE BUILDING CODE OF AUSTRALIA AUSTRALIAN STANDARDS STATUTORY REGULATIONS AND LOCAL AUTHORITY REQ. 2. CONTRACTOR TO ENSURE CONSISTENCY BETWEEN MATERIALS IS MAINTAINED 3. CONTRACTOR TO NOTIFY MHN OF ANY DISCREPENCIES, DIMENSIONAL INCONSISTENCIES OR THE NEED FOR CLARIFICATION PRIOR TO MANUFACTURING 4. MHN TO REVIEW ALL CONTRACTORS DETAILED DRAWINGS / SETTING OUT PRIOR TO CONSTRUCTION. 5. CONTRACTOR TO LIAISE WITH ELECTRICAL CONTRACTORS TO ENSURE ALL POWERDATA/COMMUNICATION REQUIREMENTS
L	DANIEROWERTS (SET BACK DIMENSIONS)	23.00.2023	ARE ACCESSIBLE. 6. ALL DIMENSIONS TO BE VERIFIED ON SITE - DO NOT SCALE 7. ALL WORKS TO BE VERIFIED AGAINST DRAWINGS FOLLOWING CONSTRUCTION AND ARCHITECT TO BE NOTIFIED OF ANY DISCREPANCIES PRIOR TO PROCEEDING WITH NEXT TRADE

ALL CONSTRUCTION TO COMPLY AT MINIMUM W/ BCA	CLAUSES & AUSTRALIAN STANDARDS
SPEC. C1.1 - FIRE RESISTING CONSTRUCTION SPEC. C1.10 - FIRE HAZARD PROPERTIES SPEC. C1.10 - FIRE HAZARD PROPERTIES SPEC. C1.1 - PERFORMANCE OF EXTERNAL WALLS IN A FIRE CLAUSE C2.6 - VERTICAL SEPARATION OF OPENINGS IN EXTERNAL WALL CLAUSE C2.12 - SPEARATION OF COUPMENT CLAUSE C2.13 - ELECTRICITY SUPPLY SYSYEM CLAUSE C.3 - ACCEPTABLE METHODS OF PROTECTION (OF OPENINGS) CLAUSE C3.8 - OPENING IN FIRE ISOLATED EXITS CLAUSE C3.6 - OPENING FOR SERVICE INSTALLATIONS CLAUSE D1.10 - DISCHARGE FROM EXITS CLAUSE D1.10 - DISCHARGE FROM EXITS CLAUSE D2.7 - INSTALLATIONS IN EXITS AND PATHS OF TRAVEL CLAUSE D2.13 - GOINGS AND RISERS CLAUSE D2.14 - LANDINGS	CLAUSE D3.3 - PARTS OF BUILDING TO BE ACCESSIBLE CLAUSE D3.6 - IDENT. OF ACCESSIBLE FACIL/SERV/FEACLAUSE D3.8 - TACTILE INDICATORS

SPECIFICATIONS (refer to specification attachment) ARTIFICIAL LIGHTING: TO COMPLY WITH BCA PART CLAUSE F4.4 & AS1680 BALUSTRADE HEIGHTS: TO COMPLY WITH BCA CLAUSE D2.16 DRAINAGE GUTTERS & DOWNPIPES: TO COMPLY WITH ASINEZS 3500 3.2 ENERGY EFFICIENCYGLAZING: TO COMPLY WITH J2 OF BCA FIRE SERVICES: TO COMPLY WITH SECTION E OF BCA HOT WATER: SYSTEMS TO COMPLY WITH PART J7 OF BCA MASONRY: TO COMPLY WITH AS3700 MECHAICAL AIRCONDITIONING: TO COMPLY WITH PART J5 OF BCA MECHANICAL AIRCONDITIONING: TO COMPLY WITH PART J5 OF BCA MECHANICAL AIRCONDITIONING: TO COMPLY WITH AS1688 & AS8.2 SMOKE ALARMS: TO COMPLY WITH BCA PART CLAUSE & SPEC E2.2 & AS3786 PENETRATIONS: THROUGH FIRE RATED CONSTRUCTION FOR MECHIELECHYDRAULIC PENETRATIONS TO COMPLY WITH BCA CLAUSE C3.15 & AS1530 4-2005 SOUND TRANSMISSION: TO COMPLY WITH BRT5 OF BCA STAIR CONSTRUCTION: TO COMPLY WITH BCA CLAUSE D2.13 STAIR CONSTRUCTION: TO COMPLY WITH BCA CLAUSE D2.13 WATERPROOFING OF WET AREAS: TO COMPLY WITH AS3740	WASH TO KIT BA'S RAP PO CCC PO AL'T PV THE EXECUTE GLUW UW UW UW

WATER OPTIONS SHOWERHEADS: 4 STAR TOILETS: 4 STAR KITCHEN TAPS: 5 STAR BATHIROOM TAPS: 5 STAR RAIN WATER TANK: 4000L POOLSPA: 35,000L COLLECT RUN OFF AREA: 64 Sqm POOL HEATING SYSTEM: SOLAR (GAS BOOSTED) ALTERNATIVE ENERGY: PV SYSTEM TO GENERATE 2.5 PEAK KWATTS THERMAL COMPORT OPTIONS EXTERNAL WALLS: R2.0 / R1.3 CEILINGS: R2.5	OMMITMEN
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ALTERNATIVE ENERGY: PV SYSTEM TO GENERATE 2.5 PEAK KWATTS THERMAL COMPORT OPTIONS EXTERNAL WALLS: CPILINGS: R2.0 / R1.3 CPILINGS: R2.5	HEATIN
EXTERNAL WALLS: R2.0 / R1.3 CEILINGS: R2.5	VENTIL
FLOOR: R2.5 GLAZING SPEC:	
Uw = 3.5 SGHC = 0.64 Uw = 6.7 SGHC = 0.7 Uw = 1.3 SGHC = 0.44	WATER COOKT OVEN:

IX CO	MMITMENTS AS PER B	ASIX CERTIFICATE AND STAMPED PLANS)
	ENERGY OPTIONS	
	COOLING:	IN AT LEAST 1 LIVING AREA: 3 PHASE A/C, ENERGY RATING: EER > 3.0-3.5 IN AT LEAST 1 BEDROOM: 3 PHASE A/C. ENERGY RATING: EER > 3.0-3.5
0)	HEATING:	IN AT LEAST 1 LIVING AREA: 3 PHASE A/C, ENERGY RATING: EER > 3.0-3.5 IN AT LEAST 1 BEDROOM: 3 PHASE A/C. ENERGY RATING: EER > 3.0-3.5
<i>)</i>)	VENTILATION:	AT LEAST 1 BATHROOM INDIVIDUAL FAN, DUCTED TO FACADE OR ROOF, MANUAL SWITCH ON/OFF KITCHEN: INDIVIDUAL FAN, DUCTED TO FACADE OR ROOF, MANUAL SWITCH ON/OFF LAUNDRY: NATURAL VENTILATION ONLY
	WATER HEATING: COOKTOP: OVEN:	5 STAR GAS INSTANTANEOUS GAS ELECTRIC

NOTES:

ARCHITECT:	PR
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MHNDU\\()\\	
35 RICHARDS LANE	
SURRY HILLS SYDNEY NSW 2010	DF
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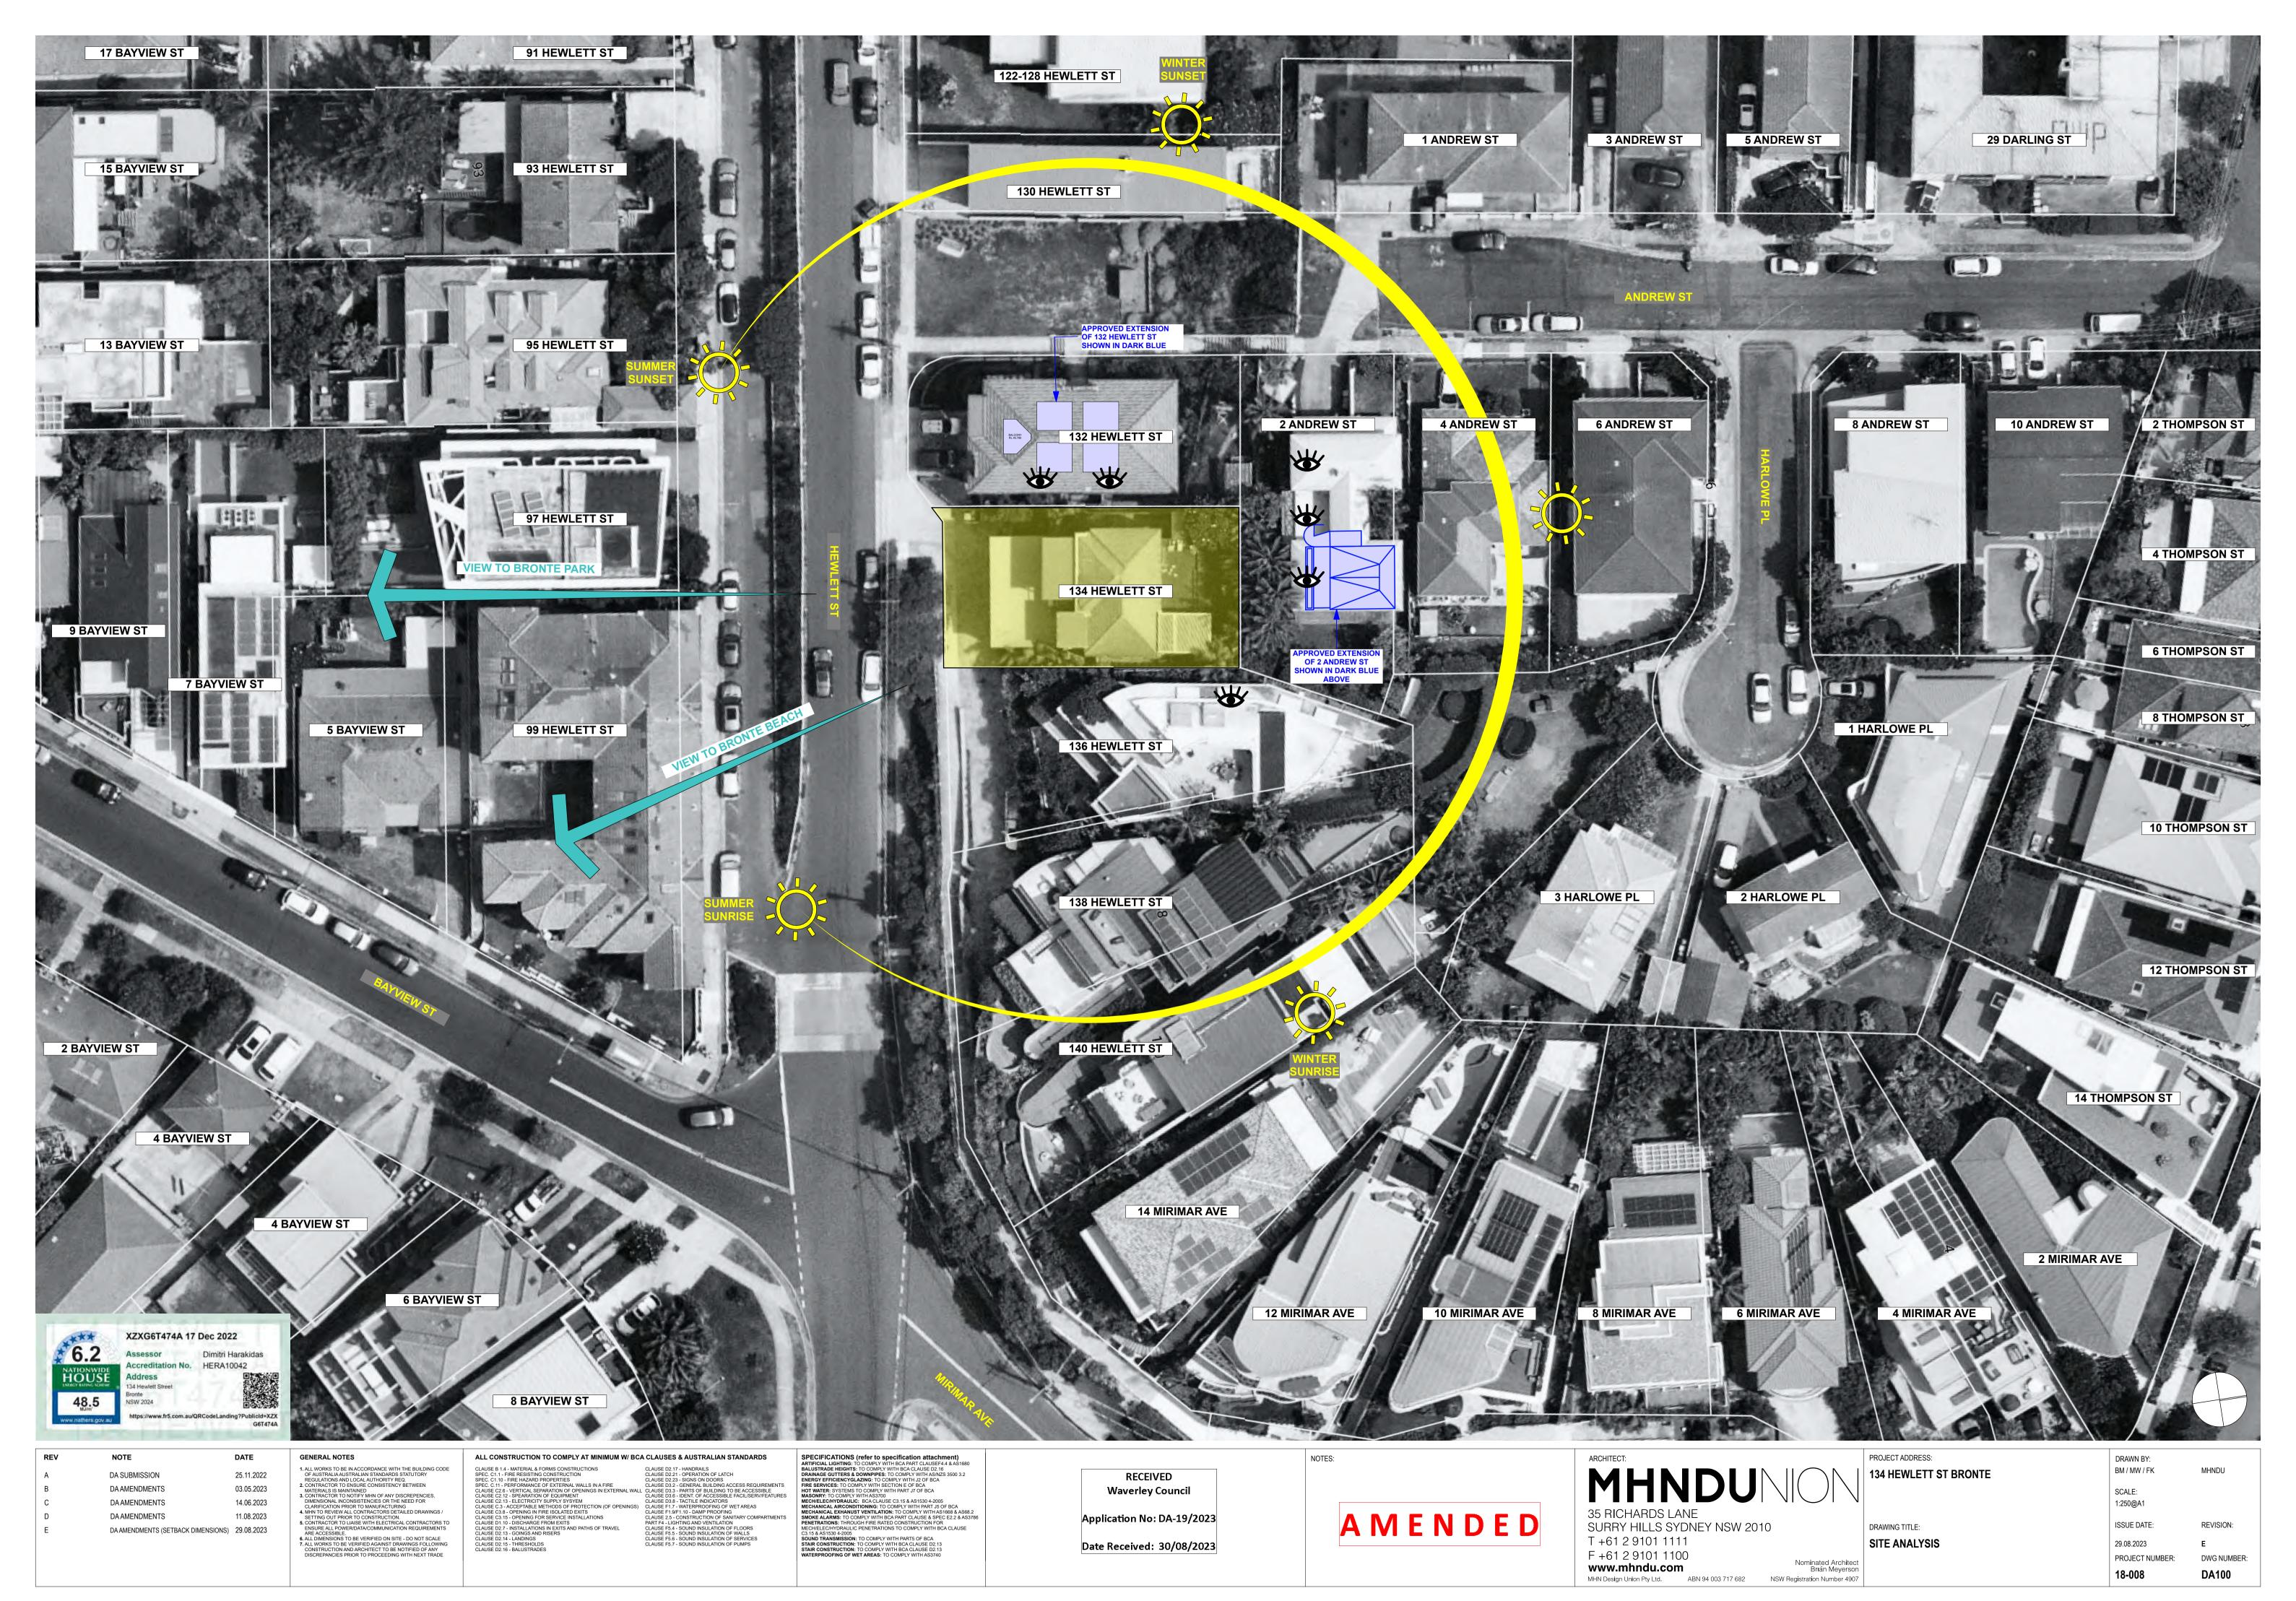
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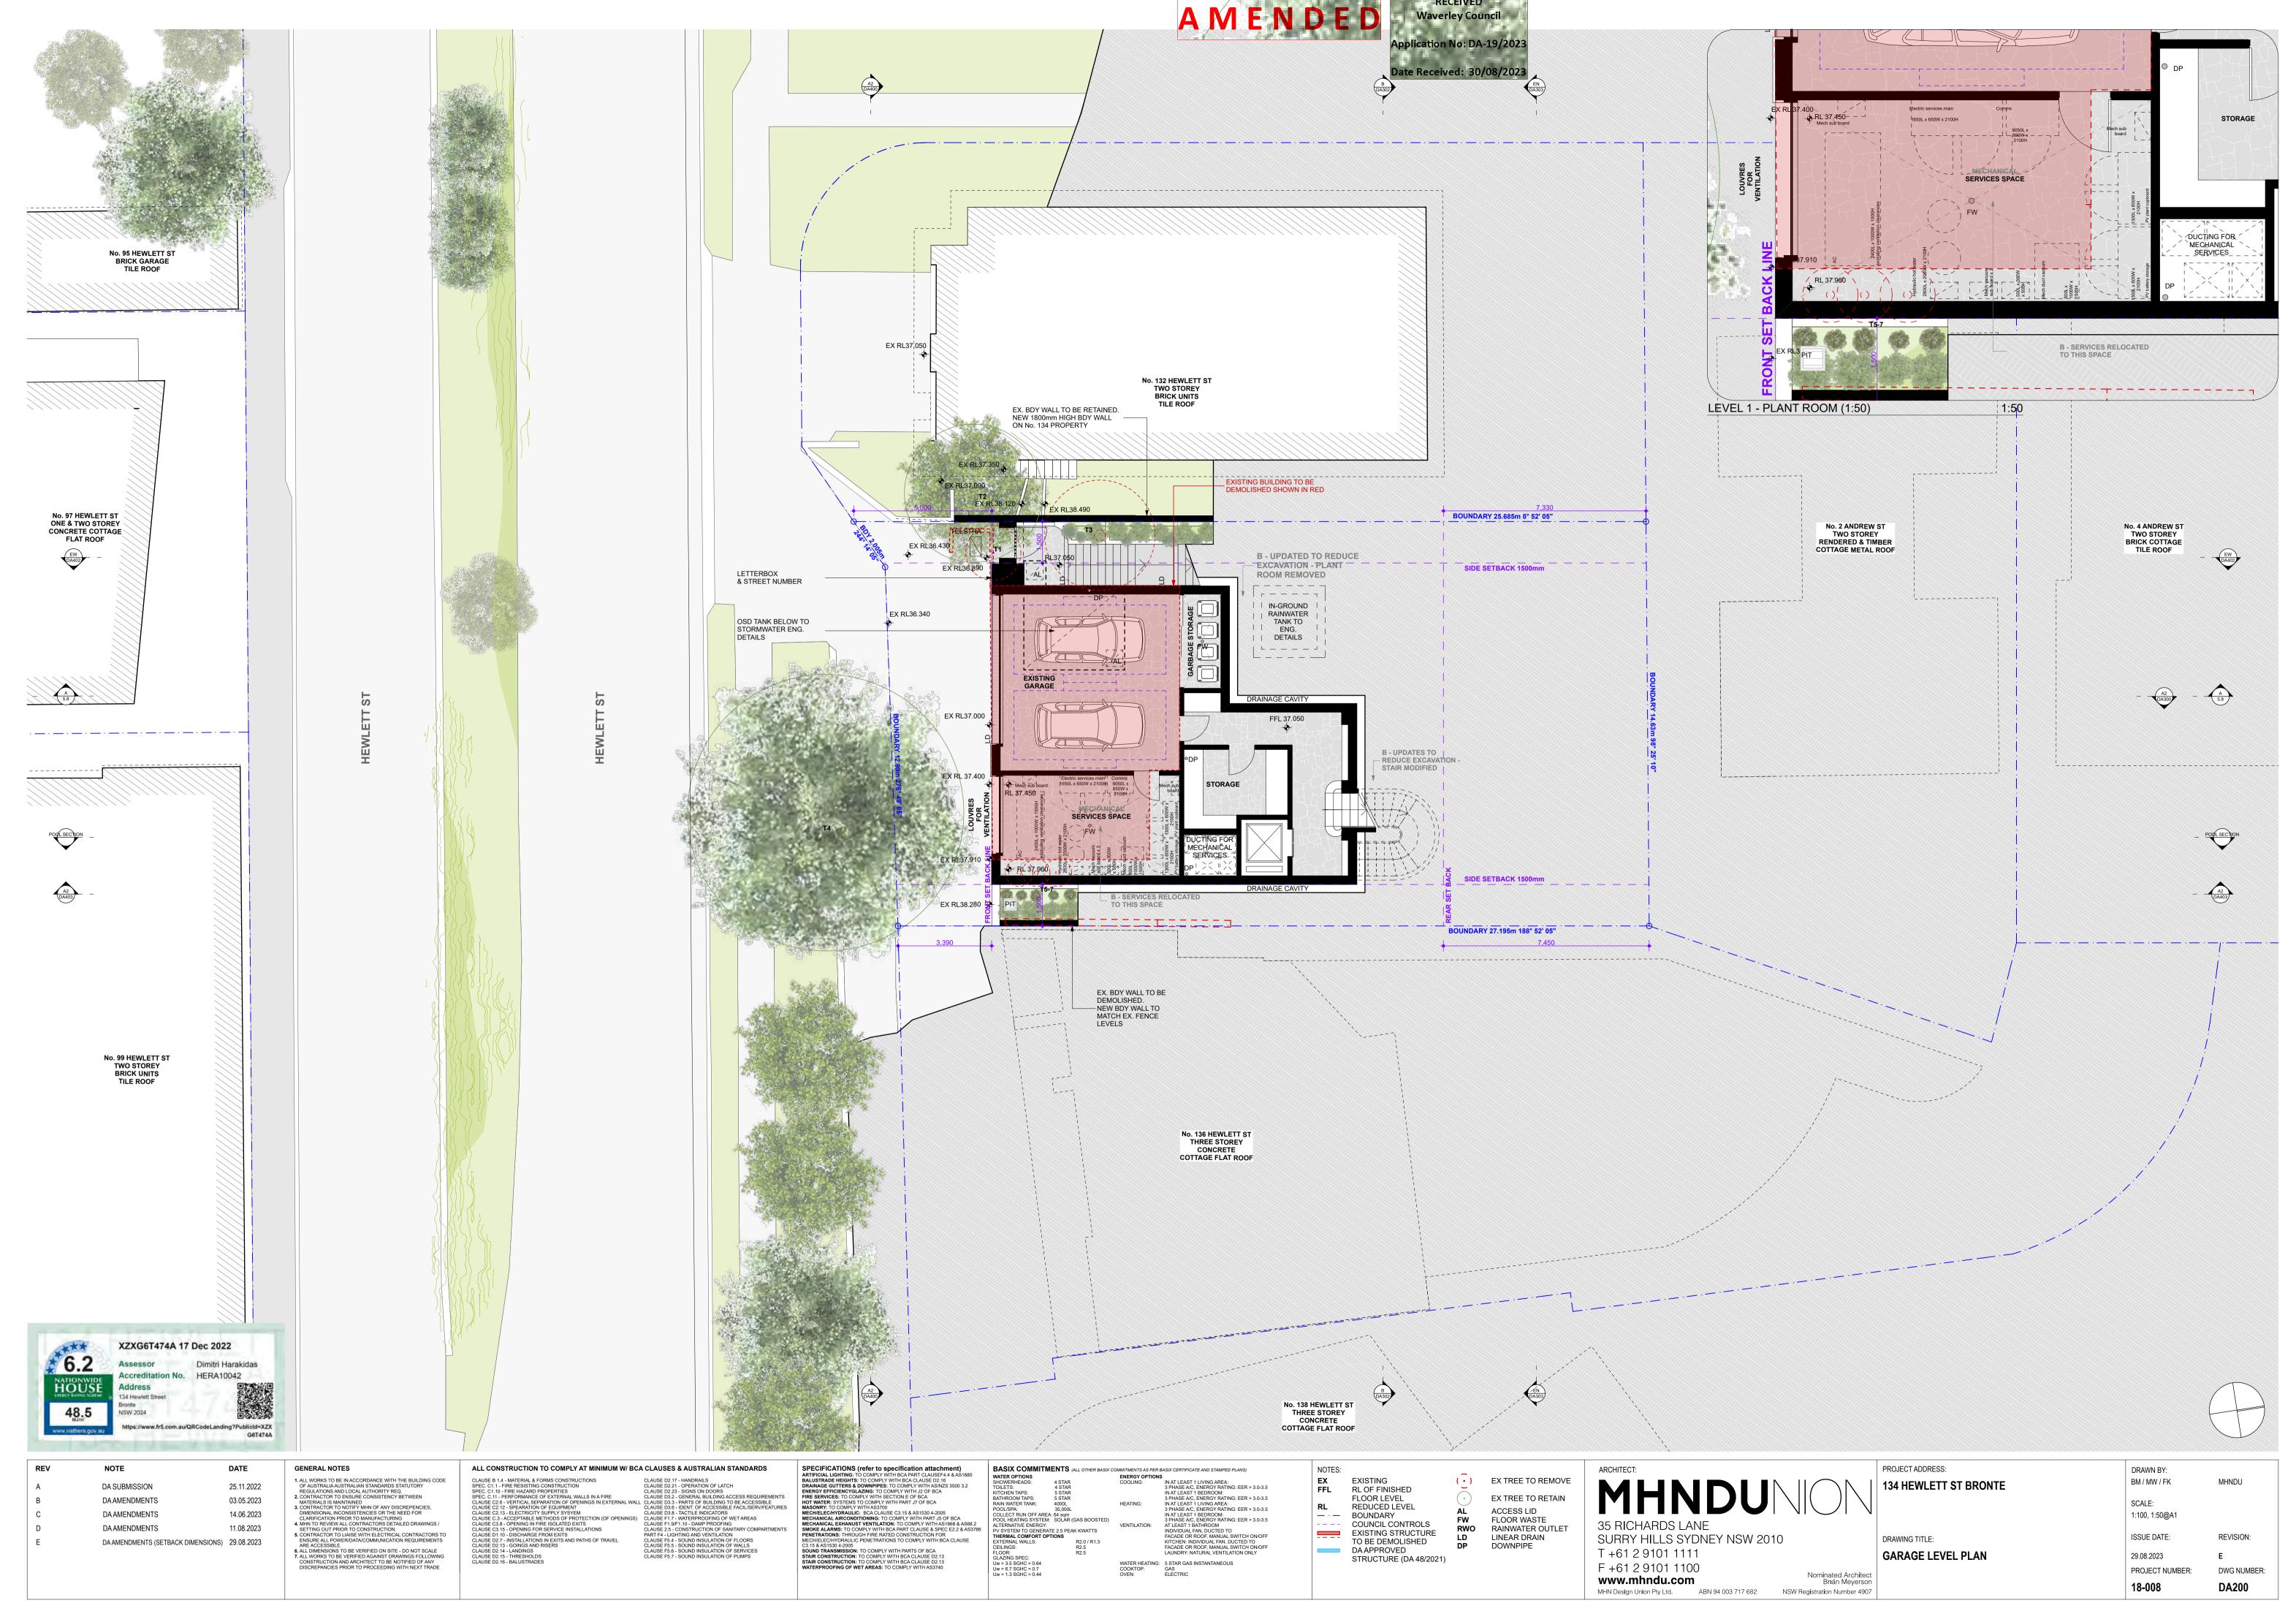
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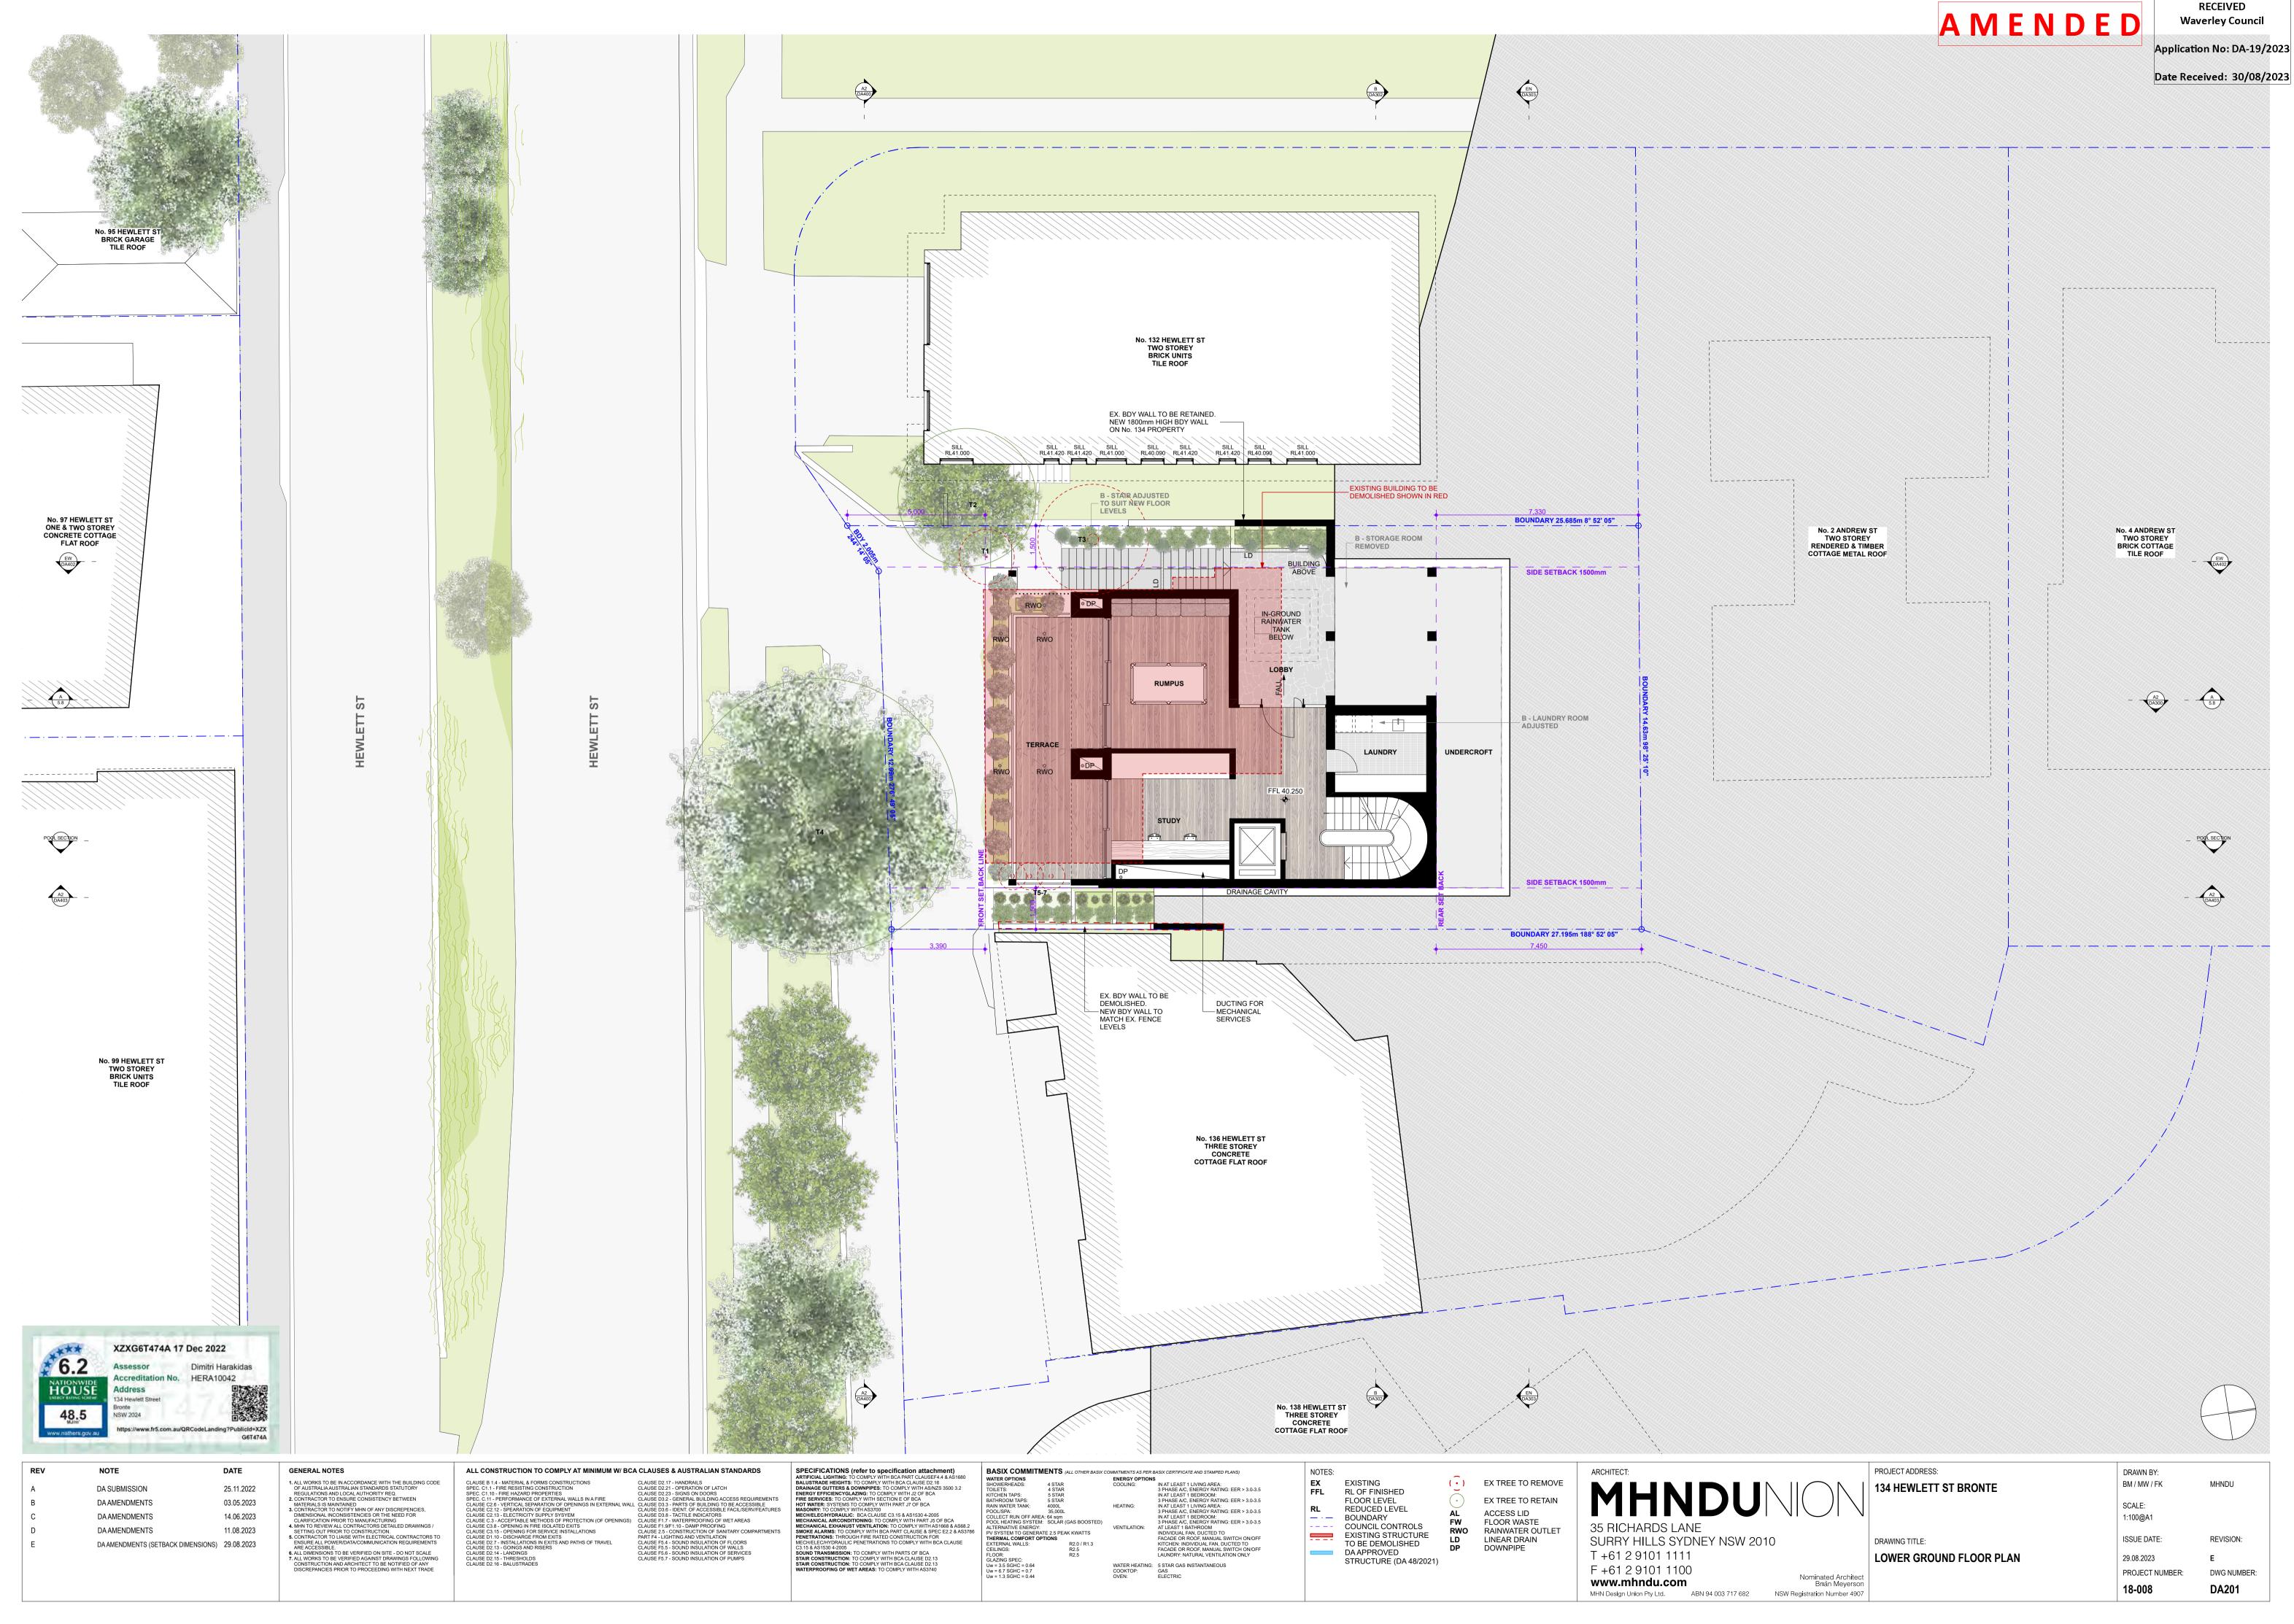
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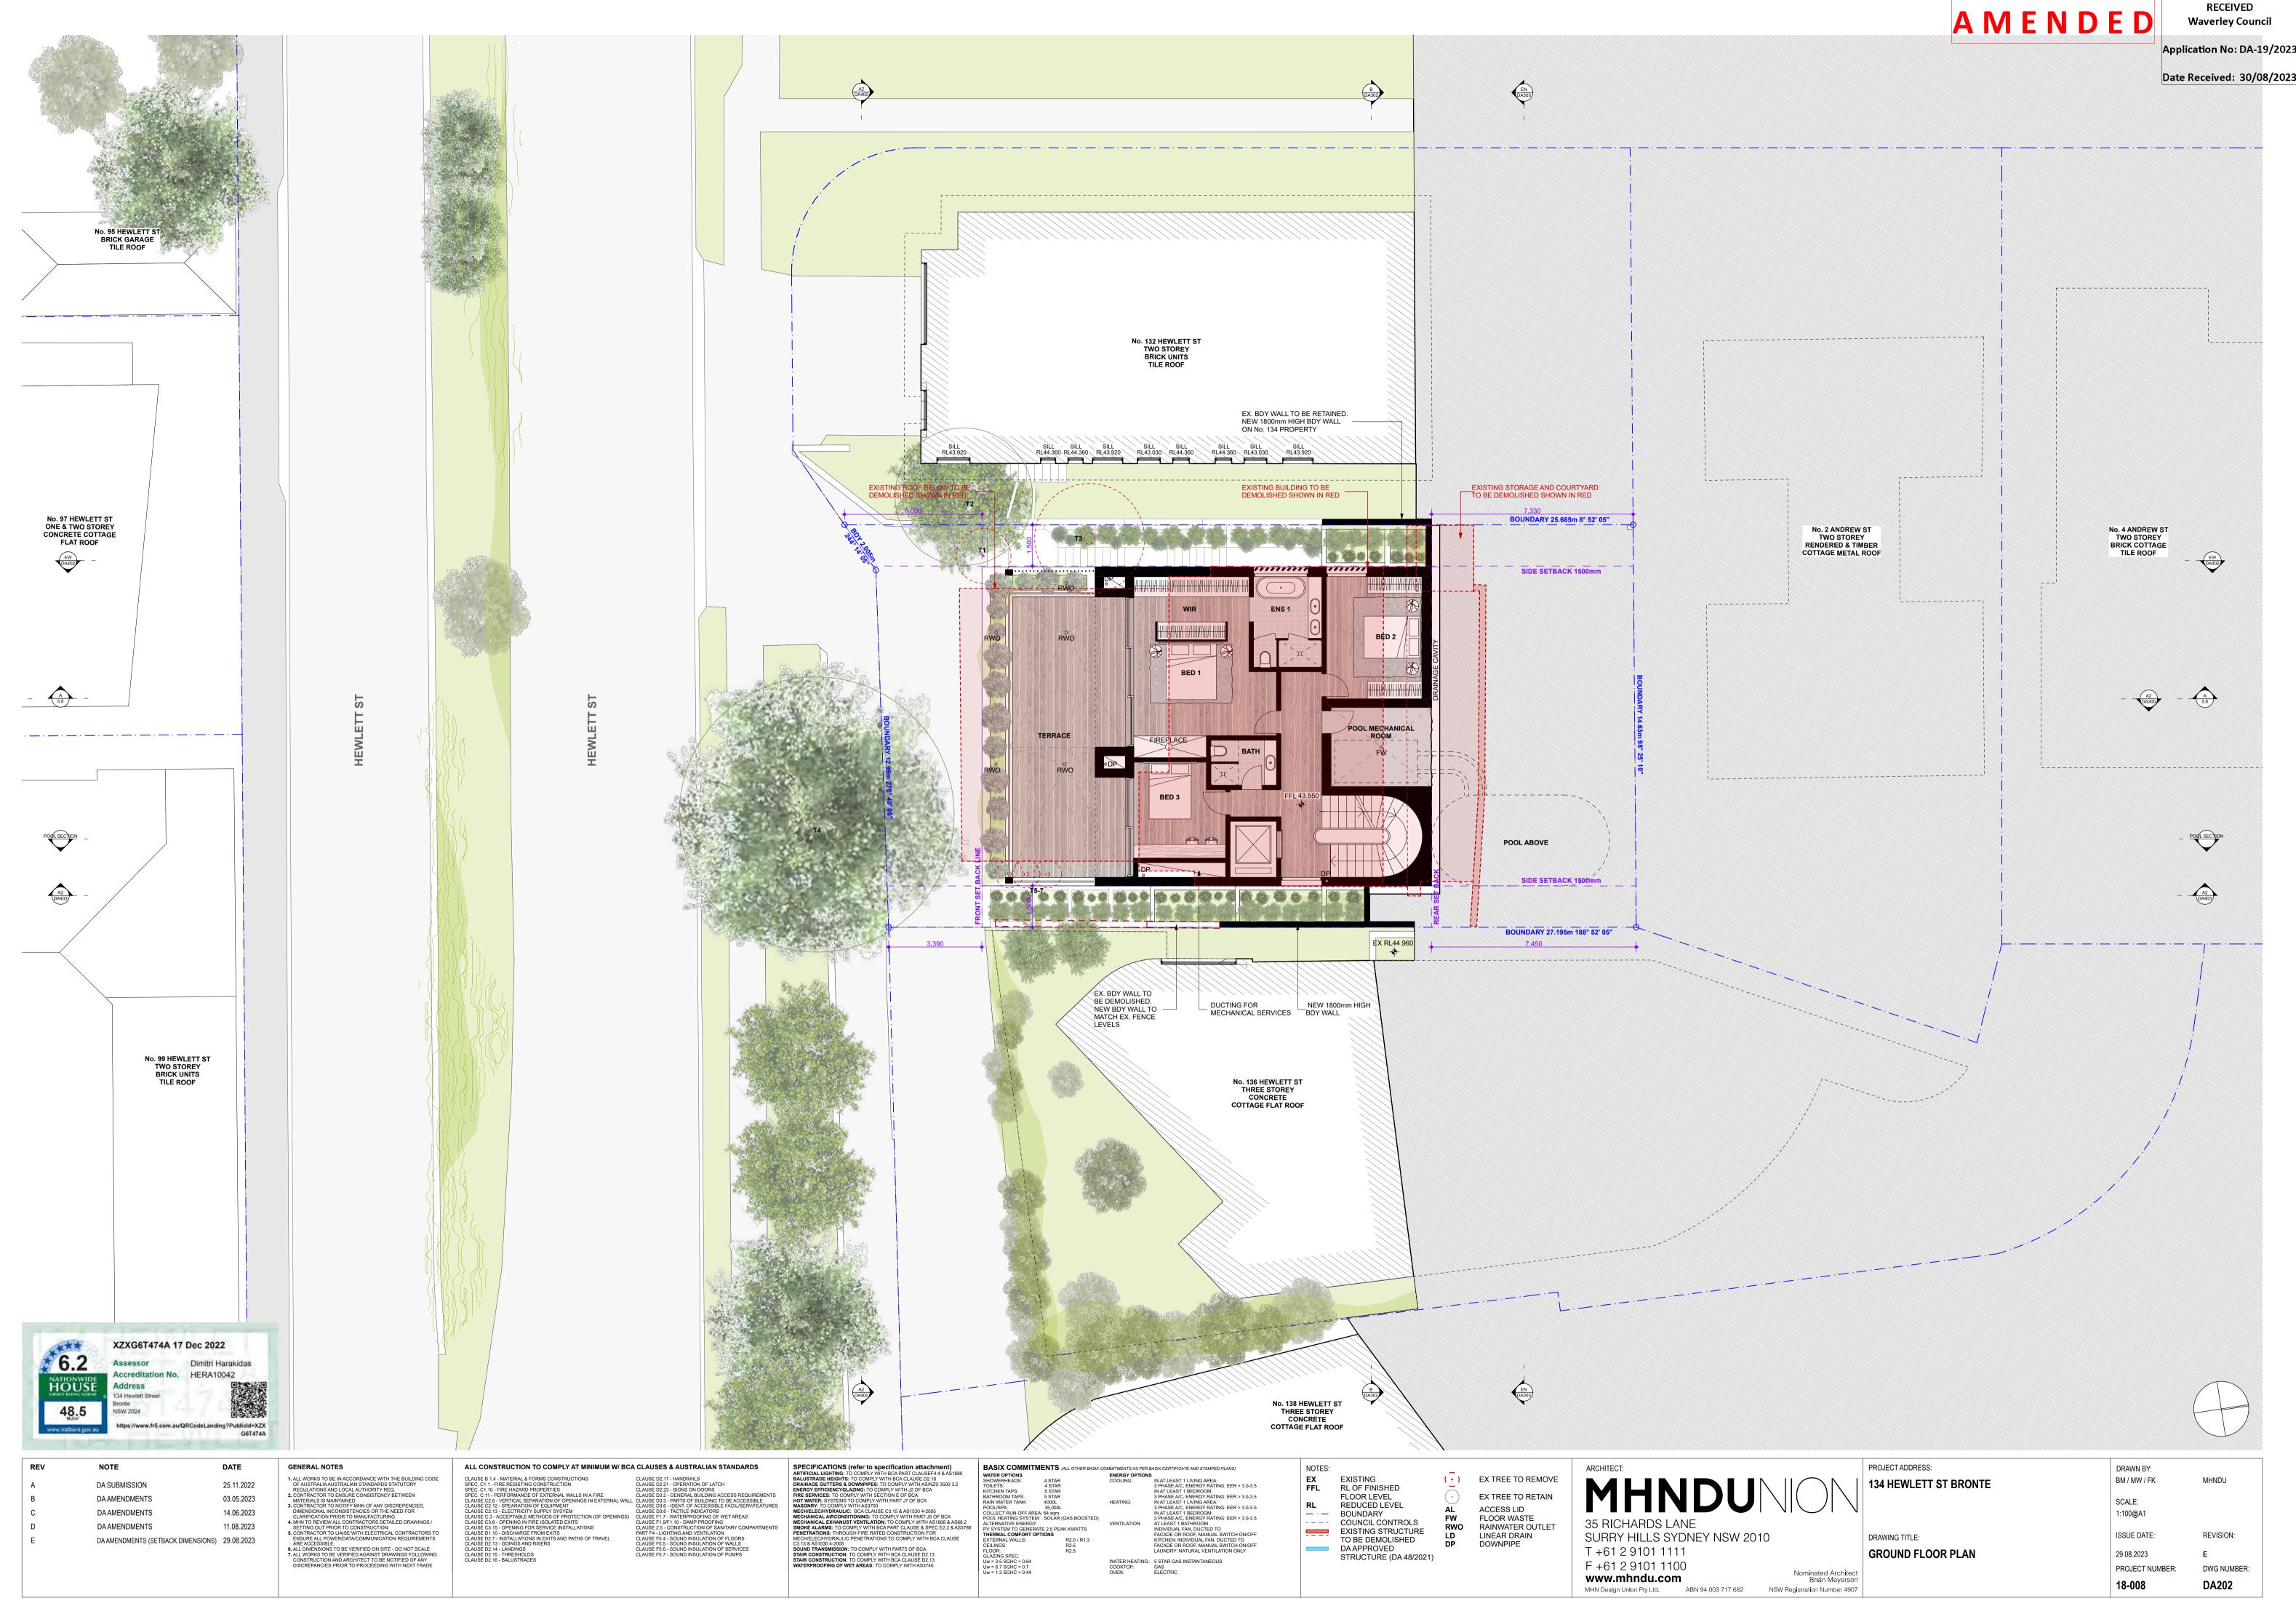
Nominated Architect Brian Meyerson


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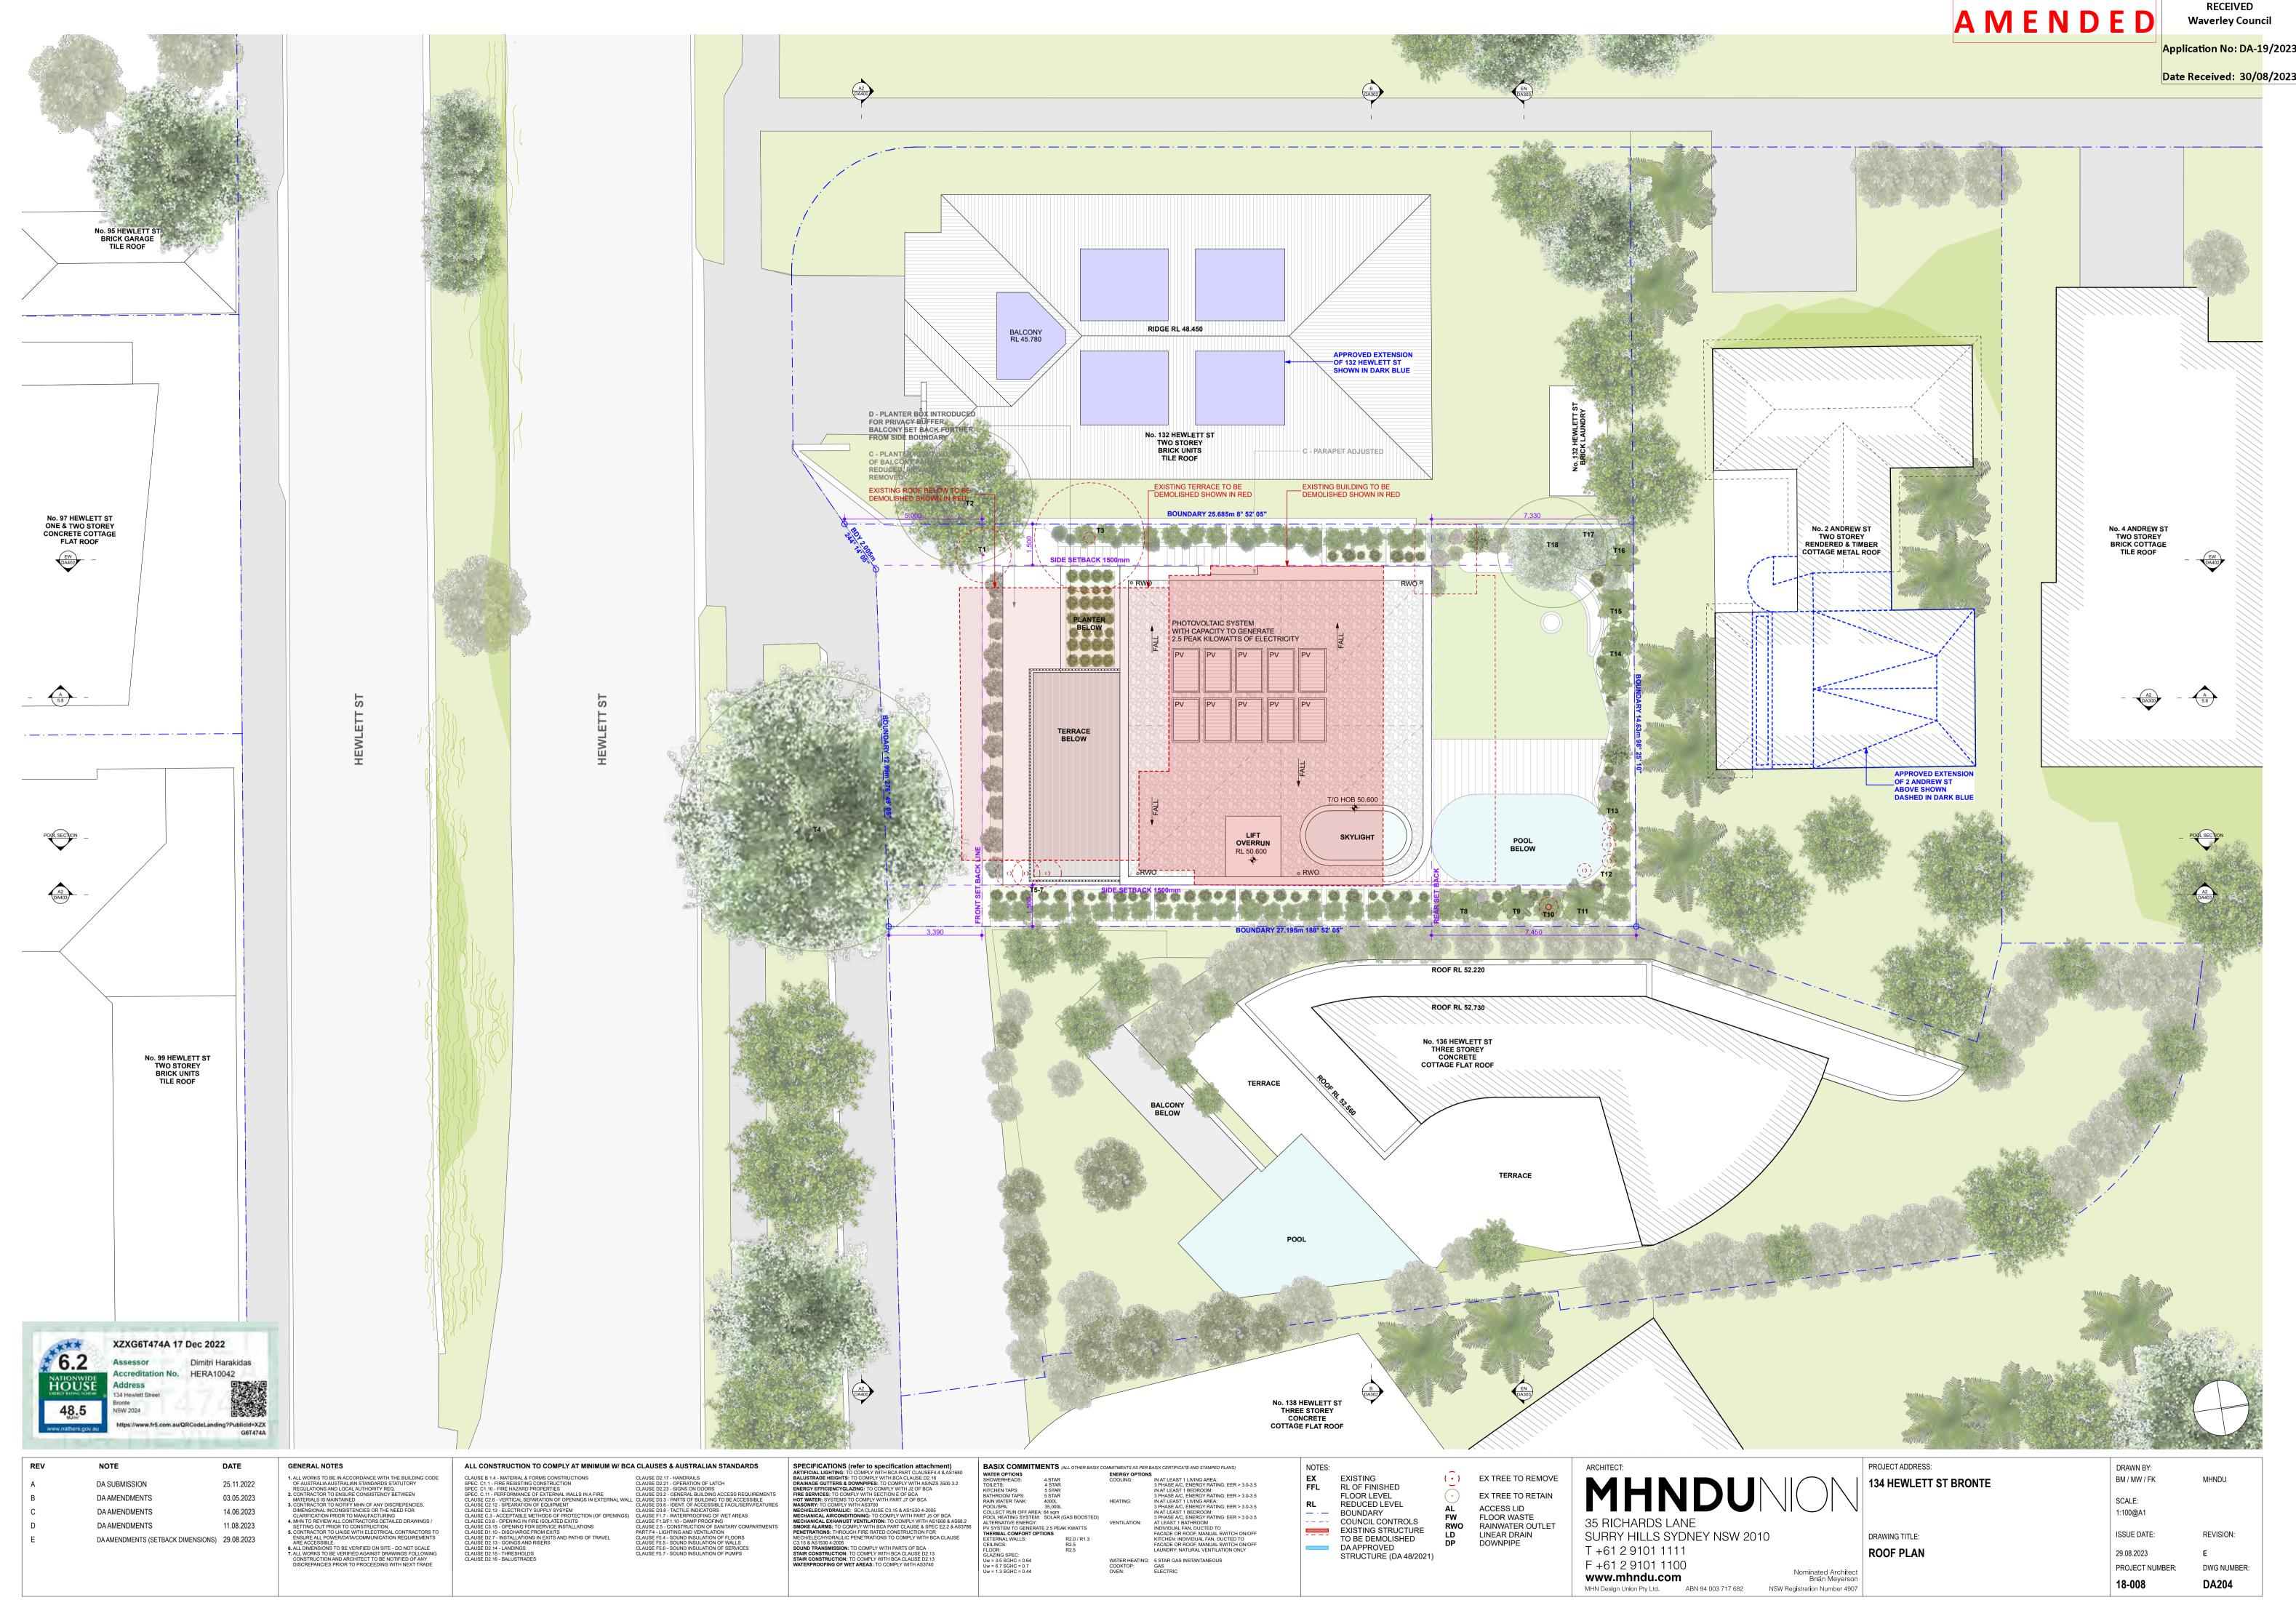










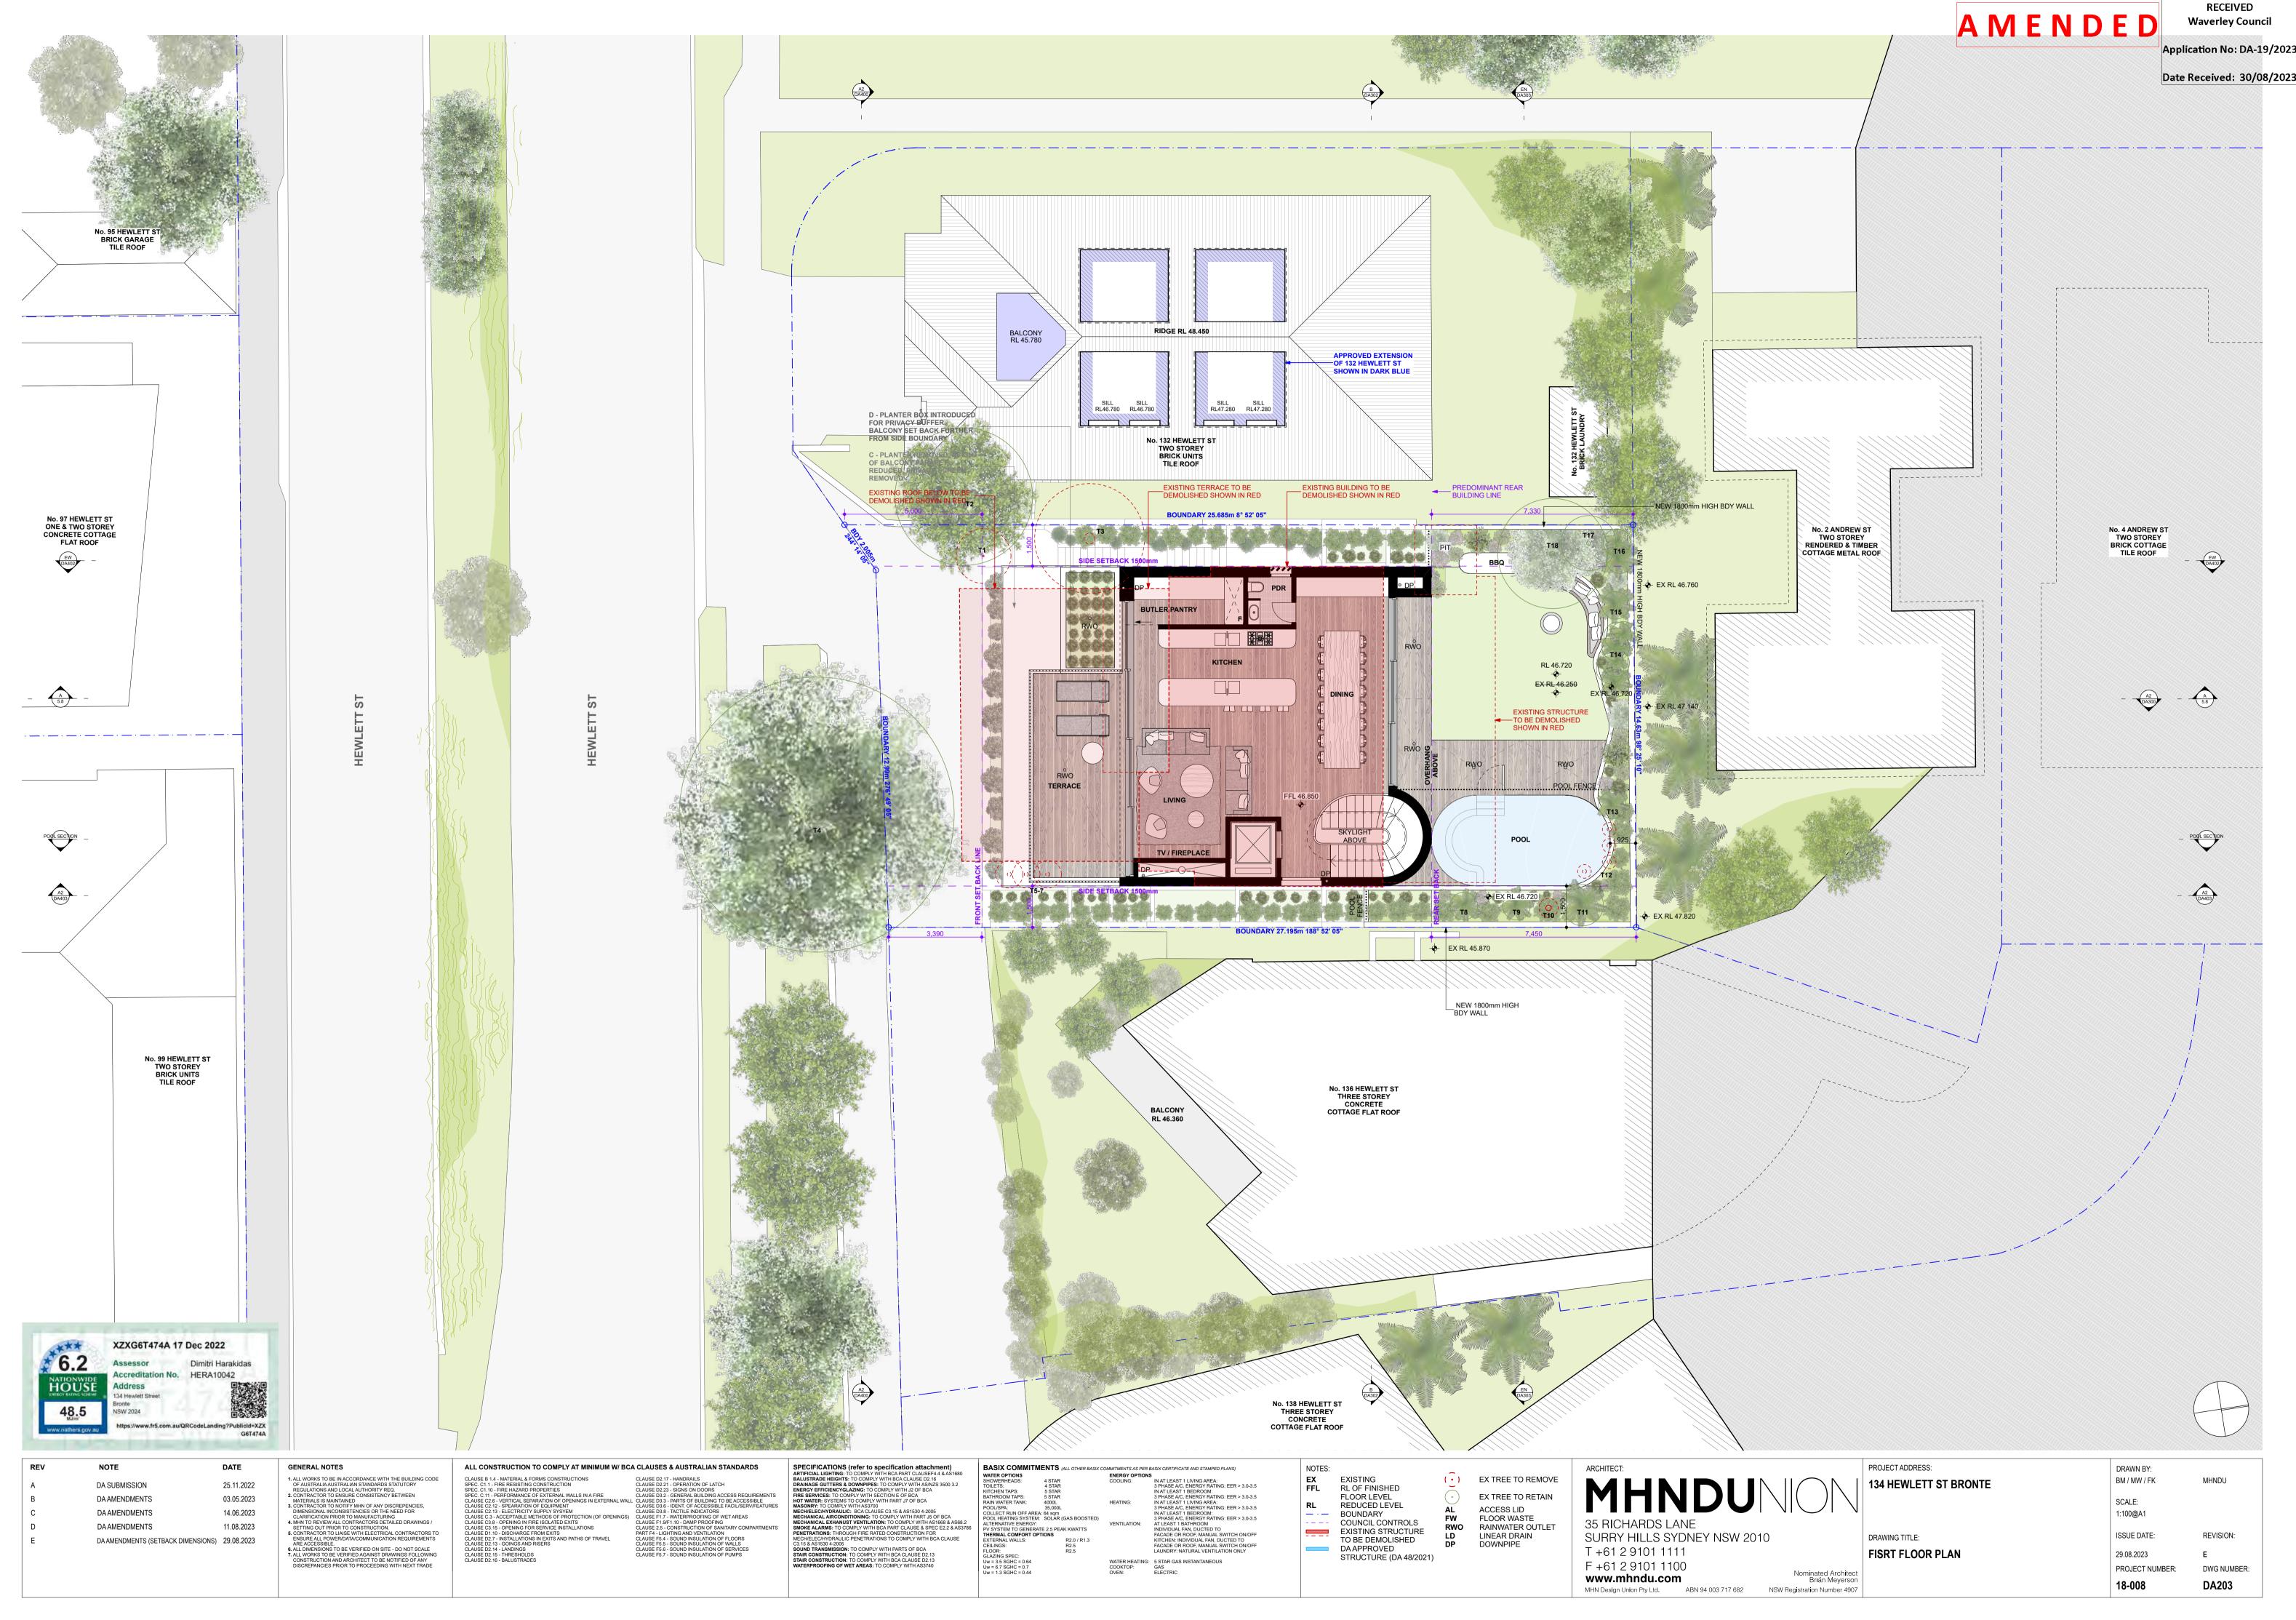

DRAWING TITLE:

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Nominated Architect

Brian Meyerson

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ISSUE DATE:

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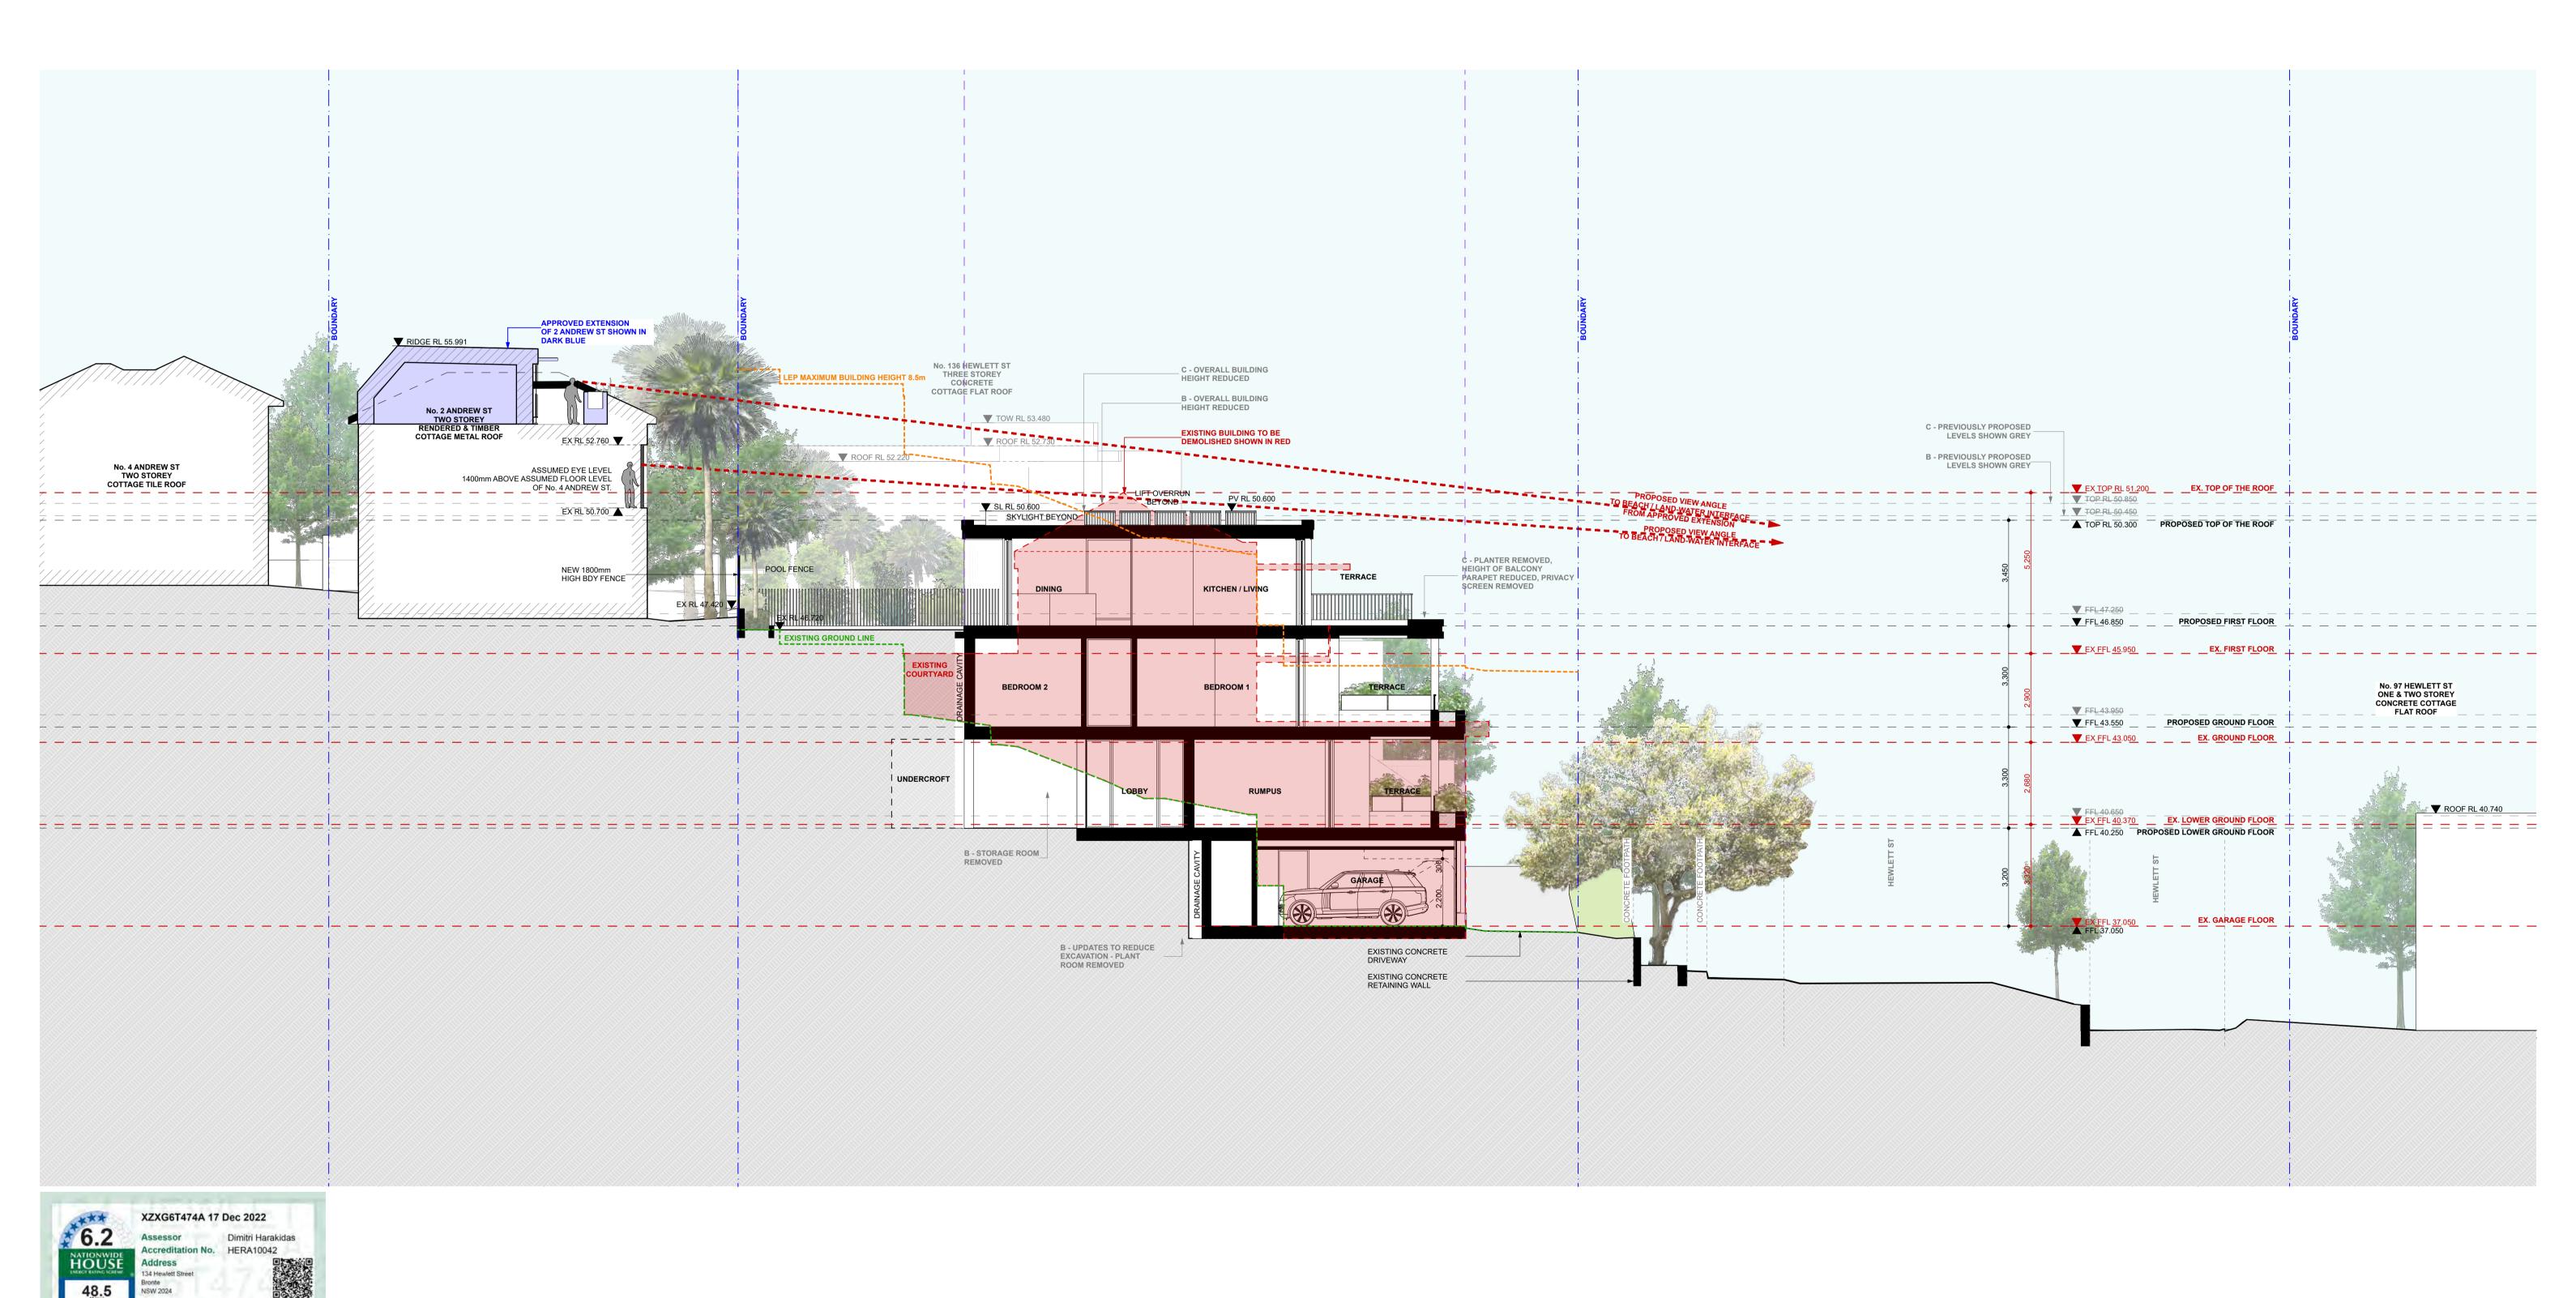
MHNDU

REVISION:

DWG NUMBER:

DA300

Date Received: 30/08/2023



COMMITMENTS AS PER BASIX CERTIFICATE AND STAMPED PLANS)

ENERGY OPTIONS

COOLING:

IN AT LEAST 1 LIVING AREA:
3 PHASE A/C, ENERGY RATING: EER > 3.0-3.5
IN AT LEAST 1 BEDROOM:
3 PHASE A/C, ENERGY RATING: EER > 3.0-3.5
HEATING:
IN AT LEAST 1 LIVING AREA:
3 PHASE A/C, ENERGY RATING: EER > 3.0-3.5
IN AT LEAST 1 BEDROOM:
3 PHASE A/C, ENERGY RATING: EER > 3.0-3.5
VENTILATION:
AT LEAST 1 BEDROOM:
INDIVIDUAL FAN, DUCTED TO
FACADE OR ROOF, MANUAL SWITCH ON/OFF
KITCHEN: INDIVIDUAL FAN, DUCTED TO
FACADE OR ROOF, MANUAL SWITCH ON/OFF
LAUNDRY: NATURAL VENTILATION ONLY

WATER HEATING: 5 STAR GAS INSTANTANEOUS COOKTOP: GAS OVEN: ELECTRIC

BASIX COMMITMENTS (ALL OTHER BASIX COMMITMENTS AS PER BASIX CERTIFICATE AND STAMPED PLANS)

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NOTES:

FFL

EXISTING

RL OF FINISHED

FLOOR LEVEL

BOUNDARY COUNCIL CONTROLS

REDUCED LEVEL

EXISTING STRUCTURE

TO BE DEMOLISHED DA APPROVED

STRUCTURE (DA 48/2021)

SPECIFICATIONS (refer to specification attachment)
ARTIFICIAL LIGHTING: TO COMPLY WITH BCA PART CLAUSEF4.4 & AS1680
BALUSTRADE HEIGHTS: TO COMPLY WITH BCA CLAUSE D2.16
DRAINAGE GUTTERS & DOWNPIPES: TO COMPLY WITH ASINZS 3500 3.2
ENERGY EFFICIENCYGLAZING: TO COMPLY WITH J2 OF BCA
FIRE SERVICES: TO COMPLY WITH SECTION E OF BCA
HOT WATER: SYSTEMS TO COMPLY WITH PART J7 OF BCA
MASORY: TO COMPLY WITH AS700
MECHALICAL AIRCONDITIONING: TO COMPLY WITH PART J5 OF BCA
MECHANICAL EXHANUST VENTILATION: TO COMPLY WITH ASR88 & AS68.2
SMOKE ALARMS: TO COMPLY WITH BCA PART CLAUSE & SPEC E2.2 & AS3786
PENETRATIONS: THROUGH FIRE RATED CONSTRUCTION FOR
MECHALICAL PROBLEM OF THE CONSTRUCTION FOR
MECHALICAL STATE OF SECONDITION OF THE STATE OF SECONDITION FOR STAIR CONSTRUCTION: TO COMPLY WITH PART 5 OF BCA
STAIR CONSTRUCTION: TO COMPLY WITH BCA CLAUSE D2.13
STAIR CONSTRUCTION: TO COMPLY WITH BCA CLAUSE D2.13
STAIR CONSTRUCTION: TO COMPLY WITH BCA CLAUSE D2.13
WATERPROOFING OF WET AREAS: TO COMPLY WITH AS3740

ALL CONSTRUCTION TO COMPLY AT MINIMUM W/ BCA CLAUSES & AUSTRALIAN STANDARDS

CLAUSE B 1.4 - MATERIAL & FORMS CONSTRUCTIONS
SPEC. C1.1 - FIRE RESISTING CONSTRUCTIONS
SPEC. C1.1 - FIRE RESISTING CONSTRUCTION
SPEC. C1.1 - FIRE RESISTING CONSTRUCTION
SPEC. C1.1 - FIRE HAZARD PROPERTIES
CLAUSE C2.6 - VERTICAL SEPARATION OF OPENINGS IN EXTERNAL WALL
CLAUSE C2.6 - VERTICAL SEPARATION OF OPENINGS IN EXTERNAL WALL
CLAUSE C2.6 - VERTICAL SEPARATION OF POENINGS IN EXTERNAL WALL
CLAUSE C2.1 - SELECTRICITY SUPPLY SYSYEM
CLAUSE C2.13 - LECTRICITY SUPPLY SYSYEM
CLAUSE C3.8 - OPENING IN FIRE ISOLATED EXITS
CLAUSE C3.8 - OPENING IN FIRE ISOLATED EXITS
CLAUSE D3.15 - OPENING FOR SERVICE INSTALLATIONS
CLAUSE D3.15 - OPENING FOR SERVICE INSTALLATIONS
CLAUSE D2.7 - INSTALLATIONS IN EXITS AND PATHS OF TRAVEL
CLAUSE D2.7 - INSTALLATIONS IN EXITS AND PATHS OF TRAVEL
CLAUSE D2.14 - LANDINGS
CLAUSE D2.15 - THRESHOLDS
CLAUSE D2.15 - THRESHOLDS
CLAUSE D2.16 - BALUSTRADES

https://www.fr5.com.au/QRCodeLanding?PublicId=XZX

DA AMENDMENTS (SETBACK DIMENSIONS) 29.08.2023

DA SUBMISSION

DA AMENDMENTS

DA AMENDMENTS

DA AMENDMENTS

DATE

25.11.2022

03.05.2023

14.06.2023

11.08.2023

GENERAL NOTES

1. ALL WORKS TO BE IN ACCORDANCE WITH THE BUILDING CODE OF AUSTRALIA AUSTRALIAN STANDARDS STATUTORY REGULATIONS AND LOCAL AUTHORITY REQ.

2. CONTRACTOR TO ENSURE CONSISTENCY BETWEEN MATERIALS IS MAINTAINED

3. CONTRACTOR TO NOTIFY MHN OF ANY DISCREPENCIES, DIMENSIONAL INCONSISTENCIES OR THE NEED FOR CLARIFICATION PRIOR TO MANUFACTURING

4. MIN TO REVIEW ALL CONTRACTORS DETAILED DRAWINGS / SETTING OUT PRIOR TO CONSTRUCTION.

5. CONTRACTOR TO LIAISE WITH ELECTRICAL CONTRACTORS TO ENSURE ALL POWER/DATA/COMMUNICATION REQUIREMENTS ARE ACCESSIBLE.

6. ALL DIMENSIONS TO BE VERIFIED AN SITE - DO NOT SCALE

7. ALL WORKS TO BE VERIFIED AGAINST DRAWINGS FOLLOWING CONSTRUCTION AND ARCHITECT TO BE NOTIFIED OF ANY DISCREPANCIES PRIOR TO PROCEEDING WITH NEXT TRADE

DRAWING TITLE:

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Brian Meyerson

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134 HEWLETT ST BRONTE

DRAWN BY:

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ISSUE DATE:

29.08.2023

18-008

PROJECT NUMBER:

BM / MW / FK

MHNDU

REVISION:


DWG NUMBER:

DA301

Date Received: 30/08/2023

RECEIVED

Application No: DA-19/2023

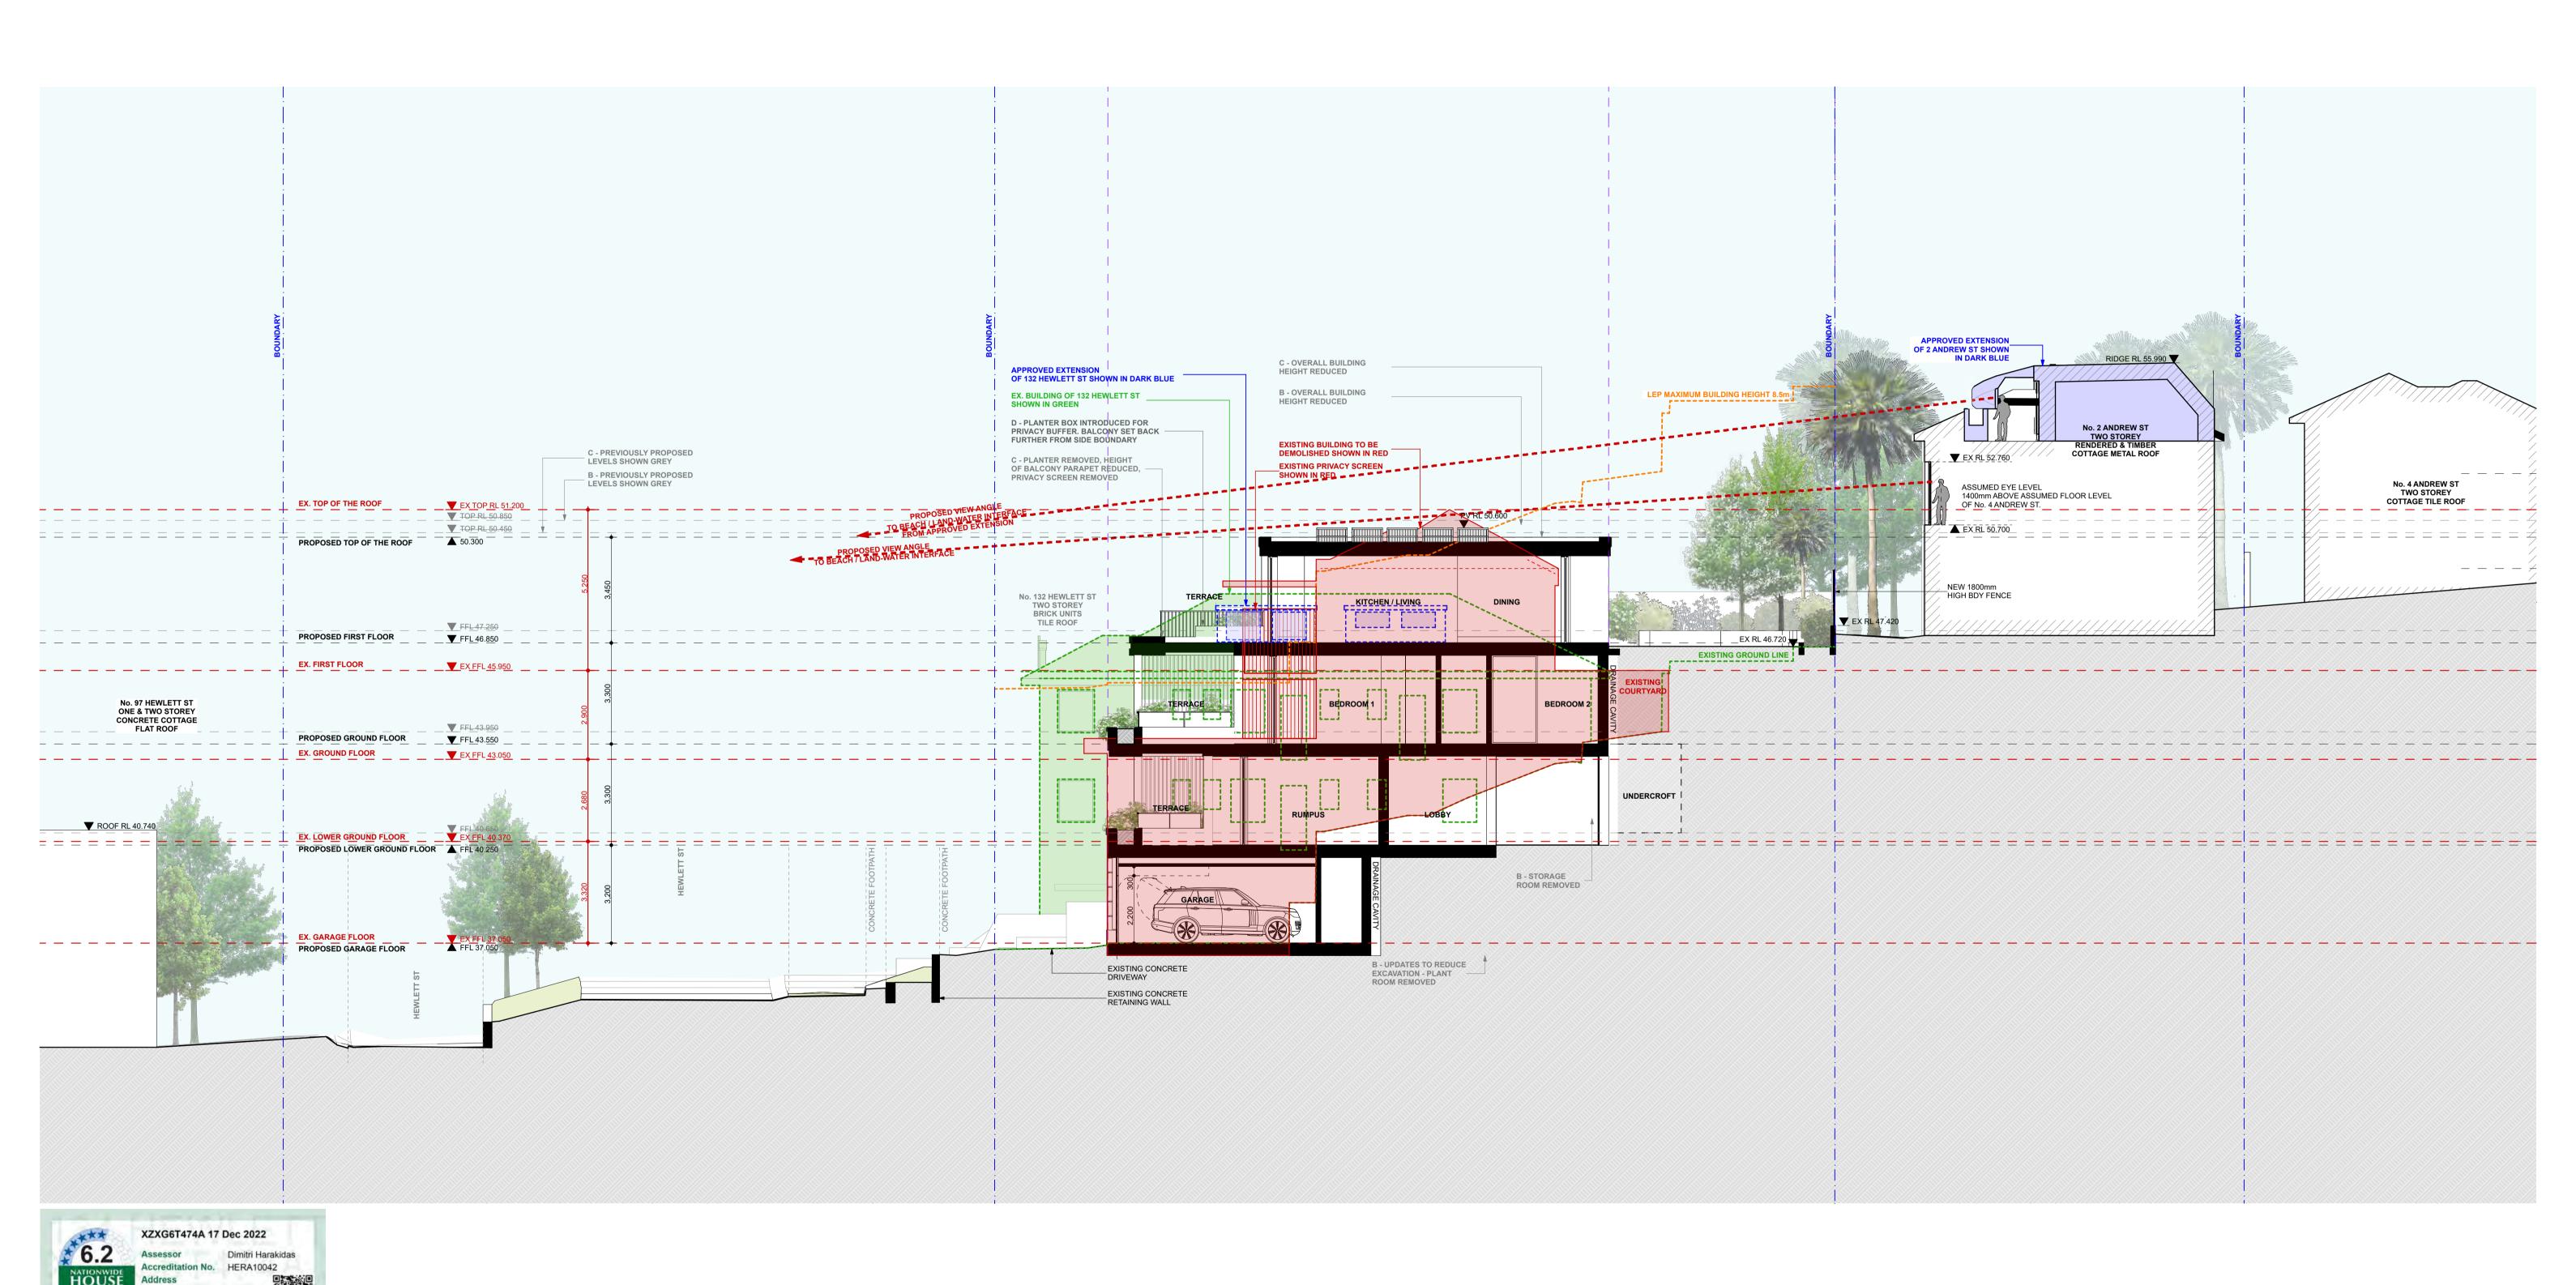

COMMITMENTS AS PER BASIX CERTIFICATE AND STAMPED PLANS)

ENERGY OPTIONS

COOLING:

IN AT LEAST 1 LIVING AREA:
3 PHASE A/C, ENERGY RATING: EER > 3.0-3.5
IN AT LEAST 1 BEDROOM:
3 PHASE A/C, ENERGY RATING: EER > 3.0-3.5
HEATING:
IN AT LEAST 1 LIVING AREA:
3 PHASE A/C, ENERGY RATING: EER > 3.0-3.5
IN AT LEAST 1 BEDROOM:
3 PHASE A/C, ENERGY RATING: EER > 3.0-3.5
IN AT LEAST 1 BEDROOM:
3 PHASE A/C, ENERGY RATING: EER > 3.0-3.5
VENTILATION:
AT LEAST 1 BEDROOM:
INDIVIDUAL FAN, DUCTED TO
FACADE OR ROOF, MANUAL SWITCH ON/OFF
KITCHEN: INDIVIDUAL FAN, DUCTED TO
FACADE OR ROOF, MANUAL SWITCH ON/OFF
LAUNDRY: NATURAL VENTILATION ONLY

WATER HEATING: 5 STAR GAS INSTANTANEOUS COOKTOP: GAS OVEN: ELECTRIC

BASIX COMMITMENTS (ALL OTHER BASIX COMMITMENTS AS PER BASIX CERTIFICATE AND STAMPED PLANS)

BASIX COMMITMENTS (ALL OTHER BASIX
WATER OPTIONS
SHOWERHEADS: 4 STAR
TOILETS: 4 STAR
KITCHEN TAPS: 5 STAR
BATHROOM TAPS: 5 STAR
RAIN WATER TANK: 4000L
POOL/SPA: 35,000L
COLLECT RUN OFF AREA: 64 sqm
POOL HEATING SYSTEM: SOLAR (GAS BOOSTED)
ALTERNATIVE ENERGY:
PV SYSTEM TO GENERATE 2.5 PEAK KWATTS
THERMAL COMFORT OPTIONS

NOTES:

FFL

EXISTING

RL OF FINISHED

FLOOR LEVEL

BOUNDARY COUNCIL CONTROLS

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REDUCED LEVEL

EXISTING STRUCTURE

TO BE DEMOLISHED

STRUCTURE (DA 48/2021)

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MASORY: TO COMPLY WITH AS700
MECHALICAL AIRCONDITIONING: TO COMPLY WITH PART J5 OF BCA
MECHANICAL EXHANUST VENTILATION: TO COMPLY WITH ASR88 & AS68.2
SMOKE ALARMS: TO COMPLY WITH BCA PART CLAUSE & SPEC E2.2 & AS3786
PENETRATIONS: THROUGH FIRE RATED CONSTRUCTION FOR
MECHALICAL PROBLEM OF THE CONSTRUCTION FOR
MECHALICAL STATE OF SECONDITION OF THE STATE OF SECONDITION FOR STAIR CONSTRUCTION: TO COMPLY WITH PART 5 OF BCA
STAIR CONSTRUCTION: TO COMPLY WITH BCA CLAUSE D2.13
STAIR CONSTRUCTION: TO COMPLY WITH BCA CLAUSE D2.13
STAIR CONSTRUCTION: TO COMPLY WITH BCA CLAUSE D2.13
WATERPROOFING OF WET AREAS: TO COMPLY WITH AS3740

ALL CONSTRUCTION TO COMPLY AT MINIMUM W/ BCA CLAUSES & AUSTRALIAN STANDARDS

CLAUSE B 1.4 - MATERIAL & FORMS CONSTRUCTIONS

SPEC. C.1.1 - FIRE RESISTING CONSTRUCTIONS

SPEC. C.1.1 - FIRE RESISTING CONSTRUCTION

SPEC. C.1.1 - FIRE RESISTING CONSTRUCTION

SPEC. C.1.1 - FIRE HAZARD PROPERTIES

SPEC. C.1.1 - PERFORMANCE OF EXTERNAL WALLS IN A FIRE

CLAUSE C.2.6 - VERTICAL SEPARATION OF OPENINGS IN EXTERNAL WALL

CLAUSE C.2.6 - VERTICAL SEPARATION OF OPENINGS IN EXTERNAL WALL

CLAUSE C.2.19 - ELECTRICITY SUPPLY SYSYEM

CLAUSE C.2.3 - ACCEPTABLE METHODS OF PROTECTION (OF OPENINGS)

CLAUSE C.3.5 - ACCEPTABLE METHODS OF PROTECTION (OF OPENINGS)

CLAUSE C.3.6 - DENTI. OF ACCESSIBLE FACILISERV/FEATURES

CLAUSE C.3.6 - DENTI. OF ACCESSIBLE FACILISERV/FEATURES

CLAUSE C.3.6 - ACCEPTABLE METHODS OF PROTECTION (OF OPENINGS)

CLAUSE C.3.6 - OPENING IN FIRE ISOLATED EXITS

CLAUSE C.2.7 - INSTALLATIONS IN EXITS AND PATHS OF TRAVEL

CLAUSE D.2.7 - INSTALLATIONS IN EXITS AND PATHS OF TRAVEL

CLAUSE D.2.17 - INSTALLATIONS IN EXITS AND PATHS OF TRAVEL

CLAUSE D.2.14 - LANDINGS

CLAUSE D.2.14 - LANDINGS

CLAUSE D.2.15 - THRESHOLDS

CLAUSE D.2.15 - THRESHOLDS

CLAUSE D.2.16 - BALUSTRADES

134 Hewlett Street NSW 2024

DA SUBMISSION

DA AMENDMENTS

DA AMENDMENTS

DA AMENDMENTS

https://www.fr5.com.au/QRCodeLanding?PublicId=XZX

DA AMENDMENTS (SETBACK DIMENSIONS) 29.08.2023

DATE

25.11.2022

03.05.2023

14.06.2023

11.08.2023

GENERAL NOTES

1. ALL WORKS TO BE IN ACCORDANCE WITH THE BUILDING CODE OF AUSTRALIA AUSTRALIAN STANDARDS STATUTORY REGULATIONS AND LOCAL AUTHORITY REQ.

2. CONTRACTOR TO ENSURE CONSISTENCY BETWEEN MATERIALS IS MAINTAINED

3. CONTRACTOR TO NOTIFY MHN OF ANY DISCREPENCIES, DIMENSIONAL INCONSISTENCIES OR THE NEED FOR CLARIFICATION PRIOR TO MANUFACTURING

4. MIN TO REVIEW ALL CONTRACTORS DETAILED DRAWINGS / SETTING OUT PRIOR TO CONSTRUCTION.

5. CONTRACTOR TO LIAISE WITH ELECTRICAL CONTRACTORS TO ENSURE ALL POWER/DATA/COMMUNICATION REQUIREMENTS ARE ACCESSIBLE.

6. ALL DIMENSIONS TO BE VERIFIED AN SITE - DO NOT SCALE

7. ALL WORKS TO BE VERIFIED AGAINST DRAWINGS FOLLOWING CONSTRUCTION AND ARCHITECT TO BE NOTIFIED OF ANY DISCREPANCIES PRIOR TO PROCEEDING WITH NEXT TRADE

RECEIVED Waverley Council

Application No: DA-19/2023

Date Received: 30/08/2023

APPROVED EXTENSION
OF 2 ANDREW ST SHOWN IN
DARK BLUE RIDGE RL 55.990 LEP MAXIMUM BUILDING HEIGHT 8.5m ▼ RL 54.790 ▼ RL 54.470 No. 2 ANDREW ST TWO STOREY RENDERED & TIMBER COTTAGE METAL ROOF _ C - PREVIOUSLY PROPOSED LEVELS SHOWN GREY B - PREVIOUSLY PROPOS LEVELS SHOWN GREY ▼ TOP RL 50.450 ▼ ▲ TOP RL 50.300 PROPOSED TOP OF THE ROOF APPROVED EXTENSION OF 132 HEWLETT ST SHOWN IN DARK BLUE __NEW 1800mm HIGH BDY FENCE No. 136 HEWLETT ST
THREE STOREY
CONCRETE
COTTAGE FLAT ROOF No. 138 HEWLETT ST MULTI STOREY CONCRETE COTTAGE No. 140 HEWLETT ST MULTI STOREY CONCRETE COTTAGE FFL 47.250 ____METAL_ROOF SECOND FLOOR FFL 45.780 No. 132 HEWLETT ST TWO STOREY BRICK UNITS TILE ROOF NEW 1800mm HIGH BDY FENCE FFL 43.950 PROPOSED GROUND FLOOR ▼ FIRST FLOOR FFL 43.080 EX. GROUND FLOOR EX FFL43.050 EX. LOWER GROUND FLOOR EX FFL 40.650

PROPOSED LOWER GROUND FLOOR FFL 40.250 GROUND FLOOR FFL 40.170-___ D - STORAGE ROOM_ REMOVED

B - UPDATES TO REDUCE EXCAVATION -STAIRS ADJUSTED

GARAGE LEVEL FFL 37.070




EX. GARAGE FLOOR PROPOSED GARAGE FLOOR FFL 37.050 FFL 37.050


REV	NOTE	DATE	GENERAL NOTES	ALL CONSTRUCTION TO COMPLY AT MINIMUM W/ BCA CLAUSE	SES & AUSTRALIAN STANDARDS	SPECIFICATIONS (refer to specification attachment) ARTIFICIAL LIGHTING: TO COMPLY WITH BCA PART CLAUSEF4.4 & AS1680	BASIX COMMITMENTS (ALL OTHER BASIX WATER OPTIONS	COMMITMENTS AS PER BASIX CERTIFICATE AND STAMPED PLANS)	NOTES:	ARCHITECT:	PROJECT ADDRESS:	DRAWN BY:	
A	DA SUBMISSION	25.11.2022	ALL WORKS TO BE IN ACCORDANCE WITH THE BUILDING CODE OF AUSTRALIA AUSTRALIAN STANDARDS STATUTORY REGULATIONS AND LOCAL AUTHORITY REQ.	SPEC. C1.1 - FIRE RESISTING CONSTRUCTION CLAUSE D2	D2.17 - HANDRAILS D2.21 - OPERATION OF LATCH D2.23 - SIGNS ON DOORS	BALUSTRADE HEIGHTS: TO COMPLY WITH BCA CLAUSE D2.16 DRAINAGE GUTTERS & DOWNPIPES: TO COMPLY WITH AS/NZS 3500 3.2 ENERGY EFFICIENCYGLAZING: TO COMPLY WITH JZ OF BCA	SHOWERHEADS: 4 STAR TOILETS: 4 STAR KITCHEN TAPS: 5 STAR	ENERGY OPTIONS COOLING: IN AT LEAST 1 LIVING AREA: 3 PHASE A/C, ENERGY RATING: EER > 3.0-3.5 IN AT LEAST 1 EPERDOM:	EX EXISTING FFL RL OF FINISHED	MHNDUNO	134 HEWLETT ST BRONTE	BM / MW / FK	MHNDU
В	DA AMENDMENTS	03.05.2023	CONTRACTOR TO ENSURE CONSISTENCY BETWEEN MATERIALS IS MAINTAINED CONTRACTOR TO NOTIFY MHN OF ANY DISCREPENCIES.	SPEC. C.11 - PERFORMANCE OF EXTERNAL WALLS IN A FIRE CLAUSE DS CLAUSE C2.6 - VERTICAL SEPARATION OF OPENINGS IN EXTERNAL WALL CLAUSE DS CLAUSE C2.12 - SPEARATION OF EQUIPMENT CLAUSE DS	D3.2 - GENERAL BUILDING ACCESS REQUIREMENTS D3.3 - PARTS OF BUILDING TO BE ACCESSIBLE D3.6 - IDENT. OF ACCESSIBLE FACIL/SERV/FEATURES	FIRE SERVICES: TO COMPLY WITH SECTION E OF BCA HOT WATER: SYSTEMS TO COMPLY WITH PART J7 OF BCA MASONRY: TO COMPLY WITH AS3700	BATHROOM TAPS: 5 STAR RAIN WATER TANK: 4000L	3 PHASE A/C, ENERGY RATING: EER > 3.0-3.5 HEATING: IN AT LEAST 1 LIVING AREA: 3 PHASE A/C, ENERGY PATING: EEP > 3.0.3.5	FLOOR LEVEL RL REDUCED LEVEL			SCALE:	
С	DA AMENDMENTS	14.06.2023	DIMENSIONAL INCONSISTENCIES OR THE NEED FOR CLARIFICATION PRIOR TO MANUFACTURING	CLAUSE C2.13 - ELECTRICITY SUPPLY SYSYEM CLAUSE C3 ACCEPTABLE METHODS OF PROTECTION (OF OPENINGS) CLAUSE F1	D3.8 - TACTILE INDICATORS F1.7 - WATER PROPRIES OF WET AREAS	MECH/ELEC/HYDRAULIC: BCA CLAUSE C3.15 & AS1530 4-2005 MECHANICAL AIRCONDITIONING: TO COMPLY WITH PART J5 OF BCA	COLLECT RUN OFF AREA: 64 sqm POOL HEATING SYSTEM: SOLAR (GAS BOOSTED)	IN AT LEAST 1 BEDROOM: 3 PHASE A/C, ENERGY RATING: EER > 3.0-3.5	— · — BOUNDARY		V	1:100@A1	
D	DA AMENDMENTS	11.08.2023	MIN TO REVIEW ALL CONTRACTORS DETAILED DRAWINGS / SETTING OUT PRIOR TO CONSTRUCTION. CONTRACTOR TO LIAISE WITH ELECTRICAL CONTRACTORS TO	CLAUSE C3.6 - OPENING IN FIRE ISOLATED EXITS CLAUSE C3.15 - OPENING FOR SERVICE INSTALLATIONS CLAUSE D1.10 - DISCHARGE FROM EXITS PART F4 - L	F1.9F1.10 - DAMP PROOFING 2.5 - CONSTRUCTION OF SANITARY COMPARTMENTS - LIGHTING AND VENTILATION	MECHANICAL EXHANDS! VENTILATION: 10 COMPLY WITH AS1668 & AS68.2 SMOKE ALARMS: TO COMPLY WITH BCA PART CLAUSE & SPEC E2.2 & AS3786 PENETRATIONS: THROUGH FIRE RATED CONSTRUCTION FOR	ALTERNATIVE ENERGY: PV SYSTEM TO GENERATE 2.5 PEAK KWATTS THERMAL COMFORT OPTIONS	VENTILATION: AT LEAST 1 BATHROOM INDIVIDUAL FAN, DUCTED TO FACADE OR ROOF, MANUAL SWITCH ON/OFF	COUNCIL CONTROLS EXISTING STRUCTURE	35 RICHARDS LANE	PD 111111 5	ISSUE DATE:	REVISION:
E	DA AMENDMENTS (SETBACK DIMENS	SIONS) 29.08.2023	ENSURE ALL POWER/DATA/COMMUNICATION REQUIREMENTS ARE ACCESSIBLE ALL DIMENSIONS TO BE VERIFIED ON SITE DO NOT SCALE		F5.4 - SOUND INSULATION OF FLOORS F5.5 - SOUND INSULATION OF WALLS F5.6 - SOUND INSULATION OF SERVICES	MECH/ELEC/HYDRAULIC PENETRATIONS TO COMPLY WITH BCA CLAUSE C3.15 & AS1530 4-2005 SQUIND TRANSMISSION, TO COMPLY WITH PARTS OF BCA	EXTERNAL WALLS: R2.0 / R1.3 CEILINGS: R2.5	KITCHEN: INDIVIDUAL FAN, DUCTED TO FACADE OR ROOF, MANUAL SWITCH ON/OFF	TO BE DEMOLISHED DA APPROVED	SURRY HILLS SYDNEY NSW 2010	DRAWING ITILE:	1330L DATE.	REVISION.
			ALL WORKS TO BE VERIFIED AGAINST DRAWINGS FOLLOWING CONSTRUCTION AND ARCHITECT TO BE NOTIFIED OF ANY		F5.7 - SOUND INSULATION OF PUMPS	STAIR CONSTRUCTION: TO COMPLY WITH BCA CLAUSE D2.13 STAIR CONSTRUCTION: TO COMPLY WITH BCA CLAUSE D2.13	FLOOR: R2.5 GLAZING SPEC: Uw = 3.5 SGHC = 0.64	LAUNDRY: NATURAL VENTILATION ONLY WATER HEATING: 5 STAR GAS INSTANTANEOUS	STRUCTURE (DA 48/2021)	T +61 2 9101 1111	SECTION B	29.08.2023	E
			DISCREPANCIES PRIOR TO PROCEEDING WITH NEXT TRADE			WATERPROOFING OF WET AREAS: TO COMPLY WITH AS3740	Uw = 6.7 SGHC = 0.7 Uw = 1.3 SGHC = 0.44	COOKTOP: GAS OVEN: ELECTRIC		F +61 2 9101 1100	chitect	PROJECT NUMBER:	DWG NUMBER
										www.mhndu.com Brian Me MHN Design Union Pty Ltd. ABN 94 003 717 682 NSW Registration Numb	yerson er 4907	18-008	DA302




RECEIVED **Waverley Council**

Application No: DA-19/2023 Date Received: 30/08/2023

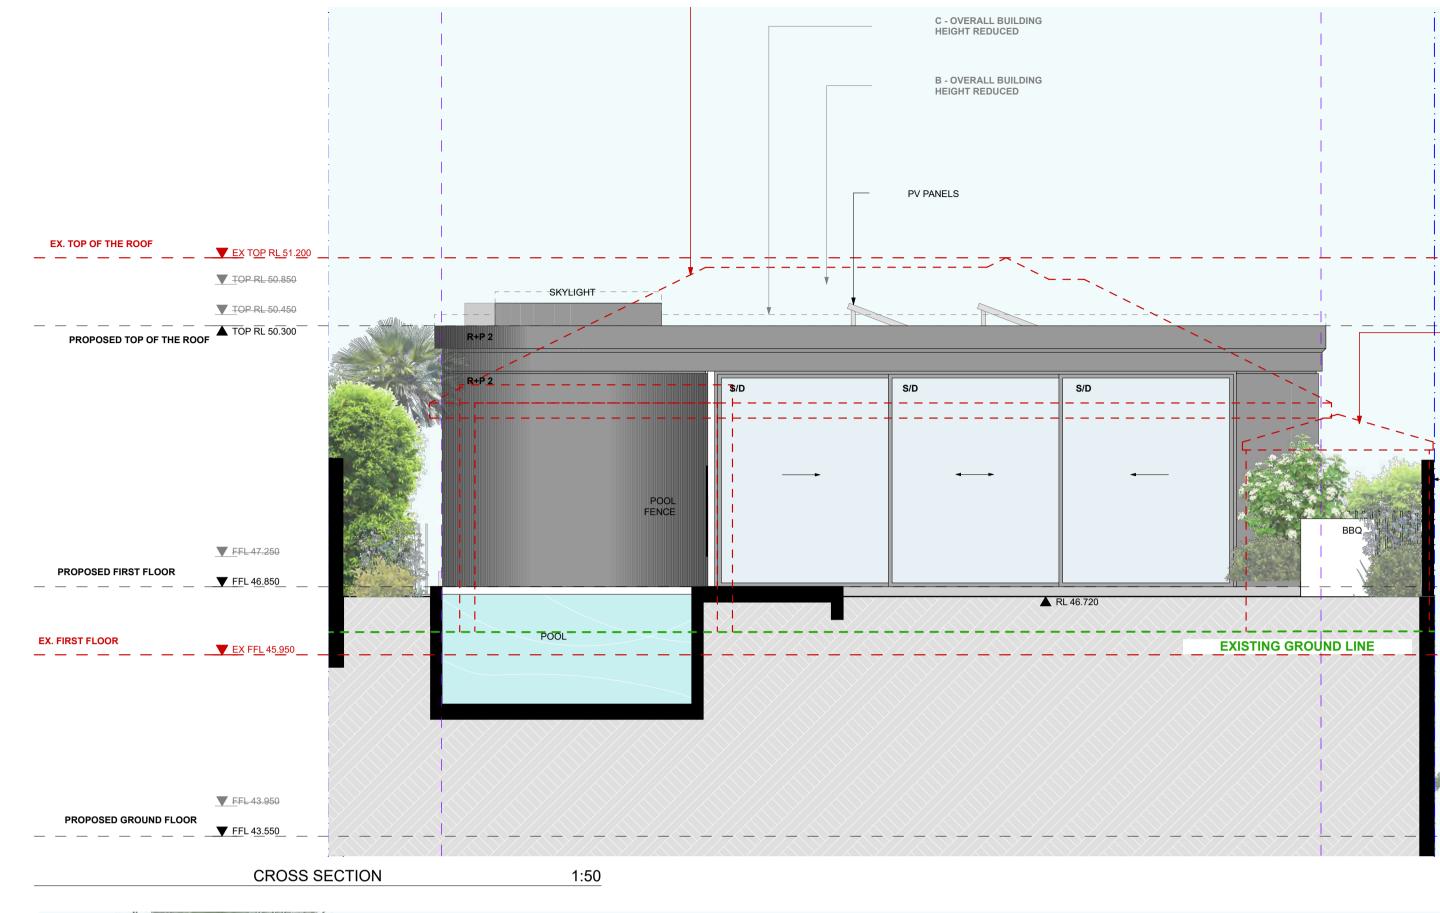

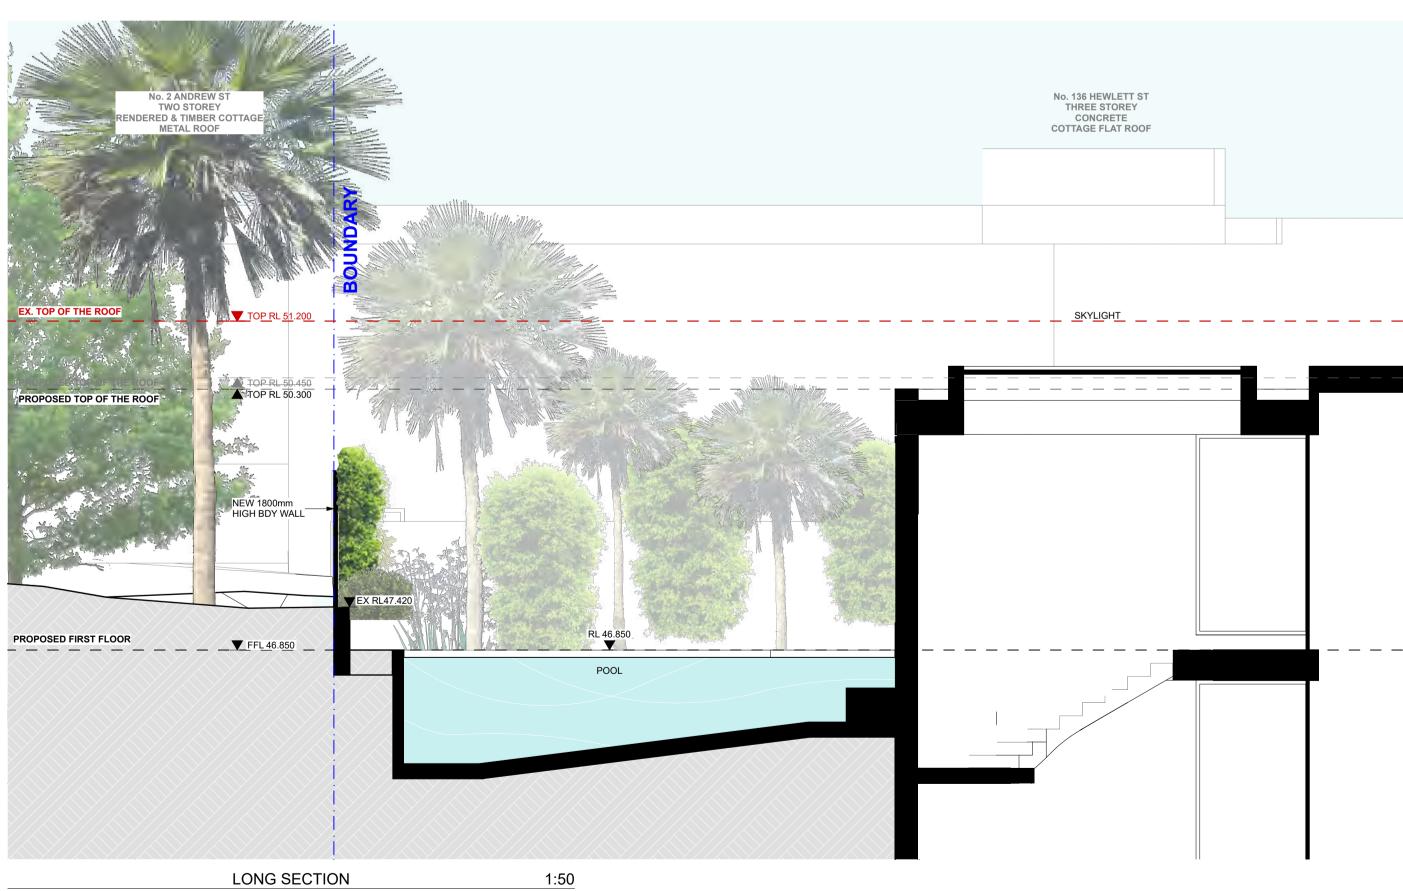


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REV	NOTE	DATE	GENERAL NOTES
A	DA SUBMISSION	25.11.2022	ALL WORKS TO BE IN ACCORDANCE WITH THE BUILDING CODE OF AUSTRALIA AUSTRALIAN STANDARDS STATUTORY REGILI ATIONS AND LOCAL AUTHORITY REQ
В	DA AMENDMENTS	03.05.2023	2. CONTRACTOR TO ENSURE CONSISTENCY BETWEEN MATERIALS IS MAINTAINED
С	DA AMENDMENTS	14.06.2023	CONTRACTOR TO NOTIFY MHN OF ANY DISCREPENCIES, DIMENSIONAL INCONSISTENCIES OR THE NEED FOR CLARIFICATION PRIOR TO MANUFACTURING
D	DA AMENDMENTS	11.08.2023	 MHN TO REVIEW ALL CONTRACTORS DETAILED DRAWINGS / SETTING OUT PRIOR TO CONSTRUCTION.
E	DA AMENDMENTS (SETBACK DIMENSIONS)	29.08.2023	5. CONTRACTOR TO LIAISE WITH ELECTRICAL CONTRACTORS TO ENSURE ALL POWER/DATA/COMMUNICATION REQUIREMENTS ARE ACCESSIBLE. 6. ALL DIMENSIONS TO BE VERIFIED ON SITE - DO NOT SCALE 7. ALL WORKS TO BE VERIFIED ACAINST DRAWINGS FOLLOWING CONSTRUCTION AND ARCHITECT TO BE NOTIFIED OF ANY DISCREPANCIES PRIOR TO PROCEEDING WITH NEXT TRADE

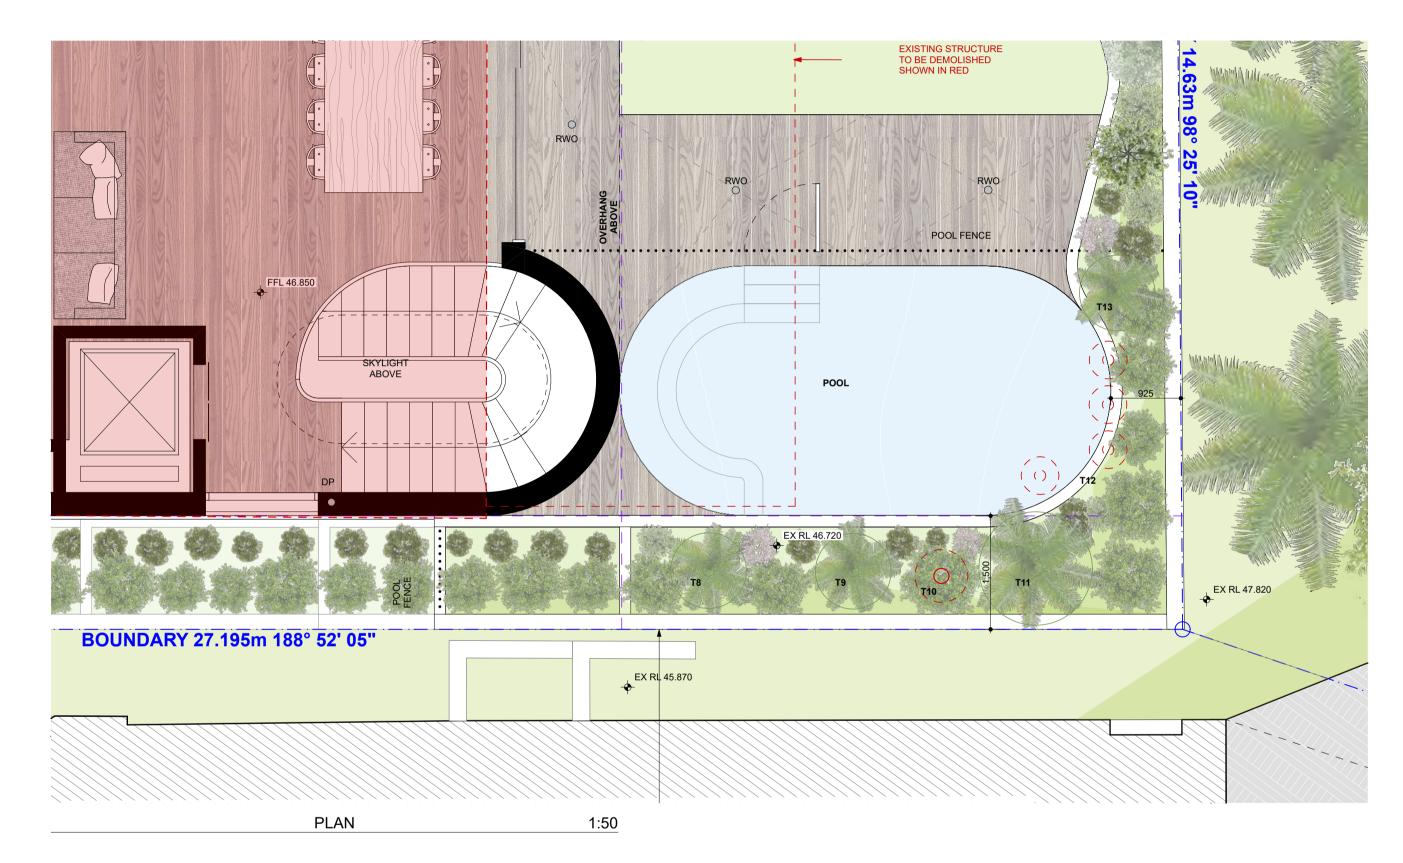ALL CONSTRUCTION TO COMPLY AT MINIMUM W/ BCA	CLAUSES & AUSTRALIAN STANDARDS
CLAUSE B 1.4 - MATERIAL & FORMS CONSTRUCTIONS SPEC. C1.1 - FIRE RESISTING CONSTRUCTION SPEC. C.1.1 - FIRE RESISTING CONSTRUCTION SPEC. C1.10 - FIRE HAZARD PROPERTIES SPEC. C.11 - PERFORMANCE OF EXTERNAL WALLS IN A FIRE CLAUSE C2.6 - VERTICAL SEPARATION OF OPENINGS IN EXTERNAL WALL CLAUSE C2.12 - SPEARATION OF EQUIPMENT CLAUSE C2.13 - LECETRICITY SUPPLY SYSYEM CLAUSE C3 ACCEPTABLE METHODS OF PROTECTION (OF OPENINGS) CLAUSE C3.8 - OPENING IN FIRE ISOLATED EXITS CLAUSE C3.15 - OPENING FOR SERVICE INSTALLATIONS CLAUSE D1.10 - DISCHARGE FROM EXITS CLAUSE D2.15 - OFINIATIONS IN CAUST SALTS AND PATHS OF TRAVEL CLAUSE D2.13 - GOINGS AND RISERS CLAUSE D2.15 - THRESHOLDS CLAUSE D2.15 - THRESHOLDS CLAUSE D2.16 - BALUSTRADES	CLAUSE D2.17 - HANDRAILS CLAUSE D2.21 - OPERATION OF LATCH CLAUSE D2.21 - SOPERATION OF LATCH CLAUSE D3.2 - SENERAL BUILDING ACCESS REQUIREMENTS CLAUSE D3.2 - GENERAL BUILDING TO BE ACCESSIBLE CLAUSE D3.6 - IDENT. OF ACCESSIBLE FACIL/SERV/FEATURES CLAUSE D3.8 - TACTILE INDICATORS CLAUSE F1.7 - WATERPROOFING OF WET AREAS CLAUSE F1.9F-1.10 - DAMP PROOFING CLAUSE F1.9F-1.10 - DAMP PROOFING CLAUSE F3.6 - SOUND INSULATION OF FLOORS CLAUSE F5.5 - SOUND INSULATION OF WALLS CLAUSE F5.5 - SOUND INSULATION OF WALLS CLAUSE F5.6 - SOUND INSULATION OF PUMPS



NOTES:

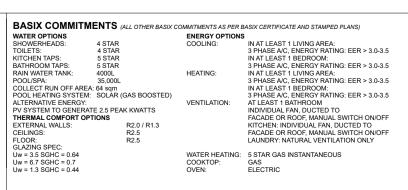

MHN Design Union Pty Ltd. ABN 94 003 717 682 NSW Registration Number 4907

PROJECT ADDRESS: 134 HEWLETT ST BRONTE DRAWING TITLE: POOL SECTIONS

DRAWN BY: BM / MW / FK MHNDU SCALE: 1:50@A1 ISSUE DATE: REVISION: 29.08.2023 PROJECT NUMBER: DWG NUMBER: DA303 18-008

DRAWING TITLE:

Nominated Architect

Brian Meyerson

SOUTH ELEVATION

134 HEWLETT ST BRONTE

DRAWN BY:

SCALE:

1:100@A1

ISSUE DATE:

29.08.2023

18-008

PROJECT NUMBER:

BM / MW / FK

MHNDU

REVISION:

DWG NUMBER:

DA400

RECEIVED **Waverley Council**

Application No: DA-19/2023

Date Received: 30/08/2023



COMMITMENTS AS PER BASIX CERTIFICATE AND STAMPED PLANS)

ENERGY OPTIONS

COOLING:

IN AT LEAST 1 LIVING AREA:
3 PHASE A/C, ENERGY RATING: EER > 3.0-3.5
IN AT LEAST 1 BEDROOM:
3 PHASE A/C, ENERGY RATING: EER > 3.0-3.5
HEATING:
IN AT LEAST 1 LIVING AREA:
3 PHASE A/C, ENERGY RATING: EER > 3.0-3.5
IN AT LEAST 1 BEDROOM:
3 PHASE A/C, ENERGY RATING: EER > 3.0-3.5
IN AT LEAST 1 BEDROOM:
3 PHASE A/C, ENERGY RATING: EER > 3.0-3.5
VENTILATION:
AT LEAST 1 BEDROOM:
INDIVIDUAL FAN, DUCTED TO
FACADE OR ROOF, MANUAL SWITCH ON/OFF
KITCHEN: INDIVIDUAL FAN, DUCTED TO
FACADE OR ROOF, MANUAL SWITCH ON/OFF
LAUNDRY: NATURAL VENTILATION ONLY

WATER HEATING: 5 STAR GAS INSTANTANEOUS COOKTOP: GAS OVEN: ELECTRIC

BASIX COMMITMENTS (ALL OTHER BASIX COMMITMENTS AS PER BASIX CERTIFICATE AND STAMPED PLANS)

BASIX COMMITMENTS (ALL OTHER BASIX
WATER OPTIONS
SHOWERHEADS: 4 STAR
TOILETS: 4 STAR
KITCHEN TAPS: 5 STAR
BATHROOM TAPS: 5 STAR
BATHROOM TAPS: 35,000L
COLLECT RUN OFF AREA: 64 sqm
POOL HEATING SYSTEM: SOLAR (GAS BOOSTED)
ALTERNATIVE ENERGY:
PV SYSTEM TO GENERATE 2.5 PEAK KWATTS
THERMAL COMPORT OPTIONS

NOTES:

FFL

EX EXISTING

RL OF FINISHED

FLOOR LEVEL

DA APPROVED

BOUNDARY

REDUCED LEVEL

COUNCIL CONTROLS

STRUCTURE (DA 48/2021)

ANW ANEETA WINDOW

METAL

SCR SCREEN

GLASS BALUSTRADE

RENDER AND PAINT

PAL PALISADE BALUSTRADE

SLIDING WINDOW / DOOR

35 RICHARDS LANE

T +61 2 9101 1111

F +61 2 9101 1100

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SURRY HILLS SYDNEY NSW 2010

MHN Design Union Pty Ltd. ABN 94 003 717 682 NSW Registration Number 4907

GB R+P

EXISTING STRUCTURE PSCR PRIVACY SCREEN

TO BE DEMOLISHED LVR LOUVERS

SPECIFICATIONS (refer to specification attachment)
ARTIFICIAL LIGHTING: TO COMPLY WITH BCA PART CLAUSEF4.4 & AS1680
BALUSTRADE HEIGHTS: TO COMPLY WITH BCA CLAUSE D2.16
DRAINAGE GUTTERS & DOWNPIPES: TO COMPLY WITH AS/NZS 3500 3.2
ENERGY SFFICIENCYGLAZING: TO COMPLY WITH J2 OF BCA
FIRE SERVICES: TO COMPLY WITH SECTION E OF BCA
HOT WATER: SYSTEMS TO COMPLY WITH PART J7 OF BCA
MASONRY: TO COMPLY WITH AS/9700
MECHANICAL EXHANUST VENTILATION: TO COMPLY WITH PART J5 OF BCA
MECHANICAL EXHANUST VENTILATION: TO COMPLY WITH AS/1688 & AS68.2
SMOKE ALARMS: TO COMPLY WITH BCA PART CLAUSE & SPEC E2.2 & AS3786
PENETRATIONS: THROUGH FIRE RATED CONSTRUCTION FOR
MECH/ELEC/HYDRAULIC PENETRATIONS TO COMPLY WITH BCA CLAUSE
C3.15 & AS1530 4-2005
SOUND TRANSMISSION: TO COMPLY WITH PART5 OF BCA
STAIR CONSTRUCTION: TO COMPLY WITH BCA CLAUSE D2.13
STAIR CONSTRUCTION: TO COMPLY WITH BCA CLAUSE D2.13
WATERPROOFING OF WET AREAS: TO COMPLY WITH AS3740

ALL CONSTRUCTION TO COMPLY AT MINIMUM W/ BCA CLAUSES & AUSTRALIAN STANDARDS

CLAUSE B 1.4 - MATERIAL & FORMS CONSTRUCTIONS
SPEC. C1.1 - FIRE RESISTING CONSTRUCTIONS
SPEC. C1.1 - FIRE RESISTING CONSTRUCTION
SPEC. C1.1 - FIRE RESISTING CONSTRUCTION
SPEC. C1.1 - FIRE HAZARD PROPERTIES
CLAUSE C2.6 - VERTICAL SEPARATION OF OPENINGS IN EXTERNAL WALL
CLAUSE C2.6 - VERTICAL SEPARATION OF OPENINGS IN EXTERNAL WALL
CLAUSE C2.6 - VERTICAL SEPARATION OF POENINGS IN EXTERNAL WALL
CLAUSE C2.1 - SELECTRICITY SUPPLY SYSYEM
CLAUSE C2.13 - LECTRICITY SUPPLY SYSYEM
CLAUSE C3.8 - OPENING IN FIRE ISOLATED EXITS
CLAUSE C3.8 - OPENING IN FIRE ISOLATED EXITS
CLAUSE D3.15 - OPENING FOR SERVICE INSTALLATIONS
CLAUSE D3.15 - OPENING FOR SERVICE INSTALLATIONS
CLAUSE D2.7 - INSTALLATIONS IN EXITS AND PATHS OF TRAVEL
CLAUSE D2.7 - INSTALLATIONS IN EXITS AND PATHS OF TRAVEL
CLAUSE D2.14 - LANDINGS
CLAUSE D2.15 - THRESHOLDS
CLAUSE D2.15 - THRESHOLDS
CLAUSE D2.16 - BALUSTRADES

NSW 2024

DA SUBMISSION

DA AMENDMENTS

DA AMENDMENTS

DA AMENDMENTS

https://www.fr5.com.au/QRCodeLanding?PublicId=XZX

DA AMENDMENTS (SETBACK DIMENSIONS) 29.08.2023

DATE

25.11.2022

03.05.2023

14.06.2023

11.08.2023

GENERAL NOTES

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2. CONTRACTOR TO ENSURE CONSISTENCY BETWEEN MATERIALS IS MAINTAINED

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4. MIN TO REVIEW ALL CONTRACTORS DETAILED DRAWINGS / SETTING OUT PRIOR TO CONSTRUCTION.

5. CONTRACTOR TO LIAISE WITH ELECTRICAL CONTRACTORS TO ENSURE ALL POWER/DATA/COMMUNICATION REQUIREMENTS ARE ACCESSIBLE.

6. ALL DIMENSIONS TO BE VERIFIED AN SITE - DO NOT SCALE

7. ALL WORKS TO BE VERIFIED AGAINST DRAWINGS FOLLOWING CONSTRUCTION AND ARCHITECT TO BE NOTIFIED OF ANY DISCREPANCIES PRIOR TO PROCEEDING WITH NEXT TRADE

DRAWING TITLE:

Nominated Architect

Brian Meyerson

NORTH ELEVATION

134 HEWLETT ST BRONTE

DRAWN BY:

SCALE:

1:100@A1

ISSUE DATE:

29.08.2023

18-008

PROJECT NUMBER:

BM / MW / FK

MHNDU


REVISION:

DWG NUMBER:

DA401

Date Received: 30/08/2023

Application No: DA-19/2023

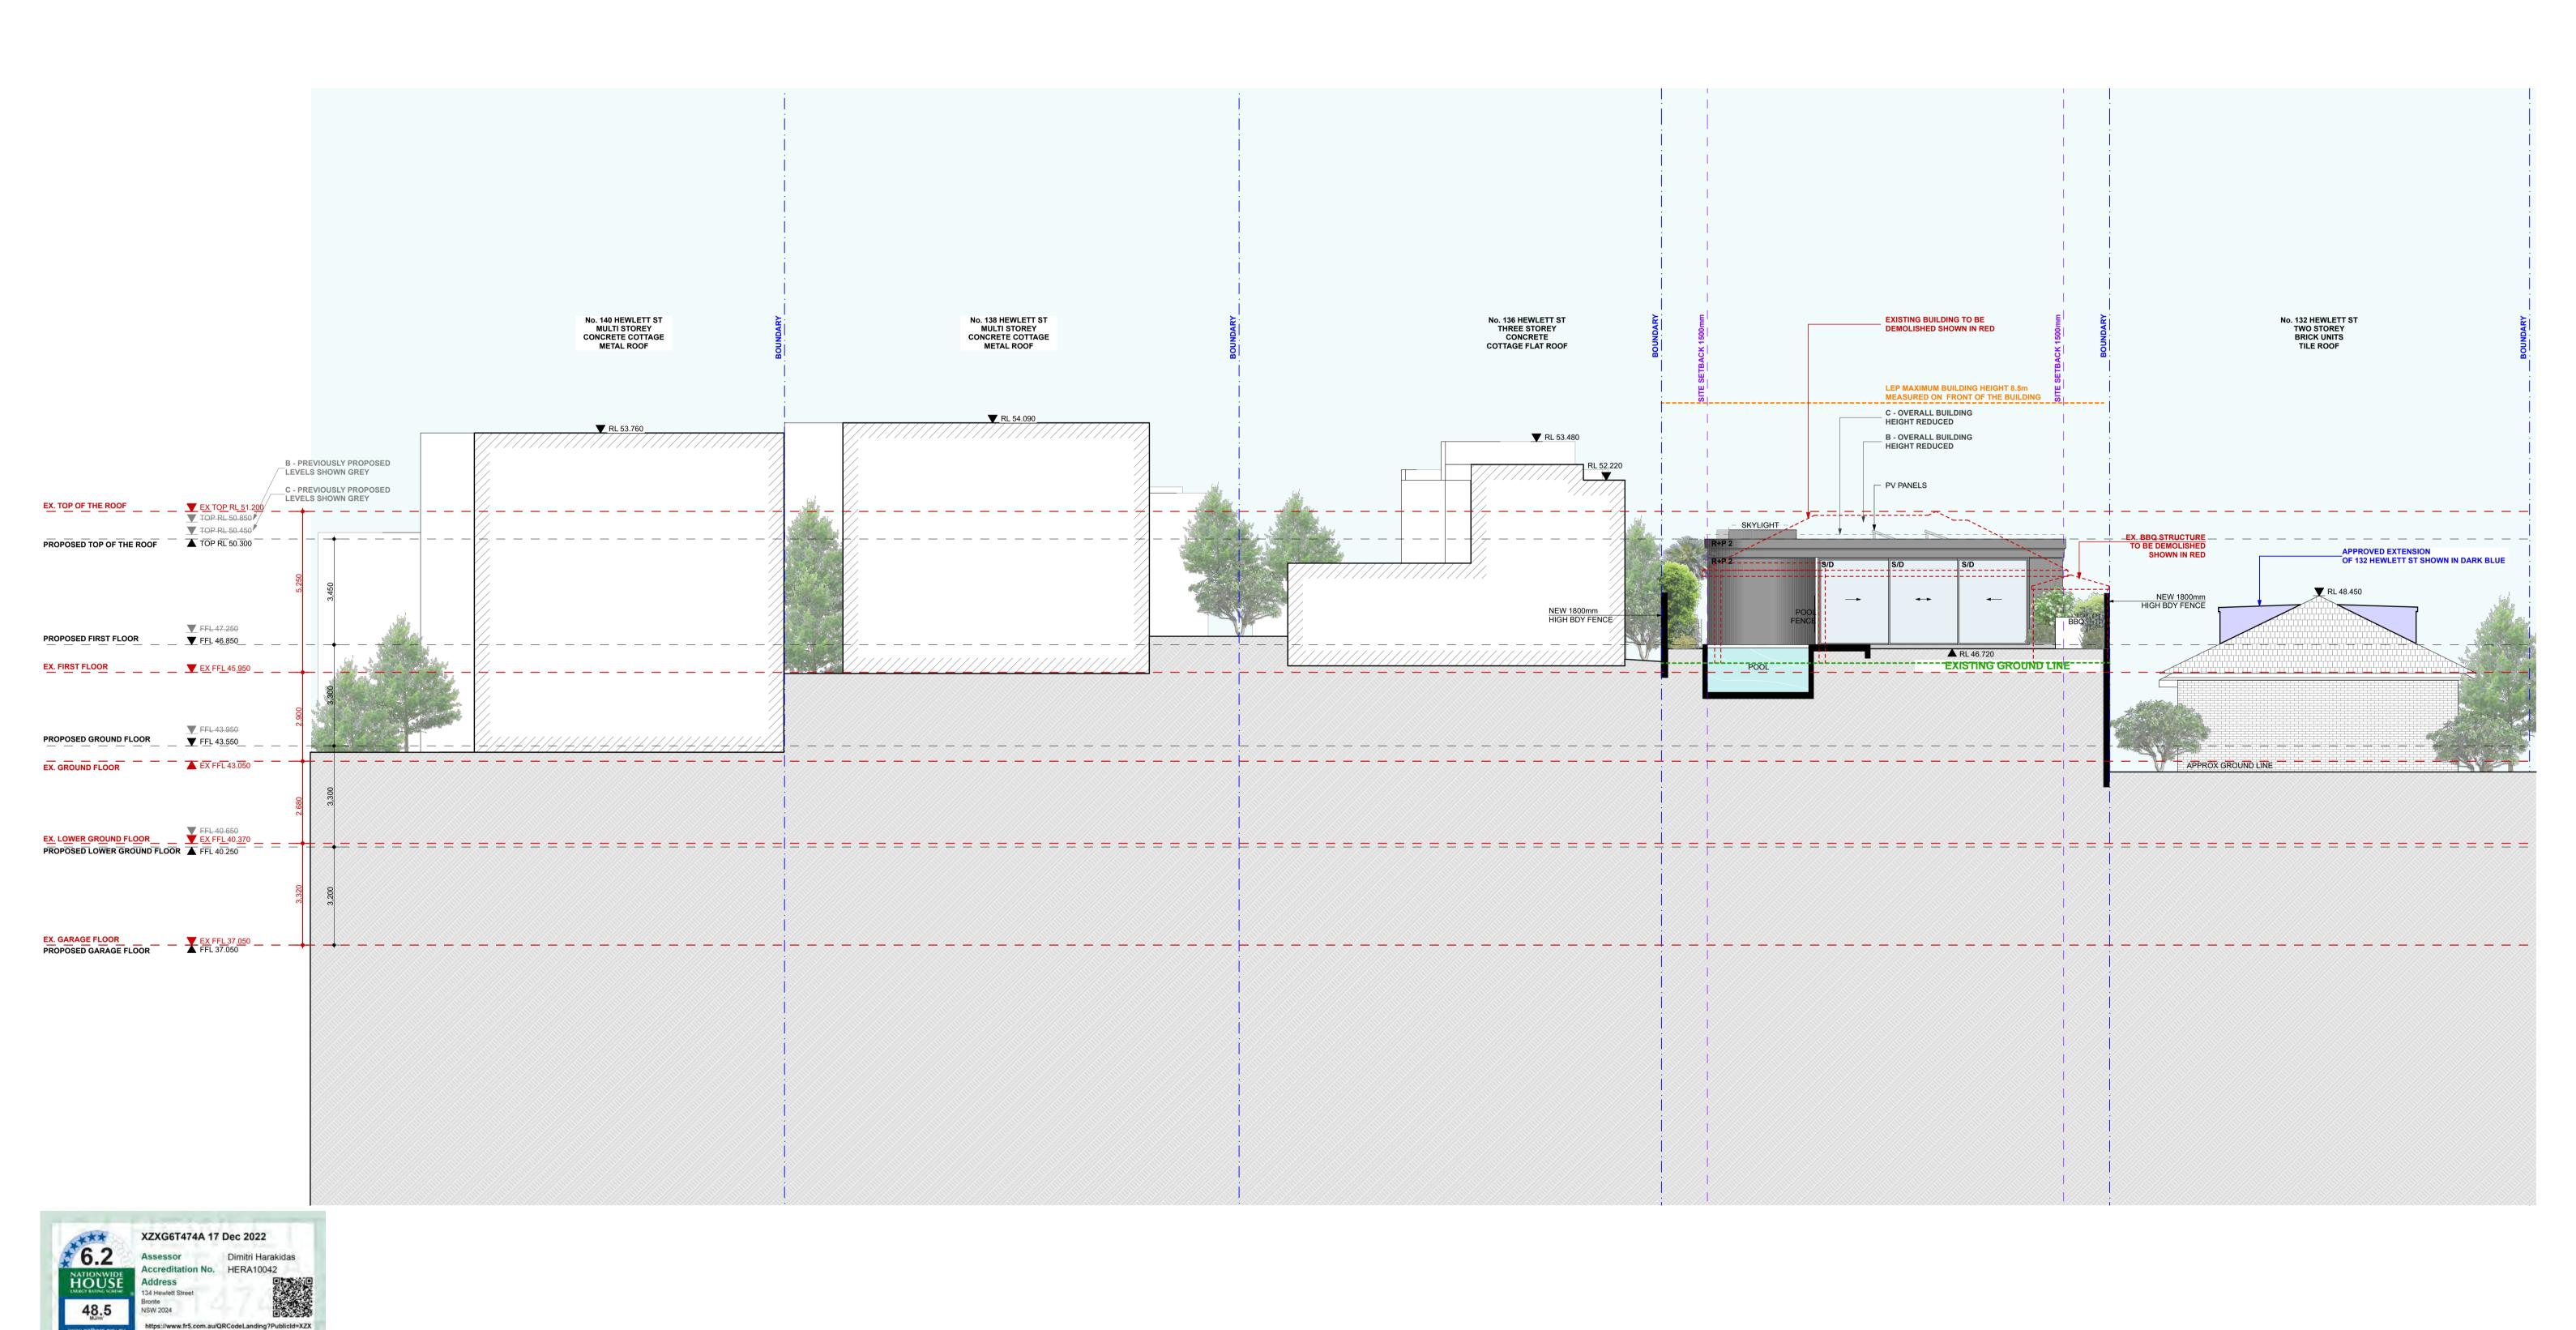

COMMITMENTS AS PER BASIX CERTIFICATE AND STAMPED PLANS)

ENERGY OPTIONS

COOLING: IN AT LEAST 1 LIVING AREA:

3 PHASE A/C, ENERGY RATING: EER > 3.0-3.5

IN AT LEAST 1 BEDROOM:

3 PHASE A/C, ENERGY RATING: EER > 3.0-3.5

HEATING: IN AT LEAST 1 LIVING AREA:

3 PHASE A/C, ENERGY RATING: EER > 3.0-3.5

IN AT LEAST 1 BEDROOM:

3 PHASE A/C, ENERGY RATING: EER > 3.0-3.5

IN AT LEAST 1 BEDROOM:

5 PHASE A/C, ENERGY RATING: EER > 3.0-3.5

VENTILATION: AT LEAST 1 BATHROOM

INDIVIDUAL FAN, DUCTED TO

FACADE OR ROOF, MANUAL SWITCH ON/OFF

KITCHEN: INDIVIDUAL FAN, DUCTED TO

FACADE OR ROOF, MANUAL SWITCH ON/OFF

LAUNDRY: NATURAL VENTILATION ONLY

WATER HEATING: 5 STAR GAS INSTANTANEOUS COOKTOP: GAS OVEN: ELECTRIC

BASIX COMMITMENTS (ALL OTHER BASIX COMMITMENTS AS PER BASIX CERTIFICATE AND STAMPED PLANS)

BASIX COMMITMENTS (ALL OTHER BASIX I
WATER OPTIONS
SHOWERHEADS: 4 STAR
TOILETS: 4 STAR
KITCHEN TAPS: 5 STAR
BATHROOM TAPS: 5 STAR
BATHROOM TAPS: 35,000L
COLLECT RUN OFF AREA: 64 sqm
POOL HEATING SYSTEM: SOLAR (GAS BOOSTED)
ALTERNATIVE ENERGY:
PV SYSTEM TO GENERATE 2.5 PEAK KWATTS
THERMAL COMPORT OPTIONS

NOTES:

FFL

EX EXISTING

RL OF FINISHED

REDUCED LEVEL

DA APPROVED

STRUCTURE (DA 48/2021)

FLOOR LEVEL

BOUNDARY

ANW ANEETA WINDOW GB GLASS BALUSTRADE

RENDER AND PAINT

PAL PALISADE BALUSTRADE

METAL SLIDING WINDOW / DOOR

35 RICHARDS LANE

T +61 2 9101 1111

F +61 2 9101 1100

www.mhndu.com

SURRY HILLS SYDNEY NSW 2010

MHN Design Union Pty Ltd. ABN 94 003 717 682 NSW Registration Number 4907

GB R+P M

COUNCIL CONTROLS SCR SCREEN
EXISTING STRUCTURE PSCR PRIVACY SCREEN

TO BE DEMOLISHED LVR LOUVERS

S/D SLIDING W SCR SCREEN

SPECIFICATIONS (refer to specification attachment)
ARTIFICIAL LIGHTING: TO COMPLY WITH BCA PART CLAUSEF4.4 & AS1680
BALUSTRADE HEIGHTS: TO COMPLY WITH BCA CLAUSE D2.16
DRAINAGE GUTTERS & DOWNPIPES: TO COMPLY WITH AS/NZS 3500 3.2
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MASONRY: TO COMPLY WITH AS/9700
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MECHANICAL EXHANUST VENTILATION: TO COMPLY WITH AS/1688 & AS68.2
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PENETRATIONS: THROUGH FIRE RATED CONSTRUCTION FOR
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WATERPROOFING OF WET AREAS: TO COMPLY WITH AS3740

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SPEC. C1.10 - FIRE RESISTING CONSTRUCTION
SPEC. C1.10 - FIRE HAZARD PROPERTIES
CLAUSE C.26 - VERTICAL SEPARATION OF OPENINGS IN EXTERNAL WALL
CLAUSE C.26 - VERTICAL SEPARATION OF OPENINGS IN EXTERNAL WALL
CLAUSE C.21 - SPEARATION OF EQUIPMENT
CLAUSE C.21.3 - ELECTRICITY SUPPLY SYSYEM
CLAUSE C.31 - ACCEPTABLE METHODS OF PROTECTION (OF OPENINGS)
CLAUSE C.38 - OPENING IN FIRE ISOLATED EXITS
CLAUSE C.3.5 - OPENING FOR SERVICE INSTALLATIONS
CLAUSE D.3.6 - OPENING FOR SERVICE INSTALLATIONS
CLAUSE C.3.6 - OPENING FOR SERVICE INSTALLATIONS
CLAUSE D.3.7 - INSTALLATIONS IN EXITS AND PATHS OF TRAVEL
CLAUSE D.2.7 - INSTALLATIONS IN EXITS AND PATHS OF TRAVEL
CLAUSE D.2.14 - LANDINGS
CLAUSE D.2.15 - THRESHOLDS
CLAUSE D.2.15 - THRESHOLDS
CLAUSE D.2.16 - BALUSTRADES

NOTE

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DA AMENDMENTS (SETBACK DIMENSIONS) 29.08.2023

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DRAWING TITLE:

Nominated Architect

Brian Meyerson

WEST ELEVATION

134 HEWLETT ST BRONTE

DRAWN BY:

SCALE:

1:100@A1

ISSUE DATE:

29.08.2023

18-008

PROJECT NUMBER:

BM / MW / FK


MHNDU

REVISION:

DWG NUMBER:

DA402

RECEIVED

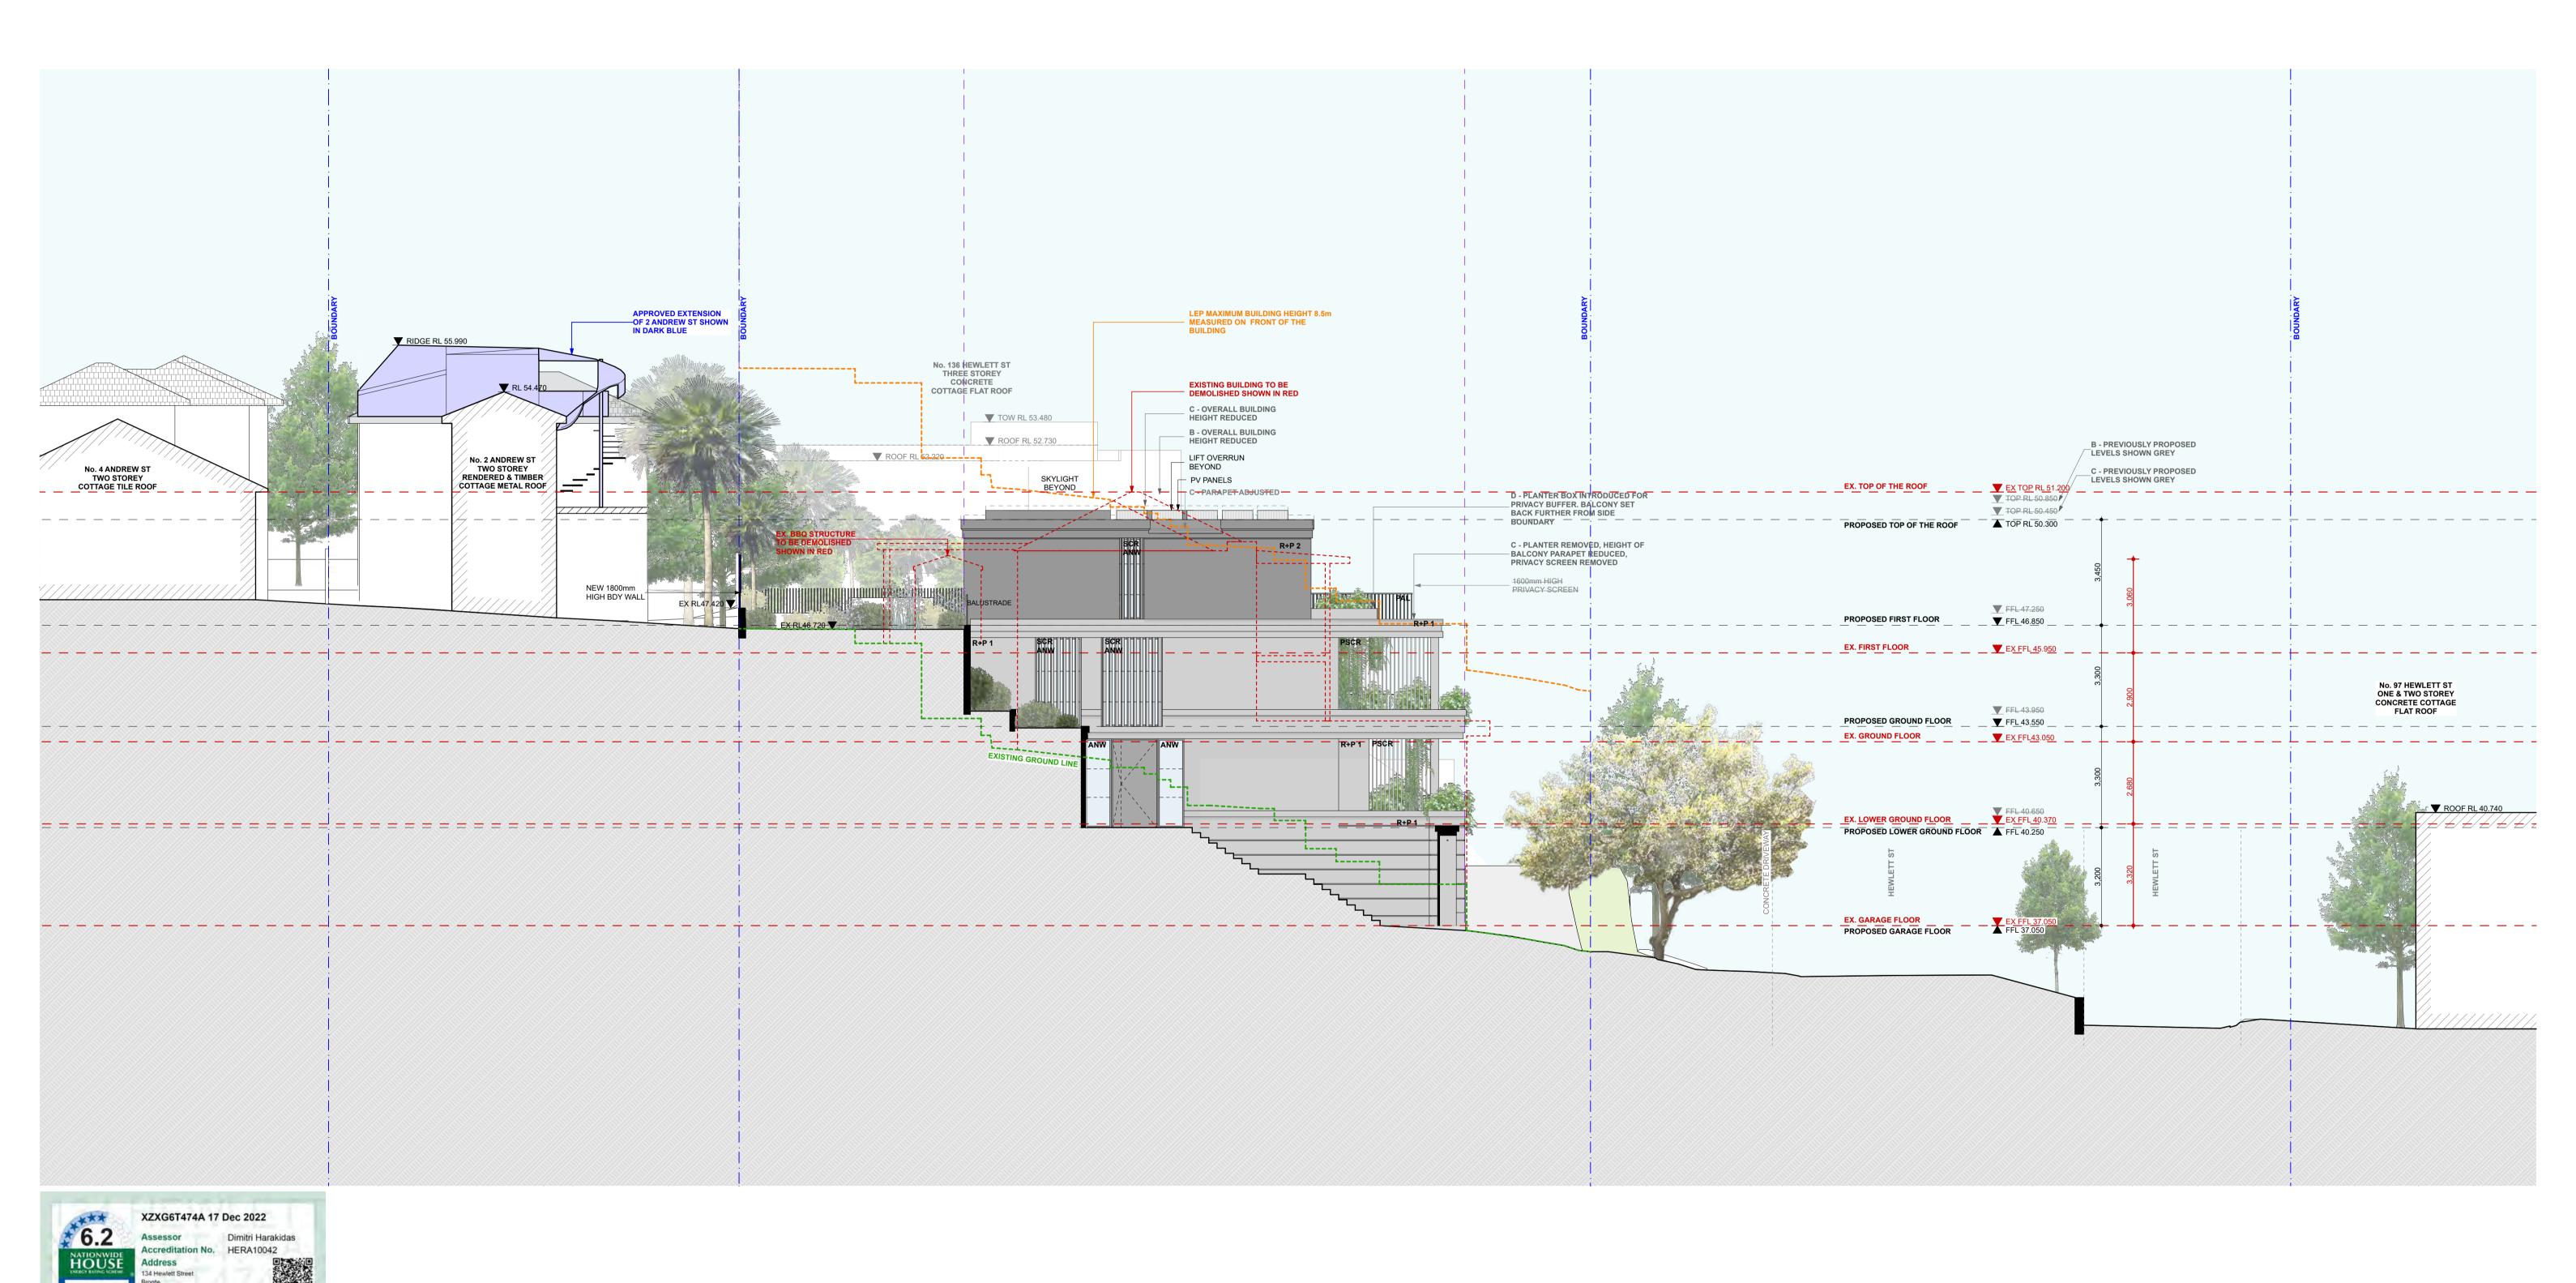

COMMITMENTS AS PER BASIX CERTIFICATE AND STAMPED PLANS)

ENERGY OPTIONS

COOLING: IN AT LEAST 1 LIVING AREA:

3 PHASE A/C, ENERGY RATING: EER > 3.0-3.5

IN AT LEAST 1 BEDROOM:

3 PHASE A/C, ENERGY RATING: EER > 3.0-3.5

HEATING: IN AT LEAST 1 LIVING AREA:

3 PHASE A/C, ENERGY RATING: EER > 3.0-3.5

IN AT LEAST 1 BEDROOM:

3 PHASE A/C, ENERGY RATING: EER > 3.0-3.5

IN AT LEAST 1 BEDROOM:

5 PHASE A/C, ENERGY RATING: EER > 3.0-3.5

VENTILATION: AT LEAST 1 BATHROOM

INDIVIDUAL FAN, DUCTED TO

FACADE OR ROOF, MANUAL SWITCH ON/OFF

KITCHEN: INDIVIDUAL FAN, DUCTED TO

FACADE OR ROOF, MANUAL SWITCH ON/OFF

LAUNDRY: NATURAL VENTILATION ONLY

WATER HEATING: 5 STAR GAS INSTANTANEOUS COOKTOP: GAS OVEN: ELECTRIC

BASIX COMMITMENTS (ALL OTHER BASIX COMMITMENTS AS PER BASIX CERTIFICATE AND STAMPED PLANS)

BASIX COMMITMENTS (ALL OTHER BASIX
WATER OPTIONS
SHOWERHEADS: 4 STAR
TOILETS: 4 STAR
KITCHEN TAPS: 5 STAR
BATHROOM TAPS: 5 STAR
RAIN WATER TANK: 4000L
POOLISPA: 35,000L
COLLECT RUIN OFF AREA: 64 sqm
POOL HEATING SYSTEM: SOLAR (GAS BOOSTED)
ALTERNATIVE ENERGY:
PV SYSTEM TO GENERATE 2.5 PEAK KWATTS
THERMAL COMFORT OPTIONS

NOTES:

FFL

EX EXISTING

RL OF FINISHED

FLOOR LEVEL

DA APPROVED

BOUNDARY

REDUCED LEVEL

COUNCIL CONTROLS

STRUCTURE (DA 48/2021)

ANW ANEETA WINDOW GB GLASS BALUSTRADE

PAL PALISADE BALUSTRADE

METAL

SCR SCREEN

RENDER AND PAINT

SLIDING WINDOW / DOOR

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SURRY HILLS SYDNEY NSW 2010

MHN Design Union Pty Ltd. ABN 94 003 717 682 NSW Registration Number 4907

GB R+P

EXISTING STRUCTURE PSCR PRIVACY SCREEN

TO BE DEMOLISHED LVR LOUVERS

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CLAUSE D2.16 - BALUSTRADES

NSW 2024

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Nominated Architect

Brian Meyerson

EAST ELEVATION

134 HEWLETT ST BRONTE

DRAWN BY:

SCALE:

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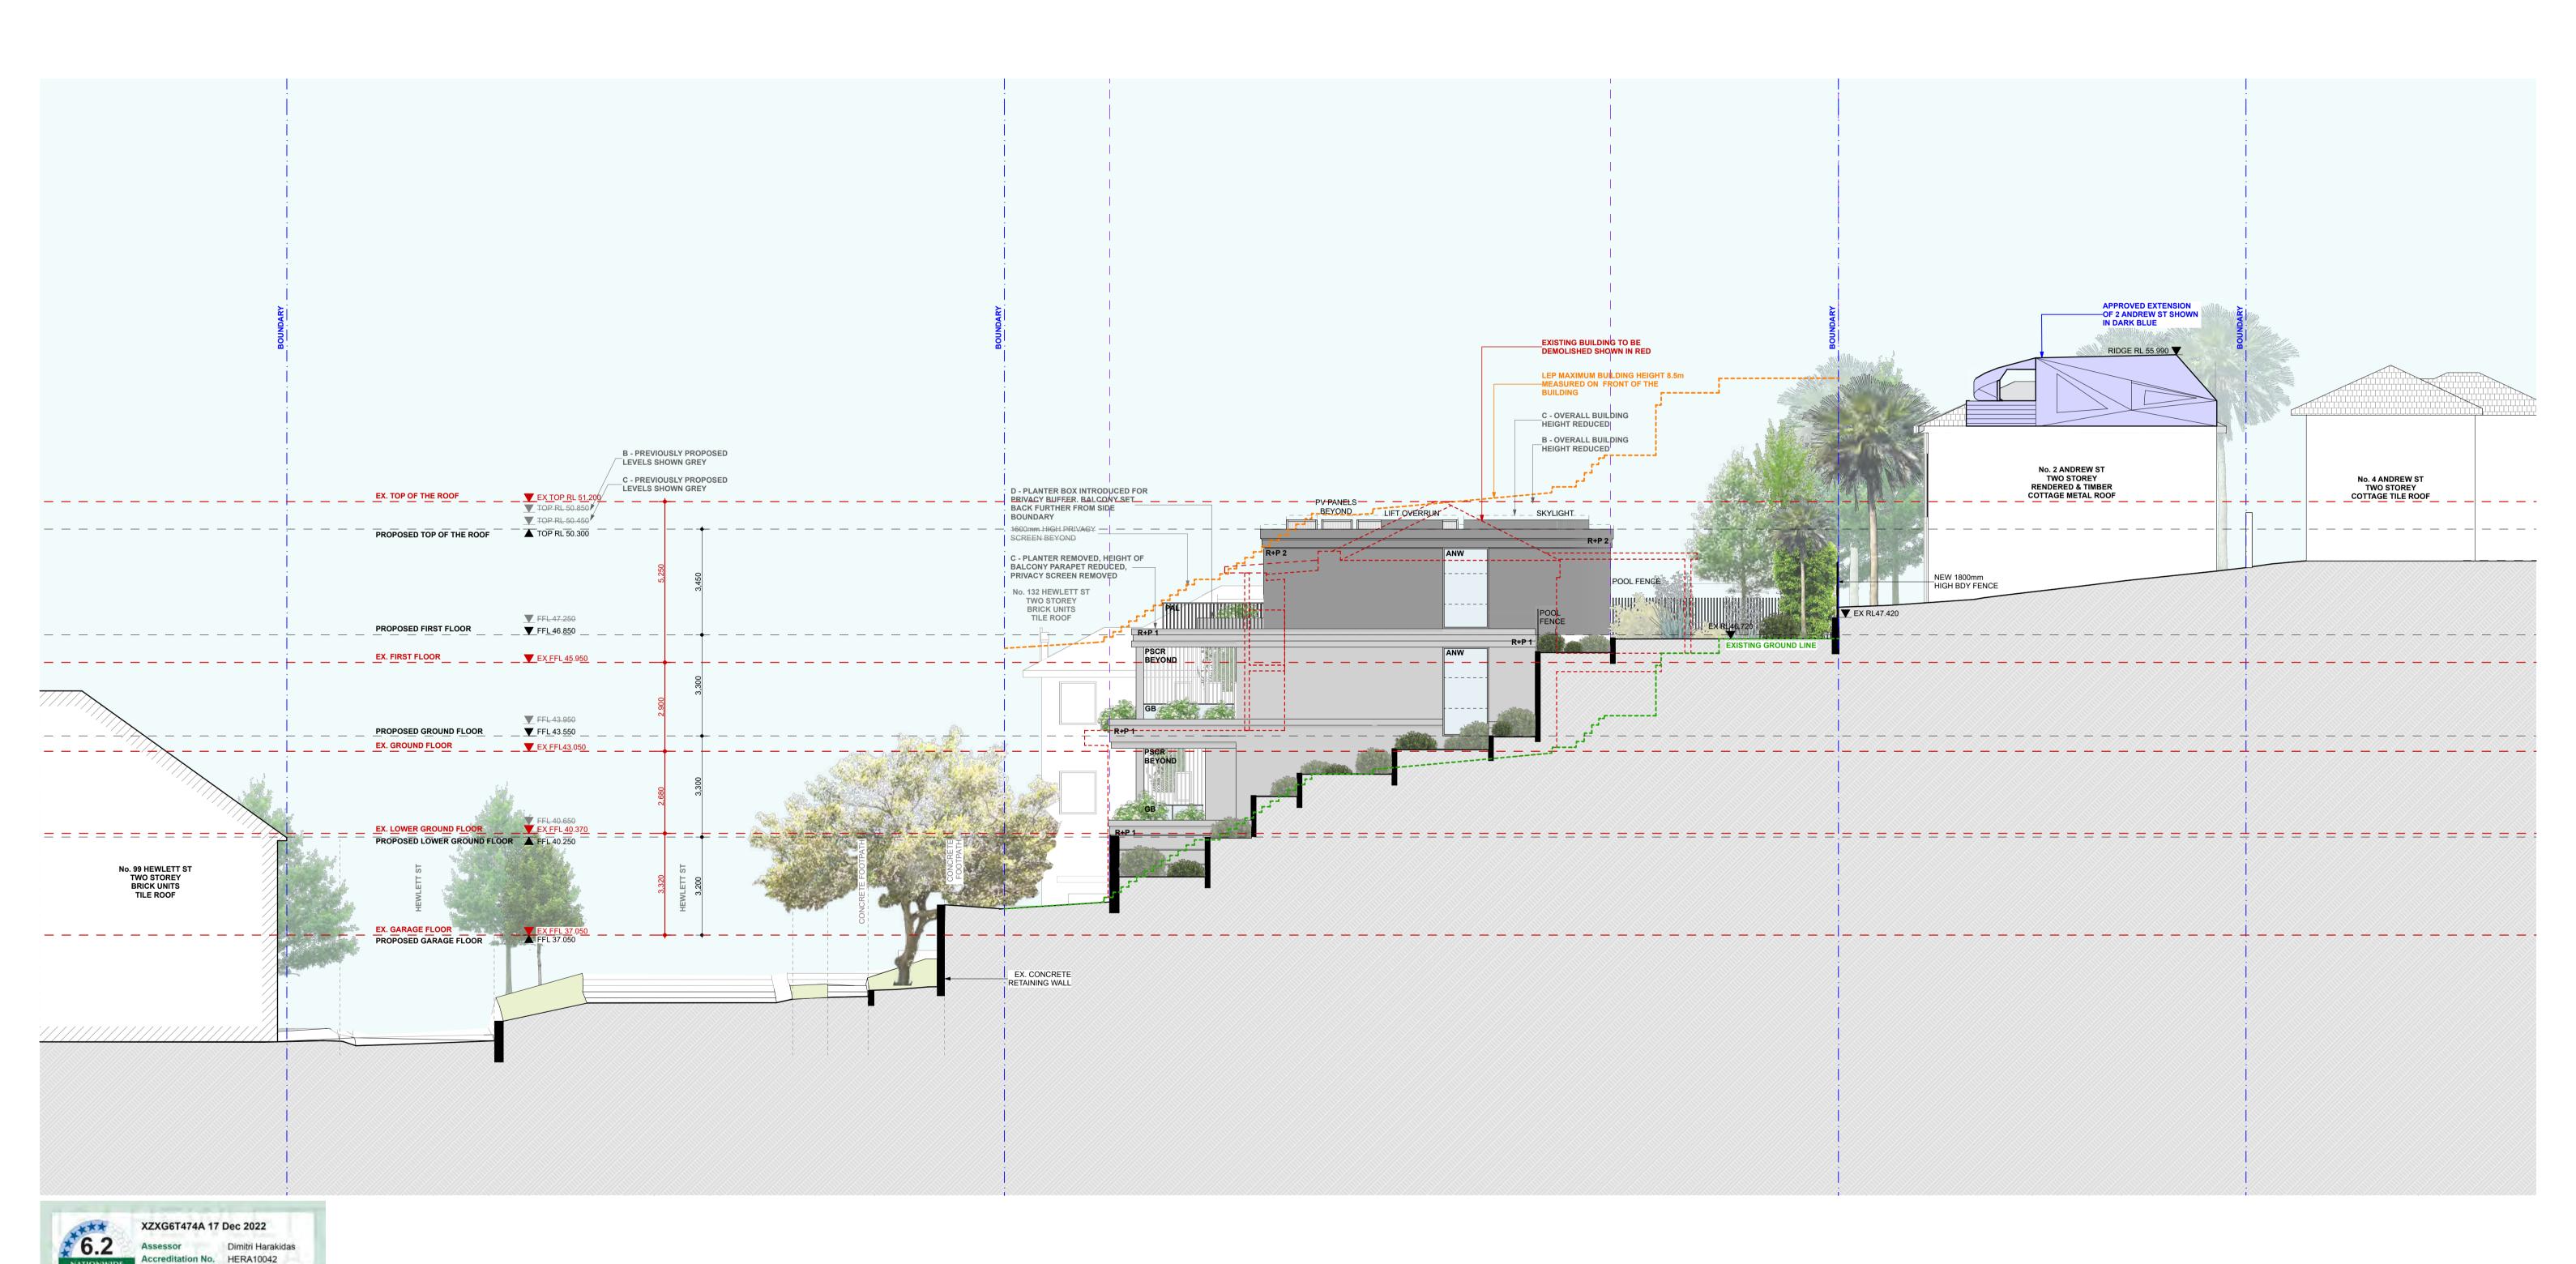
MHNDU

REVISION:

DWG NUMBER:

DA403

Application No: DA-19/2023



COMMITMENTS AS PER BASIX CERTIFICATE AND STAMPED PLANS)

ENERGY OPTIONS

COOLING:

IN AT LEAST 1 LIVING AREA:
3 PHASE A/C, ENERGY RATING: EER > 3.0-3.5
IN AT LEAST 1 BEDROOM:
3 PHASE A/C, ENERGY RATING: EER > 3.0-3.5
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COUNCIL CONTROLS

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Address 134 Hewlett Street NSW 2024

DA SUBMISSION

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https://www.fr5.com.au/QRCodeLanding?PublicId=XZX

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Report to the Waverley Local Planning Panel

Application number	DA-57/2023	
Site address	25 St Thomas Street, Bronte	
Proposal	Demolition and construction of a new three storey dwelling including basement garage and new swimming pool at rear.	
Date of lodgement	18 March 2023	
Owner	Mr A J Burrell	
Applicant	Clinton Murray Architects	
Submissions	16	
Cost of works	\$2,453,000	
Principal Issues	 Breach to height Breach to Floor Space Ratio (FSR) Volume of excavation 	
Recommendation	That the application be REFUSED for the reasons contained in the report.	

SITE MAP



1. PREAMBLE

1.1. Executive Summary

The Development Application (DA) seeks consent for the demolition and construction of a new three storey dwelling including a basement garage and new swimming pool at the site known as 25 St Thomas Street, Bronte.

The principal issues arising from the assessment of the application are as follows:

- · Breach to height;
- · Breach to FSR; and
- Volume of excavation.

The assessment finds these issues unacceptable. The proposed development exceeds both the height of buildings and FSR development standards, whilst failing to meet the objectives of the development standards by not preserving the environmental amenity of neighbouring properties through reduced solar access and view impacts. In addition, the volume of excavation is excessive. Overall, the proposal's perceived bulk and scale particularly when viewed from the front and rear is considered excessive. Whilst attempts were made during the assessment process for the applicant to address these matters, the latest scheme does not go far enough to overcome these concerns and subsequently, the application is recommended for refusal.

A total number of 16 submissions were received and the issues raised in the submissions have been considered and addressed in this report and in the recommendation.

The application has been assessed against the relevant matters for consideration under section 4.15(1) of the *Environmental Planning and Assessment Act 1979*. It is recommended for refusal.

1.2. Site and Surrounding Locality

A site visit was carried out on 15 May 2023.

The site is identified as Lot 2 in DP73583, known as 25 St Thomas St, Bronte.

The site is rectangular in shape with an eastern frontage to St Thomas Street, measuring 9.55m. It has an area of 349.2m² and falls from the west (rear) to the east (front) by approximately 2.55m.

The site is occupied by a two-storey detached dwelling with vehicle access via an attached garage.

The site is adjoined by contemporary part-two, part-three storey dwellings on either side. The locality is characterised by a variety of low-density residential development.

Figures 1 to 3 are photos of the site and its context.



Figure 1. 3D satellite imagery of the subject site and its surrounding urban context. (Source: Google Maps, 2023)



Figure 2. Front of the subject site as viewed from St. Thomas Street, looking west.

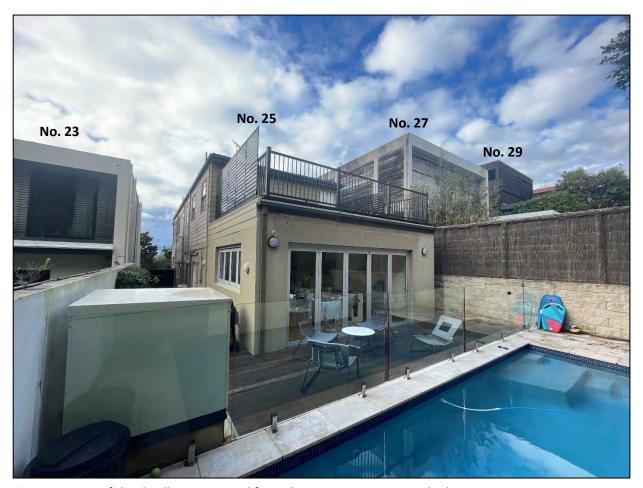


Figure 3. Rear of the dwelling as viewed from the private open space, looking east.

1.3. Relevant Development History

A search of Council's records revealed the following recent and relevant development history of the site:

• DA-277/2007

Construct a new window and sliding glass door.

Approved: 27 June 2007

DA-39/2011

Construction of a swimming pool at the rear of the dwelling.

Approved: 3 February 2011

1.4. Proposal

The Development Application (DA) seeks consent for demolition and construction of a new three storey dwelling including a basement garage and a new swimming pool at the rear, specifically the following:

- Demolition of all structures on site, inclusive of the in-ground swimming pool.
- Construction of a new three storey dwelling containing:
 - Basement

- Two car garage
- Plant room
- Storage room
- Lift and internal stair access
- Ground Floor
 - Three secondary bedrooms
 - Bathroom
 - Laundry
 - Rear outdoor area
 - In-ground swimming pool and associated landscaping
- First Floor
 - Open plan living areas
 - Office
 - Primary bedroom with walk-in robe and ensuite

1.5. Background

The DA was deferred on 15 June 2023 for the following reasons:

- 1. The development was to comply with height and FSR;
- 2. The amount of excavation proposed was excessive and was to be reduced;
- 3. Ceiling fans were to be added to habitable rooms;
- 4. The development exceeded the 7m wall height limit and was to comply;
- 5. The proposed building lines were non-compliant and were to comply;
- 6. Additional fencing details were requested;
- 7. View loss diagrams were requested;
- 8. Landscaping calculations were requested;
- 9. The RL's of neighbouring private open space was requested; and
- 10. Comments from Council's Stormwater Engineer were to be addressed.

The applicant provided additional information to the NSW Planning Portal on 14 July 2023.

Council did not accept the additional information and advised the applicant on 20 July 2023, the following:

- 1. The basement is to be reduced in size to reflect the size of the basement garages of 23 and 27 St Thomas Street. It is currently still excessive in size.
- 2. The rear building line appears excessive in bulk and should be reduced to more closely align with the averages of either side property's rear alignment (at each corresponding level). In this regard, it is noted that properties to the south exhibit balconies to the rear which assist to reduce the perceived bulk, which may be an option for you, particularly given the need to reduce bulk

and scale of the overall development (noting the expansive open terrace area below, which contributes to bulk but not GFA is not supported in the current form).

Note: The terrace area was not proposed in the original plans and therefore this point was not included in the original deferral letter dated 15 June 2023.

3. The rear terrace is excessive in size and creates a large enclosed space. The current form breaches Part C1, Section 1.2, Control (b) as development at first floor level and above shall be set back from the rear building line of the ground floor level in order to minimise bulk and scale impacts and provide visual relief for the open space and living areas at adjacent properties. It is recommended that the primary bedroom suite is relocated from the first floor and re-positioned to the ground floor to reduce this unreasonably large area. Additionally, this terrace area appears to be enclosed by walls greater than 1.4m and therefore could meet the definition of gross floor area.

Note: The terrace area was not proposed in the original plans and therefore this point was not included in the original deferral letter dated 15 June 2023.

- 4. The current proposal when excluding this terrace area still exceeds the FSR development standard.
- 5. The privacy screen blades need to be deleted as they extend past the first floor rear building line.

Amended plans were received by Council on 11 August 2023, which differed from the originally notified plans in the following way:

- 1. The size of the basement and associated excavation was slightly reduced. This was primarily reduced via a smaller plant/storage room and electrical plant room.
- 2. The TV room and laundry room were deleted from the rear of the ground floor, with the laundry room replacing the guest bathroom. The TV room and laundry room were replaced with the outdoor terrace.
- 3. The swimming pool was amended to be located in-ground.
- 4. The screening blades to the rear of the first floor were deleted.

The amended plans received on 11 August 2023 will form the basis of the assessment.

2. ASSESSMENT

The following matters are to be considered in the assessment of this DA under section 4.15 of the *Environmental Planning and Assessment Act 1979* (the Act).

2.1. Planning Instruments and Development Control Plans

The following is an assessment against relevant legislation, environmental planning instruments, including State Environmental Planning Policies (SEPPs), and development control plans.

2.1.1. State Environmental Planning Policies (SEPPs)

The following SEPPs apply from the 1 March 2022 and have been considered acceptable in the assessment of this development application:

- SEPP (Building Sustainability Index BASIX) 2004
- SEPP (Transport and Infrastructure) 2021
- SEPP (Resilience and Hazards) 2021

A detailed discussion is provided for relevant SEPP as follows:

SEPP (Transport and Infrastructure) 2021

Ausgrid has recommended conditions of consent in accordance with Section 2.48, as the subject site is located within 5m of overhead powerlines.

2.1.2. Waverley Local Environmental Plan 2012 (Waverley LEP 2012)

The relevant matters to be considered under the Waverley LEP 2012 for the proposed development are outlined below:

Table 1: Waverley LEP 2012 Compliance Table

Provision	Compliance	Comment
Part 1 Preliminary		
1.2 Aims of plan	No	The proposed development does not meet the aims of the Waverley LEP 2012 as it proposes excessive excavation and therefore does not preserve the natural environment through appropriate planning.
Part 2 Permitted or prohibited development		
Land Use Table Low Density Residential 'R2' Zone	Yes	The proposal is defined as a dwelling house, which is permitted with consent in the R2 zone.
Part 4 Principal development standards		
4.3 Height of buildings • 8.5m	No	The dwelling has a height of 9m.

Provision	Compliance	Comment
		The development breaches the height of buildings development standard by 0.5m or 5.9%.
4.4 Floor Space Ratio (FSR); and 4.4A Exceptions to FSR • Lot Size: 349.2m² • Max GFA: 251.7m² • Max FSR: 0.72:1	No	Gross Floor Area (GFA) Calculation Basement: 10.5m² Ground Floor: 102.3m² First Floor: 145.7m² TOTAL GFA: 258.5m² TOTAL FSR: 0.74:1 The development breaches the FSR development standard by 6.8m² or 2.7%.
4.6 Exceptions to development standards	See discussion	The application is accompanied by a written request pursuant to clause 4.6 of Waverley LEP 2012 to vary the height and FSR development standards. A detailed discussion of the variation to the development standards is presented below this table.
Part 5 Miscellaneous provisions		
5.21 Flood Planning	Yes	The subject site is identified as being in a low risk flooding area. Council's Stormwater Engineer has reviewed the application and advises the property is generally well outside the 1% AEP flood extents. In addition, as there are no proposed works within the 1% AEP flood extents, it is unlikely that the development will change the existing flood behaviour.
Part 6 Additional local provisions		
6.1 Acid sulfate soils	Yes	The subject site is located within acid sulfate soils class 5. However, the proposed works are unlikely to lower the water table.
6.2 Earthworks	No	The volume of earthworks proposed for the site is excessive.

The following is a detailed discussion of the issues identified in the compliance table above in relation to the Waverley LEP 2012.

Clause 4.6 Exceptions to Development Standards - Height of buildings

The application seeks to vary the height of buildings development standard in clause 4.3 under Waverley LEP 2012.

The site is subject to a maximum height of buildings development standard of 8.5m. The proposed development has a height of 9m, exceeding the standard by 0.5m equating to a 5.9% variation.

A written request has been submitted to Council in accordance with clause 4.6(3)(a) and (b) of Waverley LEP 2012 seeking to justify the contravention of the development standard by demonstrating:

- (a) That compliance with the development standard is unreasonable or unnecessary in the circumstances of the case; and
- (b) That there are sufficient environmental planning grounds to justify contravening the standard.

A copy of the applicant's written request has been provided to the Waverley Local Planning Panel for consideration.

Applicant's Written Request - Clause 4.6(3)(a) and (b)

The applicant seeks to justify the contravention of the height of buildings development standard on the following basis.

- (a) That compliance with the development standard is unreasonable or unnecessary in the circumstances of the case:
 - The proposal satisfies the objectives of the R2 Low Density Residential zone and the objectives of the height development standard.
 - The departure from the standard relates to 16m² of roof elements only. This represents only 10% of the proposed 156m² of overall roof.
 - The departure to the standard is a direct function of the existing ground levels and the site and locality's topography. The roof elements do not unreasonably add to the built form's perceived height, bulk and scale, nor its environmental impacts. The resultant height, bulk and scale of the dwelling is like its neighbouring dwellings on the western side of St Thomas Street where an appropriate transition in height is provided.
 - In general, built form slopes down from south to north and west to east, following the topography of the street and locality. The proposal steps down the site and when viewed from both the front and rear (where it complies) of the site, the proposal is of a similar height and number of storeys as the neighbouring properties.
 - Although the proposal departs from the FSR standard, part of which is provided within the
 basement level, the visible parts of the dwelling when viewed from the public domain or
 neighbouring properties is one that is anticipated by the planning controls. The proposed front
 and rear building alignments and side boundary setbacks comply and/or are consistent with that
 existing.
 - The nature of such an urban environment is that all future development will seek to maximise levels of residential amenity and density through design.
 - The locality's subdivision pattern and resultant building proximity creates privacy impacts. Given the existing and proposed built form, there is a degree of mutual overlooking, however, the proposal is not considered to increase mutual overlooking to an unacceptable level.
 - The development responds to view sharing principles in a highly urbanised city environment. A consistent front and rear building alignment is maintained and compliant side boundary setbacks are proposed. This design condition will retain / share the easterly views. Properties to the site's

west are higher up the ridge and oriented in a north south direction and therefore from their upper floor level look across their side boundary through the site and beyond with established perimeter landscaping provided in between. The largely unaltered impacts of the development in terms of views and vistas is acceptable given the circumstances of the case and the expected future built form potential on neighbouring and nearby properties.

- Within its locational context, the site can accommodate the built form as proposed and the
 development is of an intensity and scale commensurate or not incompatible with the built form
 character and the prevailing urban conditions and capacity of the locality, including neighbouring
 properties.
- The overall height of the building does not preclude (and hasn't done so in the past) redevelopment of neighbouring or nearby properties.
- The standard's departure and the development generally are not inconsistent with the relevant objectives of the standard because they do not materially alter the existing correlation between building height and density, and the correlation is appropriate under the circumstances. Nor do they alter the buildings' compatibility with the bulk, scale, streetscape or desired future character of the locality, and that compatibility is appropriate under the circumstances given the overall lack of adverse impacts to neighbouring properties and the surrounding public domain.
- Although a departure to the wall height guideline is proposed to the front of the northern and southern elevations, the departure is a direct function of the existing ground levels and the site and locality's topography. Floor to ceiling heights for the ground floor and first floor level are only the standard 2.7m. The resultant wall height and overall height is clearly not incompatible with the wall heights of each neighbour to the north and south respectively.
- The proposal responds and contributes to its context by engaging its desired future character as envisaged by the permissible land uses and densities in the surrounding locality. The surrounding area is undergoing a period of regeneration.
- The dwelling's massing responds accordingly as well as considering the existing built form adjacent. The scale is also broken down by the articulation of facades with the use of different materials and elements which helps reduce the perception of any apparent bulk. The proposal exhibits a height, bulk and scale which is not incompatible with the predominant multi level built form character on the western side of St Thomas Street.
- (b) That there are sufficient environmental planning grounds to justify contravening the standard:
 - The departure to the standard is a direct function of the existing ground levels and the site and locality's topography. The roof elements do not unreasonably add to the built form's perceived height, bulk and scale, nor its environmental impacts.
 - The resultant height, bulk and scale of the dwelling is like its neighbouring dwellings on the western side of St Thomas Street where an appropriate transition in height is provided.
 - The proposal steps down the site and when viewed from both the front and rear (where it complies) of the site, the proposal is of a similar height and number of storeys as the neighbouring properties.

- The visible parts of the dwelling when viewed from the public domain or neighbouring properties is one that is anticipated by the planning controls. The proposed front and rear building alignments and side boundary setbacks comply and/or are consistent with that existing.
- The development preserves the environmental amenity of neighbouring properties. The proposed new dwelling house and its surrounds and specifically the roof elements which depart from the standard nonetheless provide for an acceptable and equitable planning outcome and preserve environmental amenity in relation to:
 - Solar access and overshadowing;
 - Access to natural daylight and ventilation;
 - Aural and visual privacy;
 - Views and vistas from private properties and the public domain; and
 - Visual impact.

Consideration of Applicant's Written Request - Clause 4.6(4) (a) (i) and (ii)

Development consent must not be granted unless the consent authority is satisfied that:

- (a) The applicant's written request has adequately addressed the matters required to be demonstrated by subclause 3 of clause 4.6 being that compliance with the development standard is unreasonable or unnecessary in the circumstances of the case, and that there are sufficient environmental planning grounds to justify contravening the standard; and
- (b) The proposed development will be in the public interest because it is consistent with the objectives of the particular development standard and the objectives for development within the zone in which the development is proposed to be carried out.

Does the written request adequately address those issues at clause 4.6(3)(a)?

It is considered that the applicant has adequately addressed that compliance with the standard is unreasonable or unnecessary in the circumstances of the case and has referenced one or more of the following justifications as set out in *Wehbe v Pittwater Council* (2007) 156 LGERA 446:

- (a) the objectives of the development standard are achieved notwithstanding non-compliance with the standard;
- (b) to establish that the underlying objective or purpose is not relevant to the development with the consequence that compliance is unnecessary;
- (c) to establish that the underlying objective or purpose would be defeated or thwarted if compliance was required with the consequence that compliance is unreasonable;
- (d) to establish that the development standard has been virtually abandoned or destroyed by the Council's own actions in granting consents departing from the standard and hence compliance with the standard is unnecessary and unreasonable; and
- (e) to establish that "the zoning of particular land" was "unreasonable or inappropriate" so that "a development standard appropriate for that zoning was also unreasonable or unnecessary as it

applied to that land" and that "compliance with the standard in that case would also be unreasonable or unnecessary.

The applicant specifically relies upon justification (a) outlined above to address clause 4.6(3)(a) of Waverley LEP 2012. The justification provided by the applicant is not sound as the proposed development does not meet objective (a) of the development standard, as it does not preserve the environmental amenity of neighbouring properties. The proposed development overshadows north facing habitable room windows of No.27 St Thomas Street at 9am and 3pm.

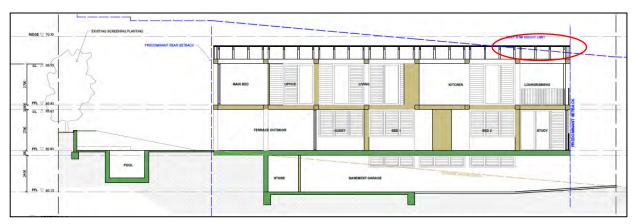


Figure 4. Section A-A showing portion of the development which exceeds height. (Source: Clinton Murray Architects, 2023)

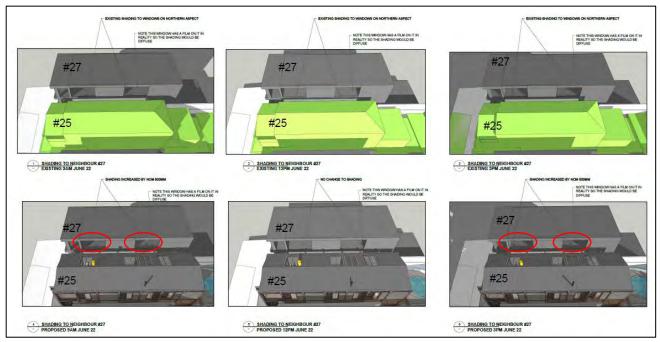


Figure 5. Shadow diagrams showing shadow impacts to windows of 27 St Thomas Street, Bronte (Source: Clinton Murray Architects, 2023)

Additionally, the proposed development may result in a view loss from No.27 St Thomas Street to the Tamarama Headland (refer to **Figure 10** below).

Does the written request adequately address those issues at clause 4.6(3)(b)?

The applicant has not adequately addressed that there are sufficient environmental planning grounds to justify contravening the development standard. As it has been discussed above, the proposed development results in unreasonable shadow and view impacts to No.27 St Thomas Street, Bronte.

Is the development in the public interest?

The proposed development will not be in the public interest because it is inconsistent with both the objectives of the particular development standard and the objectives for development within the zone in which the development is proposed to be carried out.

The relevant objectives of the height development standard are as follows:

(a) to ensure building heights preserve the environmental amenity of neighbouring properties and public spaces and, if appropriate, the sharing of views,

.....

- (c) to maintain satisfactory solar access to existing buildings and public areas,
- (d) to establish building heights that are consistent with the desired future character of the locality.

Council disagrees with the contention that the objectives of the height development standard are achieved. The applicant has not adequately demonstrated that the overall scale of the development preserves the environmental amenity of neighbouring properties as stated at objective (a). The proposed development will have additional overshadowing impacts on adjoining properties particularly the property to the south at No.27 St Thomas Street.

The proposal may also result in view loss impacts to the property located to the south at No.27 St Thomas Street. Whilst these views are obtained across a side boundary, the property at No.27 St Thomas Street currently enjoys views towards the Tamarama Headland from the front first floor north-east facing living area. This is addressed in further detail under Section 2.1.3 of this report.

The objectives of the R2 Low Density Residential zone are as follows:

- To provide for the housing needs of the community within a low density residential environment.
- To enable other land uses that provide facilities or services to meet the day to day needs of residents.
- To maximise public transport patronage and encourage walking and cycling.
- To ensure dwelling character, landscape character, neighbourhood character, streetscapes and amenity are maintained or enhanced over time.
- To encourage the supply of housing that meets the needs of the population, particularly housing for older people and people with disability.

- To promote development that incorporates planning and design measures that reduce the urban heat island effect.
- To improve the urban tree canopy by providing high levels of deep soil planting and additional landscaping.

Whilst it is acknowledged that the proposed development does provide for the housing needs of the community by developing the site for low density residential purposes, the overall planning outcome for the site to achieve this objective is unacceptable and cannot be supported.

Conclusion

For the reasons provided above the requested variation to the height is not supported, while the applicant's written request has adequately addressed the matters required to be addressed by clause 4.6(3) of the Waverley LEP 2012, the proposed development is not in the public interest because it is inconsistent with the objectives of height and the zone.

Clause 4.6 Exceptions to Development Standards - FSR

The application seeks to vary the FSR development standard in clause 4.4 under Waverley LEP 2012.

The site is subject to a maximum FSR development standard of 0.72:1. The proposed development has a FSR of 0.74:1, exceeding the standard by 6.8m² equating to a 2.7% variation.

A written request has been submitted to Council in accordance with clause 4.6(3)(a) and (b) of Waverley LEP 2012 seeking to justify the contravention of the development standard by demonstrating:

- (a) That compliance with the development standard is unreasonable or unnecessary in the circumstances of the case; and
- (b) That there are sufficient environmental planning grounds to justify contravening the standard.

A copy of the applicant's written request has been provided to the Waverley Local Planning Panel for consideration.

Applicant's Written Request - Clause 4.6(3)(a) and (b)

The applicant seeks to justify the contravention of the FSR development standard on the following basis:

- (a) That compliance with the development standard is unreasonable or unnecessary in the circumstances of the case:
- The standard's departure and the development generally are not inconsistent with the relevant objectives of the standard because they do not materially alter the existing correlation between building height and density, and the correlation is appropriate under the circumstances. Nor do

- they alter the buildings' compatibility with the bulk, scale, streetscape or desired future character of the locality, and that compatibility is appropriate under the circumstances given the overall lack of adverse impacts to neighbouring properties and the surrounding public domain.
- The surrounding locality is characterised by multi-level elevated dwellings and residential apartment buildings set on land influenced by the locality's topographical characteristics.
- This GFA does not add to the dwelling's bulk and scale. The dwelling's visible elements when viewed from the public domain or neighbouring properties is one that is generally anticipated by the planning controls and one which is not dissimilar to that existing. Furthermore, the proposed front, rear and side boundary building alignments comply and/or are consistent with that existing.
- The rear of the dwelling is not visible and there is clearly no perception of visual built form dominance, excessive bulk and scale or excessive technical GFA/FSR. Compliant curtilage to each side boundary neighbour has also been maintained.
- The height, bulk and scale of the built form does not influence or set a precedent for future buildings on neighbouring or nearby properties. Rather the new dwelling is not incompatible with the site's wider visual context as viewed from the surrounding public domain, given the scale and form of development (as anticipated by the planning controls) and as existing in the site's vicinity.
- The objective of an FSR standard is to ensure that the intensity of development respects and reflects the overall built form of a locality and does not detrimentally affect the amenity of the area. The maximum FSR that a site can achieve is determined by its environmental constraints relative to overshadowing, privacy, streetscape, built form character, parking, traffic generation, landscaping, visual impact and views and the capacity of the community infrastructure. The proposal has been designed to minimise impacts and has had regard to site users and neighbours. There are no unreasonable amenity or adverse environmental impacts.
- The 44.6m² of GFA that exceeds the FSR standard does not result in a building which is out of scale with the locality's future (desired) built form character. Additionally, 16m² of GFA is contained within the basement level. This GFA does not add to the dwelling's bulk and scale.
- The dwelling's floorspace is not visually prominent from the surrounding public domain. Clearly there is no perception of visual built form dominance, excessive bulk and scale or excessive technical GFA/FSR. The dwelling generally sits within an envelope and which is not dissimilar to that already considered acceptable on neighbouring and nearby properties.
- Habitable accommodation is not provided above the height standard. Although the proposal departs from the FSR standard, GFA/FSR is not provided above the height standard. The proposed GFA/FSR is therefore entirely contained within the anticipated building envelope location / form.
- The new dwelling provides for an acceptable and equitable planning outcome in relation to:
 - solar access and overshadowing;
 - access to natural daylight and ventilation;
 - aural and visual privacy;
 - views and vistas;
 - visual impact; and
 - parking and traffic generation.
- (b) That there are sufficient environmental planning grounds to justify contravening the standard:

- Superior residential amenity will be provided to the occupants whilst preserving/ maintaining the
 amenity (solar access, visual and aural privacy, views, vistas, outlook, natural daylight and
 ventilation) of the neighbouring properties and the surrounding public domain. This is a desirable
 outcome.
- This GFA does not add to the dwelling's bulk and scale. The dwelling's visible elements when viewed from the public domain or neighbouring properties is one that is generally anticipated by the planning controls and one which is not dissimilar to that existing. Furthermore, the proposed front, rear and side boundary building alignments comply and/or are consistent with that existing. This dictates the desired or future building envelope and location.
- Despite the FSR departure and the near negligible roof element departure to the height standard, compliance has been maintained with the DCP 2022 guidelines in relation to front and rear setbacks, side setbacks, open space, landscaped area, private open space and car parking. A minor departure to the wall height guideline (in the same location as the height standard departure) is proposed, however most of the dwelling complies with both controls and is not dissimilar to that existing on neighbouring properties.
- Although it departs from the FSR standard, the new built form and the quantum of GFA/FSR provided above the standard is nonetheless consistent with the locality's desired future character and the departure does not result in any unreasonable amenity or environmental impacts to neighbouring properties or the surrounding public domain.
- The development provides for an appropriate environmental planning outcome and is not an overdevelopment of the site as follows:
 - The proposal satisfies the objectives of the R2 Low Density Residential zone;
 - The proposal satisfies the objectives of the FSR standard;
 - The proposed works departing from the standard do not result in unreasonable amenity impacts;
- The nature of such an urban environment is that all future development will seek to maximise amenity and density through design. In this regard, the proposal represents an appropriate planning outcome with any unreasonable amenity or environmental impacts; and removing the non-compliance would not alter the perceived height, bulk and scale of the new dwelling house, considering its established context. The new dwelling is clearly not incompatible considering its wider visual context.

Consideration of Applicant's Written Request - Clause 4.6(4) (a) (i) and (ii)

Development consent must not be granted unless the consent authority is satisfied that:

(a) The applicant's written request has adequately addressed the matters required to be demonstrated by subclause 3 of clause 4.6 being that compliance with the development standard is unreasonable or unnecessary in the circumstances of the case, and that there are sufficient environmental planning grounds to justify contravening the standard; and

(b) The proposed development will be in the public interest because it is consistent with the objectives of the particular development standard and the objectives for development within the zone in which the development is proposed to be carried out.

Does the written request adequately address those issues at clause 4.6(3)(a)?

It is considered that the applicant has adequately addressed that compliance with the standard is unreasonable or unnecessary in the circumstances of the case and has referenced one or more of the following justifications as set out in *Wehbe v Pittwater Council* (2007) 156 LGERA 446:

- (a) the objectives of the development standard are achieved notwithstanding non-compliance with the standard;
- (b) to establish that the underlying objective or purpose is not relevant to the development with the consequence that compliance is unnecessary;
- (c) to establish that the underlying objective or purpose would be defeated or thwarted if compliance was required with the consequence that compliance is unreasonable;
- (d) to establish that the development standard has been virtually abandoned or destroyed by the Council's own actions in granting consents departing from the standard and hence compliance with the standard is unnecessary and unreasonable; and
- (e) to establish that "the zoning of particular land" was "unreasonable or inappropriate" so that "a development standard appropriate for that zoning was also unreasonable or unnecessary as it applied to that land" and that "compliance with the standard in that case would also be unreasonable or unnecessary.

The applicant specifically relies upon justification (a) outlined above to address clause 4.6(3)(a) of Waverley LEP 2012. The justification provided by the applicant is not sound as the proposed development does not meet objective (d) of the development standards, as it does not preserve the environmental amenity of neighbouring properties. The proposed development overshadows north facing habitable room windows of No.27 St Thomas Street at 9am and 3pm, as demonstrated in **Figures 4** and **5** above. Additionally, the proposed development may result in a view loss to the Tamarama Headland from No.27 St. Thomas Street (refer to **Figure 10** below).

Does the written request adequately address those issues at clause 4.6(3)(b)?

The applicant has not adequately addressed that there are sufficient environmental planning grounds to justify contravening the development standard. As it has been discussed above, the proposed development results in unreasonable shadowing impacts to No.27 St. Thomas Street.

The siting of the dwelling and the excavation required will result in unreasonable impacts on the amenity of neighbouring properties. The development has not been designed in a skillful manner to limit those impacts which include view loss and overshadowing.

Is the development in the public interest?

The proposed development will not be in the public interest because it is inconsistent with both the objectives of the particular development standard and the objectives for development within the zone in which the development is proposed to be carried out.

The relevant objectives of the FSR development standard are as follows:

.....

- (b) to provide an appropriate correlation between maximum building heights and density controls,
- (c) to ensure that buildings are compatible with the bulk and scale of the desired future character of the locality,
- (d) to establish limitations on the overall scale of development to preserve the environmental amenity of neighbouring properties and the locality.

Council disagrees with the contention that the objectives of the FSR development standard are achieved. The applicant has not adequately demonstrated that the overall scale of the development preserves the environmental amenity of neighbouring properties as stated at objective (d). The proposed development will have additional overshadowing impacts on adjoining properties particularly the property to the south at No.27 St Thomas Street.

The proposal may also result in view loss impacts to the property located to the south at No.27 St Thomas Street. Whilst these views are obtained across a side boundary, the property at No.27 St Thomas Street currently enjoys views towards the Tamarama Headland from the front first floor north-east facing living area. This is addressed in further detail under Section 2.1.3 of this report.

The objectives of the R2 Low Density Residential zone are as follows:

- To provide for the housing needs of the community within a low density residential environment.
- To enable other land uses that provide facilities or services to meet the day to day needs of residents.
- To maximise public transport patronage and encourage walking and cycling.
- To ensure dwelling character, landscape character, neighbourhood character, streetscapes and amenity are maintained or enhanced over time.
- To encourage the supply of housing that meets the needs of the population, particularly housing for older people and people with disability.
- To promote development that incorporates planning and design measures that reduce the urban heat island effect.
- To improve the urban tree canopy by providing high levels of deep soil planting and additional landscaping.

Whilst it is acknowledged that the proposed development does provide for the housing needs of the community by developing the site for low density residential purposes, the overall planning outcome for the site to achieve this objective is unacceptable and cannot be supported.

Conclusion

For the reasons provided above, the requested variation to the FSR is not supported, while the applicant's written request has adequately addressed the matters required to be addressed by clause 4.6(3) of the Waverley LEP 2012, the proposed development is not in the public interest because it is inconsistent with the objectives for FSR and the zone.

2.1.3. Waverley Development Control Plan 2022 (Waverley DCP 2022)

The relevant matters to be considered under the Waverley DCP 2022 for the proposed development are outlined below:

Table 2: Waverley DCP 2022 – Part B General Provisions Compliance Table

Development Control	Compliance	Comment
1. WasteGarbage bins are to be stored in an appropriate location.	Yes	Satisfactory.
2. Ecologically		
Sustainable Development		
Ceiling or wall mounted fans	Yes	Ceiling fans are notated on the plans.
 Gas cooktops, gas ovens or gas internal space heating systems. 	Yes	Electric cooking is notated on the plans.
3. Landscaping,	N/A	Tree removal is not proposed.
Biodiversity and	.,,	The state of the s
Vegetation Preservation		
5.Water Management	Conditional	Council's stormwater Engineer has reviewed the application and recommended conditions of consent.
7. Transport		
7.1 Streetscape	Yes	The off-street parking when viewed from the streetscape is acceptable, with a similar streetscape presentation to other dwellings to this portion of St Thomas Street.
7.2 On-Site Parking	Yes	The subject site is located within Parking Zone 2.
7.2.1 Vehicle Access	Yes	The existing driveway crossover is acceptable.

Development Control	Compliance	Comment	
7.2.2 Parking Rates	No The proposed extent of the basement car p makes it capable of accommodating three c street parking spaces which is in excess of t maximum of two spaces allowable under the DCP.		
11. Design Excellence	No	The proposed development does not achieve design excellence as it is not suitable for the land providing excessive excavation and is poorly designed by reducing amenity to neighbouring properties, provides an excessive bulk particularly when viewed from the rear and an excessive street frontage height.	
13. Excavation	No	The subject site is permitted to have a maximum excavated area of 119.84m³. The development proposes an excavated volume of approximately 244m³. The development also proposes excavation to the side boundaries (as shown in Section B-B) which is not supported.	

Table 33: Waverley DCP 2022 – Part C1 Low Density Residential Development Compliance Table

Development Control	Compliance	Comment
	Compliance	Comment
1.0 General Objectives		
	No	The proposal contravenes the general objectives of this part of the Waverley DCP 2022.
		The proposal is not of an appropriate scale for the lot, exceeding both height and FSR which impacts the amenity of the neighbouring property by reducing solar access and impacting on views.
1.1 Height		
 Pitched roof dwelling house Maximum external wall height of 7m 	No	The development exceeds the maximum wall height of 7m, with an overall wall height of 7.6m proposed.
1.2 Setbacks		
 1.2.1 Front and rear building lines Predominant front building line (adjacent three neighbours on 	Yes	Garage Front Building Line The proposed garage is constructed to the front boundary, similar to Nos.23 and 27 St Thomas Street.
either side) • Predominant rear building line at each floor	No	Ground Floor Front Building Line The proposed ground floor building line setback of 2.985m extends past the correlating 3.5m

Development Control	Compliance	Comment
level (adjacent three neighbours or either side)		front building line setback of No.23 St Thomas Street. As the study room is located on the northern side of the property, it is appropriate to use the neighbouring property to the north at No. 23 St Thomas Street to assess an appropriate building line. In this case, it does not comply.
	No	First Floor Front Building Line The proposal seeks to provide an enclosed building form at first floor level. To the south, No 23 St Thomas Street is also enclosed at first floor level, though setback further, compared to that being proposed.
		Uphill adjoining properties (Nos 27, 29 St Thomas Street), exhibit setback first floor levels (ie glazing line) with balconies to the first floor level which soften the bulk and scale to the streetscape.
		In this instance, the proposal seeks an enclosed form that protrudes in front of No 23 and aligns with the balustrade of No 27 (not the glazing line of No 27). The resultant effect is considered to present an unnecessarily bulkiness to the streetscape, beyond those in the immediate vicinity.
	Partial	Ground Floor Rear Building Line The proposed ground floor glazing line aligns with No 23 to the south, though provides a support structure that extends this out to align with No 27. The resultant effect provides a large roofed outdoor space that provides an overly bulky form.
	No	First Floor Rear Building Line The proposed first floor is appropriately in line with the rear first floor building line of No.27 St Thomas Street. Having regard to either side property, it is anticipated a better tapering / average would be proposed.
 1.2.2 Side setbacks Minimum of 0.9m for ground floor and first floors.) 	Yes	The development provides 0.9m side setbacks to the built form.
1.3 Streetscape and visual imp	pact	
New development to be compatible with streetscape context	No	Each dwelling from 21-29 St Thomas Street (excluding the subject site) have flat roofs (refer to Figure 1). The proposed pitched roof form will

Development Control	Compliance	Comment
 Replacement windows to complement the style and proportions of existing dwelling Significant landscaping to be maintained. 		not be reflective of the built form in the immediate streetscape. Additionally, as detailed above, the proposal presents a significant bulk and scale to the streetscape which is more pronounced than those adjoining. Ideally, an improved softening to the streetscape and tapered setback would be encouraged.
1.4 Fences		
 Front: Maximum height of 1.2m Solid section no more than 0.6m in height 	N/A	No front fencing is proposed
Side and Rear: Maximum height of 1.8m	As existing	Existing side and rear fencing are being retained.
1.5 Visual and acoustic privacy	v	
Habitable windows are not to directly face habitable windows or open space of neighbouring dwellings unless direct views are screened or other appropriate measures are incorporated into the design	Yes Yes Yes	The southern elevation of No.23 St Thomas Street exhibit's minimal openings. The northern elevation of the proposal incorporates a large number of floor to ceiling windows, however in light of the largely blank elevation opposite, the proposed windows to the northern elevation of the subject site are acceptable as they will not result in visual privacy issues. The proposed southern elevational windows are fixed with privacy louvers, which are acceptable. Existing side boundary fencing will assist with visual privacy.
1.6 Solar access		visual privacy.
Minimum of 3 hours of sunlight to 50% of living areas and principal open space areas on 21 June to subject site	Yes	
 Minimum of 3 hours of sunlight maintained to at least 50% of principal open space areas of adjoining properties on 21 June. 	Yes	The proposed development will not reduce solar access to neighbouring private open space and living areas to less than 50% of the area for three or more hours.
 avoid the unreasonable overshadowing of solar collectors on a nearby property 	No	The proposed development will overshadow the north facing windows of No. 27 St Thomas Street. As the proposed development exceeds both height and FSR, no additional overshadowing to neighbouring windows or private open space is acceptable.

Development Control	Compliance	Comment
1.7 Views		
 Views from the public domain are to be maintained Development to be designed and sited so as to enable a sharing of views with surrounding dwellings particularly from habitable rooms and decks. 	Yes No	See further discussion below this table
1.8 Car parking		
 1.8.1 Design Approach Parking only allowed where site conditions permit Designed to complement the building and streetscape Car parking structures to be behind the front building line Driveways are to be located to minimise the loss of on street parking Parking to be provided from secondary streets or lanes where possible. 	Yes	The off-street parking when viewed from the streetscape is acceptable, with a similar streetscape presentation to other dwellings to this portion of St Thomas Street.
1.8.2 Parking rates	Yes	The proposed development is permitted a maximum of two off-street parking spaces under the DCP, however, due to the excessive size of the garage/basement the development could easily provide three or more off-street parking spaces, which would not comply with the development control.
 1.8.3 Location Parking to be behind front building line for new dwellings Existing development to be in accordance with the hierarchy of preferred car parking locations 	Yes	The location of the garage is acceptable and similar to others in the street.
1.8.4 Design Complement the style, massing and detail of the dwelling	Yes	The off-street parking when viewed from the streetscape is acceptable, with a similar streetscape presentation to other dwellings to this portion of St Thomas Street.

Development Control	Compliance	Comment
 Secondary in area and appearance to the design of the residences No part of the façade is to be demolished to accommodate car parking Gates to have an open design 1.8.5 Dimensions 5.4m x 2.4m per vehicle 1.8.6 Driveways Maximum of one per property Maximum width of 3m at the gutter (excluding splay) Crossings not permitted where 2 on street spaces 	Yes	The internal dimensions of the garage is capable of supporting two vehicles. The existing driveway crossover is acceptable. If the application was recommended for approval, conditions of consent would be recommended.
are lost 1.9 Landscaping and open spa	ce	
 Overall open space: 40% of site area Overall landscaped area: 20% of site area, with at least half deep soil Minimum area of 25m² for private open space Front open space: 50% of front building setback area Front landscaped area: 50% of front open space provided 	Yes No Yes Yes No	Limited information has been provided to assess the amount of landscaped and deep soil area proposed on site. Over 25m² Over 50% Limited information has been provided to assess the amount of landscaped and deep soil area proposed on site. Additionally, the primary outdoor area for the dwelling, is hard surface (roofed) and attached to a guest bedroom and laundry rather than the primary living zone of the dwelling, which is considered an undesirable outcome. With the centralised location of the swimming pool at the rear, there is very little usable landscaping available for occupants of the dwelling to utilise with the current design. This is considered to provide poor amenity and could be enhanced.
1.10 Swimming pools and spaLocated in the rear of	pools Yes	The proposed swimming pool is located to the
property	103	rear of the property.

De	evelopment Control	Compliance	Comment
•	Pool decks on side boundaries must consider visual privacy All pool equipment to be		
	enclosed within an acoustically treated enclosure		

The following is a detailed discussion of the issues identified in the compliance tables above in relation to the Waverley DCP 2022.

View Impacts

Part C1 1.7 *Views* of Waverley DCP 2022 details all objectives and strategies for public and private domain views and view sharing, which generally seek to reduce impacts on existing views and vistas from the private and public domain. The proposal has also been assessed against the Land and Environment Court's Tenacity principle for view sharing.

During public notification, the following properties indicated that the proposed development will impact on private domain views:

- 4/120-128 Macpherson Street, Bronte
- 5/120-128 Macpherson Street, Bronte
- 8/120-128 Macpherson Street, Bronte
- 9/120-128 Macpherson Street, Bronte
- 27 St. Thomas Street, Bronte

Council's Development Assessment Planner undertook a site visit to the apartments within 120-128 MacPherson Street, Bronte and requested photographs from No.27 St Thomas Street, Bronte. These images were provided to the Architect who then used those images to provide the below view impact diagrams.



proposed building outline

Figure 6. View impact diagram - 4/120-128 Macpherson Street, Bronte. (Source: Clinton Murray Architects, 2023)



proposed building outline

Figure 7. View impact diagram - 5/120-128 Macpherson Street, Bronte. (Source: Clinton Murray Architects, 2023)



proposed building outline

Figure 8. View impact diagram - 8/120-128 Macpherson Street, Bronte. (Source: Clinton Murray Architects, 2023)



Figure 9. View impact diagram - 8/120-128 Macpherson Street, Bronte. (Source: Clinton Murray Architects, 2023)



proposed building outline

Figure 10. View impact diagram - 27 St Thomas Street, Bronte (Source: Clinton Murray Architects, 2023)

The view impact analysis taken from the units at 120-128 Macpherson Street, Bronte shows that views enjoyed by these units are not obstructed as a result of the proposed development.

In regards to the property at No.27 St Thomas Street, whilst it is acknowledged that the subject views identified above are across a side boundary which, as outlined in the Tenacity planning principle, are more difficult to protect, the impact on the Tamarama Headland view as a result of the proposed development is considered to be unreasonable, particularly given the breach of both the height and FSR development standards. A more skillful design could provide the applicant with reasonable amenity and reduce the impact on the views of neighbours. Further design resolution is required to reduce the extent of building envelope proposed, with a reduction of bulk and scale required at the front to facilitate views across the development. Having regard to the above view impacts it is considered that the proposal is unreasonable given the environmental amenity of the adjoining properties is not preserved. As outlined in the Clause 4.6 discussions above, any environmental impact from portions of the development that breach height and FSR are not supported.

2.2. Other Impacts of the Development

The proposal is considered to have a significant detrimental effect relating to environmental, social or economic impacts on the locality, and is recommended for refusal.

2.3. Suitability of the Site for the Development

The site is not considered suitable for the proposal.

2.4. Any Submissions

The application was notified for 14 days from 10 May until 24 May 2023 in accordance with the *Waverley Community Development Participation and Consultation Plan*.

Following receipt of amended plans and additional information, the application was not re-notified as the amended form of the proposal represents a lesser impact than that of the original form that was publicly notified, for the following reasons:

- 1. The size of the basement and associated excavation was slightly reduced. This was reduced via amendments to provide a smaller plant/storage room and electrical plant room.
- 2. The TV room and laundry room were deleted from the rear of the ground floor, with the laundry room replacing the guest bathroom. The TV room and laundry room were replaced with an outdoor entertaining area.
- 3. The swimming pool was amended to be located in-ground.
- 4. The screening blades to the rear of the first floor were deleted.

A total of 16 unique submissions were received from the following properties:

Table 4: Number of and where submissions were received from.

Count	Property Address
1	4/120-128 Macpherson Street, Bronte
2	5/120-128 Macpherson Street, Bronte
3	8/120-128 Macpherson Street, Bronte
4	9/120-128 Macpherson Street, Bronte
7	23 St. Thomas Street, Bronte (3 unique objections)
13	27 St. Thomas Street, Bronte (6 unique objections)
15	29 St. Thomas Street, Bronte (2 unique objections)
16	7 Albert Street, Bronte

The following issues raised in the submissions have already been discussed and addressed in the body of this report and/or the recommendation:

- Excessive FSR;
- Excessive height;
- Excessive excavation;
- Setbacks;
- Solar access;
- Visual privacy;
- View loss; and
- Lack of landscaping to front open space.

All other issues raised in the submissions are summarised and discussed below.

Issue: Floor-to- ceiling height to basement is excessive.

Response: The 2.4m floor-to-ceiling height of the basement is acceptable.

Issue: Mechanical plant/pool equipment's located to the rear, south side of the property will reduce acoustic privacy.

Response: If approved, a condition would be recommended that the pool equipment be enclosed in an acoustically treated enclosure.

Issue: Unauthorised existing works

Response: This would need to be reported to the Compliance Department for investigation but does not provide a reason for the refusal of this application.

Issue: Above-ground pool and associated decking will result in visual privacy impacts.

Response: The proposal has been amended so that the swimming pool is to be located in-ground.

Issue: Accessing meters.

Response: This is a civil matter and does not provide a reason for refusal of the development application.

Issue: Plant rooms are excessive and could be used as habitable rooms.

Response: The development does not propose habitable rooms within the basement level.

Issue: The garage could accommodate three vehicles.

Response: The amount of excavation proposed for the large garage area is a reason for refusal.

Issue: Unacceptable Geotechnical Report.

Response: If approved, excavation related conditions would be recommended.

2.5 Public Interest

The proposal is considered to have a detrimental effect on the public interest and is recommended for refusal.

3. REFERRALS

The following internal and external referral comments were sought:

3.1. Traffic and Development

An internal referral was sought from Council's Traffic Engineer who recommended conditions of consent.

3.2. Stormwater

An internal referral was sought from Council's Stormwater Engineer who recommended conditions of consent.

3.3. Tree Management

An internal referral was sought from Council's Tree Officer who recommended conditions of consent.

3.4. Ausgrid

An external referral was sought from Ausgrid who recommended conditions of consent.

4. CONCLUSION

The Development Application (DA) seeks consent for the demolition and construction of a new three storey dwelling including a basement garage and new swimming pool at the site known as 25 St Thomas Street, Bronte.

The principal issues arising from the assessment of the application are as follows:

- Breach to height;
- Breach to FSR; and
- Volume of excavation.

The assessment finds these issues unacceptable. The proposed development exceeds both the height of buildings and FSR development standards, whilst failing to meet the objectives of the development standards by not preserving the environmental amenity of neighbouring properties through reduced solar access and view impacts. In addition, the volume of excavation is excessive. Overall, the proposed bulk and scale requires further reduction and could be readily achieved if the applicant were willing. To enable support of the proposal.

A total number of 16 submissions were received and the issues raised in the submissions have been considered and addressed in this report and in the recommendation.

The application has been assessed against the relevant matters for consideration under section 4.15(1) of the *Environmental Planning and Assessment Act 1979*. It is recommended for refusal.

5. RECOMMENDATION TO WAVERLEY LOCAL PLANNING PANEL

That the development application be **REFUSED** by the Waverley Local Planning Panel for the reasons contained in Appendix A.

Report prepared by:	Application reviewed and agreed by:	Application reviewed and agreed by:
J/gmuille	JZancanaw	R
Joseph Somerville	Jo Zancanaro	Angela Rossi
Senior Development	A/ Manager, Development	A/ Executive Manager,
Assessment Planner	Assessment	Development Assessment
Date: 25 August 2023	Date: 30 August 2023	Date: 31 August 2023

Reason for WLPP referral:

1. Contentious development (10 or more objections)

OFFICE USE ONLY

Clause 4.6 register entry required	No
Determining Authority	Local Planning Panel
(Concurrence Authority for Clause 4.6 variation)	
Affordable Rental Housing Units? *This is a planning portal reporting requirement	No
Secondary Dwelling *This is a planning portal reporting requirement	No
Boarding House *This is a planning portal reporting requirement	No
Group Home *This is a planning portal reporting requirement	No
Trial Period database entry required	No
VPA submitted – follow up actions required	No
Refer to compliance for investigation	No
Commercial/liquor operational conditions	No
Other (please specify):	No

APPENDIX A – REASONS FOR REFUSAL

Having regard to section 4.15 (1) of the *Environmental Planning and Assessment Act 1979 (the Act)* the development application (the application) is refused for the following reasons:

1. The application does not satisfy section 4.15 (1)(a)(i) of the Act as it contrary to the following provisions of *Waverley Local Environmental Plan* (WLEP) 2012:

a. Clause 4.3 Height of Buildings

The application exceeds the maximum allowable height of 8.5m and the applicant's written request under clause 4.6 of WLEP has failed to adequately address the required matters under subclauses 4.6 (3)(a) and (b) of WLEP.

Details: The proposed height does not preserve the environmental amenity of neighbouring properties by creating overshadowing and view loss to No.27 St Thomas Street, Bronte contrary to clause 4.3(1)(a) of WLEP.

b. Clause 4.4 Floor Space Ratio

The application exceeds the maximum allowable Floor Space Ratio (FSR) of 0.72:1 and the applicant's written request under clause 4.6 of WLEP has failed to adequately address the required matters under subclauses 4.6 (3)(a) and (b) of Waverley LEP

Details: The proposed Floor Space Ratio does not preserve the environmental amenity of neighbouring properties by creating overshadowing and view loss to No.27 St Thomas Street, Bronte contrary to clause 4.4(1)(d) of WLEP.

- c. *Clause 6.2 Earthworks,* specifically clause (3)(h) as appropriate measures have not been proposed to minimise the volume of excavation.
- 2. The application does not satisfy section 4.15 (1)(a)(iii) of the Act as it is contrary to Waverley Development Control Plan (WDCP) 2022, in respect to the following provisions:

Part B11 Design Excellence

a. Section 11.1 Design, specifically objectives (a), (c) and (d) and controls (a) and (e)(i), (iv), (v), (vi) as the proposed development is not suitable for the land providing excessive excavation and is poorly designed by reducing amenity to neighbouring properties, provides an excessive bulk created from the rear ground floor terrace area and an excessive street frontage height.

Part B13 Excavation

b. Specifically objectives (a), (b), (c) and (d) and controls (a), (b), (c), (g) and (o) as the amount of excavation proposed is excessive for the site and is within 0.9m of the side boundaries.

Part C1 Low Density Residential Development

- c. Section 1.0 General Objectives, specifically objectives (a) and (b) as the proposed development is not appropriate for the lot as it exceeds height and floor space ratio, which does not preserve the amenity of a neighbouring property in terms of solar access and view impacts.
- d. Section 1.1 Height, specifically objectives (a), (d) and (f) and control (a) as the proposed development exceeds the 7m maximum wall height.
- e. Section 1.2 Setbacks, specifically control (a), (b), (d) as the proposal does not provide consistent setbacks with those adjoining (at each level) and the resultant effect presents an excessive bulk and scale when viewed from the streetscape and rear.
- f. Section 1.3 Streetscape and Visual Impact, specifically objectives (a) and (b) and controls (a), (d), (e) as the proposed pitched roof is not reflective of other dwellings in the streetscape, which incorporate flat roofs, as well as the proposal presenting an excessive bulk and scale to the streetscape.
- g. Section 1.6 Solar Access, specifically objectives (a) and (b) as the proposed development impacts solar access to No.27 St Thomas Street, Bronte.
- h. Section 1.7 Views, specifically objective (a) and controls (a), (b) as the proposed development may result in unreasonable view loss from No. 27 St Thomas Street, Bronte.
- Section 1.9 Landscaping and Open Space, specifically objective (a) and (b) and controls (c), (e), (g), (h) in that the landscaping is insufficient and provides little scope for being used for recreation.
- 3. The application does not satisfy section 4.15 (1)(b) of the Act as the proposed development is excessive in terms of its building massing, bulk and scale relative to the site area and dimensions, and consequently results in unacceptable amenity and streetscape impacts upon the locality and surrounding built environment.
- 4. The application is contrary to section 4.15 (1)(c) of the Act due to the site being unsuitable to accommodate the proposed development.
- 5. The application is contrary to section 4.15 (1)(d) of the Act in relation to matters raised in the public submissions received that object to the proposed development.
- 6. The application is contrary to section 4.15 (1)(e) of the Act in relation to the public interest as it is not compatible with the existing and desired future character of the locality and the broader Waverley local government area.

DA APPLICATION

LOT 2/DP73583, 25 ST THOMAS ST BRONTE

ARCHITECTURAL DRAWINGS

DWG NO.	NAME	REV	
A001	COVER PAGE AND EXISTING SITE PLAN & DEMO	D	
A002	BASEMENT PLAN	D	RECEIVED
A003	GROUND FLOOR PLAN	D	Waverley Council
A004	FIRST FLOOR PLAN	D	,
A005	ROOF PLAN	D	
A006	STORMWATER CONCEPT PLAN	D	Application No: DA-57/2023
A007	ELEVATIONS NORTH AND EAST	D	
A008	ELEVATIONS SOUTH AND WEST	D	Data Passivadu 11/09/2022
A009	SECTIONS A&B	D	Date Received: 11/08/2023
A010	LANDSCAPE PLAN	D	
A011	SHADOW DIAGRAM 9AM JUNE 22	D	
A012	SHADOW DIAGRAM 12PM JUNE 22	D	
A013	SHADOW DIAGRAM 3PM JUNE 22	D	
A014	CALCULATIONS	С	
A015	SOLAR ACCESS DIAGRAMS FOR #27 ST THOMAS ST	С	
A016	EXCAVATION PLAN	С	

PROJECT TEAM



LAND SURVEYOR SJ DIXON SURVEYORS PTY LTD SUITE 16, 2ND FLOOR

17 SURF ROAD, CRONULLA, 2230 ENERGY

Property Raters info@propertyraters.com.au

PO BOX 419 Altona 3018

AREAS

Site Area 349m2


GFA/FSR of existing dwelling: 240m2 68%

GFA/FSR of proposed dwelling: 237m2 67% Does not exceed existing Existing dwelling including all external paving and entry staircases to be demolished

- Existing garage to be demolished
- Existing paling fence to be demolished
- Existing metal shed to be demolished Existing pool to be demolished
- Existing vegetation to be demolished

LEGEND

Note: All contours shown to AHD

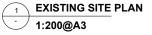

CLASSIFICATION

This building is classified under the following categories according to the BCA/NCC:

SPECIFICATIONS AND STANDARDS

These drawings are to be read in conjunction with the architect's and engineer's written specifications and details and if applicable bushfire report, any geotechnical report, coastal engineer's report & civil engineer's drawings for the project. Do not scale from the drawings and use written dimensions only. Dimensions are generally shown to the finished face unless indicated or detailed otherwise. Where there is any discrepancy between the architecture and engineering documents, seek the architect's instruction prior to the commencement of any works. Contractors must verify all dimensions on site prior to the commencement of any works or the preparing of any

Any asbestos sheeting disturbed during the works should be removed and disposed of in accordance with relevant regulations and council requirements It is the contractor's responsibility to ensure that all works are carried out in accordance with the National Construction Code, all current regulations and

AS-1170 Structural design actions

and wall cladding

AS-1576 Scaffolding

AS-2172 Solar and heat pump water heaters

AS-2311 Painting of buildings

AS-2589 Gypsum lining

AS-2904 Damp-proof courses and flashing

AS-3000 Electrical installations

AS-3500 Plumbing and drainage

AS-3610 Formwork for Concrete

AS-3660 Termite management

AS-3700 Masonry Structures

standards, and the work is complete to the satisfaction

All works shall comply but are not limited to the current

AS-1288 Glass in buildings AS-1428 Design for access and mobility

AS-1562 Design and installation of metal roof sheeting

AS-1680 Interior and workplace lighting

AS-1684 Residential timber-framing construction

AS-1720 Timber structures

AS-1860 Installation of particleboard flooring AS-1884-1985 Floor coverings - Resilient sheet and tiles

AS-2159 Piling

AS-2870 Residential slabs and footings

AS-3600 Concrete structures

AS-3740 Waterproofing of domestic wet areas

AS-3958 Ceramic tiles

AS-4055 Wind loadings for housing AS-4100/4600 Steel structures AS-4234 Heated water systems

AS-4586 Slip resistance classification of new pedestrian surface materials

AS-4654 Waterproofing membranes AS-4674 Design, construction and fit-out of food

AS-4678 Earth-retaining structures AS-4777 Grid connection of energy systems via

AS-4859 Materials for the thermal insulation of buildings AS-4994 Temporary edge protection Roof fall protects

ENERGY REQUIREMENTS

- Refer to attached NatHERS assessment prepared by Propoerty Raters and Basix certificate
- External ceiling insulation R4.0 + sarking. External/internal wall insulation R6.0 (except for
- basement level). bathroom basement walls to have R2.5.
- R2.5 ceiling insulation to basement ceiling R2.5 to exposed ground floor floors subfloor (room
- overhanging the driveway). R2.5 to 1st floor subfloor.
- Seal gaps, cracks and exhaust fans. Weather-strip windows and entry doors.
- Clinton Murray Architects is the owner of the copyright subsisting in these documents. They must **DEVELOPMENT**

Windows to be double glazed type with values of U=2.30 and SHGC=0.32,

POOL

FXIST

SHED

(4)

×62.83

TOP OF BRUSHWOOD FENCE 66 12

1/DP1024622

R2 ZONE

90°53' BOUNDARY 36.575

BRICK FENCE

(5)

FXIST

POOL

X63.09

POOL

1/DP730883 R2 ZONE

Sliding doors to be double glazed type with values of U=1.36 and SHGC=0.34

Louvre windows to be single glazed with values of U=3.74 and SHGC=0.42 or approved equivalent. W101, W107, W202-W211 to have outdoor rolle

skylights to be double glazed. external shutters to

Downlights to be IC rated insulated type

BASIX REQUIRMENTS

POOL

- Indigenous or low water planting
- Pool volume no greater than 32kL
- electric heat pump with 26-30 stcs or better
- bathrooms and kitchens to have natural light photovotaics to be installed 13kw or greater,
- connected to the dwellings electricty system Refer to the NatHERS certificate for more details

PERMITS

The contractor shall: Obtain any required permits and pay any

associated fees excluding the planning application fee and building permit fee which shall be paid by Keep a copy of the stamped building permit

drawings on site

APPLICATION

BY DESCRIPTION 21/11/22 EW ISSUE FOR DA 01/05/23 EW RFI RESPONSE 10/07/23 EW DEFERRAL LETT 11/08/23 EW RFI RESPONSE DEFERRAL LETTER RESPONSE

- Provide a site toilet and all of the statutory
- requirements for site services. Keep the site and works clean and tidy as the works progress and remove from site any excess soil from excavations Provide general and specialised cleaning of all
- trades at the completion of the works. Leave the site clear of any debris, rubbish and
- loose material and any temporary works or plant not forming part of the works.

INSURANCE

1/DP73583

2/DP73583

FL 62.83

The works shall be insured by the contractor in accordance with current statutory requirements for this

The contractor shall provide evidence of currency of insurance to the owner before commencement of the works. Insurance shall cover liability for damage to property, liability for injury to persons, and WorkCover ncluding contractor's warranty insurance and personal indemnity insurance.

SETOUT

Refer to A003 for setbacks and setout

SITE SERVICES

It is the contractor's responsibility to arrange and pay for

PROJECT LOT 2/DP73583 25 ST THOMAS STREET BRONTE

CLIENT

EXIST. 3 STOREY LIGHT

 \times 60.35

PALING FENCE

EXIST. 2 STOREY LIGHT WEIGHT RENDERED DWELLING

SCOPE OF WORKS

elevations for further information.

GLAZING

Safety glazing

STUD WALLS

BURRELL AND BENNETT

the connection of all services to the site including

contractors temporary power, provision of a meter board

and connection to mains power supply, water supply,

Demolition of existing two storey dwelling, pool and

underground basement. Construction of new pool

All glazing to be in accordance with energy report.

Window glazing to be fabricated and installed in

accordance with AS1288 and AS2047. Refer to

Within 300mm horizontally of all doors

garage and construction of new two storey dwelling with

Safety glazing to be used in the following circumstances

All rooms within 1000mm vertically of the floor

Bathrooms within 1500mm vertically from the bath

EXIST. 1 AND 2 STOREY

BRICK/RENDER DWELLING

RIDGE RL 69.97 (1)

H 70.39 S 67.75 H 67.25 S 64.48

EXIST.3 STOREY RENDERED

270°53' BOUNDARY 36 575

BRICK GARAGE

WEIGHT CLADDING AND STONE DWELLING

> New walls to be constructed using 90x45 timber stud framing in accordance with structural engineer's detail Where sizes have not been nominated by the structural engineer - All studs to be 90x45 studs with top plates,

bottom plates and iamb studs

WALL CLADDING

#29

#23

×60.46

Wall cladding will be designed and installed to comply with Section 2 and 3 of the NCC/BCA. The contractor must ensure that all necessary precautions are taken to ensure the stability of the existing and surrounding buildings during demolition and construction.

STORMWATER

Refer to A006 for Concept Stormwater plan

STAIRS/STEPS/ BALUSTRADES/RAMPS

- Stairs to have a maximum riser height of 190mm
- and a minimum tread width of 240mm. Handrails to stairs are to be a minimum of 1000mm above landings and balconies and 865mm above
- nosing of stairs. Balustrades incorporated in handrails to have a max. gap of less than 125mm in accordance with
- requirements of NCC/BCA Ramps to be constructed to comply with AS1428 and BCA/NCC requirements.

EXISTING AND DEMO PLAN

STREE

THOMAS

ST

<60.05

×60.48

KERBING

×60.13

 $\times 60.40$

POLE

×60.44×60.45


BOUNDARY

22

TELSTRA

DWG No. A001 SCALE 1:1000@A3 AUGUST 2023

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DEVELOPMENT APPLICATION

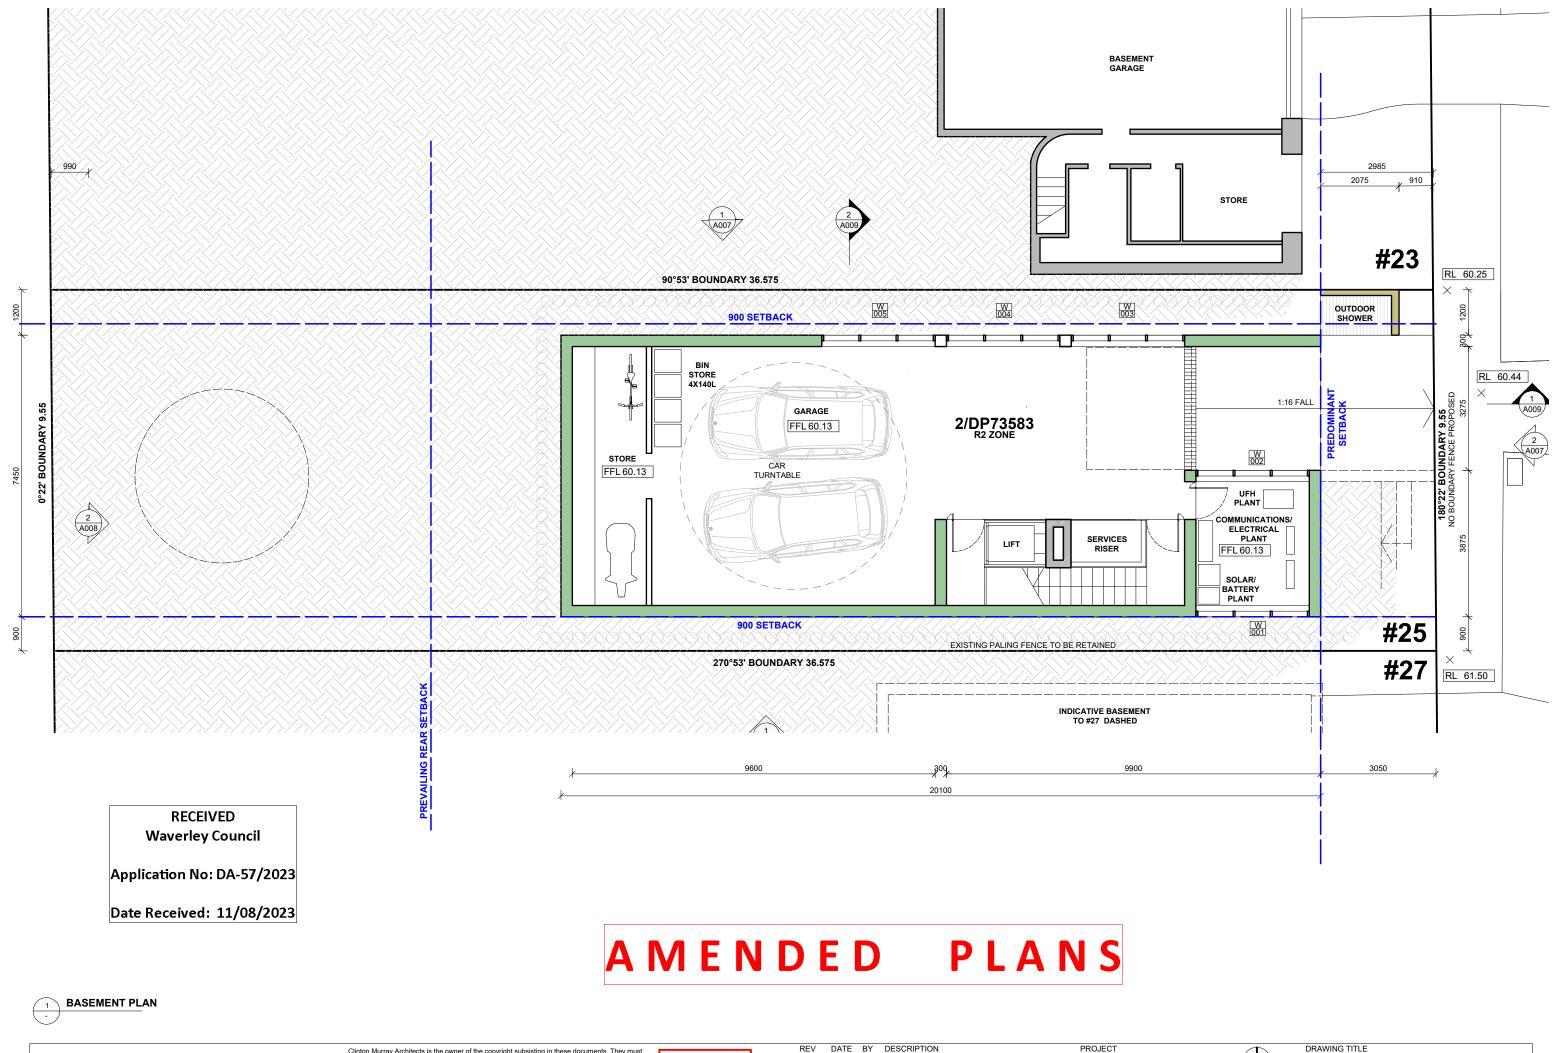
DATE BY DESCRIPTION
21/12/22 EW ISSUE FOR DA
01/05/23 EW RFI RESPONSE
10/07/23 EW DEFERRAL LETTER RESPONSE
07/08/23 EW RFI RESPONSE

PROJECT LOT 2/DP73583 25 ST THOMAS STREET BRONTE CLIENT BURRELL AND BENNETT

DRAWING TITLE
BASEMENT PLAN

DWG No. A002 SCALE 1:100@A3 AUG 2023

RECEIVED Waverley Council Application No: DA-57/2023

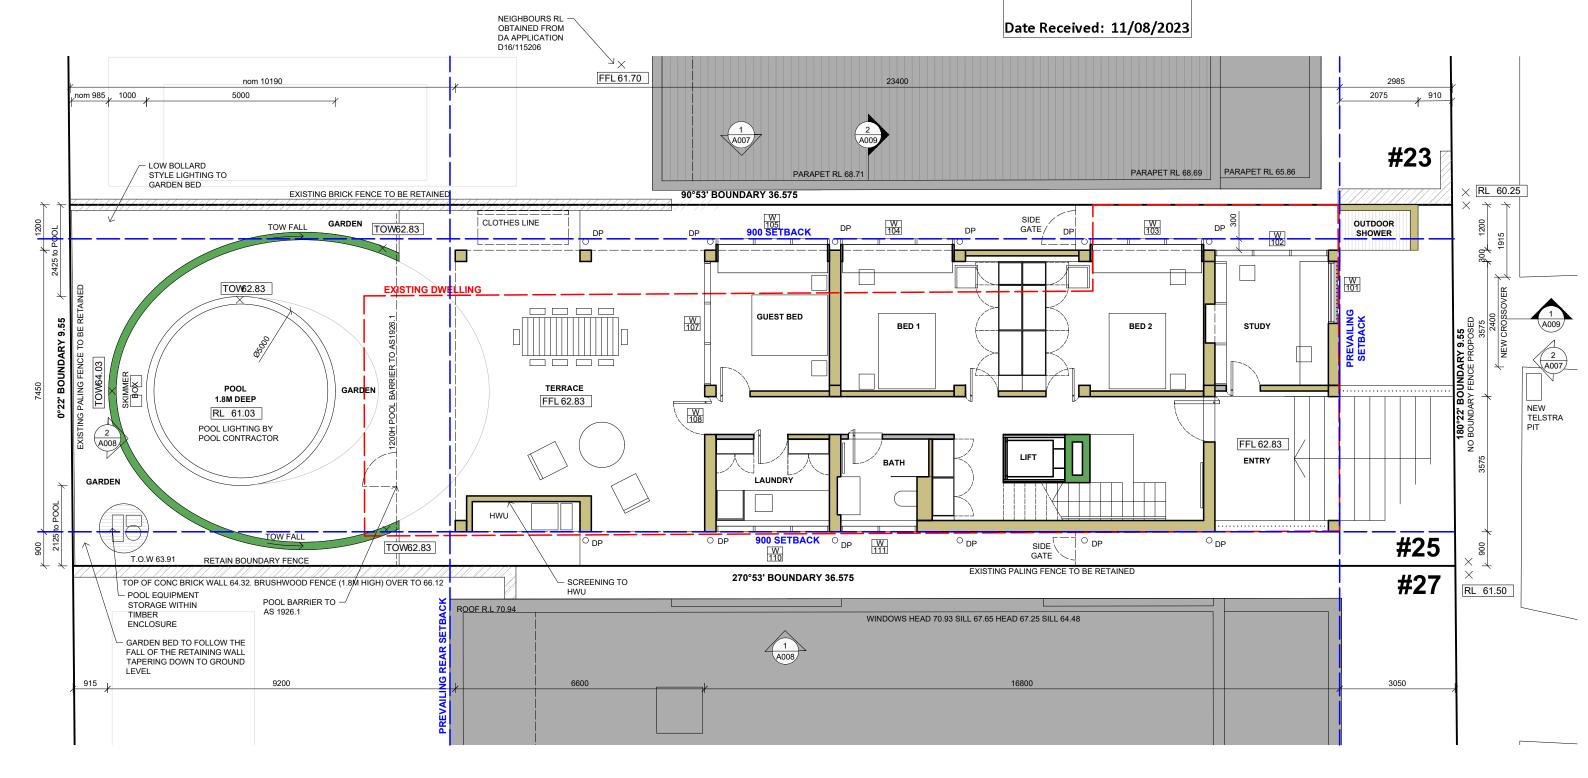

AMENDED PLANS

NOTE: Ceiling or wall mounted fans to all habitable rooms (main living areas and bedrooms).

GROUND FLOOR PLAN




DWG No. A003 SCALE 1:100@A3

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Waverley Council

Application No: DA-57/2023

Date Received: 11/08/2023

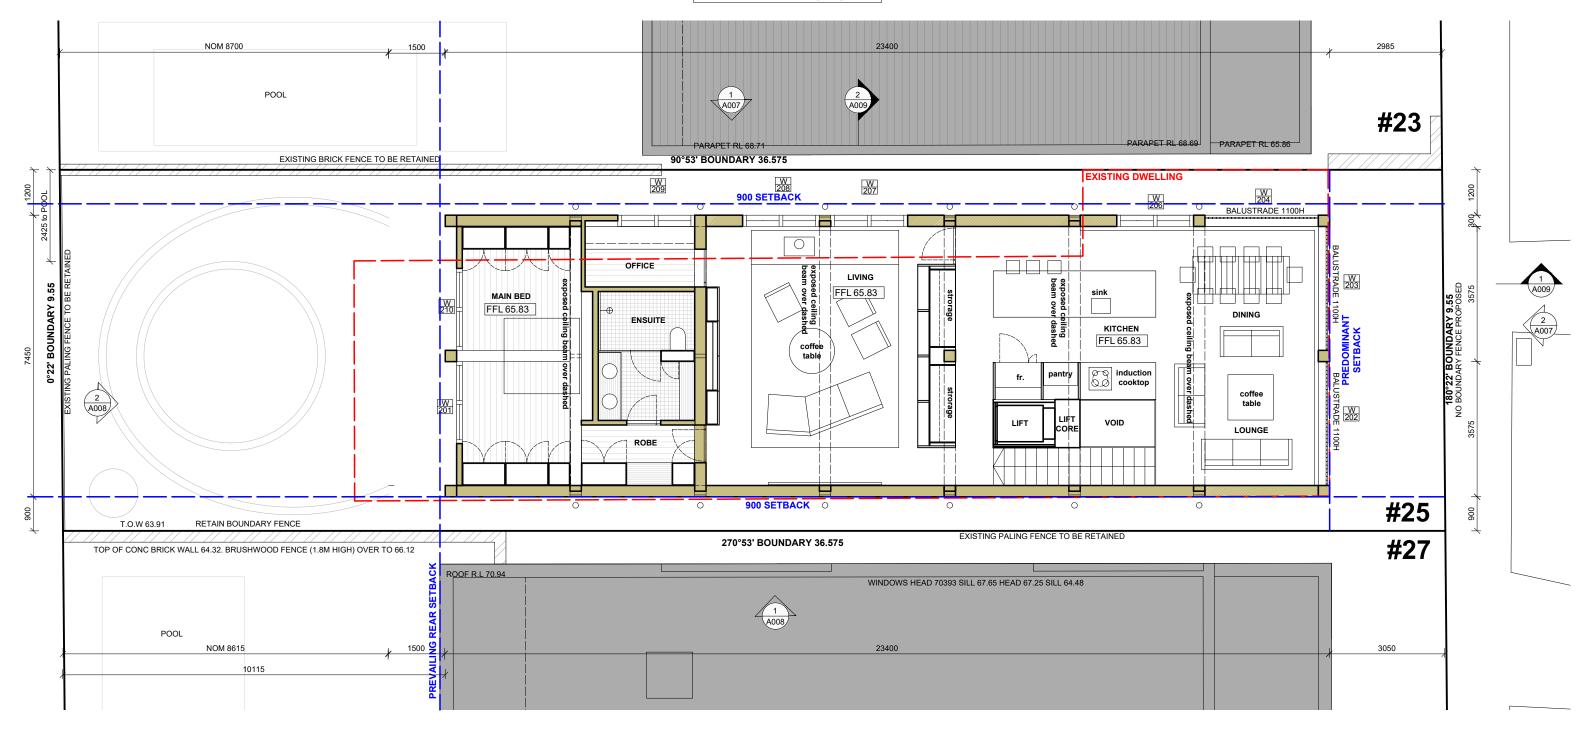


NOTE: Ceiling or wall mounted fans to all habitable rooms (main living areas and bedrooms).

AMENDED PLANS

FIRST FLOOR PLAN




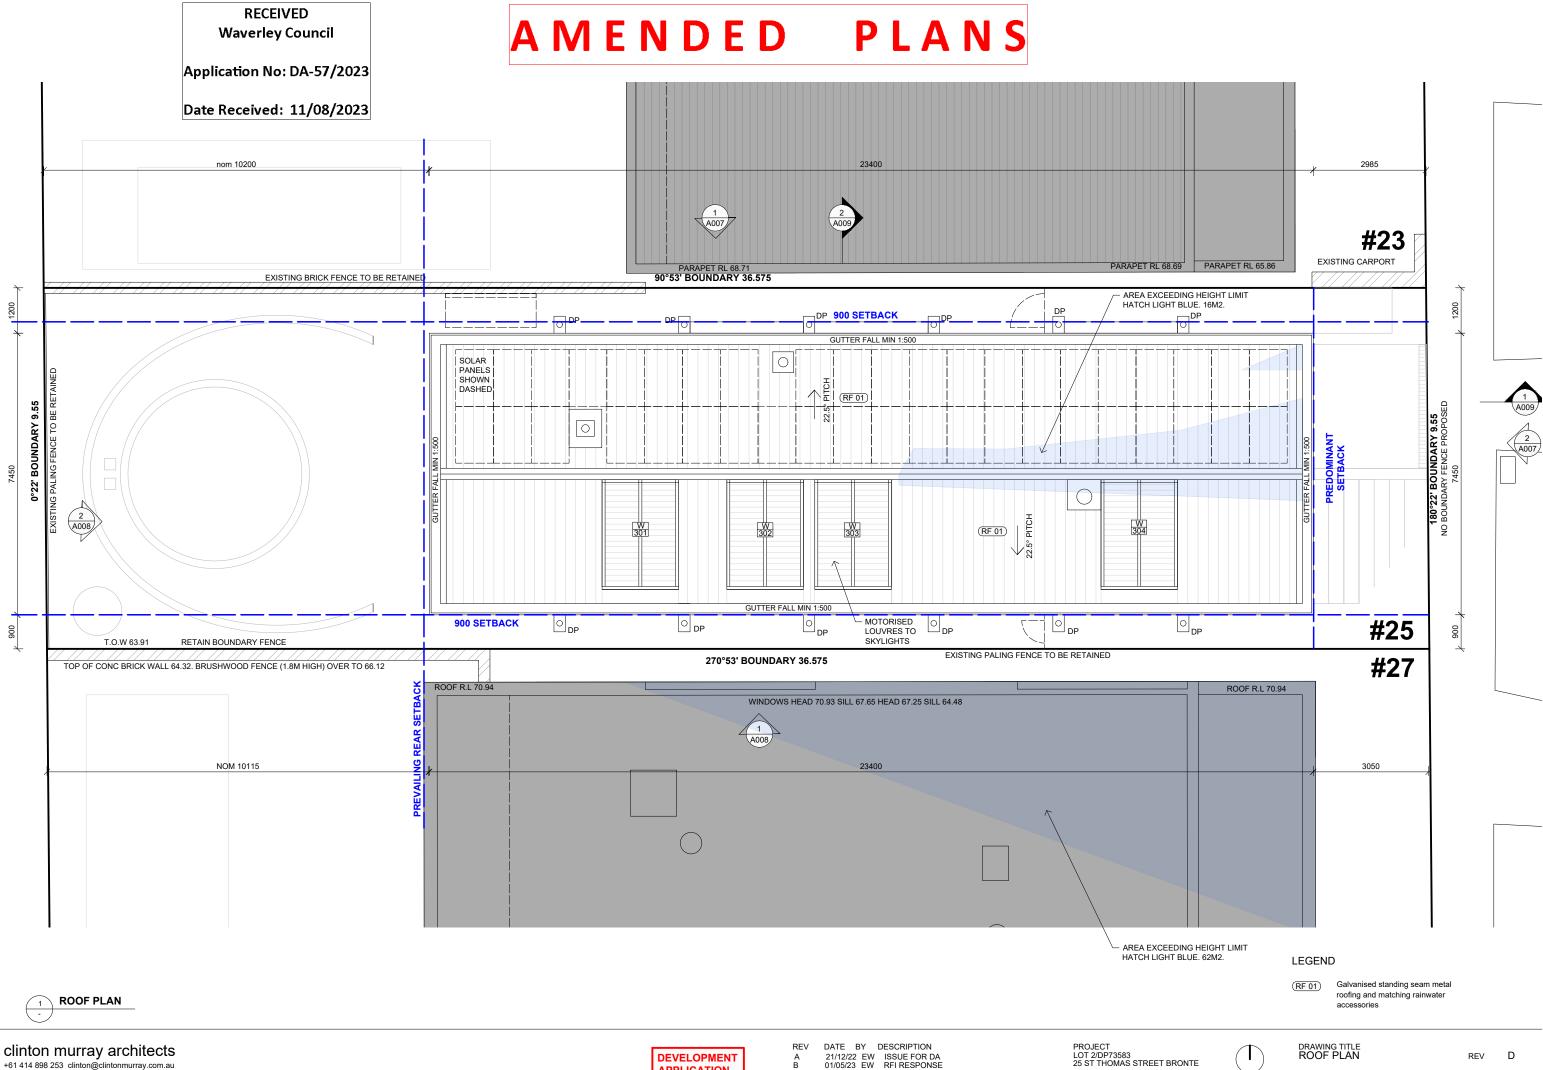

RECEIVED
Waverley Council


Application No: DA-57/2023


Date Received: 11/08/2023

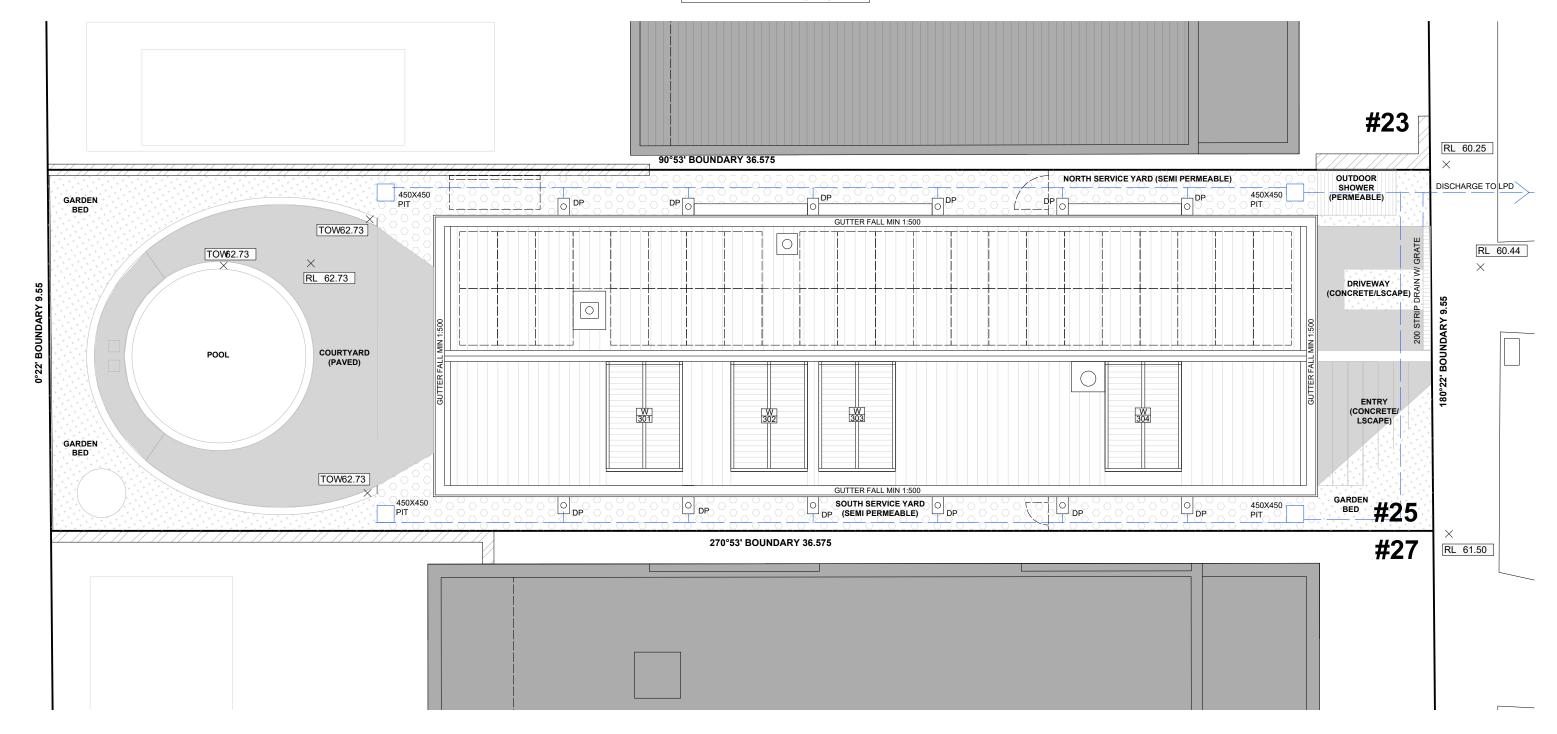


AMENDED PLANS



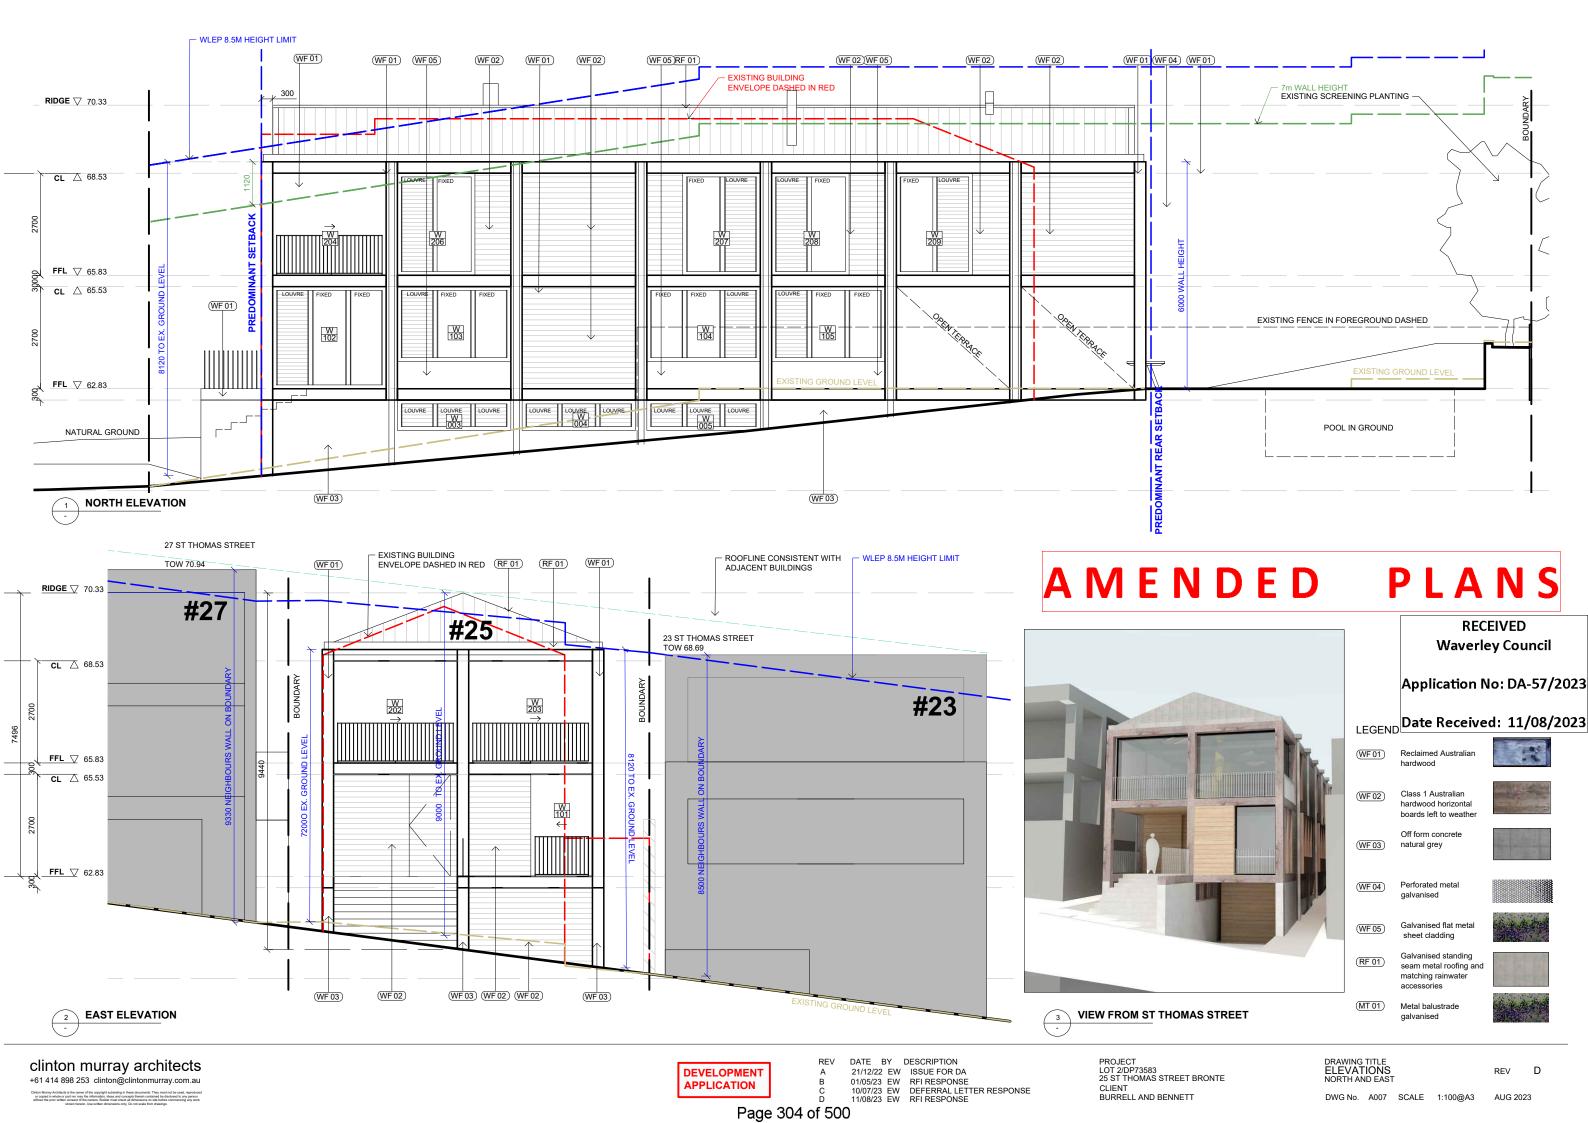


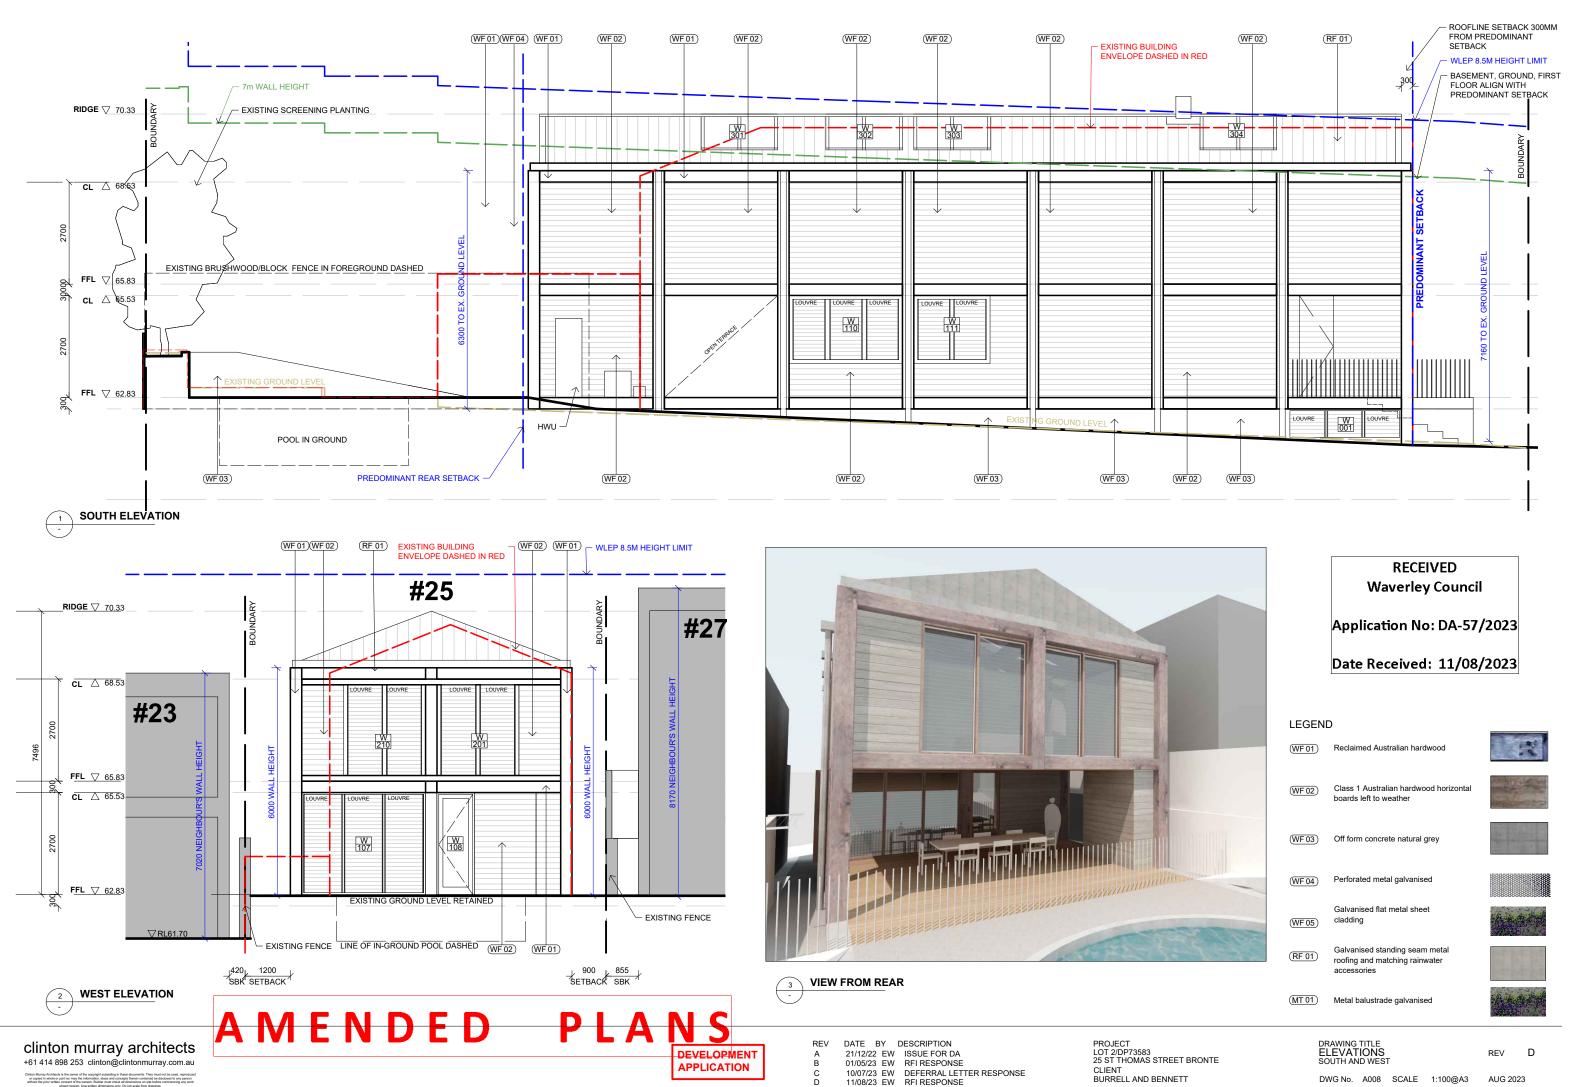

Page 305 of 500

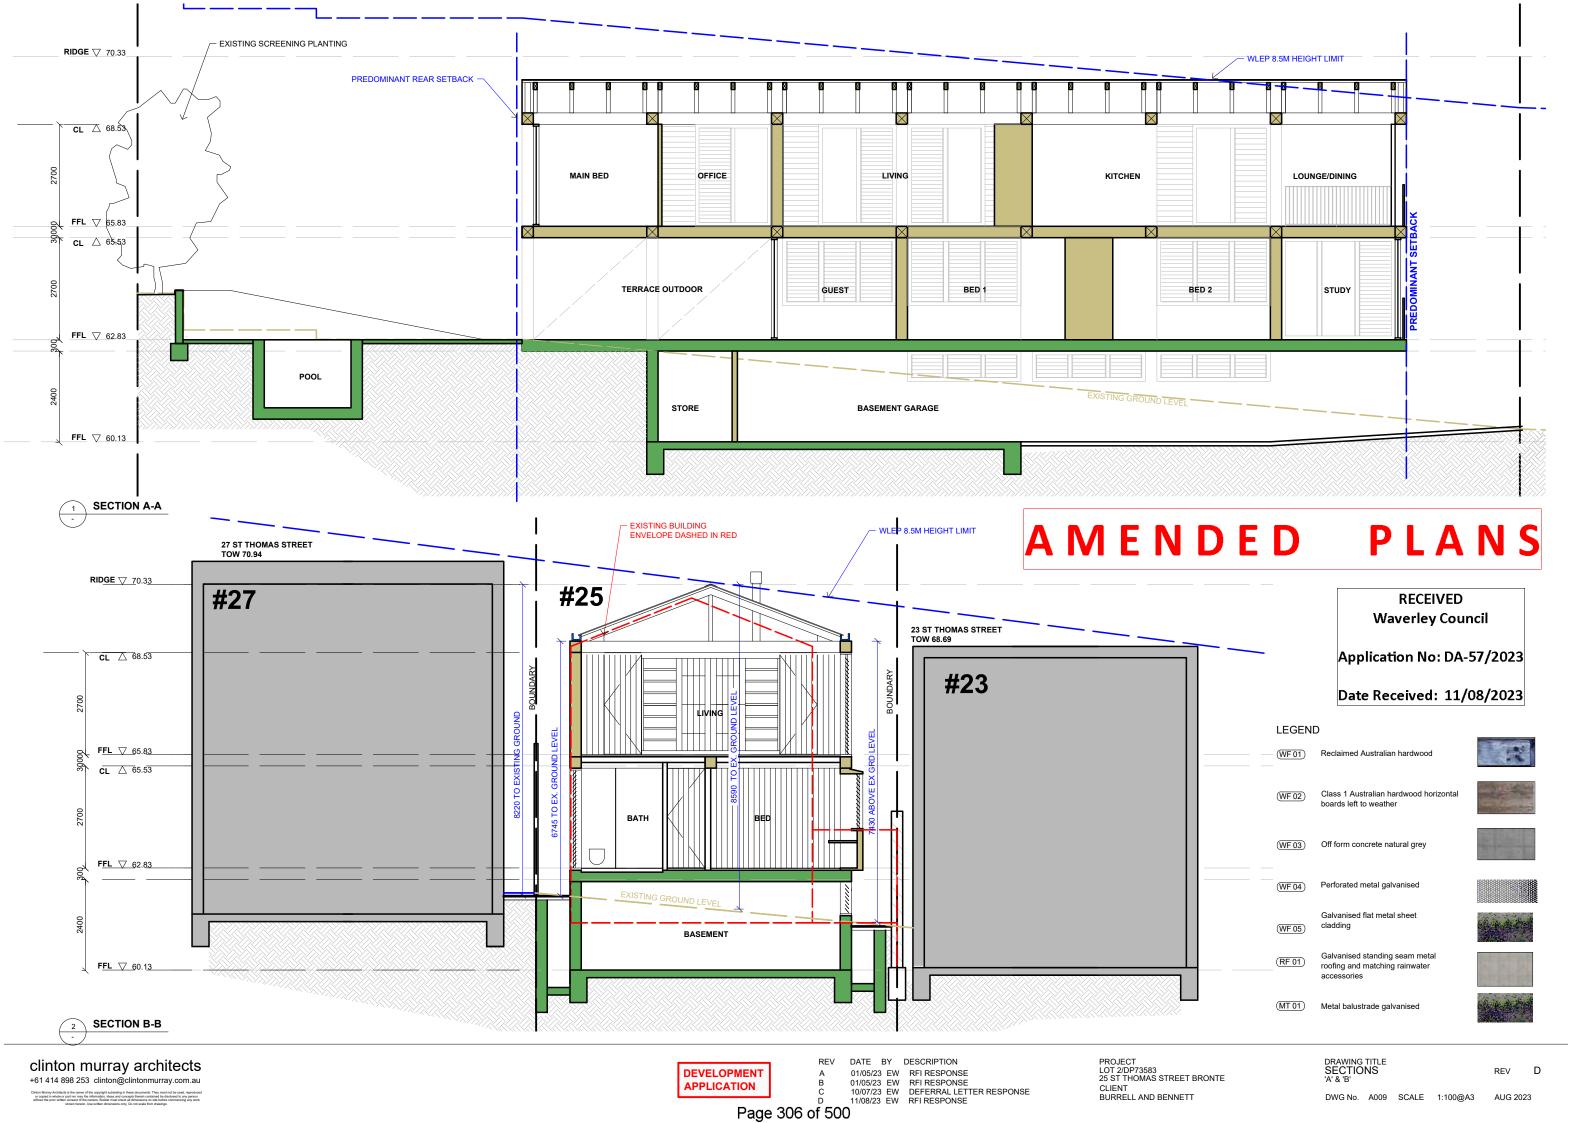

AMENDED PLANS

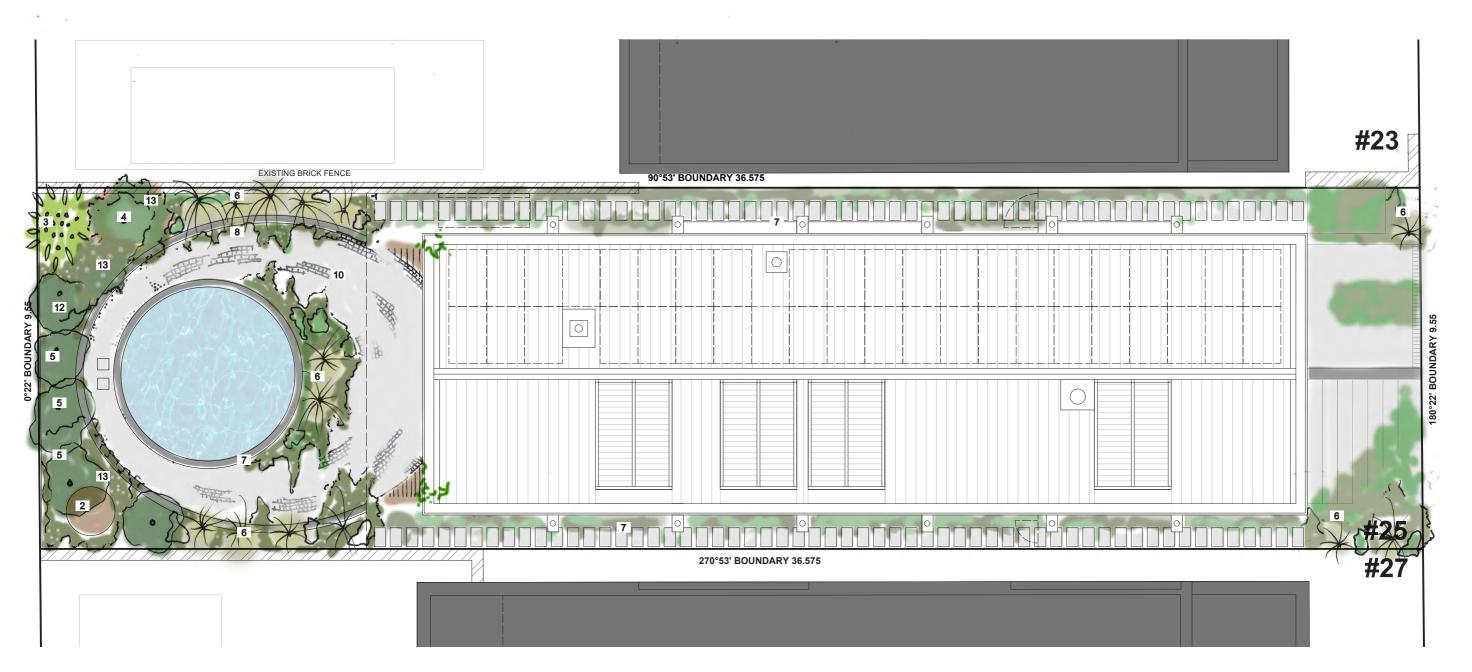

- Underplanting westringia, leptospermum, correa
- Pool equipment storage box
- Clumping bamboo

- Pennesetum and Iomandra grasses
- Scleranthus and myoporum groundcover
- Casurina glauca prostrate groundcover Ornamental grape climber to pergola
- Cobbled grey stone paving to courtyard
- Timber deck to dining area 11
- Banksia integrifolia


RECEIVED Waverley Council

Application No: DA-57/2023

Date Received: 11/08/2023





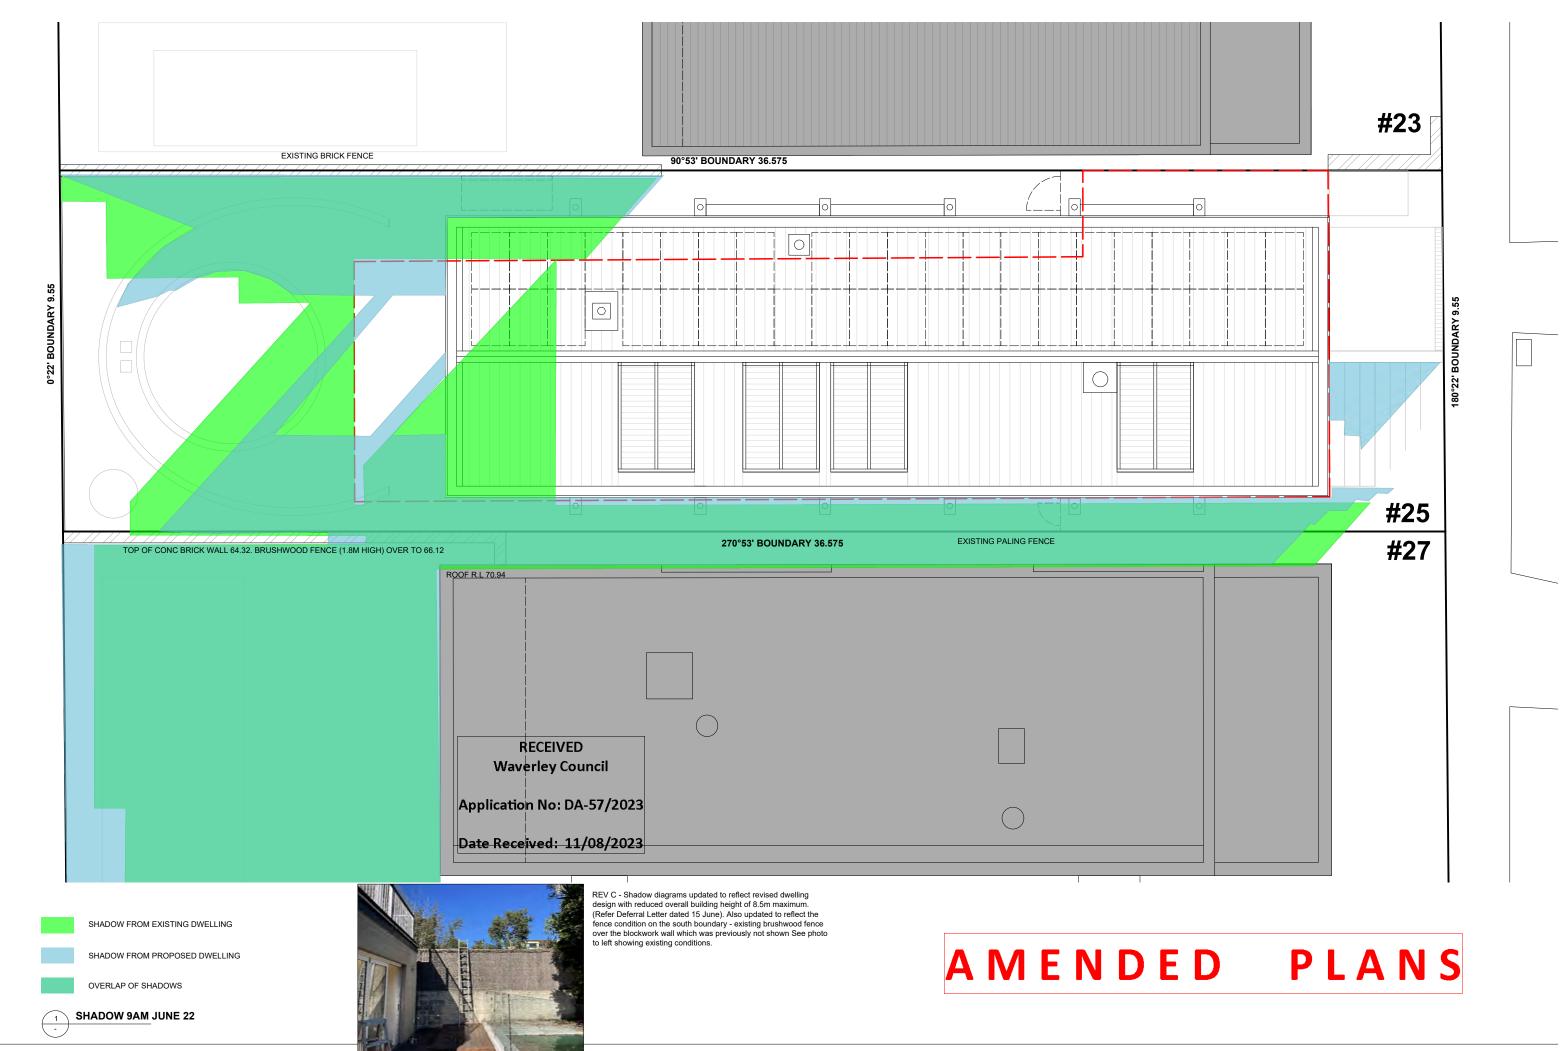


clinton murray architects




DRAWING TITLE SHADOW DIAGRAMS 22 JUNE 9AM

REV

DWG No. A011 SCALE 1:100@A3

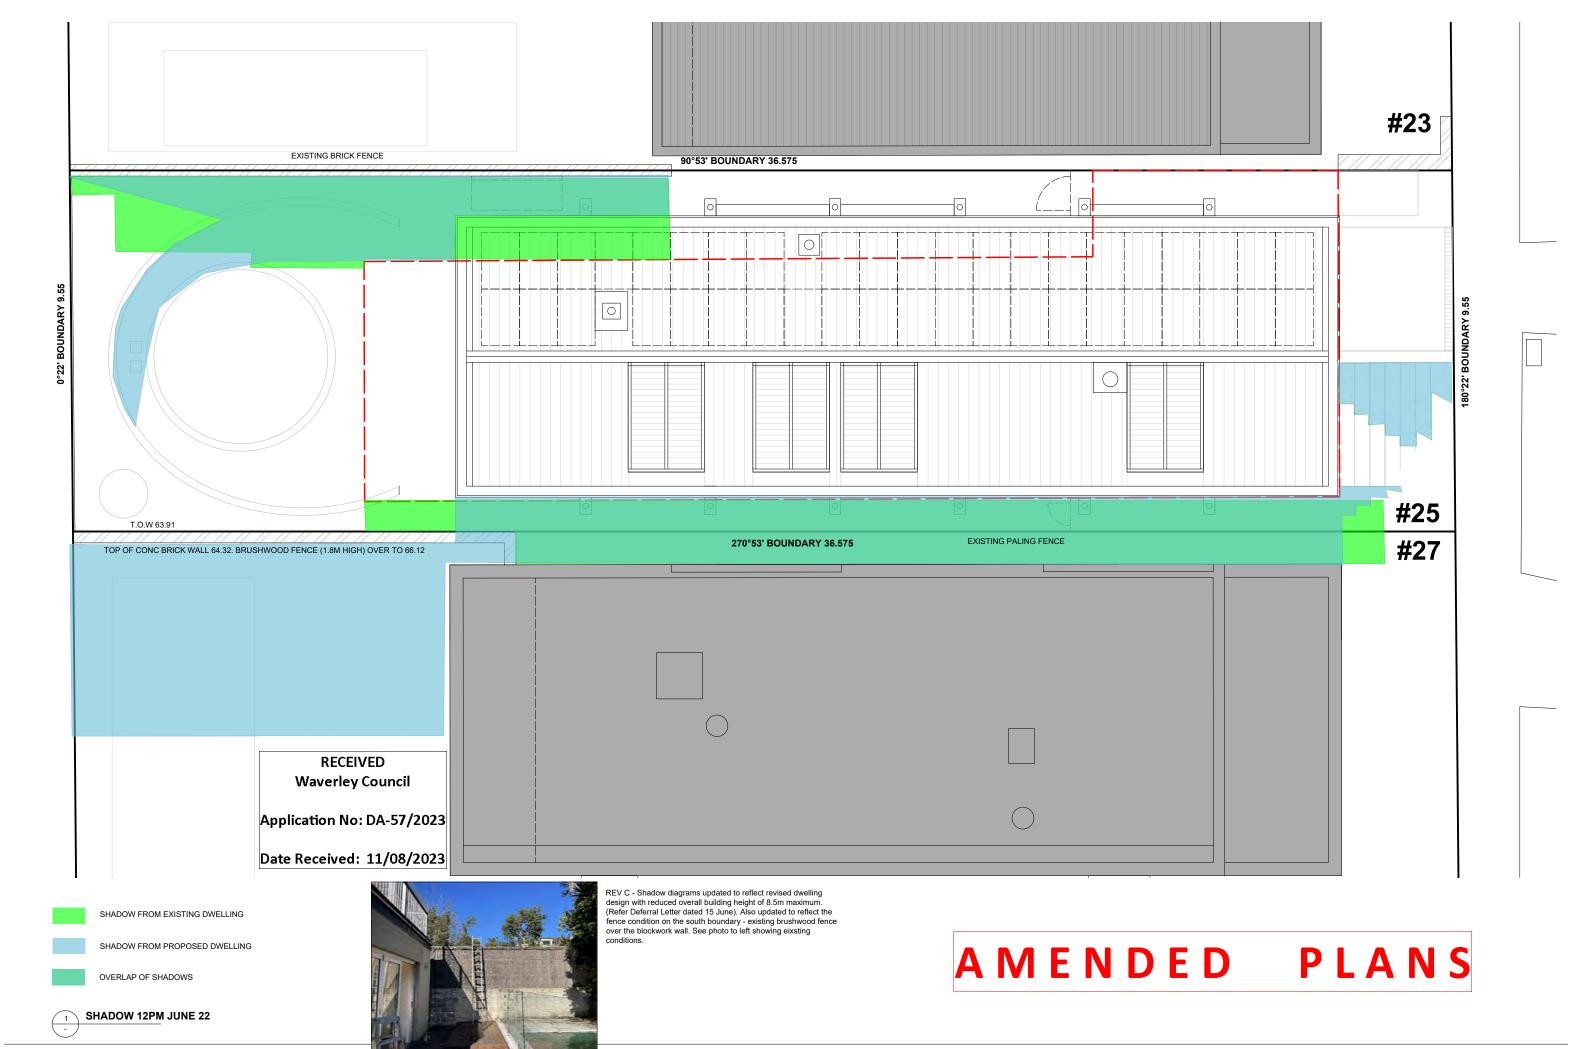



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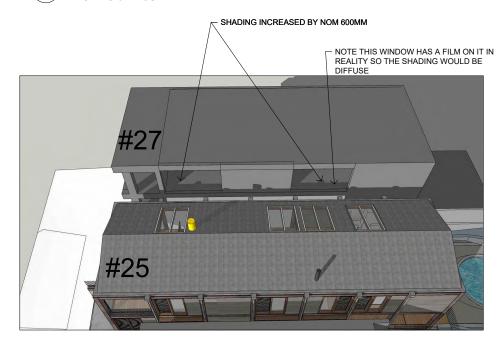
+61 414 898 253 clinton@clintonmurray.com.au

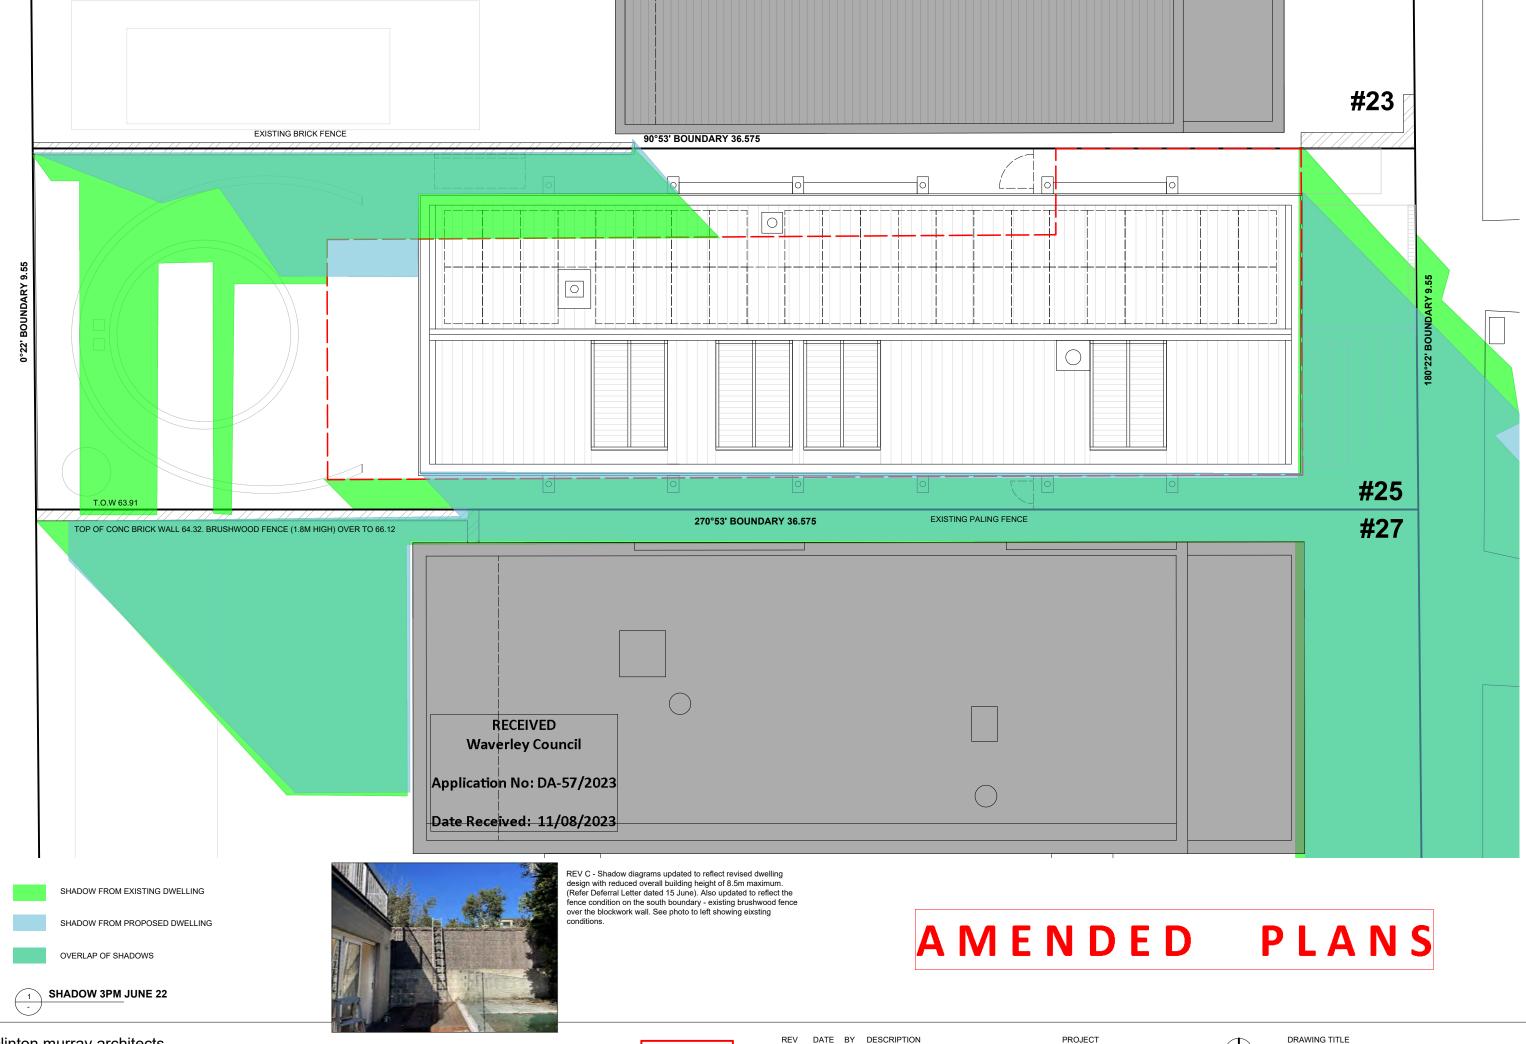





SHADING TO NEIGHBOUR #27

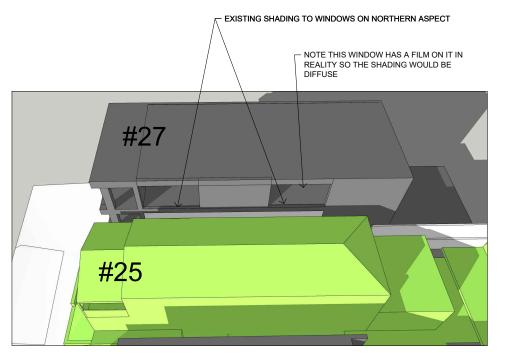PROPOSED 9AM JUNE 22

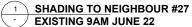

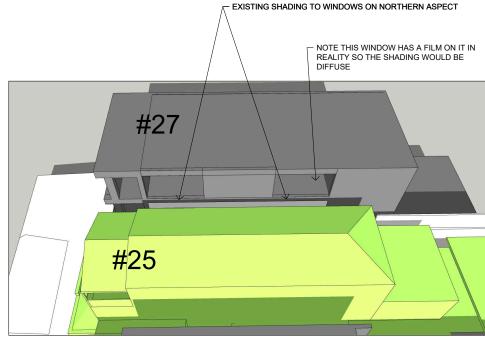

SHADING TO NEIGHBOUR #27 EXISTING 12PM JUNE 22

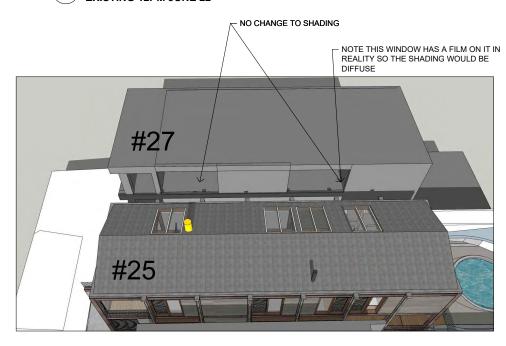

SHADING TO NEIGHBOUR #27 PROPOSED 12PM JUNE 22


RECEIVED **Waverley Council**

Application No: DA-57/2023


Date Received: 11/08/2023

EXISTING PRIVACY FILM TO GLASS CAUSES DIFFUSE SHADOW

NORTHERN WALL TO #27. THE AREA IMPACTED BY ANY FUTURE SHADING IS CONCEALD BY THE FURNITURE. AS SUCH THERE WOULD BE NO IMPACT.

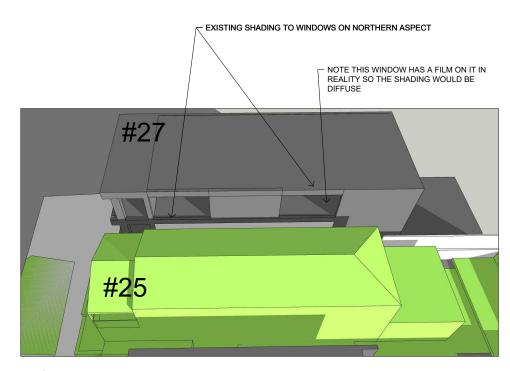


SHADING TO NEIGHBOUR #27 EXISTING 3PM JUNE 22

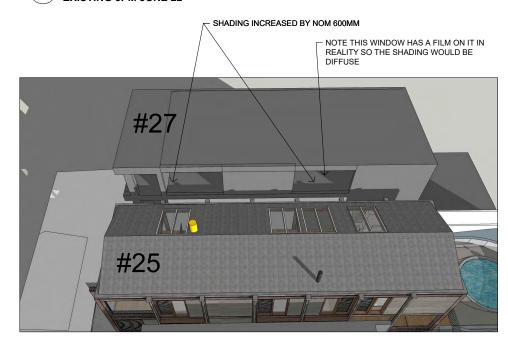

SHADING TO NEIGHBOUR #27 PROPOSED 3PM JUNE 22



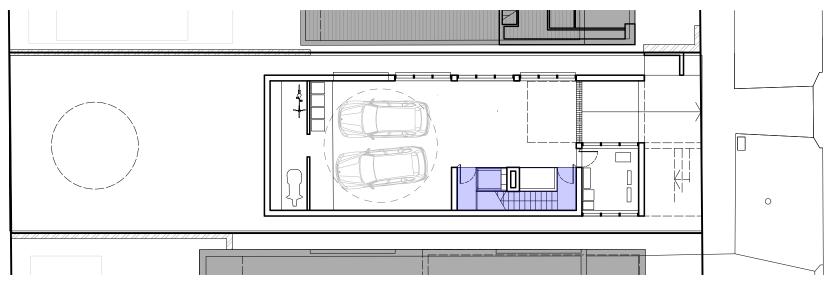

AMENDED PLANS

AREA CALCULATIONS

SITE AREA 349m2

PERMISSIBLE FSR OPEN SPACE TARGET LANDSCAPE TARGET

0.72:1 or 251.7m22 20% or 49.8M2

FSR CALCS BASEMENT 11m2 GROUND FIRST 101m2 145m2

TOTAL GFA 257m2 exceeds allowable by 5.3m2 or 2.1%

OPEN SPACE CALCS

GROUND 240m2 TOTAL % 69%

LANDSCAPE CALCS (AS PER LANDSCAPE PLAN)GROUND 72m2

TOTAL %

GFA




FRONT SETBACK

AREA 29m2


COMPRISES OPEN SPACE

18m2 or 62% min required 40% 14.5m2 or 50% min required 20% LANDSCAPE

BASEMENT PLAN AREA: 16m2

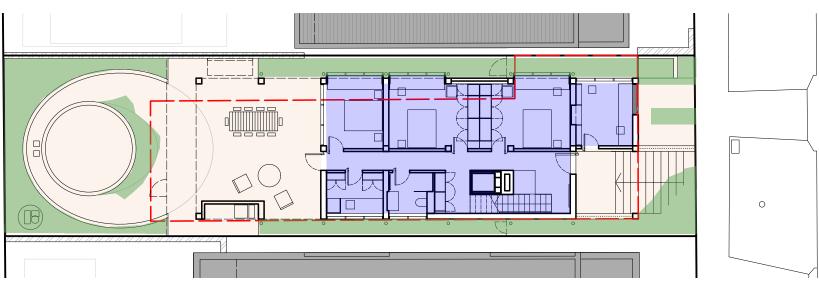



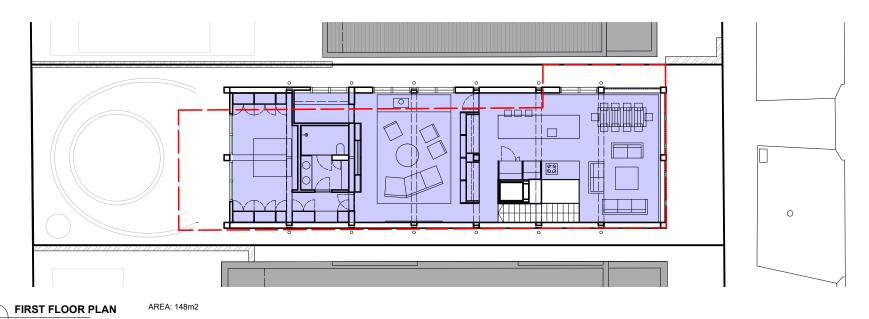

clinton murray architects +61 414 898 253 clinton@clintonmurray.com.au **DEVELOPMENT APPLICATION**

DATE BY DESCRIPTION 01/05/23 EW RFI RESPONSE 11/07/23 EW DEFERRAL LETTER 15/07/23 11/08/23 EW RFI RESPONSE

PROJECT LOT 2/DP73583 25 ST THOMAS STREET BRONTE CLIENT BURRELL AND BENNETT

RECEIVED

Waverley Council


Application No: DA-57/2023

Date Received: 11/08/2023



DRAWING TITLE CALCULATIONS

DWG No. A015 SCALE 1:100@A3

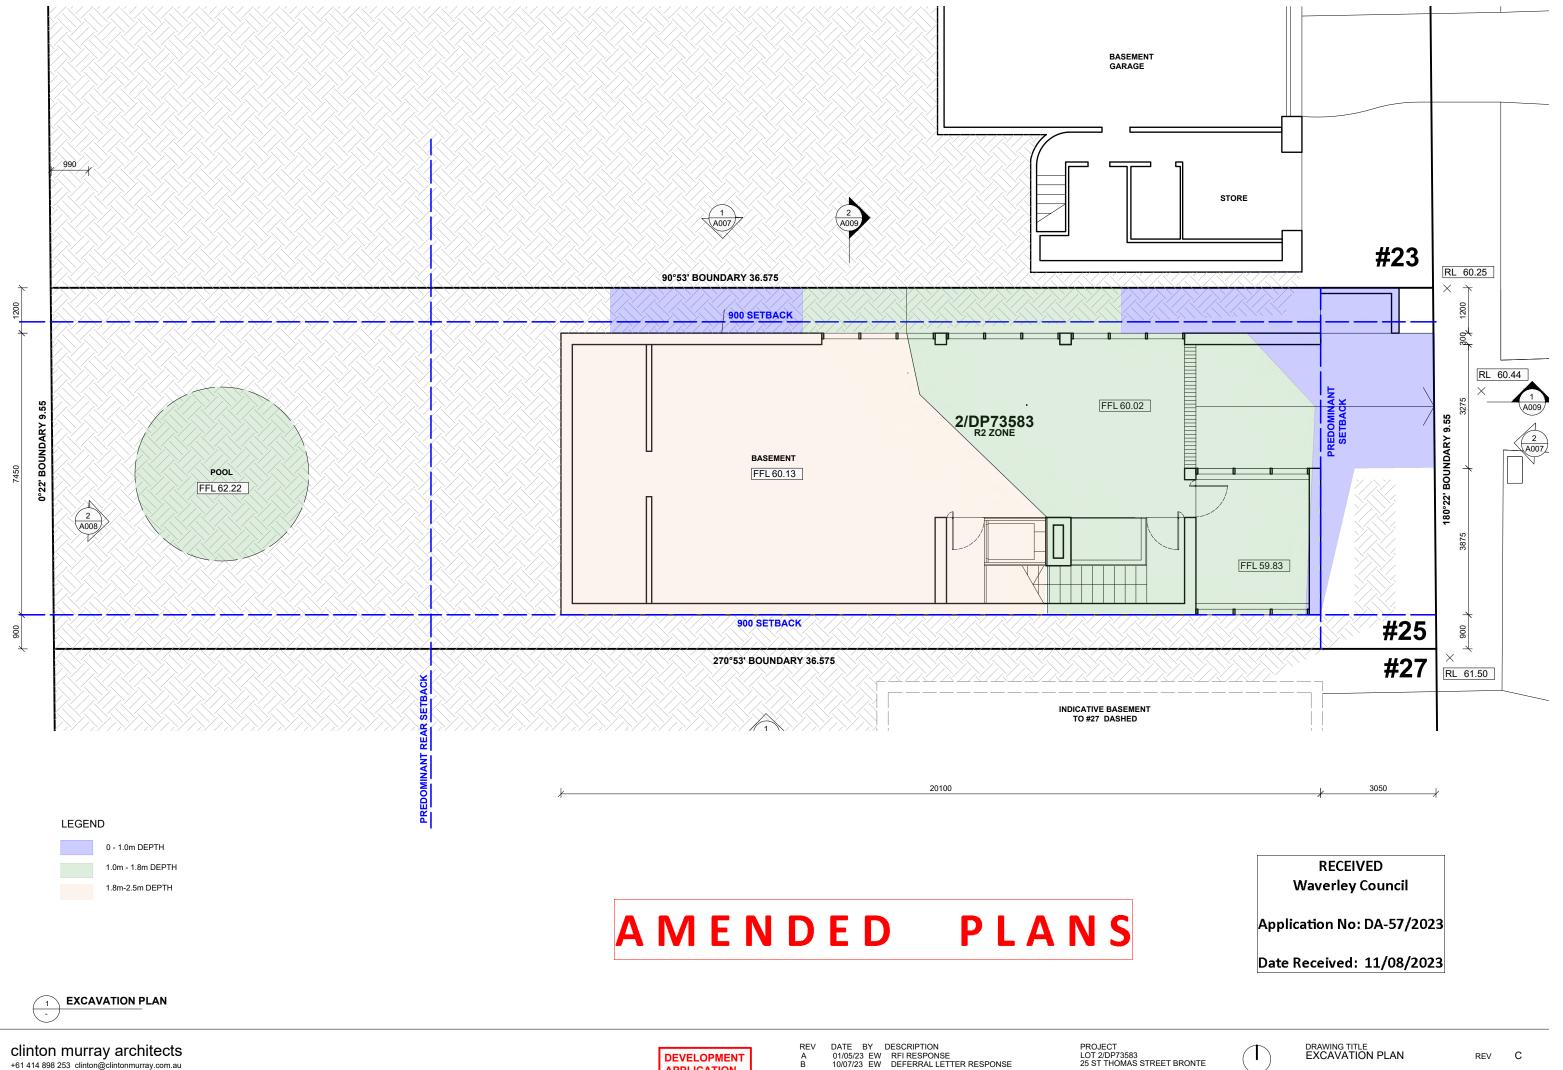

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Report to the Waverley Local Planning Panel

Application number	DA-161/2023	
Site address	15/7 Francis Street, Bondi Beach	
Proposal	Alterations and additions to unit 15, including conversion of roof void to attic level.	
Date of lodgement	26 June 2023	
Owner	Building: The Owners of Strata Plan 71516 Unit 15: Mr J A Cooke	
Applicant	Strategic Approvals	
Submissions Four		
Cost of works	\$164,395	
Principal Issues	Breach to Floor Space Ratio (FSR)	
Recommendation	The application be APPROVED in accordance with the conditions contained in the report.	

SITE MAP



1. PREAMBLE

1.1. Executive Summary

The Development Application (DA) seeks consent for alterations and additions to unit 15 including amending the hipped roof to a gabled roof to facilitate the conversion of the roof void to an attic level to be used as a bedroom at the site known as 7 Francis Street, Bondi Beach.

The principal issue arising from the assessment of the application relates to a breach to FSR.

The assessment finds this issue acceptable, as it has been demonstrated that despite the breach to the development standard, the proposal meets the FSR and zone objectives in the Waverley Local Environment Plan 2012 (Waverley LEP 2012).

A total number of four submissions were received and the issues raised in the submissions have been considered and addressed in this report and in the recommendation.

The application has been assessed against the relevant matters for consideration under section 4.15(1) of the *Environmental Planning and Assessment Act 1979*. It is recommended for approval subject to conditions of consent.

1.2. Site and Surrounding Locality

A site visit was carried out on 29 November 2021, during the assessment of a previous DA, being DA-422/2021, which was refused by the Waverley Local Planning Panel (WLPP).

The site is identified as Lot 15 in SP71516, known as no. 15/7 Francis Street, Bondi.

The site is irregular in shape with a south-western frontage to Francis Street, measuring 15.24m. The site has an area of 425.9m².

The site is occupied by a part-three, part-four storey residential flat building (RFB) with no vehicular access. Unit 15, the subject unit of this application, is located on the second floor at the front of the building.

The site is adjoined by a two storey RFB with an attic level to the north-west (9 Francis Street) and four storey backpackers building (Noah's Backpackers) to the south-east (2-8 Campbell Parade). The locality is characterised by a variety of medium residential developments.

Figures 1 to 3 are photos of the site and its context.



Figure 1: Location of the subject RFB (outlined yellow) in context with the surrounding neighbourhood. (Source: Google Maps, 2023)



Figure 2: Front of the subject building (unit 15 outlined yellow) as viewed from Francis Street, looking north-east.



Figure 3: Front of the subject building (unit 15 outlined yellow) as viewed from Francis Street, looking east.

1.3. Relevant Development History

A search of Council's records revealed the following recent and relevant development history of the site:

- **DA-107/2019** for alterations and additions to unit 15 including a new attic level and extension was refused by the WLPP on 18 October 2019 for the following reasons:
 - The proposal exceeds FSR and the applicant had not demonstrated that the proposed development was consistent with the objectives of FSR of the Waverley LEP 2012; and had not demonstrated the compliance with the standards was unreasonable or unnecessary or that there were sufficient environmental planning grounds to justify contravening the FSR development standard;
 - o The consent authority was not satisfied that the request was in the public interest;
 - View loss impacts;
 - Unreasonable privacy impacts from the proposed balcony;
 - o The proposal did not meet the minimum size for a two-bedroom apartment;
 - o Adequate storage was not provided; and
 - Inadequate documentation, including insufficient detail on the architectural plans and shadow diagrams; inadequate Statement of Statement of Environmental Effects; and no Gross Floor Area (GFA) calculation plan.

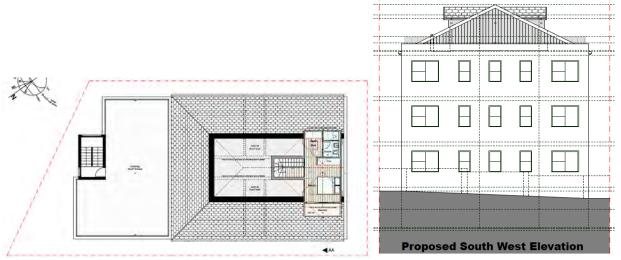


Figure 4. Plans of refused proposal under DA-107/2019. (Source: iSA Designs, 2019)

- DA-422/2021 for alterations and additions to unit 15 including a new attic level and extension was refused by the WLPP on 23 February 2022 for the following reasons:
 - The proposal exceeds FSR and the applicant had not demonstrated that the proposed development was consistent with the objectives of FSR of the Waverley LEP 2012; and had not demonstrated the compliance with the standards was unreasonable or unnecessary or that there were sufficient environmental planning grounds to justify contravening the FSR development standard;
 - The proposal will impact the Inter War Building;

- The proposed gabled addition and associated dormer windows would add unreasonable bulk to the front of the subject building and would dominate those smaller RFB's at (no. 9-17 Francis Street);
- The proposed changes to the roof form will create unreasonable additional bulk and scale to building that has reached its maximum development capacity and the proposed dormer windows are not set at least 300mm below the main ridge;
- o The proposed side balcony would create unreasonable visual privacy impacts;
- o View loss impacts; and
- Lack of information on the plans, including no window opening details; limited Survey Plan; no materials and finishes schedule; no elevational shadow diagrams; and limited information to adequately assess height.

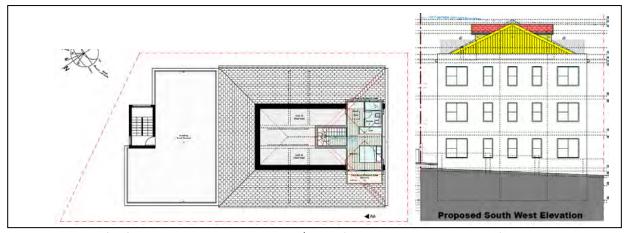


Figure 5. Plans of refused proposal under DA-422/2021. (Source: iSA Designs, 2019)

- **PD-23/2022** for alterations and additions to unit 15 including a new attic addition was issued on 25 July 2022, with the following pre-DA advice:
 - Any breach to FSR will require a Clause 4.6 variation and justification that no environmental amenity impacts would arise;
 - o Compliant floor-to ceiling heights are to be provided;
 - o Windows and skylights are to be openable; and
 - The proposed gable roof material is to match the existing roof.

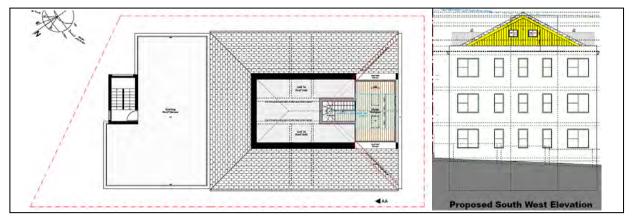


Figure 5. Plans submitted for PD-23/2022. (Source: iSA Designs, 2012)

1.4. Proposal

The DA seeks consent for alterations and additions to unit 15, including conversion of the roof void to an attic level, specifically the following:

- Internal stairs to the lower level of unit 15 to access the proposed attic level;
- Construction of a gable roof with two windows and skylights to the front of the RFB, to replace an existing hipped roof; and
- Construction of a bedroom, within the proposed gabled roof.



Figure 6. Propsoed plans submitted under the subject application (DA-161/2023). (Source: iSA Designs, 2012)

1.5. Background

The applicant was advised on 22 August 2023 that the proposed works to amend the hipped roof to a gabled roof for a storage room would not be supported as it created excessive bulk to be utilised only for a storage space. The applicant was advised if the storage room was amended to a habitable room, then the additional bulk could be considered, and was required to meet the minimum floor-to-ceiling heights.

Amended plans were received by Council on 24 August 2023, which resulted the proposed attic space being utilised as a bedroom. These plans will form the basis of the assessment.

ASSESSMENT

The following matters are to be considered in the assessment of this DA under section 4.15 of the *Environmental Planning and Assessment Act 1979* (the Act).

2.1. Planning Instruments and Development Control Plans

The following is an assessment against relevant legislation, environmental planning instruments, including State Environmental Planning Policies (SEPPs), and development control plans.

2.1.1. State Environmental Planning Policies (SEPPs)

The following SEPPs apply from the 1st March 2022 and have been considered acceptable in the assessment of this development application:

- SEPP (Building Sustainability Index BASIX) 2004
- SEPP 65 (Design Quality of Residential Apartment Development) 2002
- SEPP (Resilience and Hazards) 2021

SEPP (Design Quality of Residential Apartment Design)

The application was not referred to the Waverley Design Advisory Excellence Panel (DEAP) as the works are not considered to be substantial. Clause 6A of SEPP 65 requires that development control plans (DCPs) cannot be inconsistent with the Apartment Design Guide (ADG) in respect of the following:

- (a) visual privacy,
- (b) solar and daylight access,
- (c) common circulation and spaces,
- (d) apartment size and layout,
- (e) ceiling heights,
- (f) private open space and balconies,
- (g) natural ventilation,
- (h) storage.

If a DCP contains provisions that specify requirements, standards or controls in relation to a matter to which this clause applies, those provisions are of no effect. An assessment against the provisions within the ADG is provided in **Table 1** of this report.

Table 1: Apartment Design Guide

Design Criteria	Compliance	Comment
3F Visual privacy		
Min separation distances from buildings to side and rear boundaries:	Yes	The proposed skylights and windows will not look directly into neighbouring windows.

Design Criteria	Compliance	Comment
Up to 12m (4 storey) – 6m habitable & 3m non- habitable		
4B Natural ventilation		
All habitable rooms are naturally ventilated	Yes	The windows provide cross ventilation.
4C Ceiling heights		
	Yes	In accordance with Volume two, Section 3.8.2 of the National Construction Code, habitable rooms within an attic space must have a minimum floor-to-ceiling height of 2.2m for two-thirds of the room. As seen in the Figure 9 , two-thirds of the proposed bedroom has a floor to ceiling height of 2.2m or more.
4D Apartment size and layout		
The following minimum internal areas apply: • 2 Bed = 70 m ²	No	The apartment will have an internal area of 60.7m ² . Although this is slightly under the recommended internal area, the proposed additional space will increase the internal amenity of the unit. The bedroom will exceed 10m ² .
4G Storage		
In addition to kitchens, bathrooms and bedrooms, the following is provided: • 1-bed – 6m ³	No (merit)	No storage space is proposed (excluding kitchen, bathroom and bedrooms). Due to the small internal size of the unit, it is difficult to provide compliant storage space, without reducing the limited internal floor area.

2.1.2. Waverley LEP 2012

The relevant matters to be considered under the Waverley LEP 2012 for the proposed development are outlined below:

Table 2: Waverley LEP 2012 Compliance Table

Provision	Compliance	Comment
Part 1 Preliminary		
1.2 Aims of plan	Yes	The proposal meets the aims of the Waverley LEP 2012.
Part 2 Permitted or prohibited development		
Land Use Table Medium Density Residential 'R3' Zone	Yes	The proposal is defined as alterations and additions to an apartment within a RFB, which is permitted with consent in the R3 zone.

Provision	Compliance	Comment		
Part 4 Principal development standards				
4.3 Height of buildings ■ 12.5m	Yes	The development has a height of 12.36m.		
 4.4 FSR Lot Size: 425.9m² Max FSR: 0.9:1 Max GFA: 383.3m² 	No	GFA Calculations: Lower Ground Floor: 100.1m² Ground Floor: 245.7m² First Floor: 245.7m² Attic Addition (proposed): 15.54m² TOTAL GFA: 607.04m² TOTAL FSR: 1.43:1 The development breaches the maximum GFA by 223.74m² or 58.3%. The attic addition contributes 15.54m² to this breach or 4.05%.		
4.6 Exceptions to development standards	See discussion	The application is accompanied by a written request pursuant to clause 4.6 of Waverley LEP 2012 to vary the FSR development standard. A detailed discussion of the variation to the development standard is presented below this table.		
Part 6 Additional local provisions				
6.1 Acid sulfate soils	N/A	The subject site is located within acid sulfate soils class 5. However, given the works are not at ground level, this is not applicable.		

The following is a detailed discussion of the issues identified in the compliance table above in relation to the Waverley LEP 2012.

Clause 4.6 Exceptions to Development Standards - FSR

The application seeks to vary the FSR development standard in clause 4.4 under Waverley LEP 2012.

The site is subject to a maximum FSR development standard of 0.9:1. The proposed development has a FSR of 1.43:1, exceeding the standard by 223.74m² equating to a 58.3% variation.

A written request has been submitted to Council in accordance with clause 4.6(3)(a) and (b) of Waverley LEP 2012 seeking to justify the contravention of the development standard by demonstrating:

- (a) That compliance with the development standard is unreasonable or unnecessary in the circumstances of the case; and
- (b) That there are sufficient environmental planning grounds to justify contravening the standard.

A copy of the applicant's written request has been provided to the Waverley Local Planning Panel for consideration.

Applicant's Written Request - Clause 4.6(3)(a) and (b)

The applicant seeks to justify the contravention of the FSR development standard on the following basis:

- (a) That compliance with the development standard is unreasonable or unnecessary in the circumstances of the case:
 - (i) The proposal meets the relevant objectives of FSR.

Objective (b) To provide an appropriate correlation between maximum building heights and density controls.

The maximum allowable Building Height is 12.5m, however, this application does not result in any change to the existing building height as the proposed roof addition does not exceed the existing maximum building height.

Objective (c) To ensure that buildings are compatible with the bulk and scale of the desired future character of the locality.

The bulk and scale remains largely the same with the exception of the added roof gable.

Objective (d) To establish limitations on the overall scale of development to preserve the environmental amenity of neighbouring properties and the locality.

It can be clearly shown that the surrounding locale comprises many comparable developments consisting of a far greater bulk and scale than what this application seeks. The application results in the best use of existing void space with negligible increase to bulk and scale as well as minimal impacts caused to any adjoining neighbouring dwelling.

While the objectives of the floor space ratio planning control apply to the proposal, it should be considered that the proposal is consistent with those objectives as the completed development results in a form that is consistent with council's desired future character of the locale despite the breach in floor space ratio. This is on the basis that the underlying objective of the standard is to allow the site to accommodate an appropriate density of construction and that the design of the proposal successfully achieves this objective in its configuration and bulk, achieving a desirable outcome. Strict compliance with the floor space ratio control would likely result in undesired outcomes and a bulk form detrimental to the amenity of the property with the environmental capacity of the property being underutilised and inconsistent from the developing urban street formation.

Bulk and scale are mostly dictated by Floor space ratio as this is the primary control that controls building density. Objective (b), and (d) of clause 4.4 of the WLEP solidify this notion as shown below.

- (ii) The proposal meets the objectives of the zone.
 - a. To provide for the housing needs of the community within a medium density residential environment.

The existing site is heavily constrained in terms of lot size and buildable footprint. The existing footprint of the base building is heavily restricted in its ability to be expanded by any means. This is contradictory to the NSW state governments push for housing availability. Given the extremity of consistent price increases in Bondi and the general locale it is difficult for a small family to be able to afford to live within the area. This has a direct effect on people's quality of life as it prevents proximity to friends, family and local amenities.

The application seeks to increase the amount of usable floor area afforded to unit 15 with little to no impact on the adjoining building as well as a significantly positive impact to the public domain.

The proposed first floor also provides additional storage options which are a fundamentally important component of a dwelling, as it allows inhabitants to organise and store personal items, paraphernalia and valuables that are not required for frequent use. Given the limited footprint of the existing dwelling and restricted

storage space, this application will significantly improve the functionality of the dwelling.

Council is to consider the immense impact that this application would have on any resident that live within the dwelling (current and future) taking into account the minimal impact that is created to the surrounding neighbourhood.

b. To provide a variety of housing types within a medium density residential environment.

The base building remains a residential flat building as a result of this application and the proposed works are directly in line with the objectives of the medium density building typology.

c. To enable other land uses that provide facilities or services to meet the day to day needs of residents.

As discussed in the previous clauses, the proposal aims to afford a significantly higher level of amenity and quality of life afforded to the current and future inhabitants of the sole occupancy unit. The SOU is heavily constrained in terms of usable footprint which makes it difficult to cater for a small sized family.

d. To maximise public transport patronage and encourage walking and cycling. Not applicable.

e. To increase or preserve residential dwelling density.

The application maintains majority of the existing physical form of the building and does not significantly increase the building density.

f. To encourage the supply of housing, including affordable housing, that meets the needs of the population, particularly housing for older people and people with disability.

This objective is not relevant to the context of the application as the existing RFB is not considered to be an accessible building.

- g. To provide development that is compatible with the desired future character and amenity of the surrounding neighbourhood. Complies.
- h. To promote development that incorporates planning and design measures that reduce the urban heat island effect.

 Not applicable.
- To improve the urban tree canopy by providing high levels of deep soil planting and additional landscaping.
 Not applicable.
- (b) That there are sufficient environmental planning grounds to justify contravening the standard:
 - (i) If numerical compliance is achieved with the FSR standard then the objectives would not be achieved as no unsightly bulk and scale is introduced nor is landscaped area compromised. The application does not seek to over develop an existing structure, however, repurposes valuable area that is essentially "dead space," for a better use in the form of usable habitable area resulting in an increased quality of life for the current and future inhabitants of the dwelling.
 - (ii) The applicant's written request has adequately addressed the matters required to be demonstrated by subclause 3 of clause 4.6 being that compliance with the development standard is unreasonable or unnecessary in the circumstances of the case, and that there are sufficient environmental planning grounds to justify contravening the standard.
 - (iii) If the proposed addition was not sought then the visible bulk and scale would remain as existing and there would be no result in any improved outcome for the development and the adjacent properties.
 - (iv) The proposed development is consistent with the aims of the Policy and the objects of the EP&A Act in that:
 - a. Strict compliance with the development standard would result in an inflexible application of the control that would not deliver any additional benefits to the owners or occupants of the surrounding properties or the general public.
 - b. Strict compliance with the FSR standard in this particular instance would represent a departure from the manner in which the issue of FSR has been considered in recent times in the locale to the significant detriment of the current and future inhabitants and with no measurable benefit for the public or surrounding properties. Accordingly, strict compliance would simply prevent the maximisation of the use of land.

- c. The proposed variation allows for the most efficient and economic use of the land.
- d. The objectives of the zone are satisfied.
- e. Fundamental planning principles are satisfied:
 - i. The development is in keeping with the local context and there is no detriment to the public.
 - ii. There is no effect to streetscape amenity or any public spaces.
 - iii. The proposed works are considered orderly development of the land.
 - iv. There are no significant effects in relation to overshadowing, privacy or acoustic amenity.
 - v. The scale and bulk of the building remains as existing and is consistent with the surrounding locale.
 - vi. The quality of life afforded to the current and future inhabitants of the dwelling is greatly increased as valuable
- vii. habitable space results and can be utilised for day to day activities.

Consideration of Applicant's Written Request - Clause 4.6(4) (a) (i) and (ii)

Development consent must not be granted unless the consent authority is satisfied that:

- (a) The applicant's written request has adequately addressed the matters required to be demonstrated by subclause 3 of clause 4.6 being that compliance with the development standard is unreasonable or unnecessary in the circumstances of the case, and that there are sufficient environmental planning grounds to justify contravening the standard; and
- (b) The proposed development will be in the public interest because it is consistent with the objectives of the particular development standard and the objectives for development within the zone in which the development is proposed to be carried out.

Does the written request adequately address those issues at clause 4.6(3)(a)?

It is considered that the applicant has adequately addressed that compliance with the standard is unreasonable or unnecessary in the circumstances of the case and has referenced one or more of the following justifications as set out in *Wehbe v Pittwater Council* (2007) 156 LGERA 446:

- (a) the objectives of the development standard are achieved notwithstanding non-compliance with the standard:
- (b) to establish that the underlying objective or purpose is not relevant to the development with the consequence that compliance is unnecessary;
- (c) to establish that the underlying objective or purpose would be defeated or thwarted if compliance was required with the consequence that compliance is unreasonable;

- (d) to establish that the development standard has been virtually abandoned or destroyed by the Council's own actions in granting consents departing from the standard and hence compliance with the standard is unnecessary and unreasonable; and
- (e) to establish that "the zoning of particular land" was "unreasonable or inappropriate" so that "a development standard appropriate for that zoning was also unreasonable or unnecessary as it applied to that land" and that "compliance with the standard in that case would also be unreasonable or unnecessary.

The applicant specifically relies upon justification (a) outlined above to address clause 4.6(3)(a) of Waverley LEP 2012. This is sound justification as despite the breach to FSR, the development meets the objectives of the development standard.

Does the written request adequately address those issues at clause 4.6(3)(b)?

The applicant has adequately addressed that there are sufficient environmental planning grounds to justify contravening the development standard. The proposed development upgrades the outdated and undersized unit with an improved internal amenity, whilst not creating additional environmental amenity impacts to neighbouring properties.

Is the development in the public interest?

The proposed development will be in the public interest because it is consistent with the objectives of the particular development standard and the objectives for development within the zone in which the development is proposed to be carried out.

The relevant objectives of the FSR development standard are as follows:

Objective (b) To provide an appropriate correlation between maximum building heights and density controls.

The proposed development provides an appropriate correlation between height and density. The proposed works to amend the hipped roof to a gabled roof will provide increased internal amenity for the unit and complies with the 12.5m height limit.

Objective (c) To ensure that buildings are compatible with the bulk and scale of the desired future character of the locality.

The proposed amended gabled roof form provides an acceptable transition between 9 Francis Street and 2-8 Campbell Parade (Noah's Backpackers), with the top of the ridge aligning with the parapet height of 2-8 Campbell Parade (Noah's Backpackers).



Figure 7. Elevational plan showing a compatable bulk and scale for the locality (Source: iSA Designs, 2012)

Objective (d) To establish limitations on the overall scale of development to preserve the environmental amenity of neighbouring properties and the locality.

The proposed development preserves the environmental amenity of neighbouring properties. The submitted shadow diagrams indicate that only a small portion of additional overshadowing will fall on the RFB at 4 Francis Street at 9am. This shadowing is created from the ridge point of the proposes gable roof and will likely fall on the garage door.

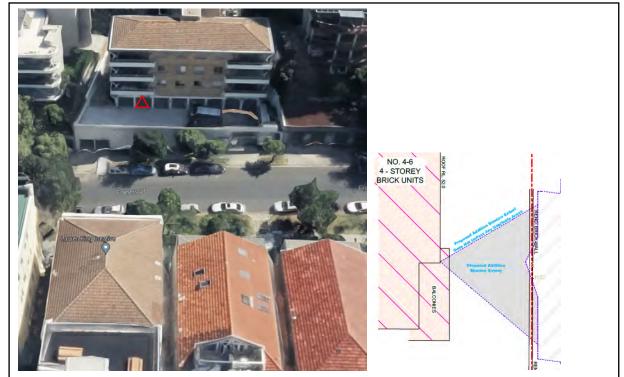


Figure 8. 3D satelight image showling the likley location of were the proposed shadowing will cast on 4 Francis Street Bondi Beach (Source: Goole Maps, 2023 & iSA Designs, 2023)

In addition to this, a view loss analysis was prepared from 4/4 Francis Street. This view loss analysis demonstrated that no view loss is likely to occur.

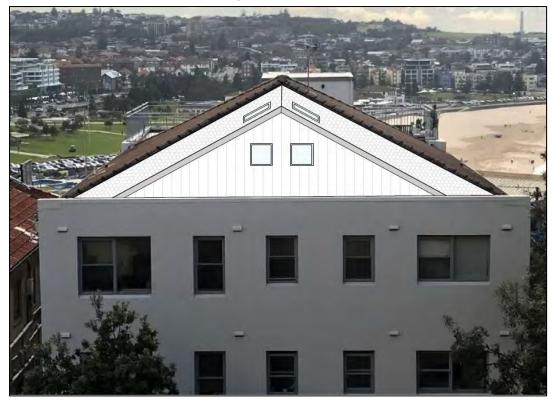


Figure 9. View loss diagram from 4/4 Francis Street, Bondi Beach (Source: iSA Designs, 2023)

The proposal meets the relevant objectives of the R3 zone, as it provides housing for the community within a medium density residential environment.

Conclusion

For the reasons provided above, the requested variation to the FSR development standard is supported as the applicant's written request has adequately addressed the matters required to be addressed by clause 4.6 of the Waverley LEP 2012 and the proposed development would be in the public interest because it is consistent with the objectives of FSR and the R3 zone.

2.1.3. Waverley Development Control Plan 2022 (Waverley DCP 2022)

The relevant matters to be considered under the Waverley DCP 2022 for the proposed development are outlined below:

Table 3: Waverley DCP 2022 – Part B General Provisions Compliance Table

Development Control	Compliance	Comment
1. Waste	Yes	The submitted Site Waste and Recycling Management Plan is satisfactory.

Development Control	Compliance	Comment
Garbage bins are to be stored in an appropriate location.		The application was referred to Council's Waste Officer who recommended conditions of consent.
2. Ecologically Sustainable Development	Yes	The submitted BASIX Certificate is satisfactory.
3. Landscaping, Biodiversity and Vegetation Preservation	N/A	Tree removal is not proposed.
5.Water Management	Yes	The application was referred to Council's Stormwater Engineer who recommended conditions of consent.
11. Design Excellence	Yes	The proposed finish of the gabled roof addition is recommended to be conditioned to match the material and colour of the existing hipped roof and the materiality of the façade is to be reviewed and approved by Council's Heritage Officer. The bulk and mass of the proposed works is considered to be acceptable and does not create
		unreasonable environmental impacts, as demonstrated in the Clause 4.6 Variation above.

Table 41: Waverley DCP 2022 – Part C2 Other Residential Development Compliance Table

Development Control	Compliance	Comment
2.2 Height		
 Maximum external wall height: R3/12.5m – 9.5m 	N/A	The wall height of the building will not increase with the attic addition.
2.3 Setbacks		
2.3.1 Street setbacksConsistent street setback	Yes	The proposed front setback is acceptable, with the proposed gable roof appropriately responding to the existing built form.
2.3.2 Side and rear setbacksMinimum side setback:.1.5m	Yes	The proposed works are setback more than 1.5m from either side boundary.
 Minimum rear setback: 6m or predominant rear building line, whichever is the greater setback 	N/A	There are no amendments to the rear setback.

Development Control	Compliance	Comment		
2.5 Building design and streetscape				
 Respond to streetscape Sympathetic external finishes 	Yes	The existing RFB provides an acceptable transition between the larger building of Noahs Backpackers (no. 2-8 Campbell Parade) to the south-east and the smaller RFB's (no. 9-17 Francis Street) to the north-west (Refer to Figure 7 above).		
2.6 Attic and roof design				
Attic must be wholly within the pitched roof form	Yes	The proposed attic will be located within the proposed gabled roof form.		
Not exceed 50% of the floor of area of the floor below	Yes	The attic level does not exceed more than 50% of the level below.		
Not contain independent dwellings and must be accessed via internal	Yes	The attic level does not contain and independent dwelling and is accessed via internal stairs.		
stairs • Be naturally ventilated	Yes	The attic level is naturally ventilated via openable windows.		
Minimum room width: 3m	Yes	The room width exceeds 3m. Floor to ceiling height will be discussed below.		
Minimum floor to ceiling height for at least 2/3 of the floor area: 2.4m	Discussed below	The skylights are less than 50% of the roof elevation.		
Dormer windows and skylights to be less than 50% of roof elevation	Yes			
2.13 Solar access and overshad	dowing			
	Yes	Overshadowing impacts are discussed within the Clause 4.6 Variation discussion above.		
2.14 Views and view sharing				
	Yes	View impacts are discussed within the Clause 4.6 Variation discussion above.		
2.15 Visual privacy and securit	у			
	Yes	The windows are modest in size and do not look directly into adjoining neighbouring windows.		
2.16 Dwelling size and layout → REFER TO PART 4D OF THE ADG				
2.18 Storage → REFER TO PART 4G OF THE ADG 2.20 Natural Ventilation → REFER TO PART 4B OF THE ADG				

The following is a detailed discussion of the issues identified in the compliance tables above in relation to the Waverley DCP 2022.

Floor-to-Ceiling Heights

In accordance with Volume two, Section 3.8.2 of the National Construction Code, habitable rooms within an attic space must have a minimum floor-to-ceiling height of 2.2m for two-thirds of the room.

As seen in the **Figure 10** below, two-thirds of the proposed bed has a floor to ceiling height of 2.2m or more.

It is noted that the space meets the Waverley LEP 2012 definition of an attic, which is defined as *any* habitable space, but not a separate dwelling, contained wholly within a roof above the ceiling line of the storey immediately below, except for minor elements such as dormer windows and the like.

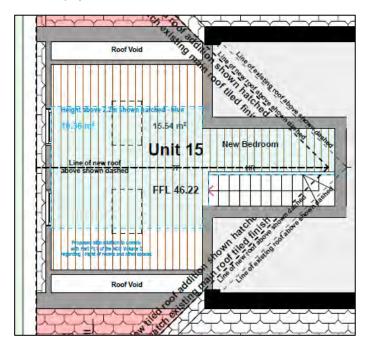


Figure 10. Compliant floor-to-ceiling heights within the attic: iSA Designs, 2023)

2.2. Other Impacts of the Development

The proposal is considered to have no significant detrimental effect relating to environmental, social or economic impacts on the locality, subject to appropriate conditions being imposed.

The previously refused applications (DA-107/2019 and DA-422/2021) proposed to amend the hipped roof to a gable roof for an attic addition containing a dormer addition to either side and a balcony to a side elevation. The dormer windows and associated balconies resulted in visual privacy and view loss impacts to neighbouring properties and therefore were not supported.

With the subject DA removing the dormer additions and balcony, the environmental amenity impacts of visual privacy and view loss have been resolved, with the proposed addition being of an appropriate bulk and scale.

2.3. Suitability of the Site for the Development

The site is considered suitable for the proposal.

2.4. Any Submissions

The application was notified in excess of 14 days from 28 June – 14 July 2023 in accordance with the *Waverley Community Development Participation and Consultation Plan*.

Following receipt of amended plans and additional information, the application was not re-notified as the amended form of the proposal does not represent a greater impact from the originally notified scheme.

• The proposed attic addition was amended from storage space to a bedroom. The bulk and scale of the development remains the same as original notified.

A total of four unique submissions were received from the following properties:

Table 5: Number of and where submissions were received from.

Count	Property Address	
1	4/4 Francis Street, Bondi Beach	
4	7/7 Francis Street, Bondi Beach (3 unique objections)	

The following issues raised in the submissions have already been discussed and addressed in the body of this report and/or the recommendation:

- Loss of visual privacy
- Solar access
- Streetscape impacts

All other issues raised in the submissions are summarised and discussed below.

Issue: 'Is this the same application submitted in 2021'

Response: The proposal differs from the scheme submitted in 2021. The primary difference is the deletion of the dormer windows and balcony.

Issue: 'Are the plans the same as submitted in 2021? If they are these plans have been rejected twice by council. If these are different plans this has not been presented to the strata committee and have not been voted on.'

Response: According to the application form, the Strata Manager signed the application form on 28 November 2022. Any application that is Strata titled requires consent from the Strata Committee (signed under delegations of the Strata Manager), which has been completed. Strata Committee Meetings are a separate and independent process that Council is not involved in.

Issue: Cost of works underestimated.

Response: The cost does not include a break-down of trade worker fees. Regardless, an amended cost of works calculation was requested during the assessment of the application.

Issue: A skip bin would impact parking.

Response: A Construction Traffic Management Plan is recommended to be submitted and approved by Council's Traffic Engineer.

Issue: Removal of demolition work via internal stairs.

Response: Standard conditions are recommended for imposition that ensure works are carried out in a safe manner. There may be disturbance for a time to other residents of the block, however this can be adequately dealt with via conditions and by-laws/Strata Management during this time.

Issue: The subject site is draft heritage listed.

Response: At the time of assessment, the subject site is not heritage listed or located in a Heritage Conservation Area. The subject site is located within the draft Bondi O'Brien Urban Conservation Area which has not yet been adopted. Regardless, Council's Heritage Officer reviewed the pre-DA application (same proposal as subject DA) and did not object. However, a condition is recommended that the proposed materials and finishes are reviewed and satisfied by the Council Heritage Officer as part of the Construction Certificate process.

Issue: 'No work hours specified No noise and disturbance restrictions No encroachment restrictions have been set.'

Response: This is dealt with via conditions of consent, which are consistent with other developments in the LGA.

Issue: 'They also state that there are no privacy issues when in fact the owner of unit 15 wants to install windows which will open directly onto the common area rooftop.'

Response: This is not correct.

Issue: 'Have the owners facing 7 Francis Street been notified that windows facing their building will be installed in 7 Francis street and the roof line altered.'

Response: Adjoining properties have been notified in accordance with Council's Community Participation Plan.

Issue: Impact on stain glass windows.

Response: This is a matter to be dealt with during the construction phase. Regardless, the subject site is not heritage listed or located within a heritage conservation area.

Issue: No time-frame has been advised.

Response: A DA does not require a time frame to be advised. This is a civil matter than can be sought between the relevant parties, separate to a DA. Once development consent is granted, the validity is 5 years to commence works.

Issue: 'The leaving open of the front security door for access creates danger for residents as anyone can then enter the building.'

Response: This is a matter that can be dealt with during the construction phase between the residents of the block and Strata Management.

2.5. Public Interest

The proposal is considered to have no detrimental effect on the public interest, subject to appropriate conditions being imposed.

REFERRALS

The following internal referral comments were sought:

3.1. Stormwater

An internal referral was sought from Council's Stormwater Engineer who recommended conditions of consent.

3.2. Heritage

Council's Heritage Officer reviewed the previous Pre-DA and raised no objection. Notwithstanding, the materials are to be reviewed and approved by Council's Heritage officer.

3.3. Fire Safety

An internal referral was sought from Council's Fire Safety Officer who recommended conditions of consent.

3.4. Waste Management

An internal referral was sought from Council's Waste Officer who did not object to the proposal.

3.5. Tree Management

An internal referral was sought from Council's Tree Officer who recommended conditions of consent relating to the retention and protection of the Coast Banksia located on the Francis Street nature strip.

4. CONCLUSION

The DA seeks consent for alterations and additions to unit 15 including amending the hipped roof to a gabled roof to facilitate the conversion of the roof void to an attic level to be used as a bedroom at the site known as 7 Francis Street, Bondi Beach.

The principal issue arising from the assessment of the application related to a breach to FSR.

The assessment finds this issue acceptable as it has been demonstrated that despite the breach to the development standard, the proposal meets the FSR and zone objectives of the Waverley LEP 2012.

A total number of four submissions were received and the issues raised in the submissions have been considered and addressed in this report and in the recommendation.

The application has been assessed against the relevant matters for consideration under section 4.15(1) of the *Environmental Planning and Assessment Act 1979*. It is recommended for approval subject to conditions of consent.

5. RECOMMENDATION TO WAVERLEY LOCAL PLANNING PANEL

That the development application be APPROVED by the Waverley Local Planning Panel subject to the conditions in Appendix A.

Report prepared by:	Application reviewed and agreed by:	Application reviewed and agreed by:
J/emuille	M ·	R
Joseph Somerville	Bridget McNamara	Angela Rossi
Senior Development	Manager, Development	A/Executive Manager,
Assessment Planner	Assessment	Development Assessment
Date: 29 August 2023	Date: 31 August 2023	Date: 1 September 2023

Reason for WLPP referral:

1. Departure from any development standard in an EPI by more than 10%

OFFICE USE ONLY

Clause 4.6 register entry required	58.3% variation to FSR (Clause 4.4)	
	X Pre-existing non-compliance	
	X No unreasonable impacts on the	
	amenity of adjoining properties or	
	streetscape	
	X Sufficient environmental planning	
	grounds	
	X Consistent with the objectives of the	
	standard	
Determining Authority	Local Planning Panel	
(Concurrence Authority for Clause 4.6 variation)		
Affordable Rental Housing Units?	No	
*This is a planning portal reporting requirement		
Secondary Dwelling	No	
*This is a planning portal reporting requirement		
Boarding House	No	
*This is a planning portal reporting requirement		
Group Home	No	
*This is a planning portal reporting requirement		
Trial Period database entry required	No	
VPA submitted – follow up actions required	No	

Refer to compliance for investigation	No
Commercial/liquor operational conditions	No
Other (please specify):	No

APPENDIX A – CONDITIONS OF CONSENT

A. APPROVED DEVELOPMENT

1. APPROVED PLANS AND DOCUMENTATION

The development must be in accordance with:

(a) Architectural Plans prepared by iSA Designs including the following:

Plan Number	Plan description	Plan Date	Date received by
and Revision			Council
DA_005 / Rev 5	Existing Lower Ground Floor Plan	15/03/2023	24/08/2023
DA_006 / Rev 5	Existing Ground Floor Plan	15/03/2023	24/08/2023
DA_007 / Rev 5	Existing First Floor Plan	15/03/2023	24/08/2023
DA_008 / Rev 5	Existing and Demolition Floor Plan	15/03/2023	24/08/2023
DA_010 / Rev 5	Proposed Second Floor Plan	15/03/2023	24/08/2023
DA_011 / Rev 5	Proposed Attic Floor Plan	15/03/2023	24/08/2023
DA_012 / Rev 5	Proposed Roof and Stormwater	15/03/2023	24/08/2023
	Management Plan		
DA_013 / Rev 5	Proposed South West Elevation	15/03/2023	24/08/2023
DA_014 / Rev 5	Proposed North East Elevation	15/03/2023	24/08/2023
DA_015 / Rev 5	Proposed North West Elevation	15/03/2023	24/08/2023
DA_016 / Rev 5	Proposed South East Elevation	15/03/2023	24/08/2023
DA_017 / Rev 5	Proposed Section AA	15/03/2023	24/08/2023
DA_020 / Rev 5	Proposed Attic Floor Reflected	15/03/2023	24/08/2023
	Ceiling Plan		

- (b) BASIX and NatHERs Certificate/s
- (c) The Site Waste and Recycling Management Plan (SWRMP) Part 1 received by Council on 23/06/2023.

Except where amended by the following conditions of consent.

2. FINISHES AND MATERIALS

The application is approved subject to the following plan amendments;

- (a) The finishes, materials and colour of the proposed roof must match the finishes, materials and colour of the existing roof.
- (b) The proposed materials and finishes of the gabled roof façade are to be reviewed and satisfied by Council's Heritage Officer.

The amendments are to be submitted and approved by the **Council's Heritage Officer** prior to the issue of any Construction Certificate.

3. MULTI UNIT HOUSING DEVELOPMENT DESIGN (SEPP 65 DEVELOPMENT)

The approved design (including any element or detail of that design) or materials, finish or colours of the building must not be changed without the written approval of Council.

B. PRIOR TO THE ISSUE OF A CONSTRUCTION CERTIFICATE

GENERAL REQUIREMENTS

4. NO BUILDING OR DEMOLITION WORKS PRIOR TO RELEASE OF CONSTRUCTION CERTIFICATE

The building work, or demolition work, must not be commenced until:

- (a) a Construction Certificate has been obtained from Council or an Accredited Certifier in accordance with the *Environmental Planning and Assessment Act 1979*;
- (b) a Principal Certifying Authority has been appointed and Council has been notified of the appointment in accordance with the *Environmental Planning and Assessment Act 1979* and *Environmental Planning and Assessment Regulation 2021*; and
- (c) Council is given at least two days' notice in writing of the intention to commence the building works.

CONTRIBUTIONS, FEES & BONDS

5. SECTION 7.12 CONTRIBUTION

A monetary development contribution is payable to Waverley Council pursuant to section 7.12 of the *Environmental Planning and Assessment Act 1979* and the Waverley Council Development Contributions Plan in accordance with the following:

- (a) Where the total development cost is less than \$500,000:
 - a. a **Cost Summary Report** or **Building Contract** or similar is to be submitted to Council's Customer Service Centre to process payment.
- (b) Where the total development cost is \$500,000 or more:
 - a. a **Detailed Cost Report** prepared by a registered Quantity Surveyor, **Building Contract**, or similar is to be submitted to and approved by Council's Executive Manager, Urban Planning, Policy and Strategy (or delegate).

 Please forward documents to info@wayerley psw gov au attentioned to Strategic
 - Please forward documents to <u>info@waverley.nsw.gov.au</u> attentioned to Strategic Planning, and reference the relevant application number, address and condition number to satisfy.
 - Upon confirmation of the contribution amount by Council's Executive Manager,
 Urban Planning, Policy and Strategy (or delegate), payment is to be processed via the Customer Service Centre.
 - c. Should there be a discrepancy between the cost of works approved in subclause (b)(i) and the DA fee nominated in the original DA, then additional DA Fees may be payable prior to the issue of a Construction Certificate.

A copy of the required format for the cost reports are provided in the Waverley Council Contributions Plan, available on Council's website.

- (c) As legislated in section 209 of the Environmental Planning and Assessment Regulation 2021, the levy must be paid in accordance with the following;
 - (i) A development valued at \$100,000 or less will be exempt from the levy;
 - (ii) A development valued at \$100,001 \$200,000 will attract a levy of 0.5% of the <u>full</u> cost of the development; or

(iii) A development valued at more than \$200,000 will attract a levy of 1% of the <u>full</u> cost of the development.

Prior to the issue of any Construction Certificate, evidence must be provided that the levy has been paid to Council in accordance with this condition or that the cost of works is less than \$100,000.

6. SECURITY DEPOSIT

A deposit (cash or cheque) for the amount of \$6,505.00 must be provided to Council for any damage caused to any property of the consent authority (ie. public land) as a consequence of the works and completing any public work (such as road work, kerbing and guttering, footway construction, stormwater drainage and environmental controls) required in connection with the consent.

This deposit (cash or cheque) must be provided to Council prior to the issue of any Construction Certificate. The full amount of the deposit, minus Council's costs for any repair of damage to Council property or rectification of unauthorised works on Council property, will be refunded after satisfactory completion all of works associated with this consent (including the required public works) to the person who paid the deposit.

7. LONG SERVICE LEVY

A long service levy, as required under section 34 of the *Building and Construction Industry Long Service Payments Act, 1986*, is to be paid in respect of this building work. Evidence that the levy has been paid is to be submitted to the Principal Certifying Authority prior to the issue of any Construction Certificate.

<u>Note</u>: Council acts as an agent for the Long Service Payment Corporation and the levy may be paid at Council's office. The levy rate is 0.25% of building work costing \$250,000 or more.

8. ENGINEERING PLANS ASSESSMENT AND WORKS INSPECTION FEES

The applicant is to pay to Council fees for assessment of all engineering plans and inspection of the completed works in the public domain inclusive of all stormwater assessment, in accordance with Council's Schedule of Fees & Charges at the time of engineering plan approval, prior to such approval being granted by Council.

An invoice will be issued to the applicant for the amount payable, which will be calculated based on the design plans for the subject development.

9. TREE PRESERVATION BOND

A bond of \$5,000 is to be lodged with Council either as cash or by way of an unconditional bank guarantee to ensure the protection and maintenance of the one (1) Banksia integrifolia (coast Banksia) on Francis Street.

The bond is to be lodged prior to the issue of a Construction Certificate.

The sum will be forfeited to the Council at its discretion for a breach of these requirements and will be refunded twelve (12) months from the issue of the Occupation Certificate subject to the satisfaction of Council.

CONSTRUCTION & SITE MATTERS

10. HOARDING

To ensure the site is contained during construction, a hoarding is required for the approved works, which is to be designed and constructed in accordance with the requirements of Safe Work NSW. Where the hoarding is to be erected over the footpath or any public place, the approval of Council's Compliance Unit must be obtained and the applicable fees paid, prior to the erection of the hoarding.

11. EROSION & SEDIMENT CONTROL

A Soil and Water Management Plan (SWMP), also known as an Erosion and Sediment Control Plan must be prepared in accordance with Waverley Council's Water Management Technical Manual.

The SWMP must be approved by the Principal Certifying Authority prior to the issue of a Construction Certificate. A copy of the SWMP must be kept on site at all times and made available to Council officers upon request.

The recommendations of the SWMP must be implemented and maintained during all construction activities and until the site is fully stabilised following construction.

12. ENGINEERING DETAILS

Structural details are to be prepared and certified by a practicing Structural Engineer in connection with all structural components of the approved works, prior to the issue of the relevant Construction Certificate.

13. ENGINEERING DETAILS - CERTIFICATE OF ADEQUACY

A Certificate of Adequacy prepared by a practicing Structural Engineer, certifying the adequacy of the existing building structure to carry the extra load of the proposed additions is to be provided to Council or the Accredited Certifier prior to the issue of a Construction Certificate.

14. DILAPIDATION REPORT

A Dilapidation report is to be prepared for any adjoining or nearby property that may be subject to potential damage as a result of any works being undertaken. The dilapidation report is be made available to affected property owners.

The report is to be dated, submitted to, and accepted by the Principal Certifying Authority, prior to any work commencing on the site.

Note: Any damage that may be caused is a civil matter. This consent does not allow or authorise any party to cause damage, trespass, or any other unlawful act and Council will not be held responsible for any damage that may be caused to adjoining buildings as a consequence of the development being carried out. Council will not become directly involved in disputes between the builder, owner, developer, its contractors and the owners of neighbouring buildings.

FIRE SAFETY

15. ESSENTIAL SERVICES - EXISTING BUILDING

Details of the currently implemented and proposed essential fire safety measures shall be submitted to Council, with the Construction Certificate, in the form of a Fire Safety Schedule. This Schedule shall be prepared by a person competent to do so and shall specify the minimum standard of performance for each essential fire safety measure included in the Schedule.

At the completion of the installation, a Final Fire Safety Certificate shall be attached to the Occupation Certificate, certifying that each essential fire safety measure specified within the current Fire Safety Schedule:

- (a) has been assessed by a properly qualified person; and
- (b) found to be capable of performing to at least the standard required by the current Fire Safety Schedule for the building for which the Certificate is issued.

16. FIRE SAFETY UPGRADING WORKS

- (a) In addition to all new works fully comply with the Building Code of Australia, pursuant to Clause 64 of the Environmental Planning and Assessment Regulation 2021, unit 15 must be upgraded to comply with the following provisions of the Building Code of Australia (BCA):
 - (i) The subject sole-occupancy units must be separated from adjoining sole occupancy units and internal common areas by building elements that comply with the fire resistance performance requirements set out in CP2 and CP8 of Volume 1 of the Building Code of Australia;
 - (ii) Smoke hazard management Part E2;
 - (iii) Sanitary and other facilities Part F2;
 - (iv) Room heights Part F3; and
 - (v) Light and ventilation Part F4.
- (b) If compliance with the deemed-to-satisfy provisions of the BCA and the matters listed in condition (a) above cannot be achieved, an alternative building solution in accordance with Part A2 of the BCA must be prepared by a suitably qualified and accredited person and be submitted to the Certifying Authority illustrating how the relevant performance requirements of the BCA are to be satisfied. Prior to a Construction Certificate being issued, the Certifying Authority must ensure that the building complies with the Building Code of Australia.
- (c) The BCA matters identified in (a) above are not an exhaustive list of conditions to verify compliance or non-compliance with the BCA. Any design amendments required to achieve compliance with the BCA must be submitted to Council. Significant amendments may require an application under Section 4.55 of the Act to be lodged with Council to amend this consent.
- (d) Prior to the commencement of any required upgrade works, a Construction Certificate must be issued by an accredited Certifying Authority and an accredited PCA be appointed. The required upgrading works detailed in this condition must be completed prior to the issue of an Occupation Certificate.

TRAFFIC MANAGEMENT

17. CONSTRUCTION TRAFFIC MANAGEMENT PLAN (CTMP)

The applicant is to submit a Construction Traffic Management Plan (CTMP) for the approval of Council's Executive Manager, Infrastructure Services, or delegate, prior to the issue of any Construction Certificate. For further information on what is required in the CTMP, please refer to Council's website at:

https://www.waverley.nsw.gov.au/building/development_applications/post_determination/development_applications - conditions of consent_

STORMWATER & FLOODING

18. STORMWATER AND PUBLIC INFRASTRUCTURE MANAGEMENT

To ensure that stormwater runoff from the development is drained in an appropriate manner, without impact to neighbouring properties and downstream systems, a detailed plan and certification of the development's stormwater management system must be submitted and approved by the Executive Manager, Infrastructure Services (or delegate) prior to the issue of the relevant Construction Certificate.

The submitted stormwater management plan prepared by Isa Designs, Project No. DA_221203, Drawing No. DA_012, dated 23/06/2023 is considered concept only.

The applicant must submit plans and specifications to comply with the current Waverley Council Water Management Technical Manual and Development Control Plan (DCP) at the time of engineering plan approval. The submitted plans shall be prepared by a suitably qualified and practising Civil Engineer and:

- (a) The stormwater management plan must specify any components of the existing system to be retained and certified during construction to be in good condition and of adequate capacity to convey additional runoff and be replaced or upgraded if required.
- (b) Detail the location of the existing stormwater drainage system including all pipes, inspection openings, surface drains, pits and their discharge location as well as any new stormwater drainage system.
- (d) Any affected Council's infrastructure as the result of construction activities within the public domain area, inclusive of stormwater, stormwater outlet/s, kerb and gutter, pavement, grass verges and vehicle crossovers within the extent works shall be replaced as per Waverley Council Public Domain Technical Manual. All associated costs shall be borne by the applicant.

Notes:

- (i) The checklist as set out on pages 68-76 on Council's Water Management Technical Manual (October 2021) available online shall be completed and submitted with any revision of Construction Certificate Plan Submission.
- (ii) Since a sewer main run through the property, plans must also be presented to Sydney Water `for their approval.
- (iii) The Applicant is advised to consider the finished levels of the public domain, including new or existing footpaths and pavement prior to setting the floor levels for the proposed development.
- (iv) Waverley Council standard drawings for public domain infrastructure assets are available upon request. Details that are relevant may be replicated in the Engineering design submissions however, Council's title block shall not be replicated.

- (v) Prior to commencement of works a security deposit will be made payable to Council to ensure any additional damage or unauthorised works within the Council property, not conditioned above. Council will reserve the right to withhold the cost of restoring the damaged assets from the security deposit should the applicant fail to restore the defects to the satisfaction of Council
- (vi) Council's contact for infrastructure assessment: E-mail: assets@waverley.nsw.gov.au or Phone: 9083 8886 (operational hours between 9.30am to 4pm Monday to Friday). The expected duration to review and approve the stormwater management plan may take at least 15 working days from the date of submission.

ENERGY EFFICIENCY & SUSTAINABILITY

19. BASIX

All requirements of the BASIX Certificate and NatHERS documentation are to be shown on the Construction Certificate plans and documentation.

WASTE

20. SITE WASTE AND RECYCLING MANAGEMENT PLAN

A Site Waste and Recycling Management Plan (SWRMP) - Part 2 is to be submitted to the Principal Certifying Authority prior to the issue of the relevant Construction Certificate, which outlines materials to be reused and/or recycled as a result of demolition and construction works. At least one copy of the SWRMP Part 2 is to be available on site at all times during construction. Copies of demolition and construction waste dockets that verify the facility that received the material for recycling or disposal and the quantity of waste received, must be retained on site at all times during construction.

C. COMPLIANCE PRIOR TO WORK COMMENCING AND DURING CONSTRUCTION

The requirements outlined in this section are to be provided to the satisfaction of the Principal Certifying Authority in all instances, except where a condition explicitly specifies the approval of Council or a Council Officer is required.

PRIOR TO ANY WORKS

21. CONSTRUCTION SIGNS

Prior to commencement of any works on the site and during construction a sign shall be erected on the main frontage of the site detailing the name, address and contact details (including a telephone number) of the Principal Certifying Authority and principal contractor (the coordinator of the building works). The sign shall be clearly legible from the adjoining street/public areas and maintained throughout the building works.

DEMOLITION

22. DEMOLITION – ASBESTOS AND HAZARDOUS MATERIALS

The demolition, removal, storage, handling and disposal of products and materials containing asbestos must be carried out in accordance with the relevant requirements of SafeWork NSW and the NSW Environment Protection Authority (EPA), including:

- (e) Work Health and Safety Act 2011;
- (f) Work Health and Safety Regulation 2017;
- (g) SafeWork NSW Code of Practice for the Safe Removal of Asbestos;
- (h) Australian Standard 2601 (2001) Demolition of Structures;
- (i) Protection of the Environment Operations Act 1997.

At least 5 days prior to the demolition, renovation work or alterations and additions to any building, the person acting on the consent shall submit a Work Plan to the Principal Certifying Authority in accordance with Australian Standard AS 2601-2001, Demolition of Structure and a Hazardous Materials Assessment prepared by a person with suitable expertise and experience. The Work Plan and Hazardous Materials Assessment shall:

- (a) Outline the identification of any hazardous materials, including surfaces coated with lead paint;
- (b) Confirm that no asbestos products are present on the subject land, or
- (c) particularise a method of safely disposing of the asbestos in accordance with the Code of Practice on how to safely remove asbestos published by SafeWork NSW (catalogue WC03561);
- (d) Describe the method of demolition;
- (e) Describe the precautions to be employed to minimise any dust nuisance; and
- (f) Describe the disposal methods for hazardous materials.

23. CONTROL OF DUST ON CONSTRUCTION SITES

The following requirements apply to demolition and construction works on site:

- (a) Hazardous dust is not to be allowed to escape from the site. The use of fine mesh dust proof screens or other measures are recommended. Any existing accumulations of dust (e.g. ceiling voids and wall cavities) must be removed by the use of an industrial vacuum fitted with a high efficiency particle air (HEPA) filter. All dusty surfaces and dust created from work are to be suppressed by a fine water spray. Water must not be allowed to enter the street and stormwater systems. Demolition is not to be performed during adverse winds, which may cause dust to spread beyond the site boundaries.
- (b) All contractors and employees directly involved in the removal of hazardous dusts and substances are to wear protective equipment conforming to Australian Standard AS1716 Respiratory Protective Devices.

24. CLASSIFICATION OF WASTE

Prior to the exportation of waste (including fill or soil) from the site the material must be classified in accordance with the provisions of the Protection of the Environment Operations Act, 1997 and the NSW EPA Waste Classification Guidelines 2014.

CONSTRUCTION MATTERS

25. CONSTRUCTION HOURS

Demolition and building work must only be undertaken between the hours of 7am and 5pm on Mondays to Fridays and 8am to 3pm on Saturdays, with no work to be carried out on Sundays and public holidays.

Excavation works involving the use of heavy earth movement equipment, including rock breakers and the like, must only be undertaken between the hours of 7am and 5pm on Mondays to Fridays, with no such work to be carried out on Saturday, Sunday or a public holiday.

Noise from construction activities shall comply with the *Protection of the Environmental Operations* (Noise Control) Regulation 2017.

26. STOCKPILES, STORAGE OF MATERIALS AND LOCATION OF BUILDING OPERATIONS

All building materials and any other items associated with the development are to be stored within the property. No materials are to be stored on Council's footpath, nature strip, or road reserve without prior Council approval.

27. CONSTRUCTION INSPECTIONS

The building works are to be inspected during construction by the Principal Certifying Authority (PCA) in accordance with the *Building Legislation Amendment* (Quality of Construction) Act 2002, clause 162A of the *Environmental Planning and Assessment Regulation 2021* and the requirements of any other applicable legislation or instruments.

28. CERTIFICATE OF SURVEY - LEVELS

All construction works are to be in accordance with the Reduced Levels (RLs) as shown on the approved plans. Certification from a Registered Surveyor certifying ground, upper floor/s and finished ridge levels

is to be submitted to the Principal Certifying Authority during construction and prior to continuing to a higher level of the building.

29. CERTIFICATE OF SURVEY - BOUNDARIES AND LOCATION OF BUILDING

A Certificate of Survey prepared by a Registered Surveyor setting out the boundaries of the site and the location of the building on the site is to be submitted to the Principal Certifying Authority to certify the building is located in accordance with the development consent plans. The Certificate is to be submitted prior to the construction of the external walls above the ground floor level of the building.

30. WORK OUTSIDE PROPERTY BOUNDARY

This consent does not authorise any work outside the property boundary.

TREE PROTECTION AND REMOVAL

31. TREE PROTECTION

All trees on site and adjoining properties, including street trees, are to be retained and protected in accordance with AS4970-2009 'Protection of Trees on Construction Sites' and to be certified by an Arborist with AQF level 5 qualification or above, unless approved to be removed in this development consent.

32. STREET TREES TO BE RETAINED/TREE PROTECTION

No existing street trees shall be removed without Council approval. Precautions shall be taken when working near trees to ensure their retention, including the following:

- (a) Do not store harmful or bulk materials or spoil under or near trees;
- (b) Prevent damage to bark and root system;
- (c) Do not use mechanical methods to excavate within root zones;
- (d) Do not add or remove topsoil from under the drip line;
- (e) Do not compact ground under the drip line;
- (f) Do not mix or dispose of liquids within the drip line of the tree; and
- (g) All trees marked for retention must have a protective fence/guard placed around a nominated perimeter in accordance with AS4970-2009 "Protection of trees on construction sites.

33. TRUNK PROTECTION

Trunk protection as per AS 4970 – 2009, Section 4.5.3 is to be installed.

Padding to be used shall be non-absorbing or free draining to prevent moisture build up around the part being protected.

The trunk protection shall consist of a layer of carpet underfelt (or similar) wrapped around the trunk, followed by 1.8 metre lengths of softwood timbers (90 x 45mm in section) aligned vertically and spaced evenly around the trunk at 150mm centres (i.e. with a 50mm gap) and secured together with 2mm galvanised wire or galvanised hoop strap. The timbers shall be wrapped around the trunk (over the carpet underfelt), but not fixed to the tree to avoid mechanical injury or damage to the trunk. Trunk protection must be installed prior to any site works including demolition and maintained in good condition for the duration of the construction period.

- (a) Trunk protection to be removed at the issue of the Occupation Certificate subject to the satisfaction of Council.
- (b) TPZ A 1.8m chain link wire fence or the like shall be erected around the above trees to be retained to protect them from damage during construction. Fencing is not to be removed until all building work has been completed. Fencing to be installed to the dimensions outlined in the table above.
- (c) If any trees on neighbouring properties require pruning, then permission must be gained from the owner of the tree(s) and an Application to Prune or Remove Trees on Private Property is then to be presented to Council for processing.
- (d) If any trees on Council owned land require pruning, the applicant is to supply an tree pruning report from an Arborist with AQF level 5 qualification or above with photos showing the branches that need to be removed.
- (e) If approval is granted the applicant may prune the tree at their expense, by an experienced Arborist/Horticulturist (with a minimum of the Horticulture Certificate or Tree Surgery Certificate).

D. <u>PRIOR</u> TO THE ISSUE OF AN OCCUPATION CERTIFICATE OR SUBDIVISION CERTIFICATE

The requirements outlined in this section are to be provided to the satisfaction of the Principal Certifying Authority in all instances, except where a condition explicitly specifies the approval of Council or a Council Officer is required, prior to the issue of an Occupation Certificate or Subdivision Certificate, whichever applies.

CERTIFICATES, LICENCES, EASEMENTS AND RESTRICTIONS

34. FINAL OCCUPATION CERTIFICATE

Prior to occupation or use of the development, an Occupation Certificate must be obtained.

The Principal Certifying Authority must be satisfied that the requirements of the *Environmental Planning & Assessment Act 1979* have been satisfied including all critical stage inspections. Documentary evidence of all required inspections is to be submitted to Council.

35. CERTIFICATION OF BASIX COMMITMENTS

The Principal Certifying Authority shall certify that the all the undertakings in the approved BASIX certificate have been completed.

36. CERTIFICATION OF APPROVED DESIGN

In accordance with the *Environmental Planning and Assessment Regulation 2021*, the Principal Certifying Authority must not issue an occupation certificate, to authorise a person to commence occupation or use of the development unless it has received a design verification statement from an architect who is registered in accordance with the Architects Act 2003 (i.e. qualified designer) that verifies that the building achieves the design quality of the development as shown in the plans and specifications in respect of which the construction certificate was issued, having regard to the design quality principles.

37. CERTIFICATION OF NEWLY CONSTRUCTED AND RETAINED STORMWATER DRAINAGE SYSTEM

Prior to the issue of any Occupation Certificate, certification is to be provided from a suitably qualified and practicing Engineer or Plumber, that any new stormwater drainage system has been constructed in accordance with the Development Consent, Water Management Technical Manual, all applicable Codes, Policies, Plans, Standards, and good engineering practice. Similarly, any retained stormwater drainage system is unblocked, in good working order, and to be repaired/replaced to best practice. A copy of the certification must be submitted to Council.

ADVISORY MATTERS

The following advisory matters are provided as additional information to ensure compliance with the relevant legislation and requirements. You must also check other Commonwealth and NSW Acts and Regulations which may apply to the works or use approved in this application.

AD1. POST CONSENT CONDITIONS REQUIRING COUNCIL INPUT

Various conditions require further input, review or approval by Council in order to be satisfied following the determination of the application (that is, post consent). In those instances, please adhere to the following process to avoid delays:

- Please read your conditions carefully.
- Information to be submitted to Council should be either via email to info@waverley.nsw.gov.au or via the NSW Planning Portal (if required).
- Attention the documentation to the relevant officer/position of Council (where known/specified in condition).
- Include DA reference number.
- Include condition number/s seeking to be addressed.
- Where multiple conditions need Council input, please try to group the documentation / email/s
 into relevant subjects (multiple emails for various officers may be necessary, for example).
- Information to be submitted in digital format refer to 'Electronic lodgement guidelines' on Council's website. Failure to adhere to Council's naming convention may result in documentation being rejected.
- Where files are too large for email, the digital files should be sent to Council via CD/USB. Council does not support third party online platforms (data in the cloud) for receipt of information.
- Please note, in some circumstances, additional fees and/or additional documents (hard copy) may be required.
- Council's standard for review (from date the relevant officer receives documentation) is 14 days. Times may vary or be delayed if information is not received in this required manner.

AD2. TELECOMMUNICATIONS ACT 1997 (COMMONWEALTH)

Telstra (and its authorised contractors) are the only companies that are permitted to conduct works on Telstra's network and assets. Any person interfering with a facility or installation owned by Telstra is committing an offence under the Criminal Code Act 1995 (Cth) and is liable for prosecution. Furthermore, damage to Telstra's infrastructure may result in interruption to the provision of essential services and significant costs. If you are aware of any works or proposed works which may affect or impact on Telstra's assets in any way, you are required to contact: Telstra's Network Integrity Team on Phone Number 1800810443.

AD3. TREE REMOVAL/PRESERVATION

Any trees not identified for removal in this application have not been assessed and separate approval may be required. Any pruning of trees on adjoining properties required for the erection of scaffolding and/or the construction of the building may also require approval.

AD4.DIAL BEFORE YOU DIG

Underground assets may exist in the area that is subject to your application. In the interests of health and safety and in order to protect damage to third party assets please contact Dial Before You Dig at www.1100.com.au or telephone on 1100 before excavating or erecting structures (this is the law in NSW). If alterations are required to the configuration, size, form or design of the development upon contacting the Dial Before You Dig service, an amendment to the development consent (or a new development application) may be necessary. Individuals owe asset owners a duty of care that must be observed when working in the vicinity of plant or assets. It is the individual's responsibility to anticipate and request the nominal location of plant or assets on the relevant property via contacting the Dial Before You Dig service in advance of any construction or planning activities.

AMENDED PLANS

THE JOLON RESIDENCE

Alterations & Additions - Scope Of Works

SP. 71516 Lot 15

Unit 15 / 7 Francis Street, Bondi Beach NSW 2026

DRAWING LIST:

DA _000	Cover Page
DA_001	Legend, General Notes & Regulatory Provisions
DA_002	Location & Context Details
DA_003	Survey Plan
DA_004	Site Analysis Plan
DA_005	Existing Lower Ground Floor Plan
DA_006	Existing Ground Floor Plan
DA_007	Existing First Floor Plan
DA_008	Existing & Demolition Second Floor Plan
DA_009	Existing & Demolition Roof Plan
DA_010	Proposed Second Floor Plan
DA_001	Proposed Attic Floor Plan
DA_012	Proposed Roof & Stormwater Management Plan
DA_013	Proposed Front (SW) Elevation
DA_014	Existing Rear (NE) Elevation
DA_015	Proposed Side (NW) Elevation
DA_016	Proposed Side (SE) Elevation
DA_017	Proposed Section AA
DA_018	Construction Waste & Site Management Plan
	Erosion, Sediment Control Plan
DA_019	Shadow Diagrams June 21 - 9am, 12pm & 3pm
DA_020	Proposed Attic Floor Reflected Ceiling Plan
DA_021	View Loss Study
DA_022	GFA Calculations



RECEIVED Waverley Council

Application No: DA-161/2023

Date Received: 24/08/2023

iSA DESIGNS

Alon Musael

DA 023

Postal Address

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Notification Plan

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15 / 7 Francis Street Bondi Beach NSW 2026 FOR CONSTRUCTION

PROJECT:

SP. 71516 Lot 15

CLIENT:

50 Pauling Avenue Coogee NSW 2034

Drawing Name: Cover Page

Jolon Cooke

Project No:

Drawing No:

DA_221203 Scale: DA_000

Drawn:

Issue:

Sent: 15.03.2023

Date: 03.12.2022

Revision: D

Preliminaries & Schematic Design **Client Review** Pre DA Meeting - Council Review **DA Submission - Council Review**

Revision Description:

Page 352 of 500

AMENDED

LEGEND:

BAL **Balustrade to BCA requirements**

CBD Cupboard

CF Concrete floor, to be polished and sealed

CP Concrete pavers

СТ Ceramic tiles

FCC Fibre cement cladding, matt paint finish

FD Fire door

Gutter

HR Handrail to BCA requirements

J Joinery

LB Letter box

MSC Metal sheet cladding

MSR Metal sheet roof

OG Obscure glazing

Parapet

RB Rendered brickwork

RWT Rainwater tank, to Hydraulic engineer details

Smoke alarm to BCA requirements SA

TC Timber cladding

TF **Timber flooring**

TG Timber gate

TW New window/door system, finish TBA

NB R3 Insulation to ceiling

Foil Insulation to underside of roof R1 Insulation to exterior walls

Existing wall to be demolished

Existing wall to be retained

New wall

GENERAL NOTES:

- All demolition works are to be carried out in accordance with AS2601-2001 Demolition of Structures.
- No demolition / Building works are to be carried out in accordance with
- Existing common wall to be weatherproofed.
- All separating walls to achieve a minimum FRL of 60/60/60 and to extend to the underside of the proposed roof covering in accordance with BCA standards.
- All smoke alarms are to be installed in nominated locations in accordance with Clause 3.7.2.3 of the BCA and AS3786-2014.
- All bedroom windows to the first floor level will be capable of being restricted to a
- External stairs to achieve a slip resistance classification of not less than P4 in accordance with AS 4586-2013.
- All balustrades to have a minimum height not less than 1m and to comply with the relevant provisions of AS/NZS 1170.1-2002 and AS 1288-2006.
- A handrail must be installed to at least one side of the new staircase, extending for the
- All floor wastes being provided to be with drainage flanges in accordance with AS 3740-
- All doorways located within 1.2 metres of the toilet to be either outward swinging, sliding doors, or that the doors will consist of removable hinges.
- The design alignment levels at the property boundary for driveways, access ramps and pathways (or the like) are to match the back of the existing Council footpath levels along the full site frontage.
- All BASIX commitments to be achieved as referenced on the BASIX Certificate.

SCHEDULE OF FINISHES:

- Timber cladding To be constructed from TC selected hardwood and clear sealed.
- TR Tiled roof (New) to match the existing tiled roof finish of the main building
- New window/door system, to be aluminium framed powdercoat finish to suit all BASIX Certificate provisions. Selected colour finish - Woodland Grey.



Woodland Grey®

BASIX COMMITMENTS:

- A minimum of 40% of new or altered light fixtures will be fitted with fluoroecent, compact fluoroescent, or light-emitting diode

- Suspended floor with enclosed subfloor framed: (R0.7) - R0.6 (down) (or R1.30 including construction).

Raked Ceiling, pitched / skillion roof: framed - Ceiling R1.76 (up), Roof: foil / sarking. Light (solar absorptance <0.475)

- External wall: framed (weatherboard, fibre, metal clad) - internal to achieve R1.30 (or R1.70 including construction)

Fixtures & Systems:

Insulation requirements:



Selected Hardwood - Tallowood

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Waverley Council

Application No: DA-161/2023

Date Received: 24/08/2023

iSA DESIGNS

Alon Musael

Postal Address Mobile Email

PO Box 403 Rose Bay NSW 2029 +61 451 867 426 alon@isadesigns.com.au

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FOR CONSTRUCTION

SP. 71516 Lot 15

15 / 7 Francis Street Bondi Beach NSW 2026 **CLIENT: Jolon Cooke**

50 Pauling Avenue Coogee NSW 2034


Date: 03.12.2022 **Drawing Name: Revision Description:** Preliminaries & Schematic Design Legend, General Notes & Regulatory Provisions **Sent:** 15.03.2023 **Client Review** Pre DA Meeting - Council Review Project No: DA_221203 Scale: Issue: **DA Submission - Council Review** AMDA_001 Revision: D **Drawing No:** Drawn:

AMENDED **PLANS**

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PROJECT:

Alterations & Additions

SP. 71516 Lot 15

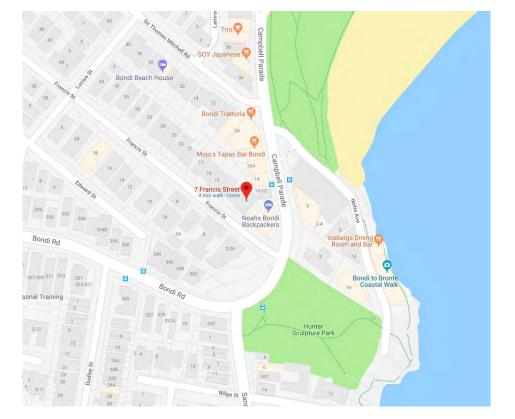FOR CONSTRUCTION 15/7 Francis Street Bondi Beach NSW 2026

CLIENT: Jolon Cooke

50 Pauling Avenue Coogee NSW 2034


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Drawing Name:		Date: 03.12.2022	Revision Description:
Location & Context Details		0 4 45 00 0000	Preliminaries & Schematic Design
Location & Context Details		Sent: 15.03.2023	Client Review
D 4 N	01		Pre DA Meeting - Council Review
Project No: DA_221203	Scale:	Issue: 5	DA Submission - Council Review
DA 002	D AM	D	
Drawing No: DA_002	Drawn: AM	Revision: D	

AMENDED PLANS

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Application No: DA-161/2023

Date Received: 24/08/2023

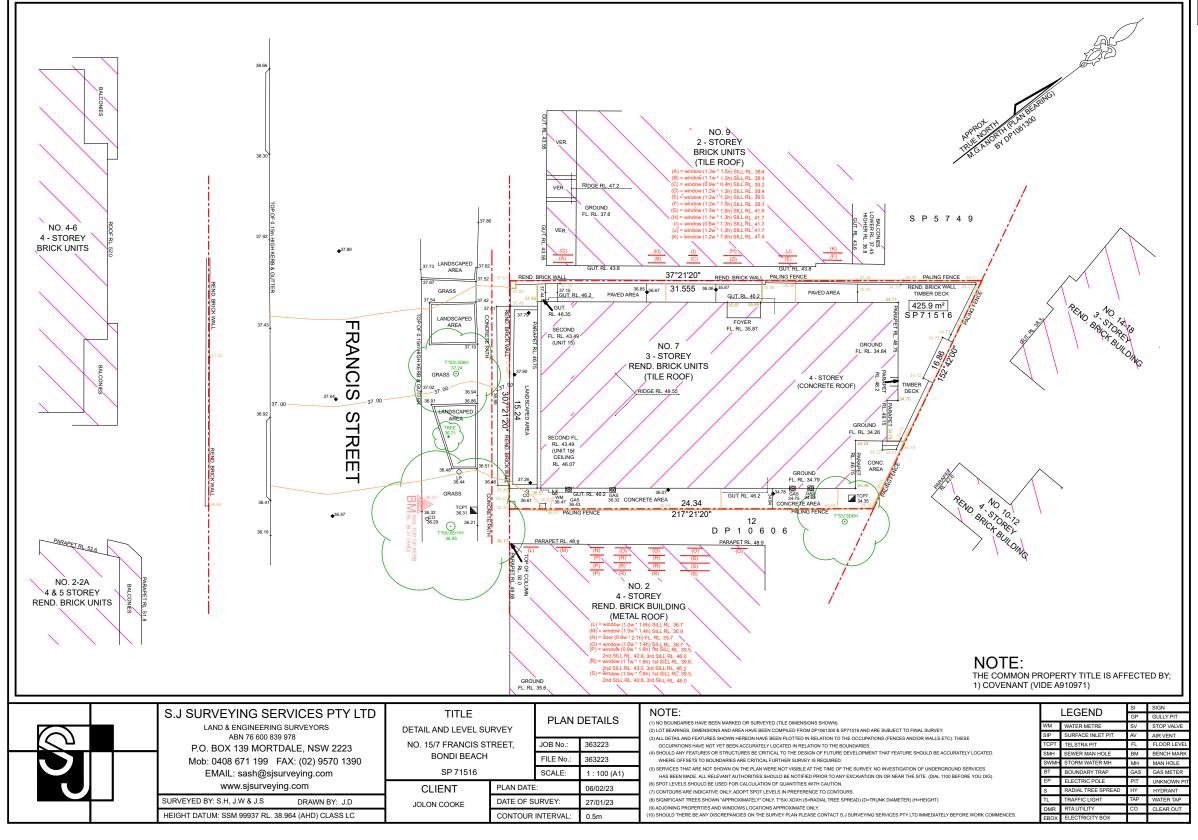

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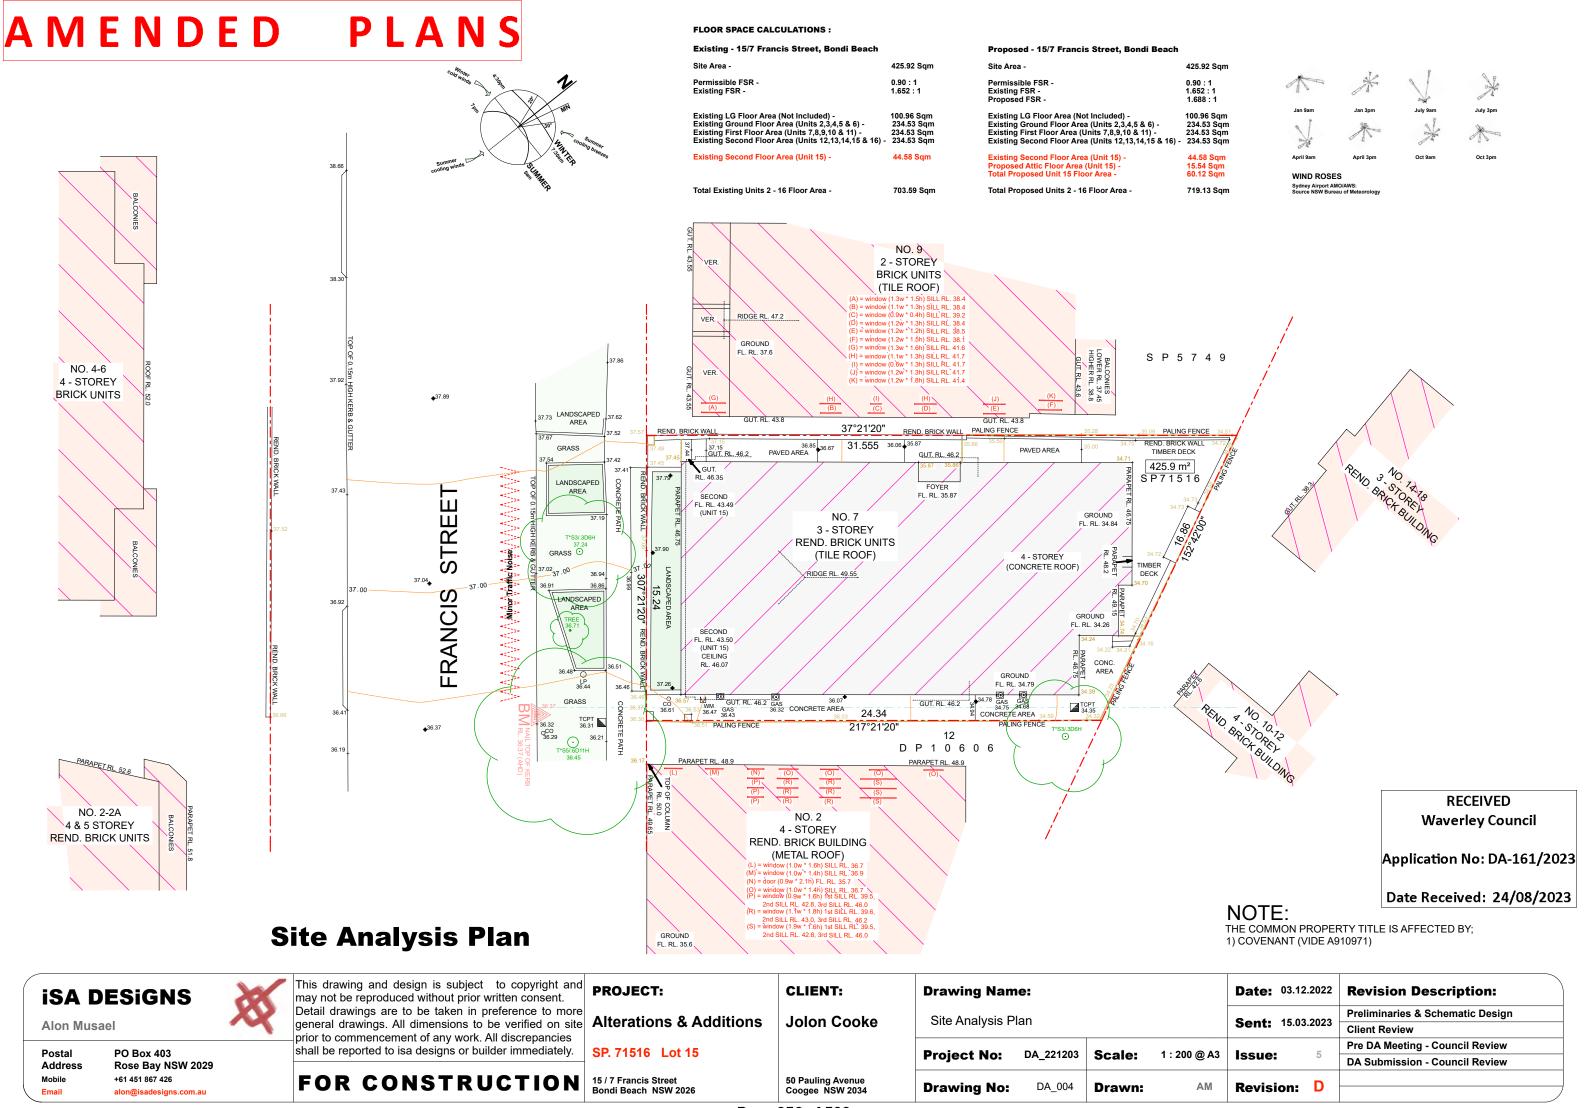
SP. 71516 Lot 15 15 / 7 Francis Street Bondi Beach NSW 2026


CLIENT: Jolon Cooke


50 Pauling Avenue Coogee NSW 2034


Drawing Name: Survey Plan Project No: DA_221203 Scale: DA_003 **Drawing No:** Drawn:


Date: 03.12.2022 **Revision Description:** Preliminaries & Schematic Design **Sent:** 15.03.2023 **Client Review** Pre DA Meeting - Council Review 1 : 250 @ A3 Issue: **DA Submission - Council Review** Revision: D




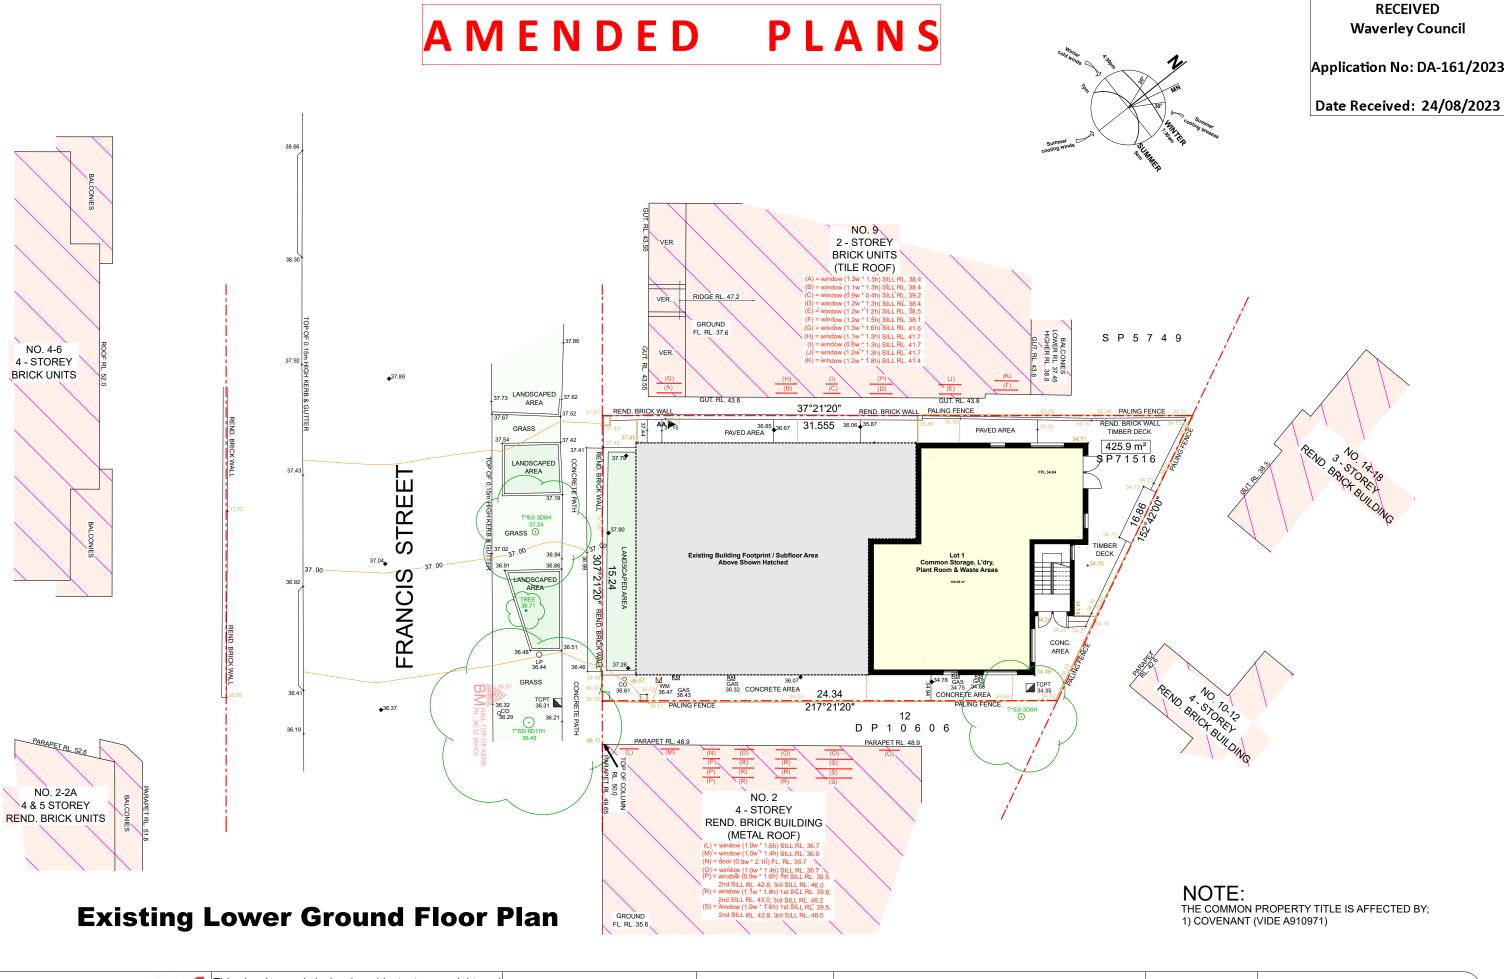


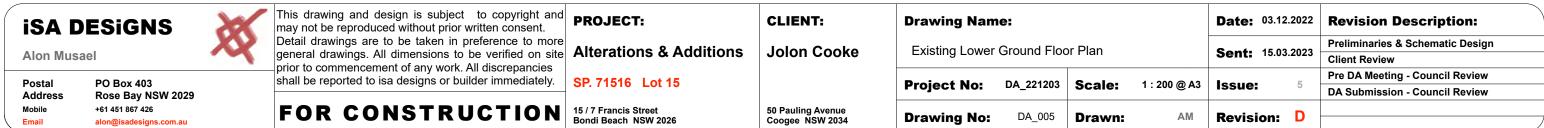


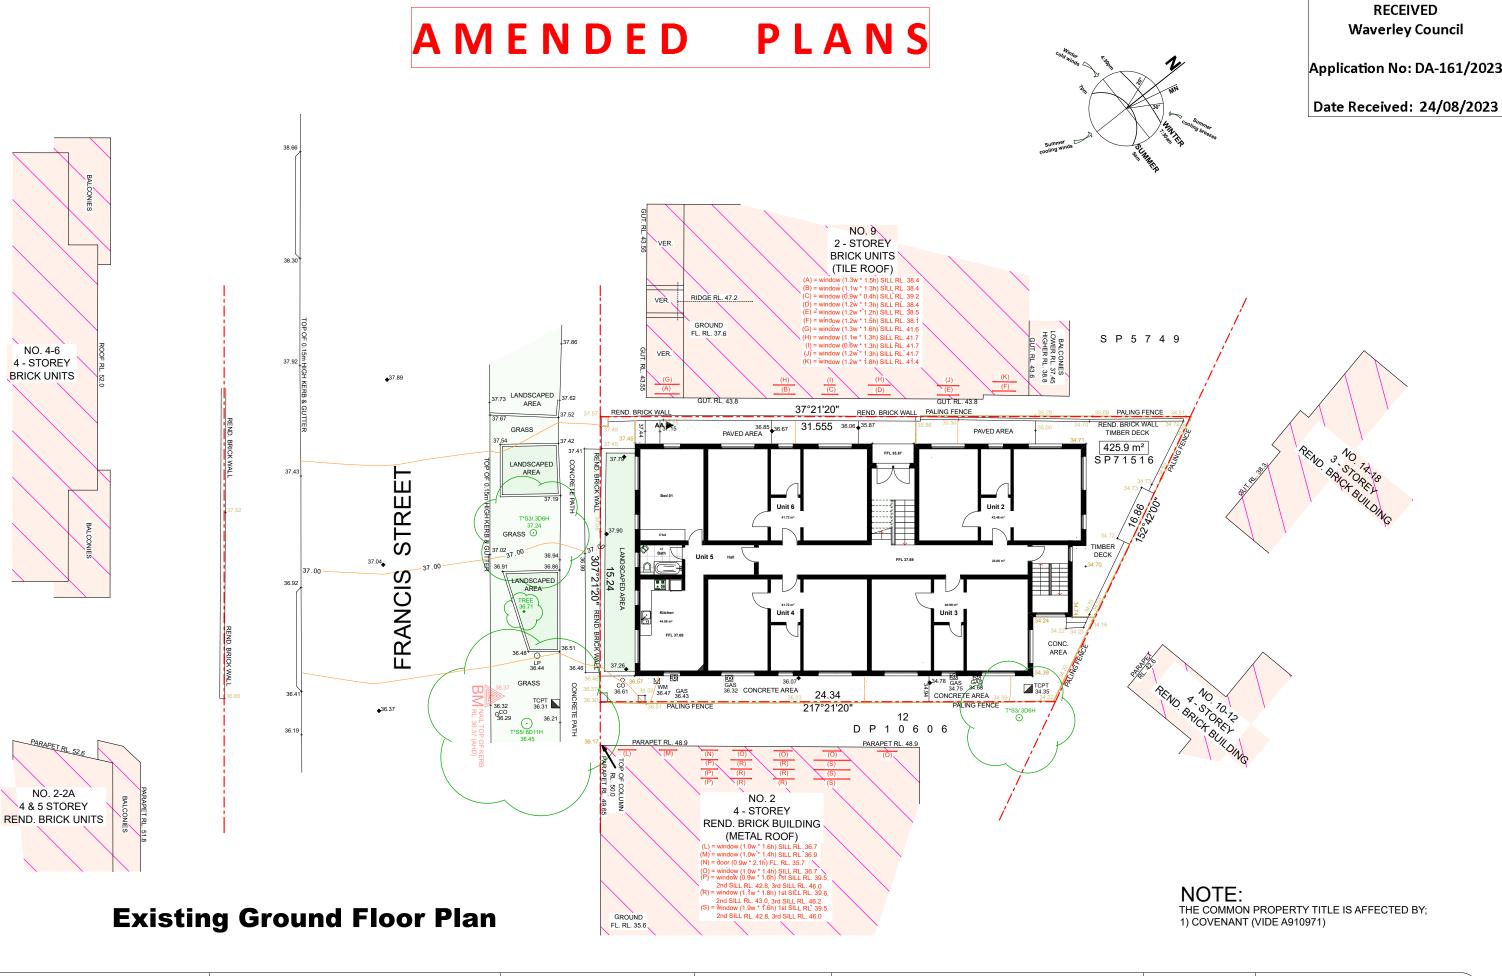


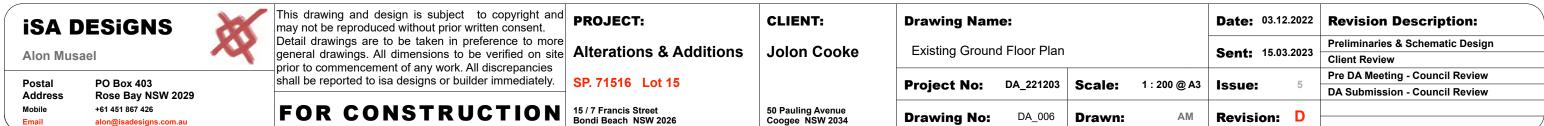

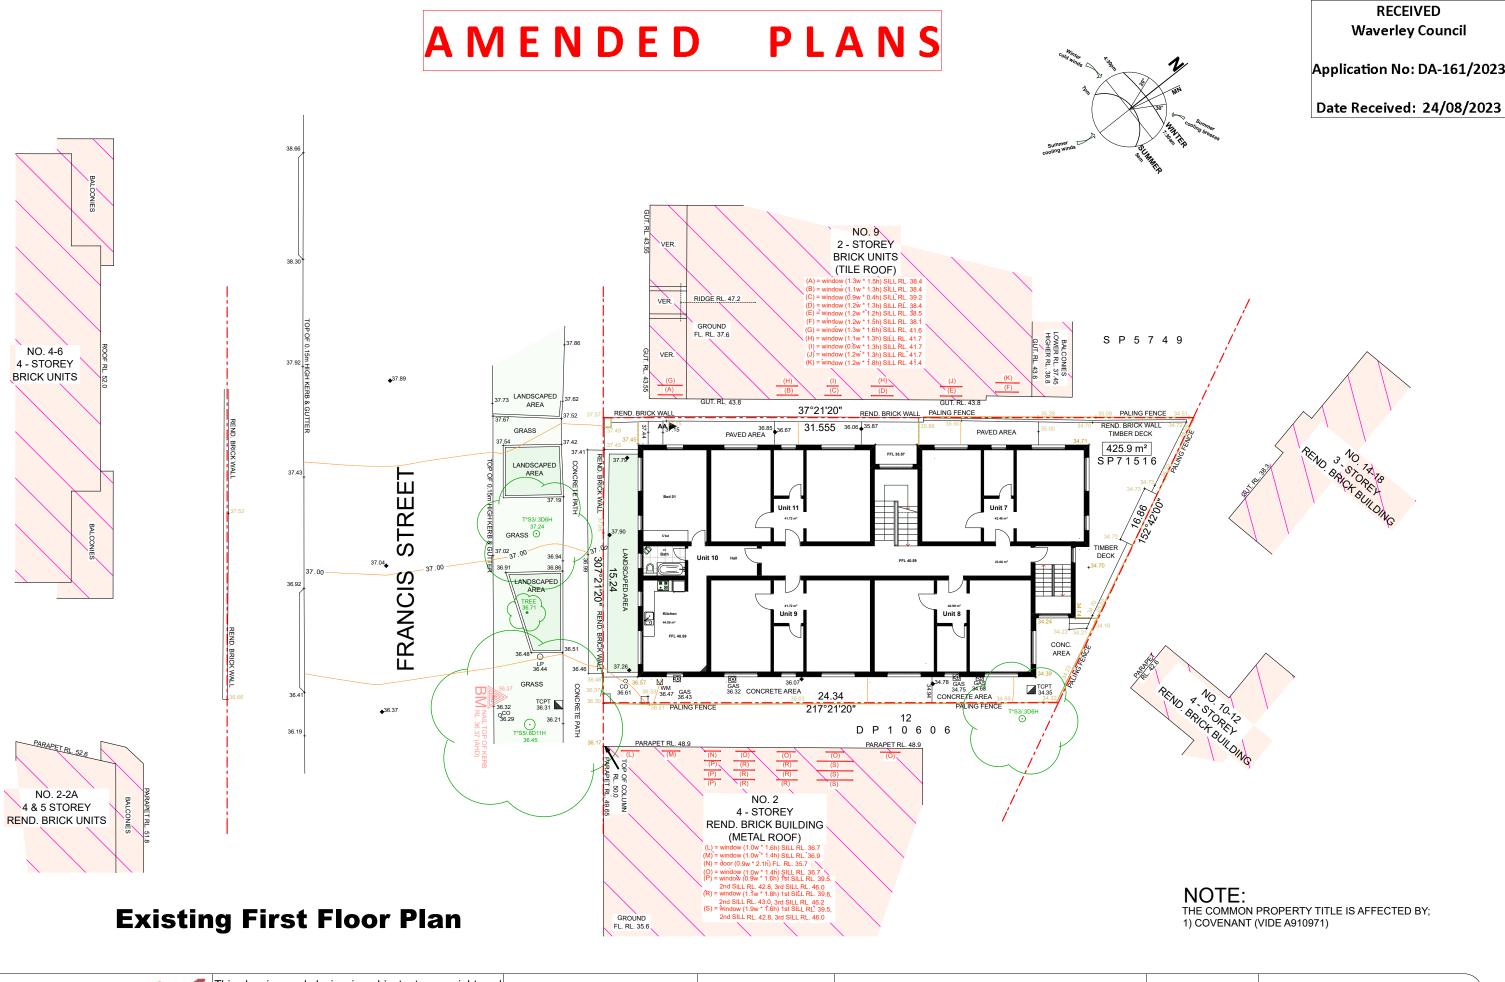

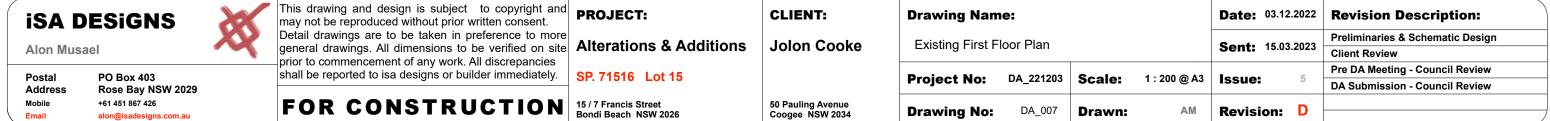

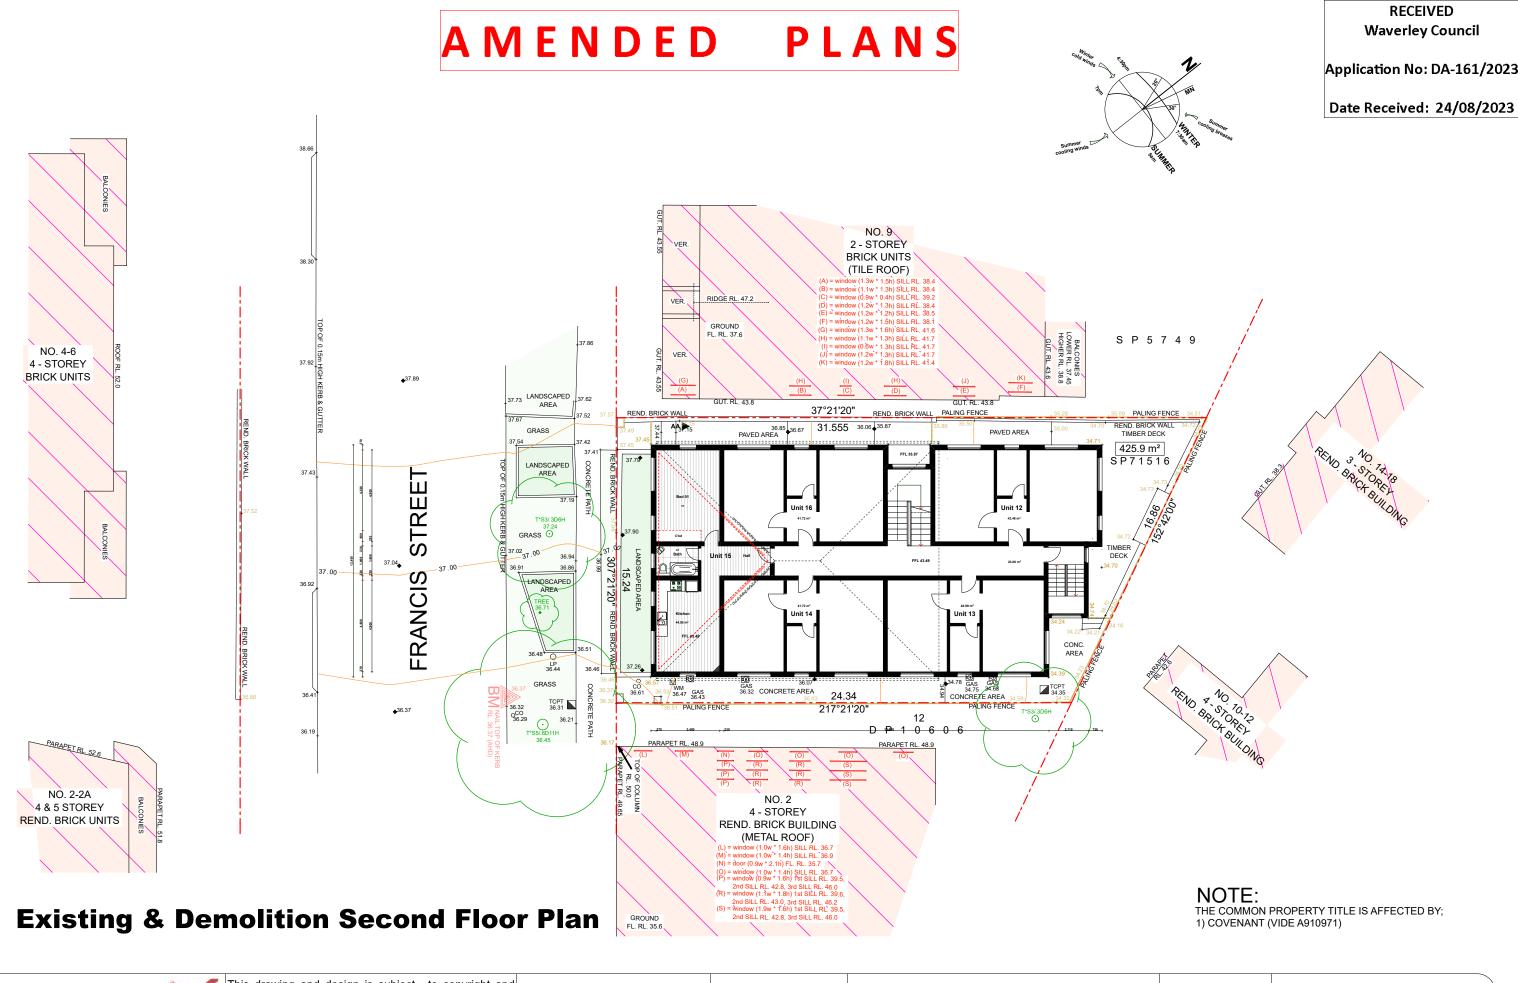

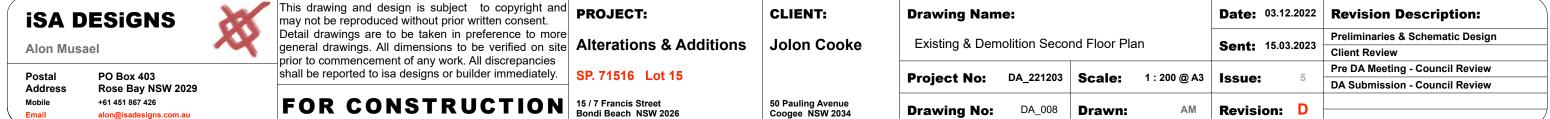

AMENDED **PLANS** BASIX COMMITMENTS: Fixtures & Systems: Application No: DA-161/2023 A minimum of 40% of new or altered light fixtures will be fitted with fluoroecent, compact fluoroescent, or light-emitting diode (LED) lamps Date Received: 24/08/2023 Suspended floor with enclosed subfloor framed: (R0.7) - R0.6 (down) (or R1.30 including construction). Raked Ceiling, pitched / skillion roof: framed - Ceiling R1.76 (up), Roof foil / sarking. Light (solar absorptance <0.475) NO. 9 2 - STOREY **BRICK UNITS** (TILE ROOF) RIDGE RL. 47.2 VER. C) = window (0.9w * 0.4h) SILL RL. 39.2 D) = window (1.2w * 1.3h) SILL RL. 38.4 E) = window (1.2w * 1.2h) SILL RL. 38.5 F) = window (1.2w * 1.5h) SILL RL. 38.1 G) = window (1.3w * 1.6h) SILL RL. 41.7 H) = window (1.1w * 1.3h) SILL RL. 41.7 (I) = window (0.8w * 1.3h) SILL RL. 41.7 J) = window (1.2w * 1.3h) SILL RL. 41.7 W = window (1.2w * 1.3h) SILL RL. 41.7 L. RL. 37.6 S P 5 7 4 9 NO. 4-6 VER. 4 - STOREY BRICK UNITS 17.73 LANDSCAPED GUT. RL. 43.8 37°21'20" PALING FENCE REND. BRICK WAL REND. BRICK WALL 36.85 36.67 31.555 36.06 35.87 PAVED AREA REND 3 NO. 14 TO BRICK BUILDING 425.9 m² LANDSCAPED AREA STREE⁻ GRASS ① TIMBER DECK LANDSCAPED AREA **FRANCI** CONC. AREA LP 36.44 GRASS 3 MM GAS 36.47 GAS 36.43 TCPT 34.35 GAS 36.32 CONCRETE AREA 24.34 TCPT 36.31 36.32 QCO 36.29 217°21'20' **♦**36.37 9 O D P 19490 6 0 6 PARAPET RL. 48.9 NO. 2-2A 4 & 5 STOREY 4 - STOREY REND. BRICK UNITS REND. BRICK BUILDING (METAL ROOF)) = window (1.0w * 1.6h) SILL RL. 36.7) = window (1.0w * 1.4h) SILL RL. 36.9 = door (0.9w * 2.1h) FL. RL. 35.7) = window (1.0w * 1.4h) SILL RL. 36.7 = window (0.9w * 1.6h) 1st SILL RL. 39.5 NOTE: THE COMMON PROPERTY TITLE IS AFFECTED BY; **Proposed Second Floor Plan** GROUND FL. RL. 35.6 1) COVENANT (VIDE A910971) This drawing and design is subject to copyright and PROJECT: **CLIENT:** Date: 03.12.2022 **Drawing Name: Revision Description: iSA DESIGNS** may not be reproduced without prior written consent. Detail drawings are to be taken in preference to more Preliminaries & Schematic Design general drawings. All dimensions to be verified on site Alterations & Additions **Jolon Cooke** Proposed Second Floor Plan **Sent:** 15.03.2023 **Alon Musael Client Review** prior to commencement of any work. All discrepancies shall be reported to isa designs or builder immediately.

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Pre DA Meeting - Council Review

DA Submission - Council Review

50 Pauling Avenue Coogee NSW 2034

Project No:

Drawing No:

DA_221203

DA_010

Scale:

Drawn:

1:200 @ A3

Issue:

Revision: D

SP. 71516 Lot 15

15 / 7 Francis Street Bondi Beach NSW 2026

FOR CONSTRUCTION

PO Box 403

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Rose Bay NSW 2029

Postal

Mobile

Email

Address

MENDED **PLANS** BASIX COMMITMENTS: Fixtures & Systems: Application No: DA-161/2023 A minimum of 40% of new or altered light fixtures will be fitted with fluoroecent, compact fluoroescent, or light-emitting diode (LED) lamps Date Received: 24/08/2023 Suspended floor with enclosed subfloor framed: (R0.7) - R0.6 (down) (or R1.30 including construction). Raked Ceiling, pitched / skillion roof: framed - Ceiling R1.76 (up), Roof foil / sarking. Light (solar absorptance <0.475) NO. 9 2 - STOREY **BRICK UNITS** (TILE ROOF) RIDGE RL. 47.2 VER. 2) = window (1.9w * 0.4h) SILL RL. 39.2 5) = window (1.2w * 1.4) SILL RL. 38.5 5) = window (1.2w * 1.5h) SILL RL. 38.5 7) = window (1.2w * 1.5h) SILL RL. 38.1 8) = window (1.3w * 1.6h) SILL RL. 41.6 4) = window (1.1w * 1.3h) SILL RL. 41.7 1) = window (0.5w * 1.3h) SILL RL. 41.7 L. RL. 37.6 S P 5 7 4 9 NO. 4-6 VER. 4 - STOREY BRICK UNITS 37.73 LANDSCAPED AREA GUT, RL, 43.8 37°21'20" PALING FENCE REND. BRICK WAL REND. BRICK WALL 36.85 36.67 31.555 36.06 35.87 REND 3 NO. 14 TO BRICK BUILDING PAVED AREA 425.9 m² LANDSCAPED AREA STREE TIMBER DECK LANDSCAPED AREA **FRANCI** CONC. AREA LP 36.44 GRASS WM 36.47 GAS 36.43 GAS 36.32 CONCRETE AREA TCPT 34.35 24.34 TCPT 36.31 36.32 QCO 36.29 **♦**36.37 S5/6D1 D∞ P 1 0 6 0 6 PARAPET RL. 48.9 NO. 2-2A NO. 2 4 & 5 STOREY 4 - STOREY REND. BRICK UNITS REND. BRICK BUILDING (METAL ROOF)) = window (1.0w * 1.6h) SILL RL. 36.7) = window (1.0w * 1.4h) SILL RL. 36.9 = door (0.9w * 2.1h) FL. RL. 35.7) = window (1.0w * 1.4h) SILL RL. 36.7 = window (0.9w * 1.6h) 1st SILL RL. 39.5 NOTE: THE COMMON PROPERTY TITLE IS AFFECTED BY; **Proposed Attic Floor Plan** GROUND FL. RL. 35.6 1) COVENANT (VIDE A910971) This drawing and design is subject to copyright and PROJECT: **CLIENT:** Date: 03.12.2022 **Drawing Name: Revision Description: iSA DESIGNS** may not be reproduced without prior written consent. Detail drawings are to be taken in preference to more Preliminaries & Schematic Design general drawings. All dimensions to be verified on site Alterations & Additions **Jolon Cooke** Proposed Attic Floor Plan

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Sent: 15.03.2023

Revision: D

Issue:

1:200 @ A3

Client Review

Pre DA Meeting - Council Review

DA Submission - Council Review

50 Pauling Avenue Coogee NSW 2034

Project No:

Drawing No:

DA_221203

DA_011

Scale:

Drawn:

SP. 71516 Lot 15

15 / 7 Francis Street Bondi Beach NSW 2026

Alon Musael

Postal

Mobile

Email

Address


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50 Pauling Avenue Coogee NSW 2034

DA_012

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AMENDED **PLANS**

RECEIVED Waverley Council

Application No: DA-161/2023

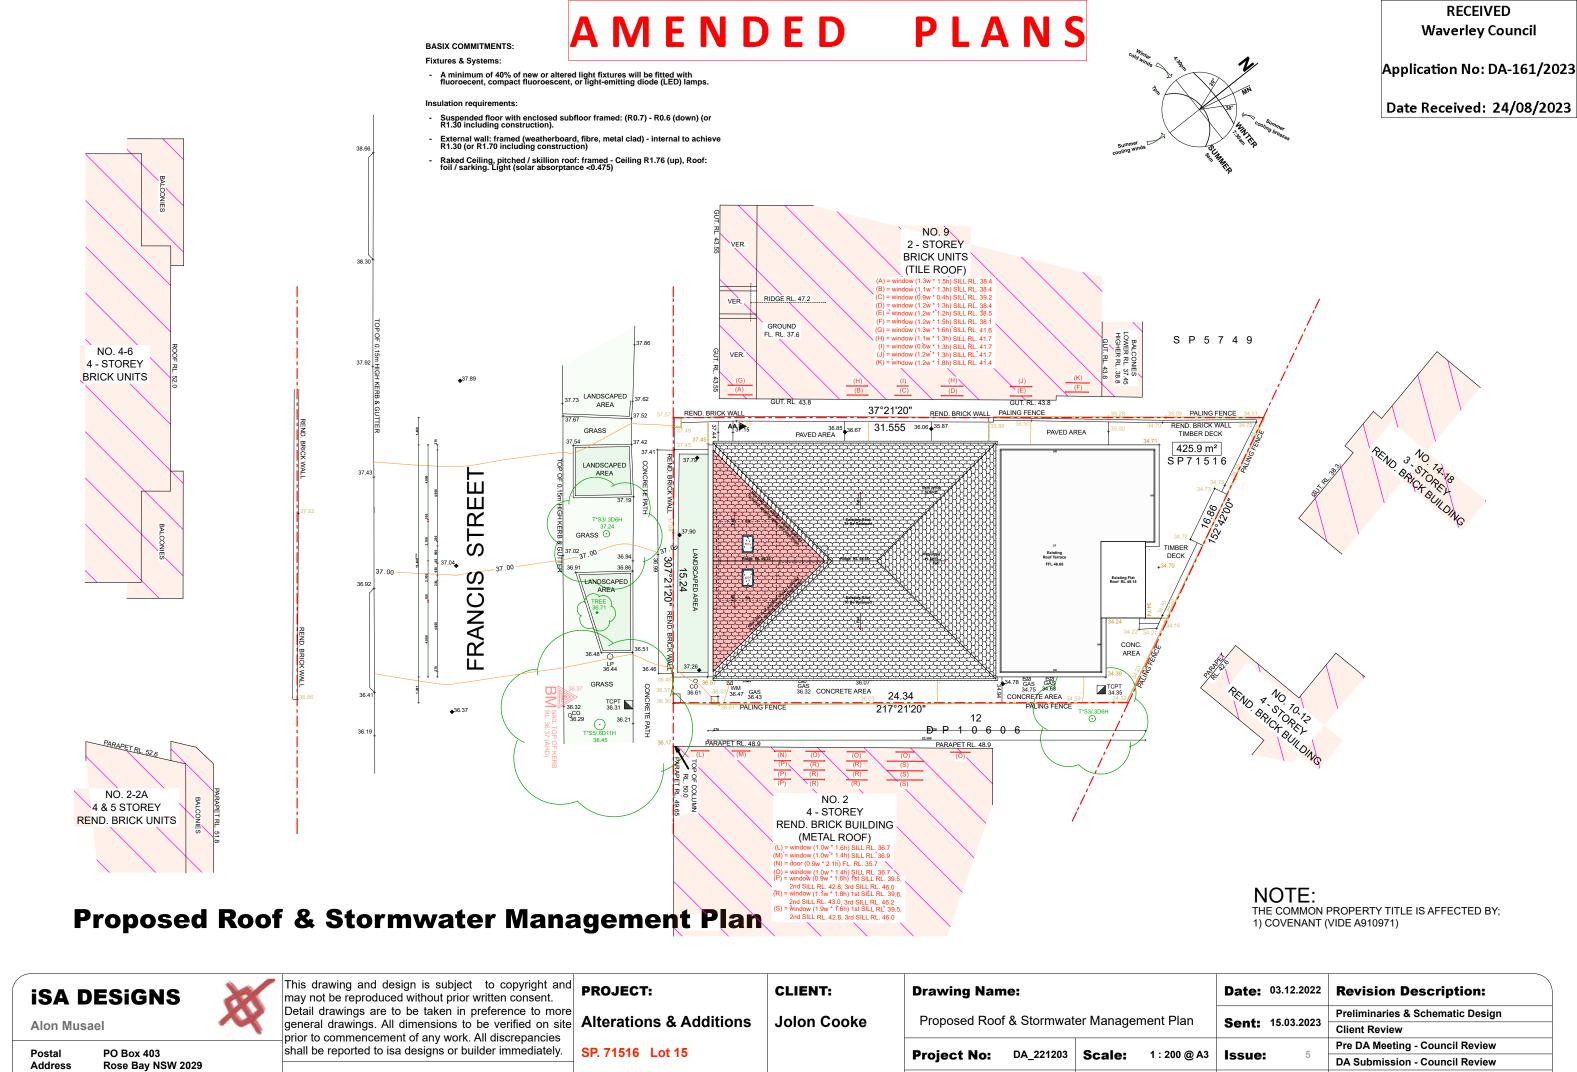Date Received: 24/08/2023

BASIX COMMITMENTS:

Fixtures & Systems





Alon Musael

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prior to commencement of any work. All discrepancies shall be reported to isa designs or builder immediately. FOR CONSTRUCTION

SP. 71516 Lot 15 15 / 7 Francis Street Bondi Beach NSW 2026

CLIENT: Jolon Cooke

50 Pauling Avenue Coogee NSW 2034

Drawing No:

Drawing Name: Proposed Front (SW) & Rear (NE) Elevations Project No: DA_221203

DA_013

Drawn:

Date: 03.12.2022 **Revision Description:** Preliminaries & Schematic Design

Sent: 15.03.2023 **Client Review** Pre DA Meeting - Council Review **Scale:** 1:100@A3 Issue: **DA Submission - Council Review**

Revision: D

AMENDED PLANS


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Application No: DA-161/2023

Date Received: 24/08/2023

BASIX COMMITMENTS:

Fixtures & Systems

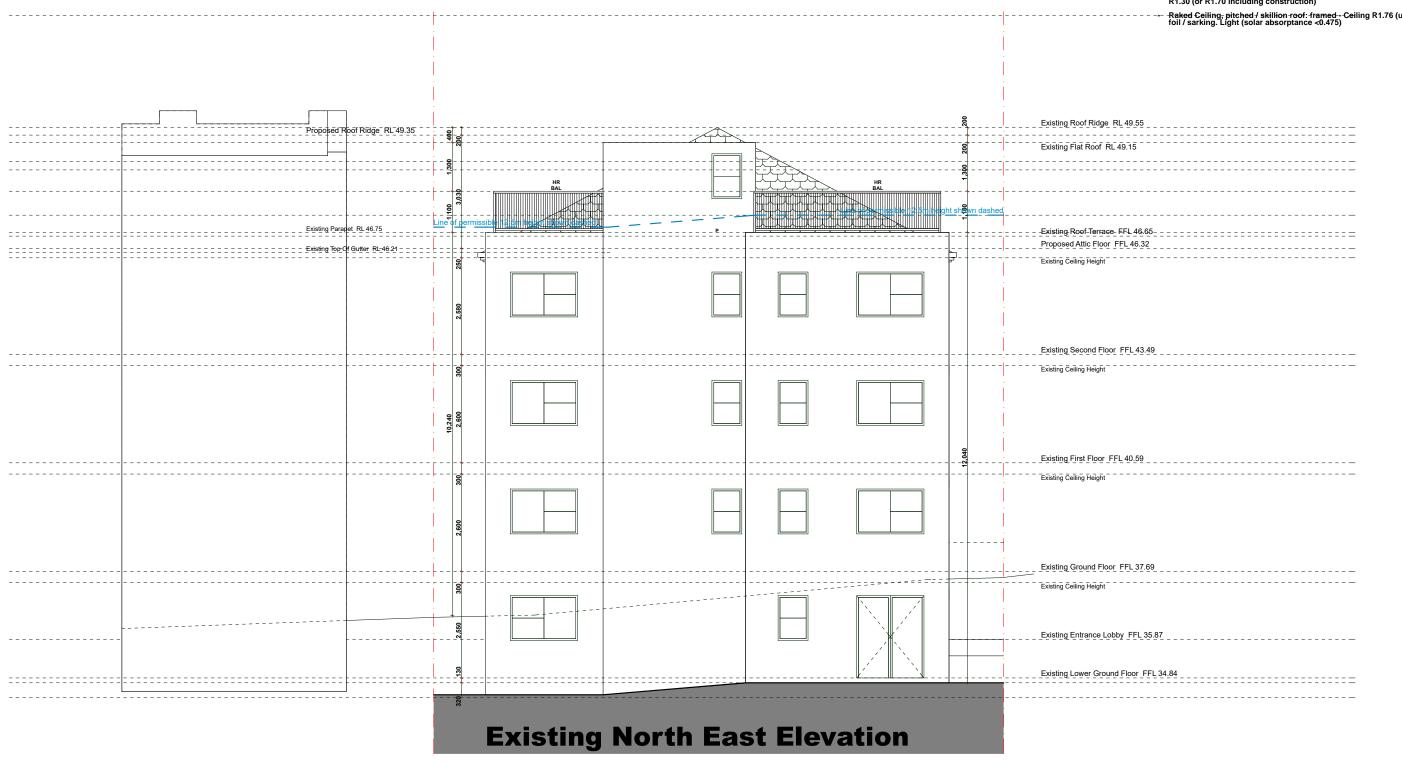

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Alterations & Additions prior to commencement of any work. All discrepancies shall be reported to isa designs or builder immediately.

FOR CONSTRUCTION

SP. 71516 Lot 15

15 / 7 Francis Street Bondi Beach NSW 2026

CLIENT: Jolon Cooke 50 Pauling Avenue Coogee NSW 2034

Drawing Name: Existing Rear (NE) Elevation Project No: DA_221203 Scale: 1:100 @ A3

Drawing No:

DA_014

Drawn:

Date: 03.12.2022 **Revision Description:** Preliminaries & Schematic Design **Sent:** 15.03.2023 **Client Review** Pre DA Meeting - Council Review Issue: **DA Submission - Council Review** Revision: D

AMENDED PLANS

RECEIVED Waverley Council

Application No: DA-161/2023

Date Received: 24/08/2023

BASIX COMMITMENTS:

Fixtures & Systems:

- Raked Geiling, pitched / skillion roof: framed foil / sarking. Light (solar absorptance < 0.475

iSA DESIGNS

Alon Musael

Postal Address Mobile

PO Box 403 Rose Bay NSW 2029 +61 451 867 426

Existing Roof Terrace -FFL 46.65

Existing Second Floor FFL 43.49

Existing Ground Floor FFL 37.69

Existing Entrance Lobby FFL 35.87

Existing Ceiling Height

Existing Ceiling Height

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FOR CONSTRUCTION

SP. 71516 Lot 15

15 / 7 Francis Street Bondi Beach NSW 2026

Jolon Cooke

CLIENT:

50 Pauling Avenue Coogee NSW 2034

Proposed North West Elevation

Drawing Name: Proposed Side (NW) Elevation

Project No: DA_221203 Scale: 1:100 @ A3

Date: 03.12.2022 **Revision Description:** Preliminaries & Schematic Design **Sent:** 15.03.2023

Client Review Pre DA Meeting - Council Review Issue: **DA Submission - Council Review** DA_015 Revision: D **Drawing No:** Drawn:

PLANS AMENDED

RECEIVED Waverley Council

Application No: DA-161/2023

Date Received: 24/08/2023


BASIX COMMITMENTS:

Fixtures & Systems:

- A minimum of 40% of new or altered light fixtures will be fitted with fluoroecent, compact fluoroescent, or light-emitting diode (LED) lamps.

Insulation requirements:

Suspended floor with enclosed subfloor framed: (R0.7) - R0.6 (down) (or R1.30 including construction).

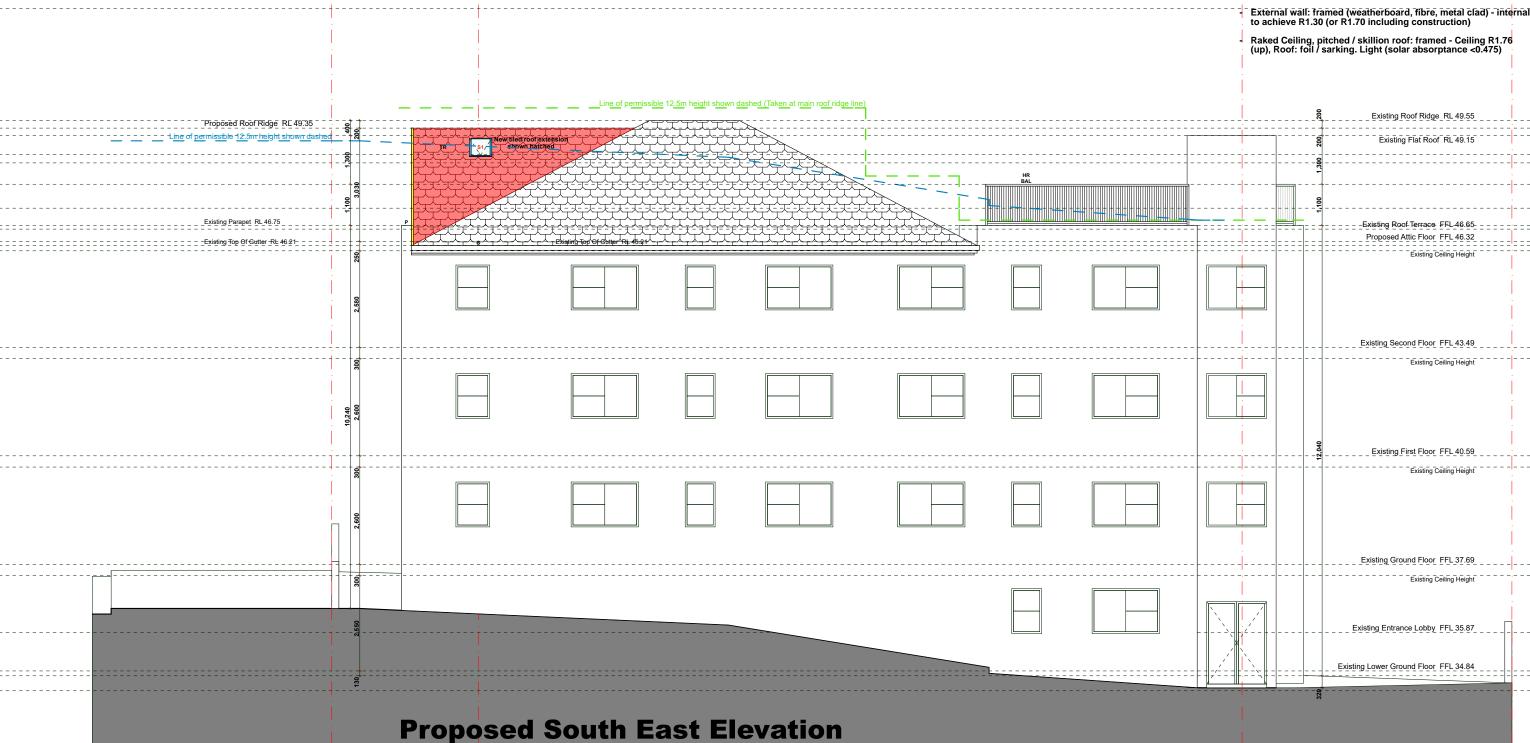

Alon Musael

Postal Address Mobile

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PROJECT: Detail drawings are to be taken in preference to more general drawings. All dimensions to be verified on site Alterations & Additions prior to commencement of any work. All discrepancies shall be reported to isa designs or builder immediately.

FOR CONSTRUCTION

SP. 71516 Lot 15

15 / 7 Francis Street Bondi Beach NSW 2026

CLIENT: Jolon Cooke

50 Pauling Avenue Coogee NSW 2034

Revision Description: Drawing Name: Date: 03.12.2022 Preliminaries & Schematic Design Proposed Side (SE) Elevation **Sent:** 15.03.2023 **Client Review** Pre DA Meeting - Council Review Project No: DA_221203 Scale: 1:100 @ A3 Issue: **DA Submission - Council Review** DA_016 Revision: D **Drawing No:** Drawn:

AMENDED **PLANS**


RECEIVED Waverley Council

Application No: DA-161/2023

Date Received: 24/08/2023

BASIX COMMITMENTS:

Fixtures & Systems:

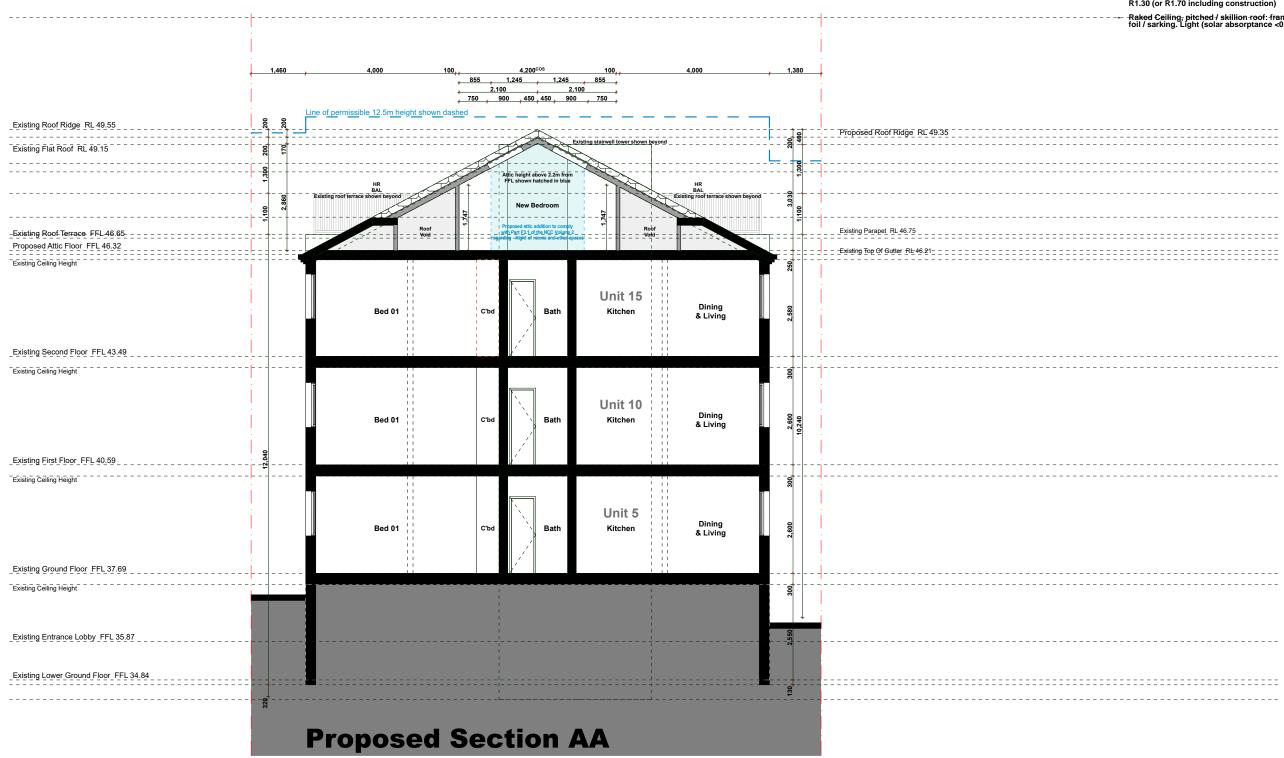

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Alterations & Additions

prior to commencement of any work. All discrepancies shall be reported to isa designs or builder immediately. FOR CONSTRUCTION

SP. 71516 Lot 15 15 / 7 Francis Street Bondi Beach NSW 2026

CLIENT: Jolon Cooke

50 Pauling Avenue Coogee NSW 2034

Drawing No:


Drawing Name: Proposed Section AA Project No: DA_221203 **Scale:** 1:100 @ A3 Issue:


Drawn:

DA_017

Date: 03.12.2022 **Revision Description:** Preliminaries & Schematic Design **Sent:** 15.03.2023 **Client Review** Pre DA Meeting - Council Review **DA Submission - Council Review**

Revision: D

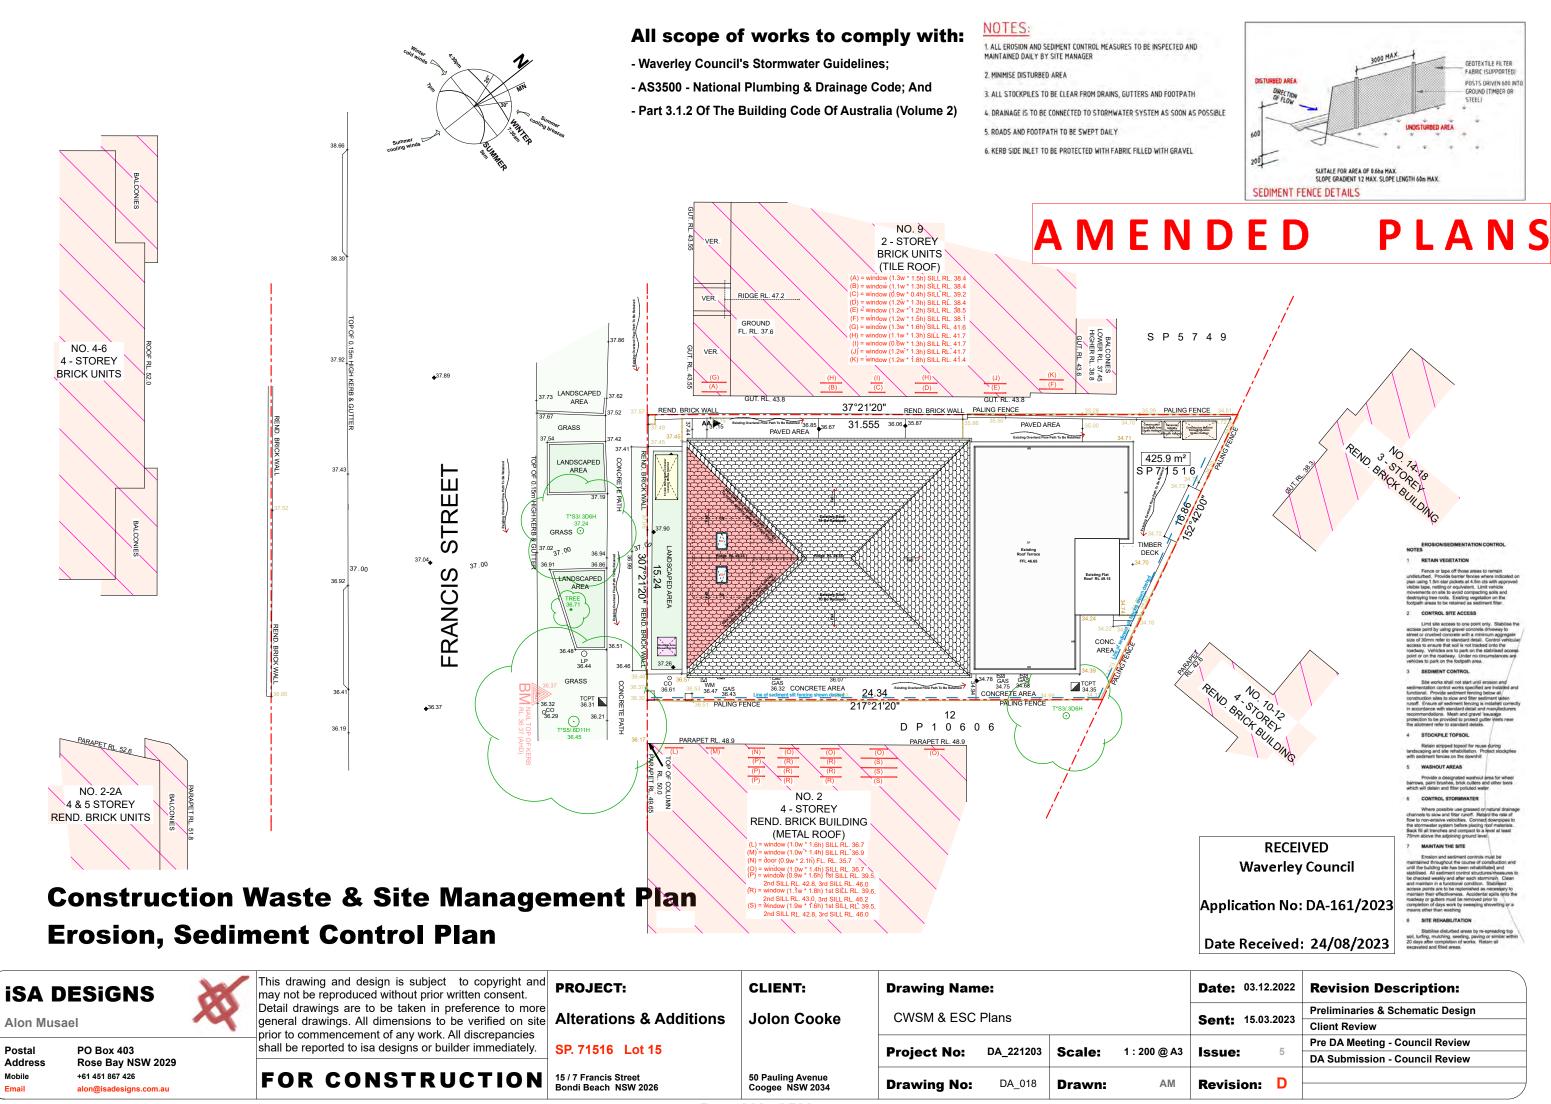

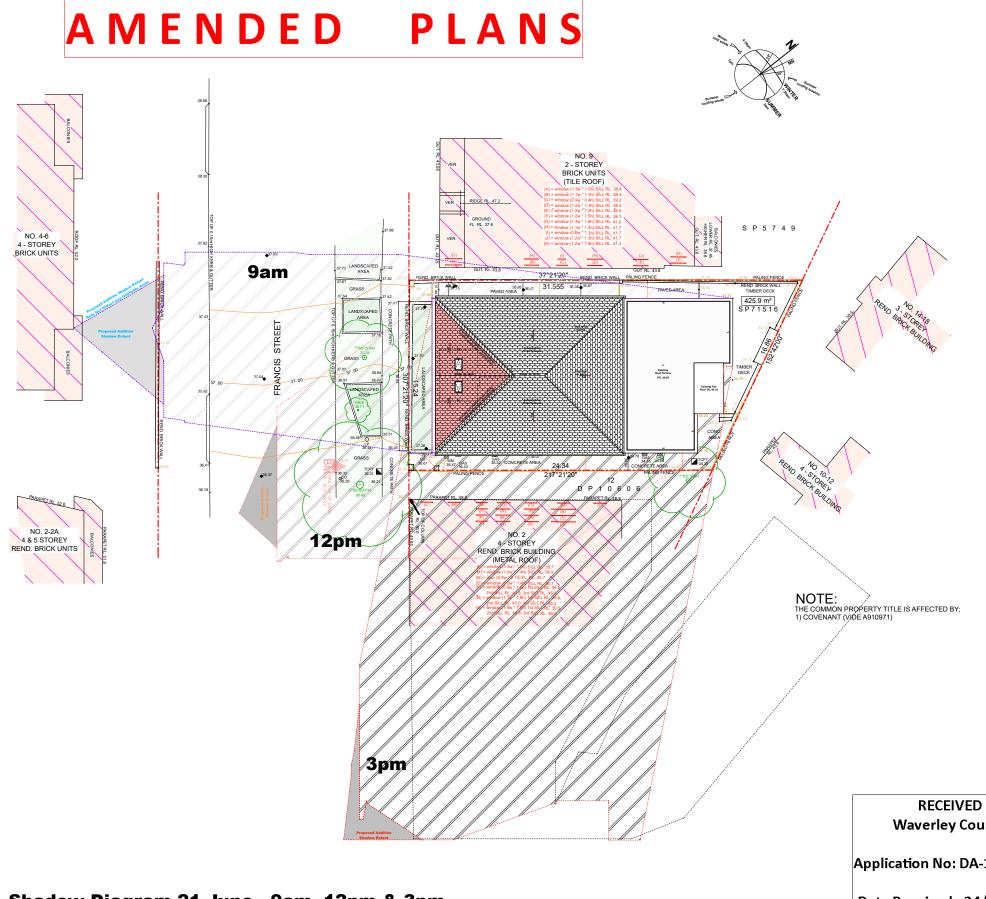





Waverley Council

Application No: DA-161/2023

Date Received: 24/08/2023

Drawing No:





Shadow Diagram 21 June - 9am, 12pm & 3pm

isa designs

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FOR CONSTRUCTION

SP. 71516 Lot 15

15 / 7 Francis Street Bondi Beach NSW 2026

CLIENT: Jolon Cooke 50 Pauling Avenue Coogee NSW 2034


Drawing Name: Shadow Diagrams June 21 - 9am, 12pm & 3pm **Project No:** DA_221203 **Scale:** 1:300 @ A3

DA_019

Drawn:

Date: 03.12.2022 **Sent:** 15.03.2023 Issue: Revision: D

Revision Description: Preliminaries & Schematic Design **Client Review** Pre DA Meeting - Council Review **DA Submission - Council Review**

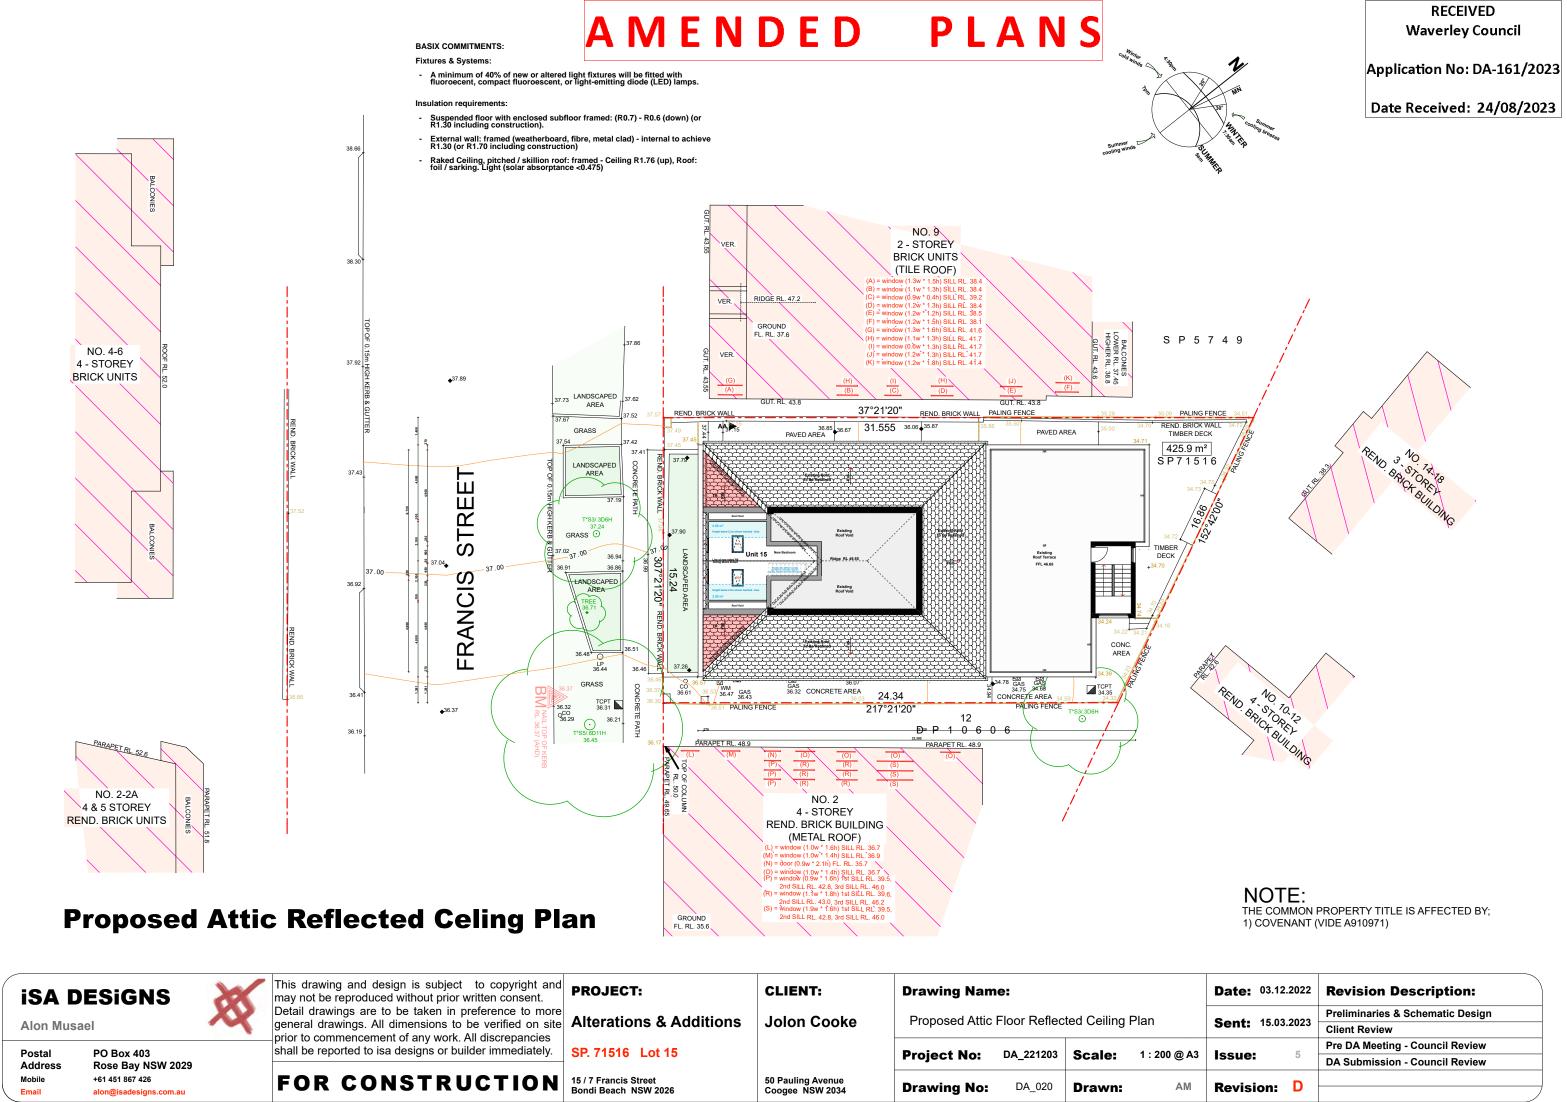



PLANS AMENDED


RECEIVED Waverley Council

Application No: DA-161/2023

Date Received: 24/08/2023

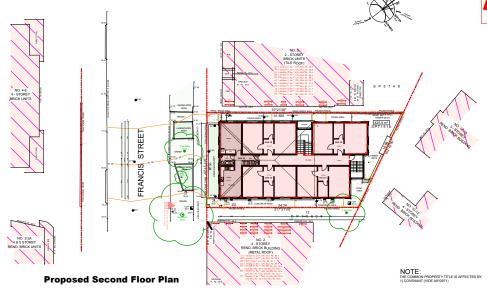

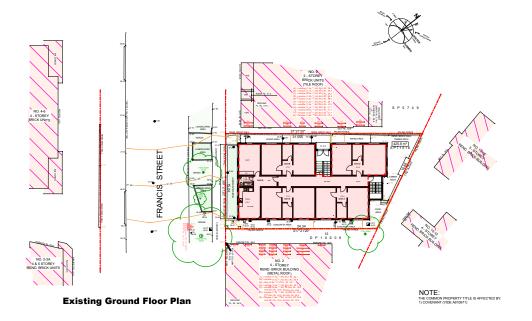

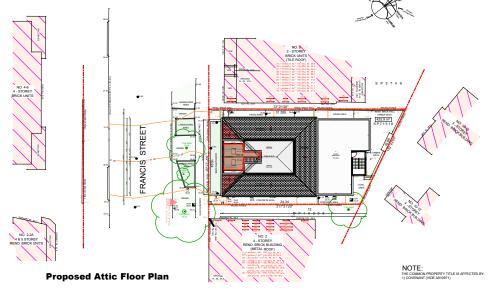

FLOOR SPACE CALCULATIONS:

Existing - 15/7	' Francis	Street,	Bondi	Beach	
-----------------	-----------	---------	-------	-------	--

425.92 Sqm Permissible FSR -Existing FSR -0.90 : 1 1.652 : 1

Existing LG Floor Area (Not Included) -Existing Ground Floor Area (Units 2,3,4,5 & 6) -Existing First Floor Area (Units 7,8,9,10 & 11) -Existing Second Floor Area (Units 12,13,14,15 & 16) -100.96 Sqm 234.53 Sqm 234.53 Sqm 234.53 Sqm

Existing Second Floor Area (Unit 15) -44.58 Sqm

Total Existing Units 2 - 16 Floor Area -703.59 Sqm

Proposed - 15/7 Francis Street, Bondi Beach

425.92 Sqm Permissible FSR -Existing FSR -Proposed FSR -0.90 : 1 1.652 : 1 1.688 : 1 Existing LG Floor Area (Not Included) -Existing Ground Floor Area (Units 2,3,4,5 & 6) -Existing First Floor Area (Units 7,8,9,10 & 11) -Existing Second Floor Area (Units 12,13,14,15 & 16) 100.96 Sqm 234.53 Sqm 234.53 Sqm

Existing Second Floor Area (Unit 15) -Proposed Attic Floor Area (Unit 15) -Total Proposed Unit 15 Floor Area -44.58 Sqm 15.54 Sqm 60.12 Sqm Total Proposed Units 2 - 16 Floor Area 719.13 Sqm

WIND ROSES

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Existing First Floor Plan

Existing Lower Ground Floor Plan

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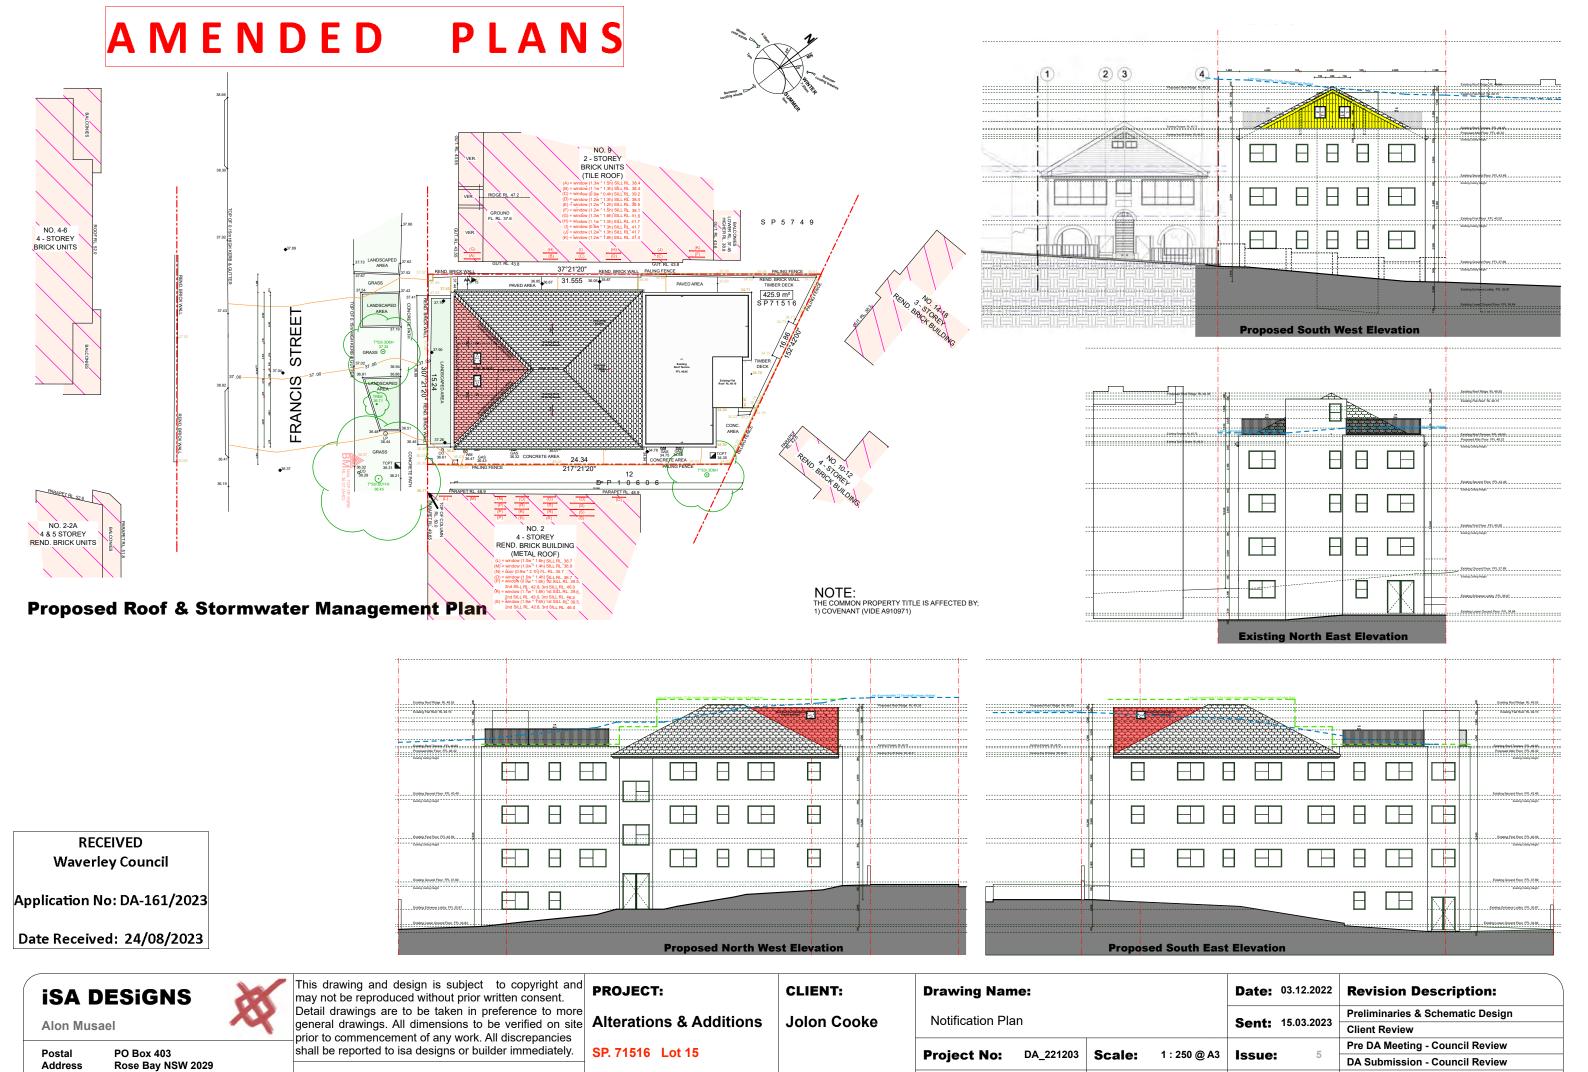
SP. 71516 Lot 15

15 / 7 Francis Street Bondi Beach NSW 2026

CLIENT: Jolon Cooke

50 Pauling Avenue Coogee NSW 2034

	Drawing Nam	e:			Date: 03.12.202	Revision Description:
	GFA Calculations				• 4 4	Preliminaries & Schematic Design
GFA Calculations				Sent: 15.03.2023	Client Review	
	Project No:	DA_221203	Scale:	1 : 500 @ A3 Issu	242	Pre DA Meeting - Council Review
					1:500 @ A3	Issue: 5
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	Drawing No:	DA_022	Drawn:	Alvi	Revision: D	



50 Pauling Avenue Coogee NSW 2034

DA_023

Drawn:

Drawing No:

Revision: D

15 / 7 Francis Street Bondi Beach NSW 2026

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Mobile

FOR CONSTRUCTION





Report to the Waverley Local Planning Panel

Application number	DA-367/2022		
Site address	56 Campbell Pde, Bondi Beach		
Proposal	Substantial demolition with retention of the front façade and a portion of the side walls and construction of a shop-top housing building containing four units with retail below and a basement. The proposal is Integrated development for Water NSW.		
Date of lodgement	2 September 2022		
Owner	Proprietors of Strata Plan 30493		
Applicant	Rob Deutsch		
Submissions	Six		
Cost of works	\$5,036,960		
Principal Issues	 Breach to building height Appropriateness of fourth floor (level 5) 		
Recommendation	That the application be APPROVED.		

SITE MAP



1. PREAMBLE

1.1. Executive Summary

The development application (DA) seeks consent for Integrated development for Water NSW for retention to the front of the existing building, substantial demolition and construction of a shop-top housing building containing four units, retail and basement car parking at the site known as 56 Campbell Parade, Bondi Beach.

The principal issues arising from the assessment of the application are as follows:

- · Breach to building height; an
- Appropriateness of fourth floor (level 5).

The assessment finds these issues acceptable. The breach to building height is considered acceptable as a well-founded Clause 4.6 Variation has been provided with the application, which demonstrates that despite the breach to the height standard, the development meets both the height and zone objectives within the Waverley Local Environmental Plan 2012 (Waverley LEP 2012).

A total number of six submissions were received and the issues raised in the submissions have been considered and addressed in this report and in the recommendation.

The application has been assessed against the relevant matters for consideration under section 4.15(1) of the *Environmental Planning and Assessment Act 1979*. It is recommended for approval subject to conditions of consent. In addition, Water NSW has provided General Terms of Approval.

1.2. Site and Surrounding Locality

A site visit was carried out on 31 October 2022.

The site is identified as SP30493, known as 56 Campbell Parade, North Bondi.

The site is rectangular in shape with an eastern frontage to Campbell Parade, measuring 10.975m. It has an area of 367.9m² and falls from the south-east to the north-west by approximately 2.09m. The site is occupied by a part-two, part-three storey mixed use building with vehicle access provided from Lamrock Place at the rear of the site to a hard stand and garages.

The site is adjoined by a part-four, part five storey residential flat building to either side. The locality is characterised by a variety of medium density mixed use development. With Bondi Beach and park located across Campbell Parade to the east. **Figures 1** to **3** are photos of the site and its context.



Figure 1. Campbell Parade streetscape, looking west.



Figure 2. Front of the subject site, looking west from Campbell Parade.



Figure 3. Rear of the subject site, looking east from Lamrock Place.

1.3. Relevant Development History

A search of Council's records revealed the following recent and relevant development history of the site:

- BA-297/1996 for the construction of alterations and additions to an existing shop front was approved on 14 August 1996.
- BA-762/1997 for an internal shop fit-out to an existing restaurant was approved on 22 October 1997.
- BA-830/1997 to install a retractable awning to the front of the shop was approved on 13 November 1997.

Adjoining development background:

It is also worth noting that the adjoining site, at 58 Campbell Parade has also recently sought consent for the substantial demolition (retention of a portion of the boundary walls and facade) and alterations and additions to the existing residential flat building including the construction of a basement and associated site and landscaping works, under DA-246/2022 (LEC No. 2022/00228308). Given the extent of works for demolition, the proposal was effectively considered a new building. This DA was filed with the Land and Environment Court as a deemed refusal appeal.

Following amendments to the proposal, an agreement was reached (s34 Agreement) and Judgement made on 2 June 2023. The approved development is a 5 level residential flat building, with a maximum height of 17.55m at the rear roof parapet and 15.81m to the top of the lift overrun.

1.4. Proposal

The DA seeks consent for Integrated development for Water NSW for retention to the front of the existing building, substantial demolition and construction of a shop-top housing building containing retail space (over 3 split levels) and four residential units above with basement car parking, specifically the following:

Demolition

• Demolition of the majority of the existing building with the retention to the front façade and the front portion of the side walls.

Construction

Basement

- Car stackers (accommodating seven vehicle spaces) with associated vehicle turntable and ramp access; two x motorcycle parking spaces; lift access; fire stairs; residential storage; and plant rooms.

Lower Ground (access to Lamrock Place)

- Vehicle access from Lamrock Place to the basement; fire stairs; residential and retail waste storage; plant room; lift access; retail space (connected to retail at ground floor above); and four x bicycle parking spaces.

Ground Floor

- Retail space (fronting Campbell Parade) with accessible bathroom; fire stairs; and lift access.
- **Apartment 1** is located to the rear of the retail unit and located a level above Lamrock Place. It consists of open plan living kitchen and dining; laundry; two x bedrooms, one with ensuite; bathroom and 15m² terrace facing Lamrock Place.

• First & Second Floors

- Fire stairs and lift access.
- **Apartments 2** and **3** are two storey units linked by internal stairs and each consist of four x bedrooms, all with ensuites; laundry; open plan living, kitchen and dining room with a 9.5m² balcony.

• Third Floor & Fourth Floors

- **Apartment 4** is a two storey unit linked by an internal stair and consists of, on the third floor, open plan living, kitchen and dining room; two x bedrooms; bathroom and 20m² terrace fronting Campbell Parade; and a lounge room and 16m² terrace fronting Lamrock Place. On the fourth floor (top level/level 5) the unit consists of a master bedroom with walk-in-robe, ensuite and 11m² terrace fronting Campbell Parade; and rear terrace with plunge pool and landscaping.
- AC units and solar panels are also located on the roof, to the rear.



Figure 4. Photomontage of the proposed development as viewed from Campbell Parade. (Source: AN+A, 2023)



Figure 5. Photomontage of the proposed development as viewed from Lamrock Place. (Source: AN+A, 2023)

1.5. Background

The DA was deferred on 8 December 2022 for the following reasons:

- Level 5 is to be deleted as it breaches height and the four storey height limit within the Campbell Parade South Area.
- The breach to height towards the rear of the development needs to better *preserve* environmental amenity impacts.
- Ensure the level 2 blade wall does not extend past the adjoining wall of 54 Campbell Parade.
- A greater rear setback is required, as well as the introduction of deep soil to comply with Part 3E of the Apartment Design Guide (ADG) and increase permeability of the site.
- A concrete awning is not supported, the awnings should be of light weight material and encompass square corners. The awning is to better comply with Part B16, Section 16.4 of the WDCP.
- It is recommended a greater side setback is provided to level 3 to ensure a compliant wall height of 12.5m (stipulated within Part E2, Section 2.2.2, Control (b)(ii) of the WDCP) and also to reduce shadowing impacts.
- Apartment 1 should be reconfigured to remove bedroom 3, which currently features poor amenity and limited daylight from a narrow window situated on the boundary. It is recommended the residential use be limited to the area west of the core at ground level and the size of the retail tenancy should be increased to the east of the core – this will also open up greater potential for future tenants, and to better integrate with the lower level retail space.
- The current proposal to Campbell Parade misses an opportunity to reference the retained brick elevation with the upper level addition. The solidity, texture and symmetry of the building and streetscape has the potential to inform the design, but this is lost through the emphasis on glazing, open balconies, planters and the roof addition. The solidity at the upper level, including the balcony is to be increased.

Amended plans were received by Council on **11 April 2023**, which significantly reduced the fourth level as was originally requested in the deferral letter.

In light of the above, greater consideration is also given to the outcome of the appeal at the adjoining property, 58 Campbell Parade, which was granted consent on 2 June 2023 via a Section 34 Agreement for a 5 storey residential flat building under *LEC No. 2022/00228308* (DA-246/2022). In this respect, the applicant for the subject application was advised that a fourth floor (ie level 5) may only be considered if it could be demonstrated that it would not result in additional environmental amenity impacts when compared with a compliant building height.

The amended plans received by Council on **9 June 2023**, which re-designed the fourth level, form the basis of this assessment.

ASSESSMENT

The following matters are to be considered in the assessment of this DA under section 4.15 of the *Environmental Planning and Assessment Act 1979* (the Act).

2.1. Water Management Act 2000

As significant excavation is proposed, the basement levels will likely interfere with the water table and may trigger the requirement for dewatering.

Dewatering potentially requires a water supply work approval, and as such, the subject DA was referred to Water NSW as Integrated Development shortly after lodgement. The amended architectural plans were not re-notified to Water NSW, as the level of excavation did not change.

General Terms of Approval were issued by Water NSW and have been included in the recommended conditions of consent.

2.1.1. State Environmental Planning Policies (SEPPs)

The following SEPPs apply from the 1st March 2022 and have been considered acceptable in the assessment of this DA:

- SEPP (Building Sustainability Index BASIX) 2004
- SEPP 65 (Design Quality of Residential Apartment Development) 2002
- SEPP (Housing) 2021
- SEPP (Biodiversity and Conservation) 2021
- SEPP (Resilience and Hazards) 2021

A detailed discussion is provided for relevant SEPPs as follows:

SEPP (Design Quality of Residential Apartment Design)

The application was referred to the Waverley Design Advisory Excellence Panel (DEAP) on 12 October 2022, which considered the original plans. The DEAP's comment of the proposed development against the nine design quality principles under Schedule 1 of SEPP 65 and a planning response to each comment are set out in **Table 1** of this report.

Table 1: Assessment against the Nine Design Quality Principles under SEPP 65

Principle	Panel's Comment	Planning Comment	
1. Context and Neighbourhood	 The proposal does/does not achieve this principle in the following ways: The retention of the existing façade to Campbell Parade is broadly supported by the Panel. A number of challenges arise from the retention of this element, including the relationship between the new and existing built fabric, and the overall composition of the site within the Campbell Pd streetscape. Council's DCP includes a granular analysis of the character along Campbell Parade, and establishes a desired future character for new development in this part of the centre. The block currently features a 3-4 storey solid masonry and rendered 	Suitable structural conditions are recommended regarding the retention of the façade. This is discussed further below.	
	setback and subservient to the overall form. • A broader analysis of the Campbell Parade frontage will also provide a number of cues for the treatment of the upper levels in this proposal, including the selection of materials, expression of the vertical and horizontal elements, and the relationship between solid façade and openings. • Further analysis of the site from key spaces within the Bondi Beach precinct is also suggested. Whilst the panel appreciate the screening of the site by the two mature pines to the east, there are a number of oblique views towards the site that highlight the prominence of the site, and the visibility of its upper	Design is discussed further below. The upper level has been reduced.	
2. Built form and Scale	Ievels. The proposal does/does not achieve this principle in the following ways: The Panel don't currently support the Level 4 of the proposal. As noted in the review session, the scale, placement and expression of this element appears awkward and inconsistent with the overall treatment of the building. In addition, the level 4 mostly sits above the height control. The analysis of the 10% addition to the height control	Given the Section 34 Agreement, which granted 58 Campbell Parade approval for the construction of a fourth level (five levels in total plus basement) under <i>LEC No.</i> 2022/00228308 (DA-246/2022), the applicant was advised that a	

Principle	Panel's Comment	Planning Comment
Timelpie		
	needs to be justified further through analysis of amenity impacts, and most crucially, the role within the visual character of the block and Campbell Parade more broadly. • The Panel recognised the potential loss of GFA as a result of removing Level 4, however, there are opportunities to reconfigure the ground and lower ground levels to provide additional floor space – albeit, in the form of lower level retail uses. • The efficiency of the lower ground and basement levels is significantly impacted by the inclusion of ramp from Lamrock PI, and adoption of car shuffle stackers to provide the 7 spaces. The Panel raise the possibility of a car lift, which may allow increased useable floor space at the lower ground. • Bed 3 for Apartment 1 should be	fourth floor may be considered if it could be demonstrated that it would not result in additional environmental amenity impacts when compared with a compliant building height. Environmental amenity impacts from the portions of the development that breach height will be discussed in detail within the Clause 4.6 variation discussion below. Council's Traffic Engineer does not object to vehicle access, subject to recommended conditions.
	reconfigured to remove Bed 3, which currently features poor amenity and limited sunlight from a narrow window situated on the boundary. The Panel suggest residential be limited to the area west of the core at ground, and increasing the size of the retail tenancy to the east of the core – this will also open up greater potential for future tenants, and to better integrate with the lower level retail space. • An alternate approach to Apartments 2	The amended plans have deleted bedroom 3 within Apartment 1.
	and 3 should be investigated, where each unit is configured over a single level. The unit on Level 1 could feature its outdoor living space behind the retained elevation on Campbell Pd. The elevation serving as weather protection from the coastal winds, and the window openings mitigating noise from the street whilst also providing privacy screening — which is likely to be an issue for pedestrians walking along the eastern side of Campbell Pd. • The reconfiguration of Units 2 and 3 will also considerably increase the amount of useable internal area for each apartment. The current design features extensive and convoluted corridors that	No objection to the layout of Apartments 2 and 3.

Principle	Panel's Comment	Planning Comment
	run the length of the floor-plate, and step around the core.	
3. Density	The proposal does/does not achieve this principle in the following ways: • The current scheme sits slightly below the permissible FSR (3:1), and its likely that the GFA will need to be reconfigured at the lower ground level to maintain a similar floor space without the Level 4. The Panel questions the need for such a generous plant room to Lamrock Place, given a further plant room is provided in the basement. An alternate approach to the basement access and parking stacker will also create additional retail space at lower ground	The proposal does not exceed the FSR for the site. The amended plans have reduced the size of the plant room. Sufficient retail space has been provided and there is no objection to car parking on the site.
4. Sustainability	The proposal does/does not achieve this principle in the following ways: On such a constrained site there are limited opportunities for sustainability measures that extend beyond those noted in the design. Without the Level 4 addition a larger and unconstrained roof-plane will be available to accommodate additional PV cells and roof-planting. The latter could form part of a rainwater capture system, integrated with the other areas of landscaping proposed throughout the building.	The proposed development will be required to meet BASIX and NatHERs.
5. Landscape	 The proposal does/does not achieve this principle in the following ways: The nature of the site limits the areas for landscape improvements to the built form and the Lamrock PI frontage. This narrow streetscape currently features a number of existing trees, which are likely to be removed or compromised as part of future developments on neighbouring sites. The Panel suggest the Proponent look for more deep soil canopy tree planting opportunities in this important public pedestrian route. The landscape/green roof at ground to Lamrock PI has the potential to support larger vegetation, with these garden beds increasing in height to further 	Due to the small size of the lot, it is difficult to achieve adequate levels of deep soil. Regardless, the amended plans have provided additional deep soil to the rear of the development. A condition is recommended that the development must provide 50% native planting as the subject site is located within a Biodiversity area. The plans were amended to reduce the size of the plant room and increase the area of landscaping to the Lamrock Lane

Principle	Panel's Comment	Planning Comment
	enclose the Apartment 1 terrace. This planting will also provide valuable privacy screening to this lower-level unit, which is an important consideration within this tight urban setting. • A number of planters are proposed along balconies throughout the building, particularly on the Lamrock Place frontage. These look great in renders, but they need to be or a sufficient size and depth to support vegetation and ensure ongoing maintenance. For example, the planters that wrap around the norther boundary at ground floor should be replaced with a more robust and maintainable material. • Planters along Campbell Parade should be considered as part of a broader analysis of this frontage. Currently, no landscaping/planters are featured in this section of Campbell, and a solid masonry treatment of this elevation might be a more appropriate treatment — see below for further comments. • The Panel recommend that if the fourth level apartment 4 is removed that a non-habitable green roof and PV garden be considered.	frontage. The planting and planter boxes are sufficient in size to contain substantial planting. A condition is recommended regarding the species.
6. Amenity	 The proposal does/does not achieve this principle in the following ways: See comments relating to the reconfiguration of Units 1 and 2, both of which currently feature undersized outdoor spaces for their number of bedrooms. Further analysis of the impact of Level 4 on the surrounding dwellings is recommended. Similarly, interrogation of potential view affectation from neighbouring properties may be required to address any objections. See comments above relating to Bed 3, Unit 1. See comments above relating to improved privacy screening for Unit 1 	This has been discussed above.
7. Safety	The proposal does/does not achieve this principle in the following ways:	

Principle	Panel's Comment	Planning Comment
	No comments relating to safety	
8. Housing Diversity and Social	The proposal does/does not achieve this principle in the following ways: No comments relating to Housing	
Interaction	Diversity & Social Interaction	
9. Aesthetics	The proposal does/does not achieve this principle in the following ways: • Despite being such a tight and constrained site, the Panel has noted a consideration variation in the treatment of the two facades, both in terms of form and materiality. Its suggested that a more thorough interrogation of the	Council's Urban Design Officer has recommended suitable conditions to improve the aesthetic of the building.
	Campbell Parade streetscape and built character is undertaken to help identify and test the most appropriate approach to this primary façade. • The Panel believes the current approach to Campbell Pd misses an opportunity to reference the retained brick elevation with the upper level additions. The solidity, texture and symmetry has the potential to inform the design, but this is lost through the emphasis on glazing, open balconies, planters and the roof addition.	The proposed elevation has been amended to better reference the brick elevation, through more solid portions to the addition.
	The Lamrock Place elevation is more consistent in the overall tectonics, featuring a greater ratio of solid form and punched openings, which reflects the local character of the area. The introduction of horizontal cuts and arches provide greater visual interest, but these elements could be more restrained given the hidden nature of this elevation and tightness of the streetscape.	As this is a rear service lane, Council does not object to the rear elevation.

The proposal has been subsequently amended and is considered to achieve design excellence.

Apartment Design Guide

Clause 6A of SEPP 65 requires that development control plans (DCPs) cannot be inconsistent with the Apartment Design Guide (ADG) in respect of the following:

- (a) visual privacy,
- (b) solar and daylight access,
- (c) common circulation and spaces,
- (d) apartment size and layout,
- (e) ceiling heights,

- (f) private open space and balconies,
- (g) natural ventilation,
- (h) storage.

If a DCP contains provisions that specify requirements, standards or controls in relation to a matter to which this clause applies, those provisions are of no effect. An assessment against the provisions within the ADG is provided in **Table 2** of this report.

Table 2: Apartment Design Guide

Design Criteria	Compliance	Comment
3D Communal and public open sp	ace	
Communal open space has a minimum area equal to 25% of the site	No	Due to the small size of the lot, communal open space is not provided. This is acceptable on merit as appropriate levels of open space is provided to each apartment in the form of balconies and the site is located directly across from Bondi Beach and park.
3E Deep soil zones		
Min deep soil of 7%	No	2.7% of the site is allocated to deep soil. Due to the small size of the lot, only a small amount of deep soil area can be provided as the basement garage covers most of the site area of the lot. This is also an improvement on the existing situation, which has no deep soil.
3F Visual privacy	<u>, </u>	
 Min separation distances from buildings to side and rear boundaries: Up to 12m (4 storey) – 6m habitable & 3m non-habitable Increased separation of 3m where adjoins a lower density zone 	No	Setbacks will be discussed in more detail below.
4A Solar and daylight access		
 Living rooms and private open spaces of at least 70% of units receive minimum of 2 hours direct sunlight between 9am-3pm mid- winter 	Yes	All four units receive two hours of direct sunlight between 9am and 3pm during the winter solstice.
4B Natural ventilation		
 All habitable rooms are naturally ventilated Number of units with natural cross ventilation is maximised: At least 60% of units naturally ventilated 	Yes	All four units are naturally cross ventilated.

Design Criteria	Compliance		Comment	
4C Ceiling heights				
Habitable rooms – 2.7m	Yes	The ceiling heights within all apartments		
• 2 storey units – 2.7m main	Yes	comply with the minimum requirement.		
level (living) & 2.4m upper				
floor where its area does not				
exceed 50% of the unit area				
4D Apartment size and layout	ı .			
The following minimum	Yes	Apartment	Min Size	Size
internal areas apply:		1 (2 bed)	75m ²	89.9m ²
• $2 \text{ Bed} = 70 \text{ m}^2$		2 (4 bed)	117m ²	192.1m ²
• $3 \text{ Bed} = 90 \text{ m}^2$		3 (4 bed)	117m ²	199.1m ²
• Add 5m ² for each		4 (3 bed)	95 ²	209.3m ²
additional bathroom				
(above 1)				
• Add 12m² for each				
additional bedroom				
Leave the last to the last the	Yes		1 10 11 10	
In open plan layouts (where the	163	Each apartments	_	areas do not
living, dining and kitchen are		exceed 8m from	a window.	
combined) the maximum				
habitable room depth is 8m from a window				
Irom a window				
Master bedrooms have a	Yes	Each secondary I	hedroom exceed	s 9m ² and
minimum area of 10m ² and		each primary be		
other bedrooms 9m ² (excluding		caen primary be	aroom exceeds 1	
wardrobe space)				
, ,				
Bedrooms have a minimum	Yes	Each bedroom h	as dimensions th	at exceed 3m.
dimension of 3m (excluding				
wardrobe space)				
Living rooms or combined	Yes	Each living area l	has a width that	exceeds 4m.
living/dining rooms have a				
minimum width of 4m for 2 and				
3 bedroom apartments				
4E Private open space and balcon	ies			
All apartments provide primary	No	Apartment	Min Size	Size
balcony as follows:		1 (2 bed)	Area: 10m²	Area: 15m ²
• 2-bed - 10m ² & 2m depth			Depth: 2m	Depth: 2.1m
• 3+bed - 12m ² & 2.4m depth		2 (4 bed)	Area: 12m ²	Area: 9.5m ²
			Depth: 2.4m	Depth: 2.7m
		3 (4 bed)	Area: 12m²	Area: 9.5m ²
			Depth: 2.4m	Depth: 2.7m
		4 (3 bed)	Area: 12m ²	Area: 20m ²
			Depth: 2.4m	Depth:
				2.305m
4F Common circulation and space	es			

Design Criteria	Compliance		Comment	:
Max of 8 units accessed off a circulation core on a single level	Yes			
4G Storage				
In addition to kitchens,	Yes	Apartment	Min Size	Size
bathrooms and bedrooms, the		1	8m³	13m³
following is provided:				(5.8m³ internal)
• 2-bed – 8m³		2	10m³	21m³
• 3+bed – 10m ³				(12.2m³ internal)
		3	10m³	15.3m³
				(6.5m³ internal)
		4	8m³	12.7m³
				(5.5m³ internal)

SEPP (Housing) 2021

The subject DA does not trigger a need for assessment under the Housing SEPP as the existing building is strata subdivided and no new affordable housing is being proposed.

SEPP (Biodiversity and Conservation) 2021

State Environmental Planning Policy (Biodiversity and Conservation) 2021 regulates the clearing of vegetation that is below the Biodiversity Offset Scheme threshold referred to in the Biodiversity Conservation Act 2016.

In accordance with Part 2.6 of the SEPP, a permit is required from Council to clear any vegetation in an area identified:

- (i) Any vegetation on Land identified as 'Biodiversity' on the Terrestrial Biodiversity Map in WLEP 2012;
- (ii) Any vegetation on Land identified as 'Biodiversity Habitat Corridor' in WDCP2012; or
- (iii) A tree identified on the Waverley Significant Tree Register; or
- (iv) A tree or vegetation that forms part of a Heritage Item or is within a Heritage Conservation Area;
- (v) Any tree with a height of five metres or greater and trunk width of 300mm or greater at ground level; or
- (vi) Any tree with a canopy spread of five metres or greater and trunk width of 300mm or greater at ground level.

Planners Comment

The property lies within the Coastal Biodiversity Corridor. A minimum of 50% of the proposed trees, 50% of the shrubs and 50% of the grasses and groundcovers (not including turfed areas) are to be indigenous or local native plants listed in Annexure B2-1 of the Waverley Development Control Plan 2012 (Waverley DCP 2012) as per Part B, Section 3.2.2, Control (a) of the Waverley DCP 2012. This is recommended as a condition of consent.

SEPP (Resilience and Hazards) 2021

SEPP (Resilience and Hazards) 2021 applies to the subject site, as it is wholly located within the Coastal Environment Area (i.e. defined by Division 3) and a Coastal Use Area (i.e. defined by Division 4).

Division 3 of the SEPP states that development within the Coastal Environment Area must not be granted development consent unless the consent authority has considered whether the proposed development is likely to cause an adverse impact on the matters for consideration outlined in **Table 3** of this report.

Table 3: Division 3 of SEPP (Resilience and Hazards) 2021 Matters for Consideration Table

Matter for Consideration	Compliance	Comment
(a) the integrity and resilience of the biophysical, hydrological (surface and groundwater) and ecological environment,	Yes	As significant excavation is proposed, the basement levels will likely interfere with the water table and may trigger the requirement for dewatering. Dewatering potentially requires a water supply work approval, and as such, the subject DA was referred to Water NSW as Integrated Development shortly after lodgement. The amended architectural plans were not re-notified to Water NSW, as the level of excavation did not change. General Terms of Approval were issued by Water NSW and have been included in the recommended conditions of consent.
(b) coastal environmental values and natural coastal processes,	Yes	The proposal is not expected to cause any changes to the natural environmental values and processes.
(c) the water quality of the marine estate (within the meaning of the Marine Estate Management Act 2014), in particular, the cumulative impacts of the proposed development on any of the sensitive coastal lakes identified in Schedule 1,	Yes	The water quality will not be affected by the proposal.
(d) marine vegetation, native vegetation and fauna and their habitats, undeveloped headlands and rock platforms,	Yes	The proposal is not expected to impact on marine vegetation and habitats as the works will be completed entirely within the site.
(e) existing public open space and safe access to and along the foreshore, beach, headland or rock platform for members of the public, including persons with a disability,	Yes	No public access ways will be affected by the proposal.

Matter for Consideration	Compliance	Comment
(f) Aboriginal cultural heritage, practices and places,	-	N/A
(g) the use of the surf zone.	Yes	There will be no impact to the use of the surf zone.

Division 4 of the SEPP states that development consent must not be granted for development on land within the Coastal Use Area unless the consent authority has considered and is satisfied with the following matters for consideration outlined in **Table 4** of this report.

Table 4: Division 4 of SEPP (Resilience and Hazards) 2021 Matters for Consideration Table

Matter for Consideration	Compliance	Comment		
(a)the consent authority has considered whether the proposed development is likely to cause an adverse impact on the following—				
(i) existing, safe access to and along the foreshore, beach, headland or rock platform for members of the public, including persons with a disability,	Yes	The proposal is not expected to cause disruption to access the foreshore, beach, headland or rock platform for members of the public, including persons with a disability.		
(ii) overshadowing, wind funnelling and the loss of views from public places to foreshores,	Yes	The proposal is not anticipated to cause overshadowing wind funnelling or loss of views to public places or the foreshores.		
(iii) the visual amenity and scenic qualities of the coast, including coastal headlands,	Yes	The proposal is not anticipated to impact the visual amenity and scenic qualities to the coast.		
(iv) Aboriginal cultural heritage, practices and places,	-	N/A		
(v) cultural and built environment heritage, and	-	N/A		
(b)the consent authority is satisfied th	at:			
(i) the development is designed, sited and will be managed to avoid an adverse impact referred to in paragraph (a), or	Yes	The proposed development is considered to be of an appropriate size and scale.		
(ii) if that impact cannot be reasonably avoided—the development is designed, sited and will be managed to minimise that impact, or	N/A			
(iii) if that impact cannot be minimised— the development will be managed to mitigate that impact, and	N/A	rrounding coastal and built environment.		

(c) ...the consent authority has taken into account the surrounding coastal and built environment, and the bulk, scale and size of the proposed development.

Matter for Consideration	Compliance	Comment
	Yes	The proposed development is of a similar bulk and scale to that of surrounding development.

2.1.2. Waverley Local Environmental Plan 2012 (Waverley LEP 2012)

The relevant matters to be considered under the Waverley LEP 2012 for the proposed development are outlined below:

Table 5: Waverley LEP 2012 Compliance Table

Provision	Compliance	Comment	
Part 1 Preliminary			
1.2 Aims of plan	Yes	The proposal meets the aims of the Waverley LEP 2012.	
Land Use Table Local Centre 'E1' Zone	Yes	The proposal is defined as shop-top housing, which is permitted with consent in the E1 zone.	
Part 4 Principal development star	ıdards		
4.3 Height of buildings • 15m	No	The development has a height of 17.1m. This breaches the height limit by 2.1m or 14%.	
 4.4 Floor Space Ratio Lot Size: 367.9m² Max FSR: 3:1 Max GFA: 1,103.7m² 	Yes	Gross Floor Area (GFA) Calculation: Basement 2: 0m² Basement 1: 0m² Lower Ground Floor: 104.78m² Ground Floor: 226.51m² First Floor: 235.42m² Second Floor: 208.58m² Third Floor: 160.38m² Fourth Floor: 57.83m² Total GFA: 993.5m²	
		Total FSR: 2.7:1	
4.6 Exceptions to development standards	See discussion	The application is accompanied by a written request pursuant to clause 4.6 of Waverley LEP 2012 to vary the height development standard. A detailed discussion of the variation to the development standard is presented below this table.	
Part 5 Miscellaneous provisions			
5.10 Heritage conservation	Yes (via condition)	The subject site is located within the Bondi Beach Heritage Conservation Area. Council's Heritage Officer reviewed the application. Their comments will be discussed in the referral section of this report.	
Part 6 Additional local provisions			

Provision	Compliance	Comment
6.1 Acid sulfate soils	Yes	The subject site is located within acid sulfate soils class 5. However, as the subject site is not 5m below the AHD it is not applicable.
6.2 Earthworks	Yes (via condition)	Appropriate excavation conditions are recommended.
6.9 Design excellence	Yes	The subject site achieves design excellence, as detailed throughout the report.
6.16 Development in zone E1	Yes	The proposed development is compatible with the desired future character and amenity of surrounding residential areas.

The following is a detailed discussion of the issues identified in the compliance table above in relation to the Waverley LEP 2012.

Clause 4.6 Exceptions to Development Standards - Height of Building

The application seeks to vary the height of buildings development standard in clause 4.3 under Waverley LEP 2012.

The site is subject to a maximum height development standard of 15m. The proposed development has a height of 17.1m, exceeding the standard by 2.1m equating to a 14% variation.

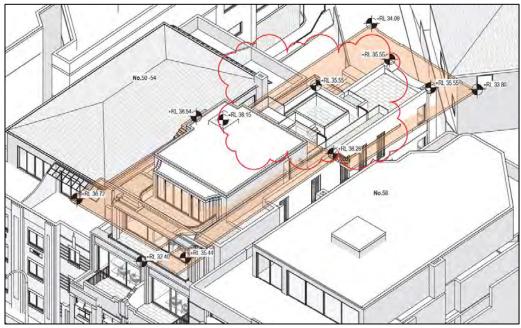


Figure 6. 15m height plane plan, showing portions of the development that breach height above the orange shaded area. (Source: AN+A, 2023)

A written request has been submitted to Council in accordance with clause 4.6(3)(a) and (b) of Waverley LEP 2012 seeking to justify the contravention of the development standard by demonstrating:

- (a) That compliance with the development standard is unreasonable or unnecessary in the circumstances of the case; and
- (b) That there are sufficient environmental planning grounds to justify contravening the standard.

A copy of the applicant's written request has been provided to the Waverley Local Planning Panel for consideration.

Applicant's Written Request - Clause 4.6(3)(a) and (b)

The applicant seeks to justify the contravention of the height of building development standard on the following basis:

- (a) That compliance with the development standard is unreasonable or unnecessary in the circumstances of the case:
 - (i) The proposal meets the relevant objectives of building height:

Objective (a): To ensure building heights preserve the environmental amenity of neighbouring properties and public spaces and, if appropriate, the sharing of views.

The environmental amenity of the adjoining properties is preserved. The solar access assessment by the architects demonstrates that areas above the height limit cause no further impact on the adjoining development to the south at 54 Campbell Parade or 1 Sir Thomas Mitchell Road as compared to a height-compliant development. This is discussed further below in meeting objective (c), which requires satisfactory solar access to existing buildings and public areas.

Privacy is preserved to the extent anticipated by the controls, as the floor level and line of sight from both the windows and the beach-facing terrace are below the height standard. The uppermost terrace is not directly adjacent to living areas and does not facilitate frequent or high intensity use (being a level above the principal living level and only 9.6m² in size, adjacent to a fenced off pool area) nor does it overlook adjoining properties given its setback from the building edge of the floor below, the adjacent planters on both sides and its height adjacent to the roofs of neighbouring buildings.

In relation to the preservation of views, no views have been observed that are available over the site that are impacted by the proposed built form to a greater degree caused by the areas of the building above the height standard. This is due to the topography of this section of Campbell Parade and the lower heights of buildings in the streets behind the site.

The preservation of the environmental amenity of public spaces is specifically facilitated by the proposed development and its preservation of the existing building and contributory components of the original building as it presents to the streetscape and the public domain. The additions to the building, and in particular the components of the building that contravene the height standard, will not be visible from in front of the site, from across the road from the site on Campbell Parade or Bondi Park.

When the additions become apparent, from distant views and obscure angles further north-east along Campbell Parade and at a greater distance from Ramsgate Avenue on the other side of Bondi Beach, they sit comfortably and compatibly above the original building form, similar to many other forms amongst the undulating building envelopes that contribute to the Campbell Parade streetscape. The setback of the uppermost floor at the front of the site has been made purposefully compatible with the setback of the approved development on the adjoining property at 58 Campbell Parade. From these distant aspects the additional height will be unoffensive to the public domain.

Objective (c) To maintain satisfactory solar access to existing buildings and public areas.

In relation to solar access onto public areas, there is no additional solar access impact arising from the height variation or the building in general affecting any public areas. Height compliant aspects of the building (at the front) cause some additional shadow onto the road surface of Campbell Parade in the late afternoon. This is a satisfactory outcome anticipated by any development on this site.

In relation to solar access to existing buildings, documentation has been provided to illustrate there is a complete preservation of solar access and solar amenity to existing buildings. This 'preservation' test is more stringent than this objective, which seeks maintenance of 'satisfactory' solar access, and this objective is therefore met.

The side facing windows of the existing building at 54 Campbell Parade are all below the height development standard and would be overshadowed from any complying development of this site. They currently receive sunlight borrowed from the site's underdeveloped 2-3 storey form.

The side facing windows on the existing building at 1 Sir Thomas Mitchell Road are similarly below the height development standard and could be affected by a height compliant development on this site subject to rear setback dimensions.

Further, the amended plans have redistributed height and floor space at the uppermost level as well as the level below. These levels are now setback further than originally proposed that are specifically designed around solar preservation **and improvement**, to both existing buildings at 54 Campbell Parade and 1 Sir Thomas Mitchell Street.

In relation to the impacts on 54 Campbell Parade, the shadow diagrams demonstrate that:

- At 9am, there is no impact upon any windows or decks beyond that caused by a height compliant building.
- At 10am, there is a marginal (almost immeasurable) reduction in sunlight to the rear terrace of a unit that is offset by a real improvement with **additional sunlight** available at the front unit, where the beach facing doors will have sunlight on the glazing that is not anticipated by the controls.
- At 11am, there is **additional sunlight** on the rear deck of a unit and **additional sunlight** on the front deck of 2 units, of which neither are anticipated by the controls.
- At 12 noon, there is a marginal (almost immeasurable) amount of **additional sunlight** on the front deck of 1 unit, and uninterrupted **additional sunlight** on the rear terrace of a unit that is not anticipated by the controls.
- At 1pm, there is **additional sunlight** on the front deck of 1 unit, and uninterrupted **additional sunlight** on the rear terrace of a unit that is not anticipated by the controls.
- At 2pm, there is **additional sunlight** to a window of 1 unit, and uninterrupted **additional sunlight** on the rear terrace of a unit that is not anticipated by the controls.
- At 3pm, there is **additional sunlight** to a window of 1 unit, and uninterrupted **additional sunlight** on the rear terrace of a unit that is not anticipated by the controls.

In relation to the impacts on the existing building at 1 Sir Thomas Mitchell Street, the shadow diagrams demonstrate that:

- At 9am, there is **additional sunligh**t to a secondary bedroom window of a unit on level 3 that is not anticipated by the controls.
- At 10am, there is **additional sunlight** to a secondary bedroom window of a unit on level 2 that is not anticipated by the controls.
- By 11am, the **additional sunlight** created by the sculpted form of the building falls onto the blank side wall of the building, with no material benefit to any openings or private outdoor areas.

• From 12 noon onwards there are **no shadows cast** onto the building.

The solar access impact arising from the areas of non-compliance are non-existent, whilst there are genuine improvements to the amenity of the neighbouring properties arising from the sculpted design offering additional sunlight, preserving the amenity of those properties and improving it beyond the extent anticipated by the controls.

Objective (d) To establish building heights that are consistent with the desired future character of the locality.

The desired future character has been most recently demonstrated by newer developments such as the building at the recently completed building at 10-14 Hall Street, and approved buildings at both 124 and 134 Campbell Parade, all within immediate proximity to the subject site.

The uppermost floor of the proposed development has been designed as a recessive element with a substantial setback from the Campbell Parade frontage of nearly 6.5 metres. Sightline diagrams by the architect illustrate that the top level will not be visible from Campbell Parade, even when standing across the road on the eastern side of the street 20 metres away.

This is consistent with the LEC outcome on the neighbouring site at 58 Campbell Parade.

The setback of the new parts of the building behind the original building will in fact obscure all new levels from the subject (western) side of the street – i.e. standing in front of the building.

The setbacks are generous and meaningful, to ensure that the building is consistent with the desired future character as required. Recent developments within the same B4 (E1) zone along Campbell Parade have a scale of 5 storeys to the street, often with limited setbacks that are modest compared to the setback proposed for this building.

Other approvals in the same zoning in close proximity to the site that contravene the development standard, but meet the objective of the standard, are relevant considerations as per SJD DB2 Pty Ltd v Woollahra Municipal Council [2020] NSWLEC 1112 ("SJD 1") and later as per Woollahra Municipal Council v SJD DB2 Pty Limited [2020] NSWLEC 115 ("SJD 2").

"SJD 1-69 - The desired future character in my opinion must take into account the form of the buildings to the east which the Council approved under effectively the same controls as present. Those buildings exceed the height and floor space ratio controls. As the Applicant pointed out in submissions, this is not a case where there is an adjacent development approved and constructed many years ago which sits as an anomaly in the street. The developments under construction represent the recently expressed attitude of the Respondent to the controls and what is desired in this part of Cross Street"

"SJD 2-63 - ... the desired future character of the neighbourhood or area can be shaped not only by the provisions of WLEP, including the development standards themselves, but also other factors, including approved development that contravenes the development standard"

The proposal is consistent with surrounding developments on Campbell Parade with taller approved and/or constructed fifth and sixth storeys that vary the height limit.

Providing setbacks to the uppermost floors offers an established and proven method of incorporating additional height to a building without impacting upon the contribution of the original front facades of buildings along Campbell Parade. There are a number of examples of this along Campbell Parade, but perhaps the most notable and relevant example is the immediately adjoining property to the south, at 54 Campbell Parade.

The neighbouring building has a set back uppermost level behind the main streetwall and parapet of the existing building. The additions are clearly visible from 3d aerial imagery and can be seen from the public domain at a greater distance from the site. Notwithstanding this, when viewing

the building and its principal height, bulk and scale from Campbell Parade, the top level (and its pitched roof) are entirely invisible. This is achieved on this neighbouring site with a 6 metre setback. On the recently approved development at 58 Campbell Parade this has been achieved with a 6.425m setback. It is proposed to match the larger 6.425m setback of 58 Campbell Parade.

The proposed uppermost will only be visible at much greater distances from the site where it will be read as a much smaller additional level commensurate with many other examples along Campbell Parade. It is notable that a visual appreciation of the uppermost level won't occur from Bondi Park immediately adjacent to the site, as the park slopes away from the site such that the top level remains invisible from the public domain. It is not until an aspect is taken from the sands of Bondi Beach at some distance that this level will be visible.

- (ii) The proposal meets the objectives of the zone.
 - a. To provide a range of retail, business and community uses that serve the needs of people who live in, work in or visit the area.

The proposal retains a single shop with activation to Campbell Parade and an expansion into a lower level behind, as well as retention of the existing 4 residential apartment density on the site, with the introduction of increased amenities for all uses.

b. To encourage investment in local commercial development that generates employment opportunities and economic growth.

The proposed expansion of the commercial tenancy on the site demonstrates an investment in commercial development.

c. To enable residential development that contributes to a vibrant and active local centre and is consistent with the Council's strategic planning for residential development in the area.

The proposal introduces improved residential units above the shopfront, with active areas facing Campbell parade.

d. To encourage business, retail, community and other non-residential land uses on the ground floor of buildings.

The ground floor is non-residential as required.

e. To strengthen the viability of Waverley's existing business centres as places of vitality for investment, employment and cultural activity.

The expansion of the commercial tenancy on the site will contribute to the broader viability of this business centre.

f. To maximise public transport patronage and encourage walking and cycling.

The proposal offers convenient bicycle parking within the building and compliant levels of car parking to minimise car dependency and encourage walking and cycling.

g. To encourage the provision of affordable housing.

The proposal includes a variety of housing types - dual level, whole level, rear facing; and sizes (number of bedrooms).

h. To provide for a range of other uses, including light industrial, that serve the surrounding neighbourhood without impacting on the amenity of the adjoining uses.

This objective is not relevant to this development.

i. To ensure development is of a height and scale that achieves the desired future character of the neighbourhood.

The height, setbacks and scale of the proposal has been specifically designed to ensure it is consistent with the desired future character.

j. To promote employment growth by giving preference to commercial development over residential development.

The ground floor and lower floor offer commercial development.

k. To provide active ground floor uses to create vibrant centres.

The ground floor facing Campbell Parade, where activation is required, is activated by predominantly commercial activity.

- (b) That there are sufficient environmental planning grounds to justify contravening the standard:
 - (i) The aspect of the development that contravenes the standard provides an alternative configuration of the building envelope on the site (based on an improved distribution of permissible gross floor area) in order to retain and preserve the significant elements of the original building that is contributory to the heritage conservation area and subject to a potential future listing as a heritage item.
 - (ii) The variation is caused by a component of the building that is a recessive response to the contributory elements of the building on the site. The set back nature of the uppermost access level is visually recessive, indiscernible and unoffensive from the public domain.
 - (iii) The existing building's façade that is being retained is significantly below the height standard. Its retention preserves the building's contribution to the conservation area and this is facilitated by the components of the building that seek to vary the height standard.
 - (iv) The materials, finishes and setback to the uppermost level are respectful and responsive to the original fabric of the building and the conservation setting, noting in particular the level is set in from both sides of the building below and substantially set in from the front and rear boundaries.
 - (v) Redistribution of height, whilst also offering less gross floor area on the site than the controls allow, provides for an orderly and economic development that permits the longevity of the significant components of the original building that is likely to be heritage listed in a future WLEP.
 - (vi) The proposal allows for the ongoing conservation of the significant components of the original building inclusive of an improvement to the environmental sustainability, energy efficiency and amenity of the building generally.
 - (vii) The design satisfies clause 5.10 of the Waverley Local Environmental Plan 2012 with respect to the heritage conservation controls, with the components of the building that are contributory to the heritage conservation area being retained.
 - (viii) The proposal promotes the economic use and development of the land and the sustainable management of built heritage, (1.3(c) and 1.3(f) of the EP&A Act).

- (ix) The scale of the building is consistent with building envelope controls outlined in the DCP that dictate the future desired character, particularly with regards to the preservation of the original street wall with recessed levels above.
- (x) The scale of the building is consistent with the part 4/ part 5 storey buildings within the Campbell Parade and Bondi Beach streetscapes, inclusive of the recent Land and Environment Court approved developments at 10-14 Hall Street, 124 Campbell Parade and 134 Campbell Parade which share the same development standard attributes as the subject site.
- (xi) The design satisfies the Object 1(g) of the EP&A Act 1979 which seeks to promote good design and amenity of the built environment.
- (xii) That despite the non-compliance, the building satisfies the objectives of the development standard and the zone.

Consideration of Applicant's Written Request - Clause 4.6(4) (a) (i) and (ii)

Development consent must not be granted unless the consent authority is satisfied that:

- (a) The applicant's written request has adequately addressed the matters required to be demonstrated by subclause 3 of clause 4.6 being that compliance with the development standard is unreasonable or unnecessary in the circumstances of the case, and that there are sufficient environmental planning grounds to justify contravening the standard; and
- (b) The proposed development will be in the public interest because it is consistent with the objectives of the particular development standard and the objectives for development within the zone in which the development is proposed to be carried out.

Does the written request adequately address those issues at clause 4.6(3)(a)?

It is considered that the applicant has adequately addressed that compliance with the standard is unreasonable or unnecessary in the circumstances of the case and has referenced one or more of the following justifications as set out in *Wehbe v Pittwater Council* (2007) 156 LGERA 446:

- (a) the objectives of the development standard are achieved notwithstanding non-compliance with the standard;
- (b) to establish that the underlying objective or purpose is not relevant to the development with the consequence that compliance is unnecessary;
- (c) to establish that the underlying objective or purpose would be defeated or thwarted if compliance was required with the consequence that compliance is unreasonable;
- (d) to establish that the development standard has been virtually abandoned or destroyed by the Council's own actions in granting consents departing from the standard and hence compliance with the standard is unnecessary and unreasonable; and
- (e) to establish that "the zoning of particular land" was "unreasonable or inappropriate" so that "a development standard appropriate for that zoning was also unreasonable or unnecessary as it applied to that land" and that "compliance with the standard in that case would also be unreasonable or unnecessary.

The applicant specifically relies upon justification (a) outlined above to address clause 4.6(3)(a) of Waverley LEP 2012.

Does the written request adequately address those issues at clause 4.6(3)(b)?

The applicant has adequately addressed that there are sufficient environmental planning grounds to justify contravening the development standard. Despite the breach to building height the proposed development meets the objectives of the development standard and zone.


Is the development in the public interest?

The proposed development will be in the public interest because it is consistent with both the objectives of the particular development standard and the objectives for development within the zone in which the development is proposed to be carried out.

The relevant objectives of the height of building development standard are as follows:

(a) To establish limits on the overall height of development to preserve the environmental amenity of neighbouring properties and public spaces and, if appropriate, the sharing of views.

The applicant has demonstrated that despite the breach to height, the amount of overshadowing to neighbouring windows and balconies would not exceed that of a compliant building envelope. The diagrams below shown in **Figure 7** show view from sun diagrams on June 21. The diagrams demonstrate that the proposed development (left) will not create additional shadowing to neighbouring properties in comparation to a compliant development (right).

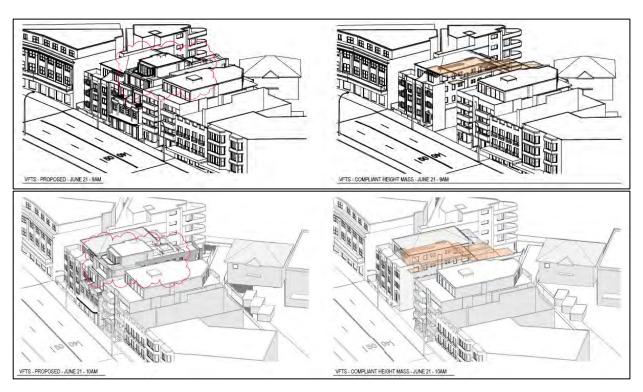

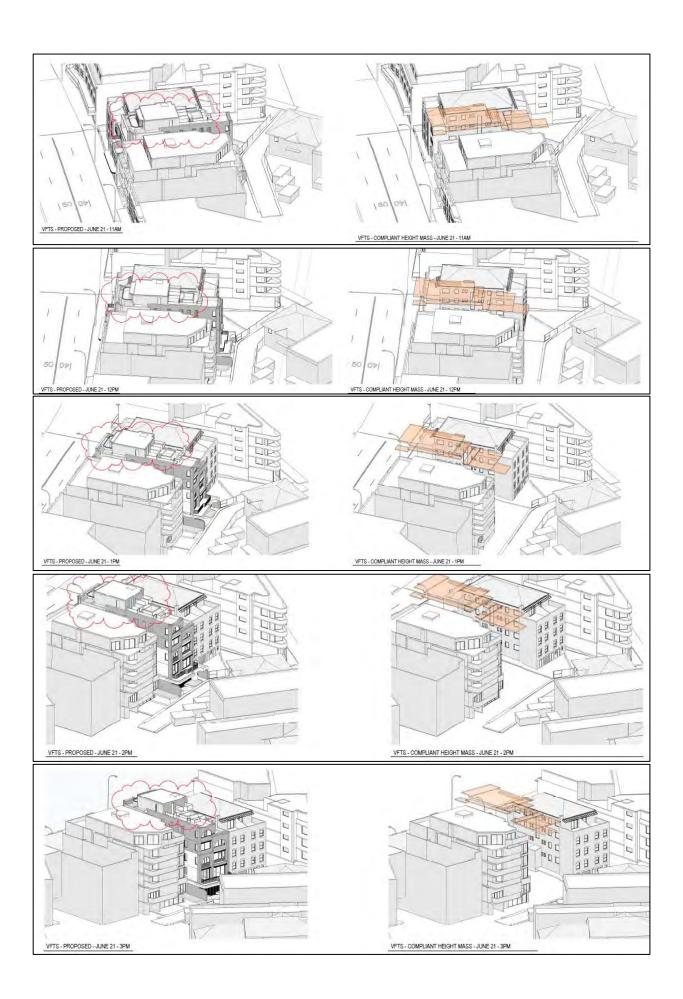


Figure 7. View from sun diagrams at between 9am – 3pm during the winter solstice, demonstrating the proposed development would not create additional overshadowing from a compliant building envelope. (Source: AN+A, 2023)

(b) To ensure that buildings are compatible with the height, bulk and scale of the desired future character of the locality and positively complement and contribute to the physical definition of the street network and public space.

To assess the acceptability of the height and scale and associated level four against the desired future character of the locality, the development is compared to the recent development consent granted to 58 Campbell Parade. This approval by the LEC on 2 June 2023 was for the substantial demolition (retention to a portion of boundary walls and frontage) and alterations and additions to a residential flat building (new building) comprising of 10 Units and integrated basement parking.

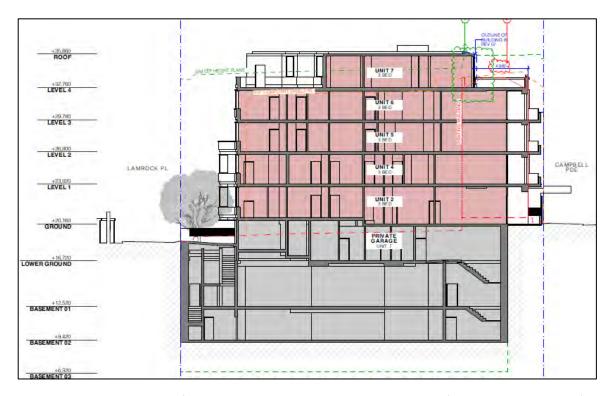


Figure 8. Approved section for 58 Campbell Parade, granted by the LEC. (Source MHNDU, 2022)

It is noted that when comparing the approved development at No. 58 with the proposed development, the proposed development sits 1.79m higher than 58 Campbell Parade (comparing parapet height).

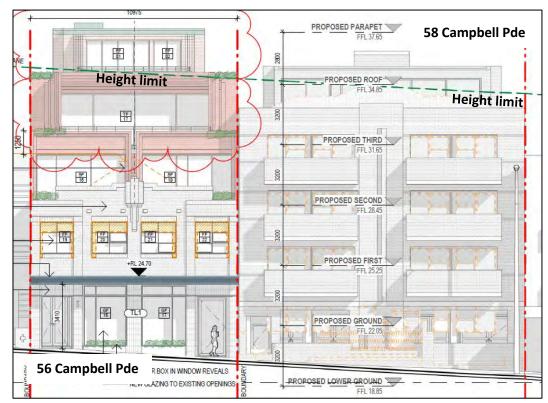


Figure 9. Comparison of approved development at 58 Campbell Parade and proposed development under this application, as viewed from Campbell Parade. (Source: AN+A, 2023)

However, the following points are outlined below to demonstrate why the fourth level is acceptable in comparison to 58 Campbell Parade:

- Due to the sloping topography of the locality, the subject site sits higher on the hill compared to No. 58. Therefore, it will visually appear taller than the proposed development. However, when measuring each buildings height (approved and proposed) it is concluded that the proposed development is not greater in overall height than No. 58. The approved development at No. 58 was approved with a height of 17.55m at the rear roof parapet and 15.81m to top of lift overrun (according to the LEC Judgement), whilst the proposed development has a height of 17.1m (measured from lift overrun to existing ground level).
- Due to the form of the existing ground level, the breach to height to the front portion of the development at No. 58 will be less than the subject site. In the diagrams below, it is identified (in left section of **Figure 10**) that the existing ground level at No. 58 substantially slopes down from the front boundary, resulting in less portions of the development breaching height. While in comparison, the existing ground level of the subject site (refer to **Figure 11**) maintains the same ground level for the first half of the site before sloping down. This results in more of the proposed development exceeding the 15m height limit in comparison to No. 58, due to the differing form of existing ground level to each site.

However, as can be seen in **Figures 10** and **11** below, it is evident that the Existing Ground Level for both developments, have utilised the Finished Floor Level of the existing buildings, therefore the portions that breach height are dictated by the existing buildings Finished Floor Level and not the natural topography of the site. Therefore, this

will result in height lines that do not take into account the natural slope of the topography.

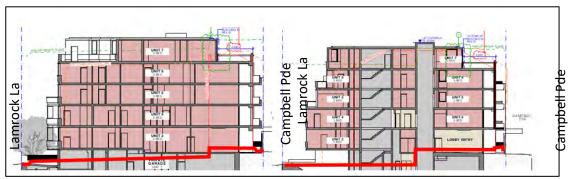


Figure 10. Existing Ground Level at 58 Campbell Parade (red line). (Source: MHNDUNION, 2023)



Figure 11. Existing Ground Level of the subject site (red line). (Source: AN+A, 2023)

• The maximum 15m height line at level four is located at approximately a persons chest height (southern boundary) and knee height (northern boundary) for the subject site, while at No. 58, the height limit is located at head height. This this indicates that the majority of level four sits higher at No. 58 when compared to the proposed development.

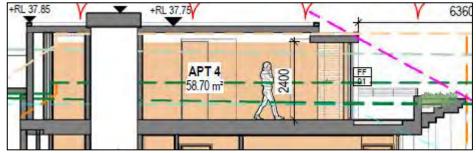


Figure 12. Maximum height line (green dashed line) is at chest and knee height to level 4 of the subject site. (Source: AN+A, 2023)

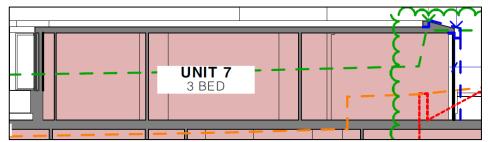


Figure 13. Maximum height line (green dashed line) is at head height to level 4 of the 58 Campbell Parade. (Source: AN+A, 2023)

Conclusion

For the reasons provided above, the requested variation to the height of building standard is supported as the applicant's written request has adequately addressed the matters required to be addressed by clause 4.6 of the Waverley LEP 2012 and the proposed development would be in the public interest because it is consistent with the objectives of height of building and the Local Centre 'E1' zone.

2.1.3. Waverley Development Control Plan 2012 (Waverley DCP 2012) - Amendment No.9

The relevant matters to be considered under the Waverley DCP 2012 for the proposed development are outlined below:

Table 6: Waverley DCP 2012 – Part B General Provisions Compliance Table

Development Control	Compliance	Comment
1. Waste	Yes	Council's Waste Officer supports the application and recommends conditions of consent.
1. Waste	163	Separate commercial and residential bin storage rooms are provided at lower ground level.
Ecologically Sustainable Development	Conditional	Appropriate conditions are recommended in relation to BASIX and NatHERs requirements.
3. Landscaping and Biodiversity	Conditional	Conditions are recommended that 50% of the planting be native species, as the subject site is located within a Biodiversity overlay.
5. Vegetation Preservation	N/A	Tree removal is not proposed.
6. Stormwater	Yes	Council's Stormwater Engineer has recommended conditions of consent.
7. Accessibility and Adaptability	Yes	The development will need to comply with the Building Code of Australia / National Construction Code.
8. Transport		
8.1 Streetscape	Yes	The parking accessed from Lamrock Place is a desired outcome, as this is a secondary access lane and removes the need for a crossover to Campbell Parade.

Development Control	Compliance	Com	ment
8.2 On-site parking	-	The subject site is locate	d in parking zone 2.
8.2.1 Vehicle Access	Conditional	Council's Traffic Enginee conditions of consent re	
8.2.2 Parking Rates		Required	Proposed
	Yes	Residential Min: 0 spaces Max: 5.7 spaces	Residential 6 spaces
		Visitor 0 spaces	Visitor 0 spaces
		Retail	Retail
	Yes	Min: 0 spaces Max: 4 spaces	1 space
	Conditional	Motorcycle 2 spaces	Motorcycle 2 spaces
	Yes	Accessible	Accessible
	163	0 spaces Bicycle	2 spaces Bicycle
	Yes Conditional	Residential: 4 spaces Retail Employee: 0 spaces Retail Visitor: 1 spaces	Residential: 4 spaces Retail Employee: 0 spaces Retail Visitor: 0 spaces
			A condition is recommended to provide 1 retail bicycle space.
9. Heritage	Conditional	The subject site is locate Heritage Conservation A discussed in more detail section of this report.	
		The application has been Their comments have be Table 1 of this report.	•
12. Design Excellence	Yes	Further comments from Officer will be discussed this report.	•
14. Excavation	Acceptable	Due to the narrow lot wi for the excavation canno Appropriate conditions a ensure excavation is carr manner.	t be achieved. The recommended to

Development Control	Compliance	Comment
15. Public Domain	Acceptable	The proposal will provide an active street frontage.
		The awning ranges in height from 3.9m to 4.5m (measured to footpath). Although this exceeds the maximum awning height of 4.2m, it is accepted on merit due to the sloping nature of the locality.
		The proposed awning provides appropriate height clearance.
		A condition is recommended that the depth of the awning be extended to be setback 0.6m from the kerb line and the corners are squared-off rather than curved.
17. Inter War Buildings	Conditional	The subject site is located within the Bondi Beach Heritage Conservation Area. This will be discussed in more detail within the referral section of this report.

Table 7: Waverley DCP 2012 – Part C3 Other Residential Development Compliance Table

Development Control	Compliance	Comment		
3.1 Site, scale and frontage	3.1 Site, scale and frontage			
	Yes	The proposed development has appropriately designed the development within the narrow lot.		
3.2 Height				
	Refer to Table 8	Maximum external wall height is stipulated in Part E2 of the Waverley DCP 2012.		
3.3 Setbacks				
3.3.1 - Street setbacks	Refer to Table 8	Maximum external wall height is stipulated in Part E2 of the Waverley DCP 2012.		
3.3.2- Side and rear setbacks	Refer to Table 8	Maximum external wall height is stipulated in Part E2 of the Waverley DCP 2012.		
3.4 Length and depth of build	ings			
 Maximum building length: 24m Façade to be articulated Maximum unit depth: 18m 	Merit	The length and depth of the building appropriately responds to the small lot size.		
3.5 Building design and streetscape				
Respond to streetscapeSympathetic external finishes	Yes	The development appropriately retains the front façade of the existing building, with the proposed works located behind this existing retained building line. This retention is considered to		

Development Control	Compliance	Comment
 Corner sites to address both streets as primary frontages Removal of original architectural features not supported. 		contribute to the Heritage Conservation Area and associated streetscape.
3.6 Attic and roof design		
	Yes	The roof form is acceptable.
3.8 Pedestrian access and entr	у	
 Entry at street level and respond to pattern within the street Accessible entry Separate to vehicular entry Legible, safe, well-lit 	Yes	Entry to the residential and commercial spaces is acceptable.
3.9 Landscaping – REFER TO Al	OG	
3.10 Communal open space – I		
3.11 Private Open Space – REF		
 Car parking to be integrated into the design of the development Max 1 x 2 way vehicle access point Provided from secondary street or lane Pedestrian safety considered Basement parking should not contravene deep soil zone controls 	Yes	Vehicular access and parking is acceptable subject to conditions of consent.
3.13 Solar access and overshadDirect sunlight to north	Yes	Overshadowing and solar access has been
facing windows of habitable rooms and all private open space areas of adjacent dwellings should not be reduced to less than 3 hours between 9.00am and 3.00pm on June 21.	163	discussed in detail within the Clause 4.6 justification. It is concluded that no additional overshadowing would occur to neighbouring windows or open space. Due to the narrow subdivision pattern of the existing lots and the 15m height limit permitted for this site, three hours of direct sunlight to north facing windows cannot be achieved.
3.14 Views and view sharing		

	o !:	
Development Control	Compliance	Comment
	Merit	View loss will be discussed in detail below Table 8 .
3.15 Visual privacy and securit	у	
 Dwellings to be orientated to the street with entrances and street numbering visible Above ground open space must not overlook rooms and private landscaped areas of adjoining properties or be screened Privacy be considered in relation to context density, separation use and design. Prevent overlooking of more than 50% of private open space of lower level dwellings in same development Roof tops are to be nontrafficable, unless there is a predominance of roof terraces in the immediate 	Acceptable	The windows to the rear portion of the side elevation that lack privacy screens are acceptable as they will not look directly into neighbouring windows. The majority of all other windows to side elevations incorporate privacy screens. The rear terrace to apartment 1 will not result in unreasonable visual privacy impacts to neighbouring properties. The front terraces to apartments 2 - 4 will overlook Campbell Parade, an active street front. The trafficable area of the level four rear terrace is setback from the edge of the roof below, obstructing sightlines. Additionally, due to the natural topography of the area and the existing built form of 54 Campbell Parade, the level four rear terrace will not look directly into neighbouring windows or balconies.
vicinity of the site. 3.16 Dwelling size and layout	DEEEB TO ADO	
3.17 Ceiling Heights – REFER TO		
3.18 Storage – REFER TO ADG	J ADG	
3.19 Acoustic privacy		
 Internal amenity by locating noisy areas away from quiet areas 	Yes	The internal layout of the apartments have been appropriately designed to locate noisy areas away from quiet areas.
3.20 Natural Ventilation – REF	ER TO ADG	
3.21 Building services		
Services are to be integrated into the design of buildings (garbage rooms, mail boxes, fire hydrants boosters, electrical substations, down pipes, plant rooms, satellite/communications structures	Yes	Services are integrated into the design of the building.
Plant rooms away from entry communal and private open spaces and bedrooms.	Yes	Plant rooms are located away from communal entry areas or private open space.

Development Control	Compliance	Comment
 Services on roof not to be seen from street or impact public or private views and be min 2m from the building edge 	Yes	Services on the roof are integrated into the design of the development.

Table 8: Waverley DCP 2012 –E2 Bondi Beachfront Area Compliance Table

Development Control	Compliance	Comment	
2.1 General Controls			
2.1.1 Public Domain Interface	Yes	The commercial and residential entries are separated.	
	Yes	The entry of the residential portion does not exceed 20% of the Campbell Parade frontage.	
	Yes	The shopfront has appropriate openings to activate the street front.	
	Yes	The vehicle entry is to the rear lane and not to Campbell Parade.	
2.1.2 Building Use	Yes	The development proposes a commercial use on the ground floor and a residential use at first floor. This is the common approach for new development in this locality, providing a permitted shop-top housing use in the zone.	
2.1.3 Built Form	Yes	The front façade of the original building is retained on the front boundary, respecting the heritage character of the existing building. Conditions recommended to ensure this occurs safely.	
	Yes	The ground floor commercial shell has a floor to ceiling height of 4.2m.	
2.1.4 Roofs	Yes	The location of services to the roof will not be visible to pedestrians on the footpath.	
2.1.5 Views	Refer to discussion	View loss will be discussed in detail below Table 8 .	
2.1.6 Heritage conservation	Conditional	The subject site is located within the Bondi Beach Heritage Conservation Area. This will be discussed in more detail within the referral section of this report.	
2.1.7 Infill Buildings	Yes	The front façade of the original building is retained on the front boundary, respecting the heritage character of the existing building.	
	2.2 Character Areas – Notts Ave or Campbell Parade South/Central/North or Ramsgate Ave East		
Area B or 2.1.2 – Campbell Parade South	Acceptable	Land Use The development proposes a commercial use on the ground floor and a residential use at first floor and above. This is the common approach for	

Development Control	Compliance	Comment
		new development in this locality, providing permitted shop-top housing uses.
		Height and Bulk The fourth level is acceptable on merit as it has been demonstrated in the Clause 4.6 Variation that it does not result in environmental amenity impacts to neighbouring properties.
		Although a 13.5m wall height is proposed, this is permitted as additional setbacks cannot be achieved without impacting the internal amenity of the apartments due to the narrow width of the lot.
		Setbacks The development retains the front façade and portions of the side walls of the existing building, which are constructed on the front boundary.
		The proposed second and third floors provide an appropriate setback from the front boundary line, recessed from the ground floor and level 1 below. The forward most 11.4m of the building is constructed on the side boundaries with the rear portion setback 1.2m from each side. This is a similar approach to the recently approved development at 58 Campbell Parade.
		Heritage and contributory buildings The development appropriately retains the front façade of the building.
		Façade Materials and Finishes The development appropriately retains the front façade of the building. A condition is recommended that materials and finishes be satisfied by Council's Urban Design Manager, to ensure an appropriate contrast between the retained elements and the new portion of the development.
		Balconies and Balustrades The proposed front balconies do not extend forward of the front façade. Levels 1 and 2 utilises the existing front façade for use as a balustrade. The recessed level three is a mix of brick and metal.
		Roofs and Parapets

Development Control	Compliance	Comment					
		The roof provides a parapet.					
		Façade Colours A condition is recommended that materials and finishes be satisfied by Council's Urban Design Officer.					
		Parking					
		Parking is accessed via the rear lane.					

The following is a detailed discussion of the issues identified in the compliance tables above in relation to the Waverley DCP 2012.

View loss

An objection was received from 10/54 Campbell Parade relating to view loss. Council requested images of the view.



Figure 14. Northern outlook from kitchen window standing from 10/54 Campbell Parade.



Figure 15. Northern outlook from living/dining room window standing from 10/54 Campbell Parade.

As this is not a view but an outlook, an assessment against the principles of Tenacity is not required. However, it is noteworthy that Step Two of the Tenacity Assessment states "the expectation to retain side views and sitting views is often unrealistic".

The assessing officer reached out to the objector to understand if there was view loss to unit 11 (as they prepared a joint objection for units 10 and 11). It was advised that 'unit 11 faces the beach but council should still consider the loss of outlook from other north facing units'.

No other objections were received in relation to view loss.

Council's Urban Design Officer advised that there could be potential view loss to properties at both Francis and Edward Streets to the south-west of the site. The team provided the following 3D modelling from 35 Francis Street.



Figure 16. 3D modelling of potential view impact, looking north-east. Proposed view (top) and existing view (bottom).

The applicant provided the following justification in relation to this potential view loss.

With respect to the images offered that purport to view impacts arising from the development upon three properties, I reject that there is a 'significant' impact arising from this development. Unfortunately the images provided by Council are not compliant with the LEC view assessment protocols or Photomontage Policy, nor is the LEP height plane overlay accurate to the particular circumstances of individual sites. This is evident particularly at the front of the site where the height plane is shown much lower in the images than the actual surveyed height plane in our drawings. The Council's model offers an extrapolated plane only. Further, the images do not provide an appropriate aspect of the whole view experienced from these properties, but rather they provide a focussed northern aspect that exaggerates the building's visual presence without reference to the whole aspect experienced from these properties.

Notwithstanding this, the images offer a number of insights that are relevant.

- They illustrate that a small portion of distant aspects of Bondi will experience a minor interruption from the proposed development.
- The properties identified are 200m metres away (three street blocks) from the subject site and the aspect over the proposed building (and approved building next door) is to an element 700m away from these properties.
- The interruption caused by the additions at 58 Campbell Parade, as <u>approved with Council's agreement</u> in the Land and Environment Court (LEC) are, by comparison to the proposed development, far more significant than we propose. In both cases, the impacts are not sufficient to warrant deletion of the top level, as Council agreed next door, as the proposed built form offers an alternative arrangement of compliant floor space on these buildings. This is an established practice accepted by the LEC in judgements at 10-14 Hall Street and 31-33 Hall Street, as well as by agreement at the neighbouring 58 Campbell Parade.
- The scale of the approved development at 58 Campbell Parade is 5-6 storeys when viewed from the rear given the top level's minimal setback from the levels below, whilst the scale of the proposed development at 56 Campbell Parade is part 4, part 5 storeys, with a smaller part additional floor above and a substantial setback from the rear.

This meets the height development standard objectives which seek to ensure preservation of amenity and "if appropriate, the sharing of views". The LEP standard does not require a preservation of views, nor do the LEC Tenacity Principles support ultimate preservation. They require sharing of views, if appropriate. In this case, the appropriateness of sharing views from properties three street blocks away from the site, to relatively and proportionately insignificant snippets of Bondi 700m away, has a reduced threshold for reasonableness, and the 'sharing' of those views offered by this proposal is nevertheless reasonable and appropriate.

With respect to the images offered that purport to the visual impact of the building as viewed from the car park in front of the pavilion, these clearly indicate that the uppermost floor of the proposed development is negligible in the context of surrounding buildings, particularly dwarfed and hidden behind by the long expanse of the approved top floor of the development at 58 Campbell Parade – that approved with Council's agreement in the LEC. The top floor's extension in a horizontal plane is roughly a fifth of that of the neighbouring development, and is visually compatible with the undulating rooftop skyline of Campbell Parade. There is no impact arising from the proposal that is tangible to the scenic quality or heritage values of the Bondi Beach State and National listings.

Further, in response to the comments raised by the DBU that the building may present as 6 storeys in height, the development is predominantly 4 or 5 storeys in scale, viewed as 4 storeys from the Campbell Parade frontage with a 5th setback level visible only from distant angles, and presents as 4-5 storeys at the rear due to the significant rear setback of the top level. There are physically no areas of the public domain from which this building can be seen as having 6 storeys. At its greatest, the building is visually 5 storeys in height from anywhere in the public domain. By contrast, the approved development at 58 Campbell Parade can be seen as 6 storeys (1-2 more than the proposal) from the rear lane and the pavilion carpark, and presents as 5 storeys (1 more than the proposal) from in front of the site on Campbell Parade.

Our proposal offers a compliant FSR, arranged appropriately on the site commensurate with surrounding development, and facilitates the retention of the significant frontage of the existing building to ensure it provides an ongoing architectural legacy to the curtilage of Bondi Beach.

The Council Assessment Planner agrees with the applicant, that images provided by Council are not compliant with the LEC view assessment protocols or photomontage policy. This policy states that accurate Survey data must be used, this is not the case for **Figure 16**, as the plans were not certified by a registered surveyor.

Additionally, Edward and Francis Streets are between 100m – 180m from the subject site and the view of the Bondi Pavilion is 450m on the other side of the subject site. Therefore, it is extremely difficult to protect these views when the zoning allows for larger buildings along Campbell Parade. In addition, the 3D modelling (despite its accuracy) shows that views of the beach and water will not be lost, which is of a higher value than the Bondi Pavilion building.



Figure 17. Aerial map showing distance between Francis and Edward Streets and the Bondi Pavilion in context of the subject site. (Source: Nearmap, 2023)

2.2. Other Impacts of the Development

The proposal is considered to have no significant detrimental effect relating to environmental, social or economic impacts on the locality, subject to appropriate conditions being imposed.

2.3. Suitability of the Site for the Development

The site is considered suitable for the proposal.

2.4. Any Submissions

The application was notified for 28 days from 12 September – 12 October 2022 and a site notice erected on the site in accordance with the *Waverley Community Development Participation and Consultation Plan*.

Following receipt of amended plans and additional information, the application was re-notified for 14 days from 13 – 29 June 2023 and a site notice erected on the site in accordance with the *Waverley Community Development Participation and Consultation Plan*.

A total of five unique submissions were received from the following properties:

Table 8: Number of and where submissions were received from.

Count	Property Address
1-2	7/54 Campbell Parade, Bondi Beach
3	10 & 11/54 Campbell Parade, Bondi Beach
4	Unknown
5	Unknown
6	16/54 Campbell Parade, Bondi Beach

The following issues raised in the submissions have already been discussed and addressed in the body of this report and/or the Recommendation:

- Breach to height
- Building separation (as per the ADG)
- Side and rear setbacks
- Bondi Beach precinct (as per the DCP)
- Loss of visual privacy
- Overshadowing
- Excavation

All other issues raised in the submissions are summarised and discussed below.

Issue: Noise from construction.

Response: The standard industry hours of construction are recommended to be imposed via condition.

Issue: Damage to property by drilling/excavation.

Response: Appropriate excavation related conditions are recommended for imposition.

Issue: Impact from Construction Traffic.

Response: A Construction Traffic Management Plans is recommended to be provided and approved by Council's Traffic Engineer prior to works commencing.

Issue: Should not demolish building due to its character

Response: The front façade of the dwelling is being retained to maintain its historic character.

Issue: Destruction of tree canopy.

Response: Tree removal is not proposed as part of this application. Regardless, tree protection conditions are recommended.

2.5. Public Interest

The proposal is considered to have no detrimental effect on the public interest, subject to appropriate conditions being imposed.

3. REFERRALS

The following internal and external referral comments were sought:

3.1. Fire Safety

An internal referral was sought from Council's Fire Safety Officer, who recommended conditions of consent.

3.2. Heritage

An internal referral was sought from Council's Heritage Officer who reviewed the original submitted plans and advised the following:

• <u>Heritage Officer:</u> The proposed top floor addition has a significant impact on these buildings viewed from Bondi Park opposite.

<u>Planners Comment:</u> The first floor addition is setback from the level below with greater side setbacks. This aids in reducing the bulk and scale of the fourth level. Additionally, the proposed fourth level has been justified as outlined in this report.

• <u>Heritage Officer:</u> Any consent to exceed the height limit must be predicated on the additional height being of a recessive and not a dominant or prominent form.

Planners Comment: See comment above.

<u>Heritage Officer:</u> Extended rising or level eaves should not be approved and where sun shading
to windows and doors is required this should be achieved with shades projecting out at a lower
level [e.g. door head height at 2100-2200mm]. Similarly, any roof form should be recessive as
shown on the applicant's comparative example where the roof slopes up from the outer front
edge.

<u>Planners Comment:</u> The development will be required to meet the BASIX and NaTHERs threshold.

• <u>Heritage Officer:</u> Material and colour finishes are to mitigate the visual impact of the form- dark grey/black cladding is not to be used.

<u>Planners Comment:</u> A condition is recommended that the finalised materials and finishes is to be approved by Council.

Amended referral comments were not sought on the amended proposal as the original comments raised no significant heritage related design concerns.

3.3. Urban Design

An internal referral was sought from Council's Urban Design Officer who advised the following:

• <u>Urban Design Officer:</u> The top floor is removed in order to comply with the Height control and reduce the extent of the bulk.

<u>Planners Comment:</u> A detailed analysis of level 4 has been completed above and it is deemed acceptable.

• <u>Urban Design Officer:</u> View loss impacts from the buildings at Edward Street and Francis Street are considered.

<u>Planners Comment:</u> View loss impacts have been discussed above.

<u>Urban Design Officer:</u> The whole additions at the top are redesigned in order to provide a better
integration with the retained façade in terms of proportions of solids to voids on Campbell
Parade.

<u>Planners Comment:</u> The proposed integration is deemed acceptable. The front façade of the existing building is retained with the upper level additions recessed from the existing retained front building line.

• <u>Urban Design Officer:</u> To reduce the visual impact of the fourth floor Campbell parade façade by reducing the size and singularity of the opening.

<u>Planners Comment:</u> A condition is recommended that the Level 3 opening is reduced.

• <u>Urban Design Officer:</u> Use sympathetic materials whilst clearly differentiating the old from the new.

<u>Planners Comment:</u> A condition is recommended that the finalised materials and finishes is to be approved by Council's Urban Design Manager.

3.4. Strategic Planning

An internal referral was sought from Council's Strategic Planning Department who did not object to the proposal.

3.5. Biodiversity

An internal referral was sought from Council's Biodiversity Officer who recommended conditions of consent.

3.6. Waste Management

An internal referral was sought from Council's Waste Officer who recommended conditions of consent.

3.7. Sustainable Development

An internal referral was sought from Council's Sustainability Officer who recommended conditions of consent.

3.8. Health Management

An internal referral was sought from Council's Health Officer who recommended conditions of consent.

3.9. GIS

An internal referral was sought from Council's GIS Officer who recommended conditions of consent.

3.10. Traffic

An internal referral was sought from Council's Traffic Engineer who recommended conditions of consent.

Council's Traffic Engineer advised the proposed ramp with a grade of 1:8 for the first 3 metres into the property and 1:4 thereafter is not acceptable. It does not provide a safe position for exiting drivers to pause and check for other vehicles and pedestrians prior to leaving the site.

Modified plans are required with the ramp gradient at a maximum of 5% for the first 4.5 metres into the property. A minimum headroom of 2.2 metres is to be provided for the modified ramp.

Conditions to this effect are recommended for imposition.

3.11. Stormwater

An internal referral was sought from Council's Stormwater Engineer who recommended conditions of consent.

3.12. Public Domain

An internal referral was sought from Council's Public Domain Engineer who recommended conditions of consent.

3.13. Tree Management

An internal referral was sought from Council's Tree Officer who did not object to the proposal.

3.14. Design Excellence Advisory Panel (DEAP)

An external referral was sought from DEAP. Their comments are outlined within Table 1 of this report.

4. CONCLUSION

The DA seeks consent for Integrated development for Water NSW for retention to the front of the existing building, demolition and construction of a shop-top housing building containing retail (over 3 split level), with four units above at the site known as 56 Campbell Parade, Bondi Beach.

The principal issues arising from the assessment of the application are as follows:

- Breach to building height;
- Appropriateness of fourth floor (level 5); and
- Retention of existing front façade / structural stability.

The assessment finds these issues acceptable.

The breach to building height was deemed acceptable as a well-founded Clause 4.6 Variation was provided with the application, which demonstrated that despite the breach to height the development met the objectives of both height and the zone within the Waverley LEP 2012. In addition, due to the precedents of the recently approved fourth level at 58 Campbell Parade the proposed fourth floor was also deemed acceptable.

A total number of six submissions were received and the issues raised in the submissions have been considered and addressed in this report and in the recommendation.

The application has been assessed against the relevant matters for consideration under section 4.15(1) of the *Environmental Planning and Assessment Act 1979*. It is recommended for approval subject to conditions of consent. General terms of approval have been granted by Water NSW and are included in the list of recommended conditions.

5. RECOMMENDATION TO WAVERLEY LOCAL PLANNING PANEL

That the development application be APPROVED by the Waverley Local Planning Panel subject to the conditions in Appendix A.

Report prepared by:	Application reviewed and agreed by:	Application reviewed and agreed by:
J/9muille		
Joseph Somerville	Bridget McNamara	Angela Rossi
Senior Development	Manager, Development	A/Executive Manager,
Assessment Planner	Assessment	Development Assessment
Date: 27 July 2023	Date: 11 August 2023	Date: 1 September 2023

Reason for WLPP referral:

- 1. Departure from any development standard in an EPI by more than 10%
- 2. Sensitive development:
 - (a) Designated development
 - (b) SEPP 65 development

OFFICE USE ONLY

Clause 4.6 register entry required	14% variation to height (Clause 4.3)				
	Pre-existing non-compliance				
		No change to overall building height			
		Variation limited to the [lift/plant/parapet/attic]			
	X	No unreasonable impacts on the amenity of adjoining properties or streetscape			
	Х	Sufficient environmental planning grounds			
	Х	Consistent with the objective of the standard			
Determining Authority (Concurrence Authority for Clause 4.6 variation)		Local Planning Panel			
Affordable Rental Housing Units?	No				

Secondary Dwelling	No
Boarding House	No
Group Home	No
Trial Period database entry required	No
VPA submitted – follow up actions required	No
Refer to compliance for investigation	No
Commercial/liquor operational conditions	No
Other (please specify):	No

APPENDIX A – CONDITIONS OF CONSENT

A. APPROVED DEVELOPMENT

1. APPROVED PLANS AND DOCUMENTATION

The development must be in accordance with:

(a) Architectural Plans prepared by AN+A of Project No: CAM2105 including the following:

Plan Number and	Plan description	Plan Date	Date received by		
Revision			Council		
DA006 / Rev C	Site Plan – Proposed	30/05/2023	09/06/2023		
DA010 / Rev A	Existing + Demolition – Lower	18/08/2022	09/06/2023		
	Ground Floor				
DA011 / Rev A	Existing + Demolition – Ground	18/08/2022	09/06/2023		
	Floor				
DA012 / Rev A	Existing + Demolition – First Floor	18/08/2022	09/06/2023		
DA013 / Rev A	Existing + Demolition – Roof Plan	18/08/2022	09/06/2023		
DA014 / Rev B	Proposed – Basement 2	14/02/2023	09/06/2023		
DA015 / Rev B	Proposed – Basement 1	14/02/2023	09/06/2023		
DA016 / Rev B	Proposed – Lower Ground	14/02/2023	09/06/2023		
DA017 / Rev C	Proposed – Ground Floor	30/05/2023	09/06/2023		
DA018 / Rev B	Proposed – First Floor Plan	30/05/2023	09/06/2023		
DA019 / Rev B	Proposed – Second Floor Plan	30/05/2023	09/06/2023		
DA020 / Rev C	Proposed – Third Floor Plan	30/05/2023	09/06/2023		
DA021 / Rev C	Proposed – Fourth Floor Plan	30/05/2023	09/06/2023		
DA022 / Rev C	Proposed – Roof Plan	30/05/2023	09/06/2023		
DA150 / Rev C	Proposed – East Elevation	30/05/2023	09/06/2023		
DA151 / Rev C	Proposed – West Elevation	30/05/2023	09/06/2023		
DA152 / Rev B	Proposed – North Elevation	30/05/2023	09/06/2023		
DA153 / Rev B	Proposed – South Elevation	30/05/2023	09/06/2023		
DA170 / Rev C	Section A – Long Section	30/05/2023	09/06/2023		
DA171/ Rev C	Section B – Cross Section	30/05/2023	09/06/2023		

- (b) Geotechnical Report (344263Lrpt) prepared by JK Geotechnics, dated 03/09/2021 and received by Council 01/09/2023.
- (c) Acoustic Report (20211076.1/2207A/R1/RG) prepared by Acoustic Logic, dated 22/07/2022 and received by Council 01/09/2023.
- (d) Access Report prepared Morris Goding Access Consulting, dated 22/08/2022 and received by Council 01/09/2023.
- (e) BCA Report (MSA2411_BCA)) prepared by Matt Shuter and Associates, dated 19/08/2022 and received by Council 01/09/2023.
- (f) Flood Risk Management Report (210445) prepared by NB Consulting Engineers, dated 17/08/2022 and received by Council 01/09/2023.

- (g) Heritage Impact Statement (J4720) prepared by Weir Phillips Heritage and Planning, dated 02/08/2022 and received by Council 01/09/2023.
- (h) Traffic and Transport Management Plan (21399) prepared by Varga Traffic Planning Pty Ltd, dated 03/09/2021 and received by Council 23/08/2023.
- (i) BASIX and NatHERs Certificate/s
- (j) The Site Waste and Recycling Management Plan (SWRAMP) Part 1 received by Council on 01/09/2022.

Except where amended by the following conditions of consent.

2. GENERAL MODIFICATIONS – URBAN DESIGN / HERITAGE RESTORATION

The proposal shall be amended as follows:

- (a) The Level 3 frontage to Campbell Parade is to be amended to reduce the roof corbelling as it dominates the façade at this level.
- (b) The awning to Campbell Parade is to be extended in depth to be set back 0.6m from the Campbell Parade kerb line. The awning corners are to be squared-off.
- (c) A detailed Schedule of Conservation Works prepared by a suitably qualified heritage architect and dealing in detail with the restoration and conservation of the façade of the building is to be submitted for approval by Council's Heritage Officer.
- (d) A detailed report prepared by a suitably qualified engineer with the input of a suitable qualified Heritage Architect is to be submitted for approval by Council's Heritage Architect which:
 - i. Outlines the methodology for retention and conservation of the façade of the building and retained structure including sidewalls.
 - ii. Includes a methodology to ensure the stability and viability of the parapet during construction and its tying back into the new slab, and
 - iii. Ensures the structural stability of the façade arising from the insertion of the approved building form and openings into the existing façade.
- (e) A schedule of external materials and finishes and design details of all elements of the building façade, including materials for structure on the roof terrace. The new materials are to provide a variance to differentiate between the retained facade and the new building;
- (f) Large-scale detailed sections illustrating the construction of the roof, facades, method of fixing privacy screens, shading devices, balconies, planters and balustrades and major junctions between materials;
- (g) Detailed drawings of the shop fronts, entry foyers, awnings, window operation.

The amendments are to be approved by the **Council's Manager of Urban Design (or delegate)** prior to the issue of any Construction Certificate. An electronic copy of the amended plans or additional information (see website for electronic document requirements) addressing this condition, including a covering letter shall be provided to Council for review.

3. GENERAL MODIFICATIONS – VEHICLE ACCESS

The proposal shall be amended as follows:

- (a) The proposed ramp with a grade of 1:8 for the first 3 metres into the property and 1:4 thereafter is not acceptable. It does not provide a safe position for exiting drivers to pause and check for other vehicles and pedestrians prior to leaving the site.
- (b) Modified plans are required with the ramp gradient at a maximum of 5% for the first 4.5 metres into the property.
- (c) The headroom clearance on entry, on the ramp, and on the basement level is to be a minimum of 2.2 metres.

The amendments are to be approved by the **Council's Traffic Engineer** prior to the issue of any Construction Certificate. An electronic copy of the amended plans or additional information (see website for electronic document requirements) addressing this condition, including a covering letter shall be provided to Council for review.

4. INFRASTRUCTURE SERVICES

Evidence from Ausgrid confirming that an electricity substation is not required. In the event that a substation is required, details of the proposed location are to be submitted for approval along with amended plans accommodating any layout changes. No facility is to be provided along the Campbell Parade frontage.

5. GENERAL TERMS OF APPROVAL - WATER NSW

- (a) Groundwater must only be pumped or extracted for the purpose of temporary construction dewatering at the site identified in the development application. For clarity, the purpose for which this approval is granted is only for dewatering that is required for the construction phase of the development and not for any dewatering that is required once construction is completed.
- (b) Before any construction certificate is issued for any excavation under the development consent, the applicant must: 1. Apply to WaterNSW for, and obtain, an approval under the Water Management Act 2000 or Water Act 1912, for any water supply works required by the development; and 2. Notify WaterNSW of the programme for the dewatering activity to include the commencement and proposed completion date of the dewatering activity Advisory Note: 3. An approval under the Water Management Act 2000 is required to construct and/or install the water supply works. For the avoidance of doubt, these General Terms of Approval do not represent any authorisation for the take of groundwater, nor do they constitute the grant or the indication of an intention to grant, any required Water Access Licence (WAL). A WAL is required to lawfully take more than 3ML of water per water year as part of the dewatering activity. 4. A water use approval may also be required, unless the use of the water is for a purpose for which a development consent is in force.
- (c) A water access licence, for the relevant water source, must be obtained prior to extracting more than 3ML per water year of water as part of the construction dewatering activity. Advisory Notes:

 1. This approval is not a water access licence. 2. A water year commences on 1 July each year. 3. This approval may contain an extraction limit which may also restrict the ability to take more than 3ML per water year without further information being provided to WaterNSW. 4. Note that certain water sources may be exempted from this requirement see paragraph17A, Schedule 4 of the Water Management (General) Regulation 2018.

- (d) If no water access licence is obtained for the first 3ML / year (or less) of water extracted, then, in accordance with clause 21(6), Water Management (General) Regulation 2018, the applicant must: (a) record water taken for which the exemption is claimed, and (b) record the take of water not later than 24 hours after water is taken, and (c) make the record on WAL exemption form located on WaterNSW website "Record of groundwater take under exemption", and (d) keep the record for a period of 5 years, and I give the record to WaterNSW either via email to Customer.Helpdesk@waternsw.com.au or post completed forms to PO Box 398 Parramatta NSW 2124 (i) not later than 28 days after the end of the water year (being 30 June) in which the water was taken, or (ii) if WaterNSW directs the person in writing to give the record to WaterNSW on an earlier date, by that date.
- (e) All extracted groundwater must be discharged from the site in accordance with Council requirements for stormwater drainage or in accordance with any applicable trade waste agreement.
- (f) The design and construction of the building must prevent: (a)any take of groundwater, following the grant of an occupation certificate (and completion of construction of development), by making any below-ground levels that may be impacted by any water table fully watertight for the anticipated life of the building. Waterproofing of below-ground levels must be sufficiently extensive to incorporate adequate provision for unforeseen high water table elevations to prevent potential future inundation; (b)obstruction to groundwater flow, by using sufficient permanent drainage beneath and around the outside of the watertight structure to ensure that any groundwater mounding shall not be greater than 10 % above the pre-development level; and (c)any elevated water table from rising to within 1.0 m below the natural ground surface.
- (g) Construction phase monitoring bore requirements GTA: a) A minimum of three monitoring bore locations are required at or around the subject property, unless otherwise agreed by WaterNSW.
 B) The location and number of proposed monitoring bores must be submitted for approval, to WaterNSW with the water supply work application. c) The monitoring bores must be installed and maintained as required by the water supply work approval. D) The monitoring bores must be protected from construction damage.
- (h) Construction Phase Monitoring programme and content: a) A monitoring programme must be submitted, for approval, to WaterNSW with the water supply work application. The monitoring programme must, unless agreed otherwise in writing by WaterNSW, include matters set out in any Guide published by the NSW Department of Planning Industry and Environment in relation to groundwater investigations and monitoring. Where no Guide is current or published, the monitoring programme must include the following (unless otherwise agreed in writing by WaterNSW): i. Pre-application measurement requirements: The results of groundwater measurements on or around the site, with a minimum of 3 bore locations, over a minimum period of 3 months in the six months prior to the submission of the approval to WaterNSW. Ii. Field measurements: Include provision for testing electrical conductivity; temperature; pH; redox potential and standing water level of the groundwater; iii. Water quality: Include a programme for water quality testing which includes testing for those analytes as required by WaterNSW; iv. QA: Include details of quality assurance and control v. Lab assurance: Include a requirement for the testing by National Association of Testing Authorities accredited laboratories. B) The applicant must comply with the monitoring programme as approved by WaterNSW for the duration of the water supply work approval (Approved Monitoring Programme)
- (i) Prior to the issuing of the occupation certificate, and following the completion of the dewatering activity, and any monitoring required under the Approved Monitoring Programme, the applicant

must submit a completion report to WaterNSW. (b) The completion report must, unless agreed otherwise in writing by WaterNSW, include matters set out in any guideline published by the NSW Department of Planning Industry and Environment in relation to groundwater investigations and monitoring. Where no guideline is current or published, the completion report must include the following (unless otherwise agreed in writing by WaterNSW): 1) All results from the Approved Monitoring Programme; and 2) Any other information required on the WaterNSW completion report form as updated from time to time on the WaterNSW website. C) The completion report must be submitted using "Completion Report for Dewatering work form" located on WaterNSW website www.waternsw.com.au/customer-service/water-licensing/dewatering

- (j) The extraction limit shall be set at a total of 3ML per water year (being from 1 July to 30 June). The applicant may apply to WaterNSW to increase the extraction limit under this condition. Any application to increase the extraction limit must be in writing and provide all information required for a hydrogeological assessment. Advisory note: Any application to increase the extraction limit should include the following: Groundwater investigation report describing the groundwater conditions beneath and around the site and subsurface conceptualisation Survey plan showing ground surface elevation across the site Architectural drawings showing basement dimensions Environmental site assessment report for any sites containing contaminated soil or groundwater (apart from acid sulphate soils (ASS)) Laboratory test results for soil sampling testing for ASS If ASS, details of proposed management and treatment of soil and groundwater. Testing and management should align with the NSW Acid Sulphate Soil Manual
- (k) Any dewatering activity approved under this approval shall cease after a period of two (2) years from the date of this approval, unless otherwise agreed in writing by WaterNSW (Term of the dewatering approval). Advisory note: an extension of this approval may be applied for within 6 months of the expiry of Term.
- (I) This approval must be surrendered after compliance with all conditions of this approval, and prior to the expiry of the Term of the dewatering approval, in condition GT0151-00001. Advisory note: an extension of this approval may be applied for within 6 months of the expiry of Term.
- (m) The following construction phase monitoring requirements apply (Works Approval): a. The monitoring bores must be installed in accordance with the number and location shown, as modified by this approval, unless otherwise agreed in writing with WaterNSW. B. The applicant must comply with the monitoring programme as amended by this approval (Approved Monitoring Programme). C. The applicant must submit all results from the Approved Monitoring Programme, to WaterNSW, as part of the Completion Report

6. MULTI UNIT HOUSING DEVELOPMENT DESIGN

The approved design (including any element or detail of that design) or materials, finish or colours of the building must not be changed without the written approval of Council.

7. PUBLIC DOMAIN IMPROVEMENTS

The public domain is to be upgraded on both Campbell Parade and Lamrock Place frontages for the development site in accordance with the current Waverley Council Development Control Plan (DCP) and Public Domain Technical Manual (PDTM) at the time of engineering plan approval. A public domain plan for the following works shall be submitted to Council, and approved by the Executive Manager, Infrastructure Services (or delegate) prior to the issue of the relevant Construction Certificate.

(a) Pedestrian footpath

- (b) Vehicular crossing
- (c) Road pavement
- (d) Kerb and gutter
- (e) Stormwater infrastructure located within the Council kerb and/or footpath

B. PRIOR TO THE ISSUE OF A CONSTRUCTION CERTIFICATE

The requirements outlined in this section are to be provided to the satisfaction of the Principal Certifying Authority in all instances, except where a condition explicitly specifies the approval of Council or a Council Officer is required.

GENERAL REQUIREMENTS

8. NO BUILDING OR DEMOLITION WORKS PRIOR TO RELEASE OF CONSTRUCTION CERTIFICATE

The building work, or demolition work, must not be commenced until:

- (a) a Construction Certificate has been obtained from Council or an Accredited Certifier in accordance with the *Environmental Planning and Assessment Act 1979*;
- (b) a Principal Certifying Authority has been appointed and Council has been notified of the appointment in accordance with the *Environmental Planning and Assessment Act 1979* and *Environmental Planning and Assessment Regulation 20210*; and
- (c) Council is given at least two days' notice in writing of the intention to commence the building works.

CONTRIBUTIONS, FEES & BONDS

9. SECTION 7.12 CONTRIBUTION

A monetary development contribution is payable to Waverley Council pursuant to section 7.12 of the *Environmental Planning and Assessment Act 1979* and the Waverley Council Development Contributions Plan in accordance with the following:

- (a) Where the total development cost is less than \$500,000:
 - a. a **Cost Summary Report** or **Building Contract** or similar is to be submitted to Council's Customer Service Centre to process payment.
- (b) Where the total development cost is \$500,000 or more:

number to satisfy.

- a. a **Detailed Cost Report** prepared by a registered Quantity Surveyor, **Building Contract**, or similar is to be submitted to and approved by Council's Executive Manager, Urban Planning, Policy and Strategy (or delegate).

 Please forward documents to info@waverley.nsw.gov.au attentioned to Strategic Planning, and reference the relevant application number, address and condition
- b. Upon confirmation of the contribution amount by Council's Executive Manager, Urban Planning, Policy and Strategy (or delegate), payment is to be processed via the Customer Service Centre.
- c. Should there be a discrepancy between the cost of works approved in subclause (b)(i) and the DA fee nominated in the original DA, then additional DA Fees may be payable prior to the issue of a Construction Certificate.

A copy of the required format for the cost reports are provided in the Waverley Council Contributions Plan, available on Council's website.

- (c) As legislated in section 209 of the Environmental Planning and Assessment Regulation 2021, the levy must be paid in accordance with the following;
 - (i) A development valued at \$100,000 or less will be exempt from the levy;
 - (ii) A development valued at \$100,001 \$200,000 will attract a levy of 0.5% of the <u>full</u> cost of the development; or
- (iii) A development valued at more than \$200,000 will attract a levy of 1% of the <u>full</u> cost of the development.

Prior to the issue of any Construction Certificate, evidence must be provided that the levy has been paid to Council in accordance with this condition or that the cost of works is less than \$100,000.

10. SECURITY DEPOSIT

A deposit (cash or cheque) for the amount of \$100,79.20 must be provided to Council for any damage caused to any property of the consent authority (ie. public land) as a consequence of the works and completing any public work (such as road work, kerbing and guttering, footway construction, stormwater drainage and environmental controls) required in connection with the consent.

This deposit (cash or cheque) must be provided to Council prior to the issue of any Construction Certificate. The full amount of the deposit, minus Council's costs for any repair of damage to Council property or rectification of unauthorised works on Council property, will be refunded after satisfactory completion all of works associated with this consent (including the required public works) to the person who paid the deposit.

11. LONG SERVICE LEVY

A long service levy, as required under section 34 of the *Building and Construction Industry Long Service Payments Act, 1986*, is to be paid in respect of this building work. Evidence that the levy has been paid is to be submitted to the Principal Certifying Authority prior to the issue of any Construction Certificate.

<u>Note</u>: Council acts as an agent for the Long Service Payment Corporation and the levy may be paid at Council's office. The levy rate is 0.25% of building work costing \$250,000 or more.

12. ENGINEERING PLANS ASSESSMENT AND WORKS INSPECTION FEES

The applicant is to pay to Council fees for assessment of all engineering plans and inspection of the completed works in the public domain inclusive of all stormwater assessment, in accordance with Council's Schedule of Fees & Charges at the time of engineering plan approval, prior to such approval being granted by Council.

An invoice will be issued to the applicant for the amount payable, which will be calculated based on the design plans for the subject development.

PLAN DETAILS

13. VERIFICATION OF CONSTRUCTION CERTIFICATE DOCUMENTATION (SEPP 65 BUILDINGS)

The preparation of the construction certificate plans shall be supervised and be to the satisfaction of an architect who is registered in accordance with the *Architects Act 2003* (i.e. a qualified designer) in

accordance with the requirements of the State Environmental Planning Policy No. 65 - Design Quality of Residential Apartment Development.

In accordance with the Environmental Planning and Assessment Regulation 20210, the Principal Certifying Authority must not issue a construction certificate unless it has received a design verification statement from a qualified designer which verifies that the construction certificate plans and specifications achieve or improve the design quality of the development for which development consent was granted, having regard to the design quality principles set out in *State Environmental Planning Policy No. 65 Design Quality of Residential Apartment Development*.

14. PROVISION FOR SHAFT FOR FUTURE FOOD PREMISES

Adequate provision shall be made within the confines of the building, for the installation of a mechanical exhaust system for future food/commercial use/s within the building.

15. BASEMENT STORAGE

The basement level/s are to provide separate and secure storage areas (in the form of lockable storage cages or the like), allocated to each apartment in the development for larger bulkier items (surfboards, boxes, camping equipment etc.) which are not suited to be stored within each individual apartment. Storage is to be allocated to individual units in accordance with the requirements of the Waverley Development Control Plan 2022.

CONSTRUCTION MATTERS

16. HOARDING

To ensure the site is contained during construction, a hoarding is required for the approved works, which is to be designed and constructed in accordance with the requirements of Safe Work NSW. Where the hoarding is to be erected over the footpath or any public place, the approval of Council's Compliance Unit must be obtained and the applicable fees paid, prior to the erection of the hoarding.

17. EROSION & SEDIMENT CONTROL

A Soil and Water Management Plan (SWMP), also known as an Erosion and Sediment Control Plan must be prepared in accordance with Waverley Council's Water Management Technical Manual.

The SWMP must be approved by the Principal Certifying Authority prior to the issue of a Construction Certificate. A copy of the SWMP must be kept on site at all times and made available to Council officers upon request.

The recommendations of the SWMP must be implemented and maintained during all construction activities and until the site is fully stabilised following construction.

18. DETAILS OF EXCAVATION, SHORING OR PILE CONSTRUCTION

A report shall be prepared by a suitably qualified and practising Structural Engineer/Geotechnical Engineer detailing the proposed methods of bulk excavation, shoring or pile construction, including details of vibration emissions and any possible damage which may occur to adjoining or nearby properties as a result of the proposed building and excavation works.

Any practices or procedures specified in the Structural Engineer's report in relation to the avoidance or minimisation of structural damage to adjoining properties are to be fully complied with and incorporated into the plans and specifications together with the Construction Certificate.

19. ENGINEERING DETAILS

Structural details are to be prepared and certified by a practicing Structural Engineer in connection with all structural components of the approved works, prior to the issue of the relevant Construction Certificate.

20. DILAPIDATION REPORT

A Dilapidation report is to be prepared for any adjoining or nearby property that may be subject to potential damage as a result of any works being undertaken. The dilapidation report is be made available to affected property owners.

The report is to be dated, submitted to, and accepted by the Principal Certifying Authority, prior to any work commencing on the site.

Note: Any damage that may be caused is a civil matter. This consent does not allow or authorise any party to cause damage, trespass, or any other unlawful act and Council will not be held responsible for any damage that may be caused to adjoining buildings as a consequence of the development being carried out. Council will not become directly involved in disputes between the builder, owner, developer, its contractors and the owners of neighbouring buildings.

21. SYDNEY WATER SECTION 73 COMPLIANCE CERTIFICATE APPLICATION

An application to obtain a Section 73 Compliance Certificate under the *Sydney Water Act 1994* must be made prior to the issue of the relevant Construction Certificate. The application must be made through an authorised Water Servicing Coordinator.

For more information about making an application to obtain a Section 73 Compliance Certificate, please consult Sydney Water's website.

Following this application, a "Notice of Requirements" will be provided by Sydney Water that outlines any requirements of works to be completed prior to the issue of the Section 73 Compliance Certificate. Please make early contact with the Coordinator, as building of water/sewer extensions can be time consuming and may impact on other services and building, driveway or landscape design.

A Section 73 Compliance Certificate must be issued from Sydney Water prior to the issue of an occupation certificate.

22. BONDI - ROSE BAY SAND BODY

This site may be located within the Bondi - Rose Bay Sand Body as identified in Council's Aboriginal Cultural Heritage Study 2009. After demolition of the existing building and prior to any excavation, a suitably qualified archaeologist must inspect the site to determine if the site needs further investigation. Should an object of potential Aboriginal or archaeological significance be discovered during the demolition, excavation or construction period associated with this development, works are to immediately cease and the NSW National Parks and Wildlife Service must be contacted.

Waverley Council must be notified of any referral to the NSW National Parks and Wildlife Service and be provided with a copy of any subsequent response.

23. TELECOMMUNICATIONS IN NEW RESIDENTIAL FLAT BUILDING AND MIXED USE DEVELOPMENTS

Evidence is to be provided to the Principal Certifier that arrangements have been made for;

- (a) The installation of fibre-ready facilities to all individual lots and/or premises to enable fibre to be readily connected to any premises that is being or may be constructed on those lots. Demonstrate that the carrier has confirmed in writing that they are satisfied that the fibre ready facilities are fit for purpose; and
- (b) The provision of fixed-line telecommunications infrastructure in the fibre-ready facilities to all individual lots and/or premises demonstrated through an agreement with a carrier.

TRAFFIC MANAGEMENT

24. CONSTRUCTION TRAFFIC MANAGEMENT PLAN (CTMP)

The applicant is to submit a Construction Traffic Management Plan (CTMP) for the approval of Council's Executive Manager, Infrastructure Services, or delegate, prior to the issue of any Construction Certificate. For further information on what is required in the CTMP, please refer to Council's website at:

https://www.waverley.nsw.gov.au/building/development_applications/post_determination/development_applications - conditions of consent_

STORMWATER & FLOODING

25. STORMWATER AND PUBLIC INFRASTRUCTURE MANAGEMENT

To ensure that stormwater runoff from the development is drained in an appropriate manner, without impact to neighbouring properties and downstream systems, a detailed plan and certification of the development's stormwater management system must be submitted and approved by the Executive Manager, Infrastructure Services (or delegate) prior to the issue of the relevant Construction Certificate.

The submitted Water Management Plan prepared by NB Consulting, Job No. 210445, Drawing No. D01-D06, dated 01/09/2022 is considered concept only.

The applicant must submit plans and specifications to comply with the current Waverley Council Water Management Technical Manual and Development Control Plan (DCP) at the time of engineering plan approval. The submitted plans shall be prepared by a suitably qualified and practising Civil Engineer and address the following:

- (a) Please complete "Annexure C Stormwater management plan checklist" located in Waverley Council: Water Management Technical Manual, October 2021, Section 15.3.
- (b) The plans shall provide any required On-Site Stormwater Detention (OSD) system and its details e.g. pit dimensions, cross & long sections, significant water invert levels of inlet and outlet pipes, details of Discharge Control Pit, orifice plate details including orifice diameter, depth of water above centreline of orifice etc., pit overflow, OSD plaque, OSD warning sign and catchment plan.
- (c) For pit and pipes:

- i. Please provide pits at all junctions, change of gradient, change of direction, change in diameter, reflux valves, flap valves, orifice plates, debris screening.
- ii. Provide pipe proposed invert levels.
- iii. Grates are to be galvanised steel grid type. Grates are to be of heavy-duty type in areas where they may be subject to vehicle loading.
- iv. Provide calculations of gutter sizing for 1% AEP storm event and min. number of downpipes required.
- v. A grated trench drain shall be provided across the (garage entrance/driveway/street boundary) within private property. Unless otherwise sized by a suitably qualified and practising Engineer, the dimensions of the trench grate shall be no less than 300mm wide by 100mm deep at the shallow end and have a "bottom" slope of 2%. This trench drain shall be connected to an approved drainage system.
- vi. Downpipe alignment not connecting between the First, Second and Third Floor Stormwater Drainage Plans on balcony. Please update accordingly and show connection between floors.

(d) Pump design:

- i. Please provide pump capacity.
- ii. Make sure pump to be designed in accordance with AS/NZS 3500.3:2018 Section 8 and ensure pump meets these requirements.
- iii. The collection system for the pump system must be designed in accordance with the design criteria for gravity drainage and must incorporate adequate buffer storage as recommended by the pump manufacturer or a suitably qualified practitioner.
- iv. Consideration of the consequences of a power failure must be made when sizing the buffer storage.
- v. Show an alarm system to comprise of basement pump-out failure warning sign together with a flashing strobe light and siren installed at a clearly visible location at the entrance of the basement in case of pump failure. Minimum 150mm freeboard from pump out system to all parking spaces and full hydraulic details and pump manufacturers specification to be provided.
- vi. In the event of the failure of both the duty and standby pumps, an overland flow path and/or surcharge and pondage in a suitably visible area must be provided.
- vii. In circumstances where no overland path exists, pondage may be approved in a suitable area. These areas must be sited with a view to minimising the cost of damage to occupiers of the property and include signage warning residents that inundation of the area may occur in the event of a pump failure.
- viii. Provide screening details. All electrical fittings and supply located min. 0.3m freeboard above max. water level and/or overland flow paths.
- (e) Water Sensitive Urban Design
 - i. Provide MUSIC model schematic and results of assessment.
- (f) Provide the Erosion and Sediment Control Plan.
- (g) The stormwater management plan must specify any components of the existing system to be retained and certified during construction to be in good condition and of adequate capacity to convey additional runoff and be replaced or upgraded if required.
- (h) Any affected Council's infrastructure as the result of construction activities within the public domain area, inclusive of stormwater, stormwater outlet/s, kerb and gutter, pavement, grass verges and vehicle crossovers within the extent works shall be replaced as per Waverley Council Public Domain Technical Manual. All associated costs shall be borne by the applicant.

Notes:

- The checklist as set out on pages 68-76 on Council's Water Management Technical Manual (Oct 2021) available online shall be completed and submitted with any revision of Construction Certificate Plan Submission.
- The Applicant is advised to consider the finished levels of the public domain, including new or existing footpaths and pavement prior to setting the floor levels for the proposed development.
- Waverley Council standard drawings for public domain infrastructure assets are available upon request. Details that are relevant may be replicated in the Engineering design submissions however, Council's title block shall not be replicated.
- Prior to commencement of works a security deposit will be made payable to Council to
 ensure any additional damage or unauthorised works within the Council property, not
 conditioned above. Council will reserve the right to withhold the cost of restoring the
 damaged assets from the security deposit should the applicant fail to restore the defects
 to the satisfaction of Council.
- Council's contact for infrastructure assessment: E-mail: <u>assets@waverley.nsw.gov.au</u> or Phone: 9083 8886 (operational hours between 9.30am to 4pm Monday to Friday). The expected duration to review and approve the stormwater management plan may take at least 15 working days from the date of submission.

26. FLOODING REQUIREMENTS

The development must have a net neutral effect on flood behaviour. This includes increasing flood effects elsewhere, loss of flood storage, changes in flood levels, flows and velocities caused by alterations to the flood conveyance, and the cumulative impact of neighbouring developments. To ensure this has been considered, the submitted architectural plans will need to be updated to reflect the following:

- I. A suitably qualified and practicing Engineer must provide a report certifying that development will not increase flood effects elsewhere having regard to loss of flood storage.
- II. All new building materials must be flood resistant or flood compatible to a height of 19.2 m AHD.
- III. All new internal electrical switches, power points or similar utilities liable to flood damage set to freeboard level
- IV. A suitably qualified engineer must certify that any new structure can withstand the forces of floodwater, scour debris, and buoyancy up to and including 19.2 m AHD.
- V. A storage area is to be provided above the RL of 19.2 m AHD for the storage of goods that can be damaged or mobilized by flooding, or goods that have the potential to cause pollution during flooding.
- VI. Any proposed fencing must be built using flood-compatible material.
- VII. There is to be no filling of the land within the property.

Details and certification must accompany the Construction Certificate and be submitted to Waverley Council for approval by Council's Executive Manager, Infrastructure Services (or delegate) prior to the issue of the relevant Construction Certificate.

27. PUBLIC INFRASTRUCTURE WORKS

Public infrastructure works shall be designed and constructed as outlined in this condition of consent. The approved works must be completed to Council's satisfaction at no cost to Council.

Full design engineering drawings to be prepared by a suitably qualified and experienced engineering professional and be submitted to Council for the approval of the Executive Manager, Infrastructure Services (or delegate) prior to the issue of the relevant Construction Certificate.

The Applicant must submit plans and specifications for the following infrastructure works to Council's Public Infrastructure Engineer:

- (d) <u>Road Pavement:</u> The full renewal and reconstruction of asphalt pavement for full road width in Lamrock Place frontage. Details of the road pavement treatments and sub-grade details to be advised by Council.
- (e) <u>Footpath, Kerb and Gutter:</u> Replace all footpath, kerb and gutter traversing both Campbell Parade and Lamrock Place frontages. Any stormwater kerb lintel infrastructure within the extent of kerb and gutter works shall be replaced. Proposed kerb profiles are to be provided to ensure proper connections to existing kerb and gutter along the street frontage.
 - (ii) Any existing or proposed utility pillars on the site frontages to be either underground or inside the property boundary of the proposed development. Applicant must liaise with the relevant authorities for their approval and communicate to Council with written confirmation, before executing any works.
 - (iii) All mains electrical connections to the development must be routed underground. Council will not accept the erection of newly placed electricity columns within the Councils Public Domain to support the new development.

Notes

The Applicant is advised to consider the finished levels of the public domain, including new or existing footpaths and pavement prior to setting the floor levels for the proposed development.

Council's contact for public domain: E-mail: assets@waverley.nsw.gov.au or Phone: 9083 8886 (operational hours between 9.30am to 4.00pm Monday to Friday).

ENERGY EFFICIENCY & SUSTAINABILITY

28. BASIX

All requirements of the BASIX Certificate and NatHERs documentation are to be shown on the Construction Certificate plans and documentation.

29. ENERGY EFFICIENCY

An Energy Assessment Report is to be submitted in accordance with the *Waverley Development Control Plan 2012*, which recommends design solutions to reduce the predicted operational energy demand and greenhouse gas emissions of the proposed development by 30% less than a reference building (i.e. NCC, Section J compliant only). The report is to be submitted and be to the satisfaction of Council's Executive Manager, Environmental Sustainability (or delegate) prior to the issue of a Construction Certificate for any works above ground level.

The construction certificate plans are to incorporate the recommendations of the approved Energy Assessment Report.

30. REFLECTIVITY REPORT

In accordance with Part B16 of the Waverley Development Control Plan 2012, a Reflectivity Report,

prepared by an appropriately qualified person is to be submitted to the Principal Certifying Authority which verifies that the approved development complies with the following;

- (a) The use of glass is a maximum of 60% of the façade surface area at ground floor level and above.
- (b) Reflected solar glare on drivers should not exceed 500 candelas/m2. A candela is the base unit for measuring the intensity of luminance under the International System of Units (SI).
- (c) All panels and elements on vertical façades are to have a maximum specular reflectivity of visible light from normal angles of incidence of 20%.
- (d) Any surface inclined by more than 20 degrees to the vertical (inclined glass awnings or cladding on inclined roofs) are to have a maximum specular reflectivity of visible light from normal angles of incidence of 10%.

If the approved development cannot achieve compliance with the above requirements, a Section 4.55 modification application must be submitted.

WASTE

31. SITE WASTE AND RECYCLING MANAGEMENT PLAN

A Site Waste and Recycling Management Plan (SWRMP) — Part 2 is to be submitted to the Principal Certifying Authority prior to the issue of the relevant Construction Certificate, which outlines materials to be reused and/or recycled as a result of demolition and construction works. At least one copy of the SWRMP Part 2 is to be available on site at all times during construction. Copies of demolition and construction waste dockets that verify the facility that received the material for recycling or disposal and the quantity of waste received, must be retained on site at all times during construction.

32. WASTE STORAGE AREAS

The development must have a bin storage area with sufficient space to accommodate the following minimum number of bins for the residential and/or commercial components of the development;

Residential

- o 2 x 240L MGBs for general waste (collected weekly)
- o 2 x 240L MGBs for container recycling (collected fortnightly)
- o 2 x 240L MGB for paper recycling (collected fortnightly)
- A room or caged area with a minimum floor space of 4m2 must be provided for the storage of discarded bulky items and problem waste, awaiting collection. Additional space is required for recycling problem waste such as textiles or electronic waste.

Commercial

- o 3 x 240L Mobile Garbage Units (MGBs) for general waste (collected weekly)
- o 3 x 240L MGBs for comingled recycling (collected weekly)
- o Number of bins and frequency of collection must be monitored and adjusted to meet waste generation needs, particular in peak season (summer)
- Sufficient space must be allocated for the storage of reusable items such as crates and pallets associated with the commercial space.

- (a) All waste and recycling storage rooms must be built to meet all appropriate design requirements set in Part B of Waverley Council Development Control Plan 2012. All waste and recycling storage rooms must be graded and drained to the sewerage system and approved by Sydney Water.
- (b) The proposal must have a system for the convenient transportation of waste and recyclables to the storage area and the point of collection.

LANDSCAPING & TREES

33. LANDSCAPE WORKS IN A HABITAT CORRIDOR

An amended landscape plan is to be submitted to and approved by Council's Executive Manager, Environmental Sustainability (or delegate) prior to the issue of any Construction Certificate, with a plant species list having a minimum of 50% of the proposed trees, 50% of the shrubs and 50% of the grasses and groundcovers (not including turfed areas) are to be indigenous or local native plants listed in Annexure B2-1 of the Waverley Development Control Plan 2012.

34. GREEN ROOF LANDSCAPING DETAILS

The construction certificate landscape plans are to comply with the controls for green roofs in Part B3.1 of the *Waverley Development Control Plan 2012* including;

- (a) Comprise plants that are suitable for the site in relation to the environmental conditions (sun, wind and views) and include indigenous or local native plants to Waverley (see Annexure B2 1).
- (b) Have a minimum soil depth of 300mm and use lightweight soil mixes that are porous, able to drain freely, and suitable for the selected plant species.
- (c) The green roof is to be designed to be a non-trafficable area (with no balustrades) and must be irrigated without requiring frequent maintenance access. Any access to the roof is to be for servicing purposes only.

A qualified landscape architect must review the design and verify that it complies with the above requirements.

NOISE AND HEALTH

35. VERMIN AND RAT CONTROL

A *Pest and Vermin Control Management Plan* prepared by a suitable qualified person outlining measures to be taken to reduce rat/vermin populations is to be submitted for the approval of Council's Manager, Health and Compliance (or delegate) prior to the issue of a Construction Certificate for the demolition of existing buildings.

36. NOISE MANAGEMENT PLAN - DEMOLITION, EXCAVATION AND CONSTRUCTION

A site specific Noise Management Plan, prepared by a suitably qualified acoustic consultant (as defined in the advisory section of this consent) must be submitted to the satisfaction of Council's Executive Manager, Compliance (or delegate) for demolition, excavation and construction works.

For further information on the requirements, refer to Council's website:

https://www.waverley.nsw.gov.au/building/development_applications/post_determination/development_applications - conditions of consent_

37. NOISE – ACOUSTIC REPORT

An Acoustic Assessment Report prepared by a suitably qualified acoustic consultant shall be prepared to assess the impacts of the development (internal and external areas) including any mechanical plant, refrigeration motors, pool related plant (pool pump, heater and/or filter) and air conditioning units and make recommendations to ensure that the noise from the development will be within the acceptable limits of the Protection of the Environment Operations Act 1997 and relevant legislation. The plan must be submitted to the satisfaction of Council's Executive Manager, Compliance (or delegate).

Note: Any management measures recommended in the acoustic report shall be incorporated into a

Plan of Management, which will be required to be submitted to Council for approval prior to the issue of an Occupation Certificate.

For further information on the requirements, refer to Council's website:

https://www.waverley.nsw.gov.au/building/development_applications/post_determination/development_applications - conditions of consent_

FIRE SAFETY

38. ESSENTIAL SERVICES - EXISTING BUILDING

Details of the currently implemented and proposed essential fire safety measures shall be submitted to Council, with the Construction Certificate, in the form of a Fire Safety Schedule. This Schedule shall be prepared by a person competent to do so and shall specify the minimum standard of performance for each essential fire safety measure included in the Schedule.

At the completion of the installation, a Final Fire Safety Certificate shall be attached to the Occupation Certificate, certifying that each essential fire safety measure specified within the current Fire Safety Schedule:

- (a) has been assessed by a properly qualified person; and
- (b) found to be capable of performing to at least the standard required by the current Fire Safety Schedule for the building for which the Certificate is issued.

39. FIRE SAFETY

A building in respect of which there is a change of building use must comply with the Category 1 Fire Safety Provisions applicable to the proposed new use.

C. COMPLIANCE PRIOR TO WORK COMMENCING AND DURING CONSTRUCTION

The requirements outlined in this section are to be provided to the satisfaction of the Principal Certifying Authority in all instances, except where a condition explicitly specifies the approval of Council or a Council Officer is required.

PRIOR TO ANY WORKS

40. CONSTRUCTION SIGNS

Prior to commencement of any works on the site and during construction a sign shall be erected on the main frontage of the site detailing the name, address and contact details (including a telephone number) of the Principal Certifying Authority and principal contractor (the coordinator of the building works). The sign shall be clearly legible from the adjoining street/public areas and maintained throughout the building works.

41. USE OF FILL ON SITE

All fill imported on to the site shall be free of building and other demolition waste, and contain virgin excavated natural material (VENM) as defined in Part 3 of Schedule 1 of the Protection of the Environment Operations Act, 1997 and

Sampling and analysis of the fill material should be conducted in accordance with the NSW EPA Sampling Design Guidelines (1995) to ensure that the material is not contaminated.

Any other waste derived material the subject of a resource recovery exemption under cl. 51A of the *Protection of the Environmental Operations (Waste) Regulations 2014* that is permitted to be used as fill material.

Any waste derived material the subject of resource exemption received at the development site must be accompanied by documentation as to the materials compliance with the exemption conditions and must be provided to the Principal Certifying Authority on request.

DEMOLITION & EXCAVATION

42. DEMOLITION – ASBESTOS AND HAZARDOUS MATERIALS

The demolition, removal, storage, handling and disposal of products and materials containing asbestos must be carried out in accordance with the relevant requirements of SafeWork NSW and the NSW Environment Protection Authority (EPA), including:

- Work Health and Safety Act 2011;
- Work Health and Safety Regulation 2017;
- SafeWork NSW Code of Practice for the Safe Removal of Asbestos;
- Australian Standard 2601 (2001) Demolition of Structures;
- Protection of the Environment Operations Act 1997.

At least 5 days prior to the demolition, renovation work or alterations and additions to any building, the person acting on the consent shall submit a Work Plan to the Principal Certifying Authority in accordance with Australian Standard AS 2601-2001, Demolition of Structure and a Hazardous Materials Assessment prepared by a person with suitable expertise and experience. The Work Plan and Hazardous Materials Assessment shall:

- (a) Outline the identification of any hazardous materials, including surfaces coated with lead paint;
- (b) Confirm that no asbestos products are present on the subject land, or
- (c) Particularise a method of safely disposing of the asbestos in accordance with the Code of Practice on how to safely remove asbestos published by SafeWork NSW (catalogue WC03561);
- (d) Describe the method of demolition;
- (e) Describe the precautions to be employed to minimise any dust nuisance; and
- (f) Describe the disposal methods for hazardous materials.

43. CONTROL OF DUST ON CONSTRUCTION SITES

The following requirements apply to demolition and construction works on site:

- (a) Hazardous dust is not to be allowed to escape from the site. The use of fine mesh dust proof screens or other measures are recommended. Any existing accumulations of dust (e.g. ceiling voids and wall cavities) must be removed by the use of an industrial vacuum fitted with a high efficiency particle air (HEPA) filter. All dusty surfaces and dust created from work are to be suppressed by a fine water spray. Water must not be allowed to enter the street and stormwater systems. Demolition is not to be performed during adverse winds, which may cause dust to spread beyond the site boundaries.
- (b) All contractors and employees directly involved in the removal of hazardous dusts and substances are to wear protective equipment conforming to Australian Standard AS1716 Respiratory Protective Devices.

44. CLASSIFICATION OF WASTE/ DISPOSAL OF EXCAVATED SOILS

Prior to the exportation of waste (including fill or soil) from the site the material must be classified in accordance with the provisions of the Protection of the Environment Operations Act, 1997 and the NSW EPA Waste Classification Guidelines 2014.

45. EXCAVATION AND BACKFILLING

All excavations and backfilling associated with the erection or demolition of a building must be executed safely and in accordance with the appropriate professional standards and must be properly guarded and protected to prevent them from being dangerous to life or property.

If an excavation associated with the erection or demolition or a building extends below the level of the footings of a building on an adjoining allotment of land, the excavation is to be managed by a practising structural engineer.

46. STRUCTURAL DOCUMENTATION

- (a) A construction management plan must be submitted to an independent, third party structural engineer and the project geotechnical engineer for approval. The engineers must have relevant experience, have chartered status with the Institute of Engineers Australia and be registered on the National Engineers Register. The construction management plan must incorporate and reflect the intent of the following documents:
 - i. Geotechnical Report (344263Lrpt) prepared by JK Geotechnics, dated 03/09/2021 and received by Council 01/09/2023.

Satisfaction of the third party structural engineer and project geotechnical engineer that the construction management plan will provide for the retention of the building and its structural integrity must be demonstrated to the consent authority prior to the issue of the relevant Construction Certificate.

- (b) The documentation provided by the principal structural engineer as part of the construction certificate should detail the follow:
 - ii. Design and documentation of the Strengthening and Stability requirements to ensure the existing building is suitable for the intended alteration and additions, and
 - iii. Provide detailed procedure on the methodology and constructability of the proposed work within the existing / approved building envelope, in particular to the excavation works.

CONSTRUCTION MATTERS

47. CONSTRUCTION HOURS

Demolition and building work must only be undertaken between the hours of 7am and 5pm on Mondays to Fridays and 8am to 3pm on Saturdays, with no work to be carried out on Sundays and public holidays.

Excavation works involving the use of heavy earth movement equipment, including rock breakers and the like, must only be undertaken between the hours of 7am and 5pm on Mondays to Fridays, with no such work to be carried out on Saturday, Sunday or a public holiday.

Noise from construction activities shall comply with the *Protection of the Environmental Operations* (Noise Control) Regulation 2017.

48. STOCKPILES, STORAGE OF MATERIALS AND LOCATION OF BUILDING OPERATIONS

All building materials and any other items associated with the development are to be stored within the property. No materials are to be stored on Council's footpath, nature strip, or road reserve without prior Council approval.

49. CONSTRUCTION INSPECTIONS

The building works are to be inspected during construction by the Principal Certifying Authority (PCA) in accordance with the *Building Legislation Amendment (Quality of Construction) Act 2002,* clause 162A of the *Environmental Planning and Assessment Regulation 2021* and the requirements of any other applicable legislation or instruments.

50. CERTIFICATE OF SURVEY - LEVELS

All construction works are to be in accordance with the Reduced Levels (RLs) as shown on the approved plans. Certification from a Registered Surveyor certifying ground, upper floor/s and finished ridge levels is to be submitted to the Principal Certifying Authority during construction and prior to continuing to a higher level of the building.

51. CERTIFICATE OF SURVEY - BOUNDARIES AND LOCATION OF BUILDING

A Certificate of Survey prepared by a Registered Surveyor setting out the boundaries of the site and the location of the building on the site is to be submitted to the Principal Certifying Authority to certify the building is located in accordance with the development consent plans. The Certificate is to be submitted prior to the construction of the external walls above the ground floor level of the building.

52. WORK OUTSIDE PROPERTY BOUNDARY

This consent does not authorise any work outside the property boundary.

TREE PROTECTION AND REMOVAL

53. TREE PROTECTION

All trees on site and adjoining properties, including street trees, are to be retained and protected in accordance with AS4970-2009 'Protection of Trees on Construction Sites' and to be certified by an Arborist with AQF level 5 qualification or above, unless approved to be removed in this development consent.

54. STREET TREES TO BE RETAINED/TREE PROTECTION

No existing street trees shall be removed without Council approval. Precautions shall be taken when working near trees to ensure their retention, including the following:

- (a) Do not store harmful or bulk materials or spoil under or near trees;
- (b) Prevent damage to bark and root system;
- (c) Do not use mechanical methods to excavate within root zones;
- (d) Do not add or remove topsoil from under the drip line;
- (e) Do not compact ground under the drip line;
- (f) Do not mix or dispose of liquids within the drip line of the tree; and
- (g) All trees marked for retention must have a protective fence/guard placed around a nominated perimeter in accordance with AS4970-2009 "Protection of trees on construction sites.

VEHICLE ACCESS & PUBLIC DOMAIN WORKS

55. RECONSTRUCT VEHICLE CROSSING

The existing vehicle crossing is to be demolished and a new crossing constructed to provide access to the proposed carparking. A separate application is required for the vehicle crossing, with all work to be carried out with the approval of and in accordance with the requirements of Council.

The crossing is to be 3.0 metres wide at the property boundary. The width at the street is to be 3.0 metres plus 0.45 metre splays.

Prior to the submission of the vehicle crossing application, works as executed drawings shall be submitted to Council for the approval of the Executive Manager Creating Waverley confirming the finished levels of the internal driveway between the property boundary and the car parking spaces/s comply with the approved levels.

56. VEHICULAR ACCESS - FINISHED LEVEL TO FOOTPATH

The finished level at the property boundary on both sides of the vehicle crossing is to match the level of the existing concrete footpath.

57. VEHICLE PRIORITY/TRAFFIC LIGHT SYSTEM

A vehicle priority system shall be provided. Details are to be shown in documentation and on plans to be submitted to Council for the approval of the Executive Manager, Infrastructure Services, or delegate.

58. MECHANICAL PARKING SYSTEM

The mechanical parking system (car stacker) is to be designed to accommodate a B99 car as defined in AS2890.1.

59. HEADROOM CLEARANCE

The headroom clearance within the garages and accessways is to be a minimum of 2.2 metres.

60. CAR STACKERS

The car stackers shall be independent stackers that allow vehicles to enter and leave independently. Minimum dimensions for the car bays in the stackers are to be 2.0 metre headroom, 2.3 metre width, and 5.0 metre length.

Dependent car stackers which are reliant on moving a car out of the stacker to allow another car to exit are not approved.

61. CAR PARKING

- i. A total of **7** car vehicle parking spaces are to be provided within the development, to be allocated as follows:
 - a. 1 residential visitor space
 - b. 1 retail space
 - c. 5 residential spaces.
- ii. Accessible parking spaces are to be designed in accordance with Australian Standard AS2890.6 2009 Off Street Parking for People with Disabilities.
- iii. A minimum of 20% of the carparking spaces must be installed with EV Charging stations.
- iv. 100% of carparking spaces must be EV Ready spaces.
- v. Car parking spaces are to be allocated with the rates specified in the DCP, with no more than 2 spaces allocated to any residential unit/dwelling with 3 or more bedrooms. All car spaces and to be appropriately signposted and parked.
- vi. Car parking spaces shall not be independent lots, but rather part lots attached to units in any future Subdivision Plans.

62. BICYCLE PARKING

A total of **5** bicycle parking spaces are to be provided within the development, allocated in the following manner:

- (a) 4 residential bicycle spaces
- (b) 1 retail visitor bicycle spaces
- (c) At least 1 of these spaces to be located at ground level, adjacent to lobby.

The bicycle spaces are to be designed in accordance with Australian Standard AS2890.3 - 2015 Parking Facilities - Bicycle Parking.

The bicycle spaces are to be provided by way of a secure lockable area, individual lockers or suitable bicycle racks and are to be located within the ground floor foyer or adjacent within any forecourt or within the basement car parking area. Signage and line-marking (way finding) is to be provided to guide visitors to the allocated bicycle parking spaces to ensure a safe path of travel to the bicycle spaces (separate to cars). Details of this are to be submitted to Council for the approval of the Executive Manager, Infrastructure Services, or delegate.

STORMWATER & PUBLIC DOMAIN

63. PRE-CONSTRUCTION STORMWATER PIPE CCTV DILAPIDATION REPORT

Prior to doing any works, internal inspection of the Council's stormwater conduit to determine its structural and serviceability condition must be carried out by a Closed Circuit Television (CCTV) by an approved contractor. The report is to be submitted to Council's Executive Manager, Infrastructure Services (or delegate) for its review. No works on Council's stormwater infrastructure shall commence until given approval by Council.

64. PRE-CONSTRUCTION DILAPIDATION REPORT

To ensure Council's infrastructure is adequately protected a pre-construction dilapidation report on the existing public infrastructure within the vicinity of the proposed development and along the travel routes of all construction vehicles is to be submitted to Council. The report shall detail, but not be limited to, the location, description and photographic record (in colour) of any observable defects to the following infrastructure where applicable:

- (a) Road pavement
- (b) Kerb and gutter
- (c) Footpath
- (d) Drainage pits and lintels
- (e) Traffic signs
- (f) Any other relevant infrastructure

The report is to be dated, submitted to, and accepted by Council's Public Infrastructure Engineer, prior to any work commencing on the site. All fees and charges associated with the collation of this report shall be at the cost of the Applicant.

65. PUBLIC DOMAIN ENGINEERING INSPECTIONS

To ensure all public infrastructure engineering works required by Council under this consent will be constructed to Council satisfaction, inspection(s) will be required and compliance certificates must be

obtained from Council's Public Infrastructure stormwater, and footpath paving hold points.	Engineer	for	the	road	pavement,	kerb	and	gutter,

D. PRIOR TO THE ISSUE OF AN OCCUPATION CERTIFICATE OR SUBDIVISION CERTIFICATE

The requirements outlined in this section are to be provided to the satisfaction of the Principal Certifying Authority in all instances, except where a condition explicitly specifies the approval of Council or a Council Officer is required, prior to the issue of an Occupation Certificate or Subdivision Certificate, whichever applies.

CERTIFICATION AND LICENCES

66. FINAL OCCUPATION CERTIFICATE

Prior to occupation or use of the development, an Occupation Certificate must be obtained.

The Principal Certifying Authority must be satisfied that the requirements of the *Environmental Planning & Assessment Act 1979* have been satisfied including all critical stage inspections. Documentary evidence of all required inspections is to be submitted to Council.

67. CERTIFICATION OF BASIX COMMITMENTS

The Principal Certifying Authority shall certify that the all the undertakings in the approved BASIX certificate have been completed.

68. CERTIFICATION OF APPROVED DESIGN

In accordance with the Environmental Planning and Assessment Regulations 2021, the Principal Certifying Authority must not issue an occupation certificate, to authorise a person to commence occupation or use of the development unless it has received a design verification statement from an architect who is registered in accordance with the Architects Act 2003 (i.e. qualified designer) that verifies that the building achieves the design quality of the development as shown in the plans and specifications in respect of which the construction certificate was issued, having regard to the design quality principles.

69. CERTIFICATION OF BASIX COMMITMENTS

The Principal Certifying Authority shall certify that the all the undertakings in the approved BASIX certificate have been completed.

70. CERTIFICATION OF LANDSCAPING

At the completion of all works a certificate is to be submitted to the Principal Certifying Authority from a qualified Landscape and/or Arboriculture Consultant certifying that the work has been completed in accordance with the approved Landscape Plan and that a maintenance program has been established. If relevant, the waterproofing on any green roof is to be tested and evidence of the test is to be provided with the certification.

71. FLOOR SPACE RATIO

The gross floor area (GFA) of the building shall be limited to 993.5m².

Prior to any Occupation Certificate (including Interim) being issued, a Registered Surveyor must provide certification to the satisfaction of the Principal Certifying Authority, that the building achieves compliance with this GFA (as calculated in accordance with the definition contained in the Waverley Local Environmental Plan 2012).

Reason: The gross floor area of the development is limited in order to achieve suitable bulk and scale. The consent would not have been granted if not for this compliance with the development standard.

72. BUILDING HEIGHT

- (a) The height of the building must not exceed the following RLs (AHD):
 - i. Fourth floor (Level 5) parapet: RL 37.85
 - ii. Roof of fourth floor (Level 5): RL 37.75
 - iii. Apartment 4 lift overrun: RL 38.15
- (b) Prior to any Occupation Certificate (including Interim) being issued, a Registered Surveyor must provide certification of the height of the development, utilising the definition under the Waverley Local Environmental Plan 2012, applicable at the time of development consent, to the satisfaction of the Principal Certifier.

73. CERTIFICATION OF ACOUSTIC PERFORMANCE

An acoustic report/certificate prepared by a suitably qualified acoustic consultant is to be submitted to the Principal Certifying Authority and the Council, certifying that all acoustic recommendations (including noise from mechanical plant) and conditions of consent (including the operational conditions) have been incorporated into the development and can be satisfied.

74. CERTIFICATION OF ALL MECHANICAL PLANT

A Certificate of Test of all mechanical plant together with a copy of the final test figures, conducted by a suitably qualified person, certifying that the system complies with the conditions of this consent, National Construction Code (NCC) and relevant Australian Standards.

75. CERTIFICATION OF SWIMMING POOL/OUTDOOR SPA

Prior to the pool being used, the following must be provided;

- (a) Certification that the pool has been constructed in accordance with the consulting engineers design;
- (b) Evidence that the swimming pool/outdoor spa has been registered on the State Government Swimming Pool Register (http://www.swimmingpoolregister.gov.au);
- (c) A sign outlining details of resuscitation techniques for adults, children and infants has been placed in a prominent position, close to the pool/outdoor spa. Signs are available from Council;
- (d) A copy of the occupation certificate must be submitted to Council.

Note: Swimming/spa pool pumps are restricted from use between 8pm to 7am weekdays and Saturdays, 8pm to 8am on Sundays and public holidays in accordance with the requirements of the Protection of the Environment Operations (Noise Control) Regulation 2017.

PUBLIC DOMAIN

76. SUPERVISING ENGINEER FINAL CERTIFICATE – PUBLIC DOMAIN

Prior to the issue of any Occupation Certificate for the works, the Applicant shall submit to Council, a final Certificate from the Supervising Engineer confirming that the public domain works have been constructed in accordance with the Council approved plans and Waverley Council standards and specifications. The certificate shall include commentary to support any variations from the approved drawings.

77. WORK-AS-EXECUTED PLAN – PUBLIC DOMAIN

To ensure public infrastructure works required under the consent are completed in accordance with approved plans and specifications, a Work-as-Executed plan of the works, prepared by a registered surveyor is to be submitted to the Principal Certifying Authority and Council for review with any required rectification works completed and approved by Council prior to issue of any Occupation Certificate.

The W.A.E plans are to note all departures clearly in red on a copy of the approved Construction Certificate plans and certification from an experienced chartered civil engineer shall be submitted to support all variations from approved plans.

78. CERTIFICATION OF PUBLIC INFRASTRUCTURE WORKS

To ensure public infrastructure works required under the consent are completed to Council's satisfaction a final inspection of the completed works is required from Council's Infrastructure Engineer. The Occupation Certificate shall not be issued until certification has been obtained from Council confirming the public infrastructure works have been constructed to Council's satisfaction.

Notes

- The issue of a Final Compliance Certificate from the Council Engineer will be withheld should there be any outstanding fees and charges applicable to the development. This includes but not limited to fees applicable for engineering plans assessment and work inspection fees.
- The refund of any damage and/or security deposits will be subject to satisfactory restoration and rectification of all civil infrastructure that have dilapidated as a result of the construction activities associated with this development consent.
- To ensure satisfactory performance of the public domain works, a defects liability period of twelve (12) months shall apply to the works completed by the applicant/developer following completion of the development. The defects liability period shall commence from the date of issue of the Occupation Certificate for the development. The applicant shall be liable for any part of the work which fails to perform in a satisfactory manner as outlined in Council's standard specification, during the twelve (12) months' defects liability period.

STORMWATER

79. CERTIFICATION OF NEWLY CONSTRUCTED AND RETAINED STORMWATER DRAINAGE SYSTEM

Prior to issue of any Occupation Certificate, certification is to be provided from a suitably qualified and practising Engineer or Plumber, that any new stormwater drainage system has been constructed in accordance with the Development Consent, Water Management Technical Manual, all applicable Codes,

Policies, Plans, Standards and good engineering practice. Similarly, any retained stormwater drainage system is unblocked, in good working order and to be repaired/replaced to best practice. A copy of the certification must be submitted to Council.

80. WORKS-AS-EXECUTED DRAWINGS – STORMWATER DRAINAGE SYSTEM

- (a) (a) A Works-As-Executed drawing (WAED) of the stormwater drainage system must be prepared, stamped, and signed by a Registered Surveyor. This drawing must detail the alignment of all pipelines, pits, basement pump-out facility, rainwater harvesting facility and other drainage-related infrastructure. An original or a color copy must be submitted to Waverley Council. Where changes have occurred, the Council-approved plans shall be marked-up in red ink and shall include levels and locations for the drainage structures and works.
- (b) A suitably qualified and practicing Engineer must provide certification of the WAED of the stormwater drainage system that the stormwater drainage works and basement pump-out facility were constructed to their satisfaction and in accordance with the Development Consent, Water Management Technical Manual, all applicable Codes, Policies, Plans, Standards, and good engineering practice. A copy of the aforementioned letter of certification must be submitted to Council.

81. CREATION OF POSITIVE COVENANT AND RESTRICTION FOR OSD

Prior to the issue of an Occupation Certificate, a "Positive Covenant" and "Restriction on the Use of Land" shall be created for the On-Site Stormwater Detention (OSD) system, under Section 88E of the Conveyancing Act 1919. This is to place a restriction on the Title that the OSD system is maintained and kept free of debris/weed to allow unobstructed passage of stormwater through the site and underneath the residence. The property owner/occupant shall not modify or remove the OSD system without consent from Council.

The wording of the Instrument shall be submitted to and approved by Executive Manager, Infrastructure Services (or delegate) prior to lodgement at NSW Land Registry Services.

Where a Title exists, the Positive Covenant and Restriction on the Use of Land is to be created via an application to the NSW Land Registry Services using forms 13PC and 13RPA. Accompanying this form is the requirement for a plan to scale showing the relative location of the OSD system, including its relationship to the building footprint. Electronic color photographs of the OSD system shall accompany the application for the Positive Covenant and Restriction on the Use of Land.

The Instrument shall be registered and a registered copy of the document shall be submitted to and approved by the consent authority prior to the issue of an Occupation Certificate or use of the building. All associated costs shall be borne by the applicant.

82. CERTIFICATION OF THE FINISHED FLOOR LEVEL OF THE DWELLING

The certification referred to in "COMPLIANCE PRIOR TO AND DURING CONSTRUCTION- FINISHED FLOOR LEVEL OF THE DWELLING" must form part of the application for an Occupation Certificate.

83. CREATION OF SITE FLOOD EMERGENCY RESPONSE PLAN

Before occupation or prior to the issue of any Occupation Certificate, a site flood emergency response plan must be prepared, and any required flood warning system must be installed and fully tested. A copy of this plan must be submitted to the Private Certifier and to Waverley Council.

Certification from a suitably qualified engineer to the effect that this plan has been prepared and where required, the flood warning system has been installed and tested, must be included with the Occupation Certificate.

84. PLANNED PREVENTATIVE MAINTENANCE SCHEDULE FOR PUMP OUT SYSTEM

The registered proprietor shall be required to submit written intent to establish and maintain a Planned Preventative Maintenance (PPM) schedule of the pump out system prior to the issue of Occupation Certificate. Council will not be liable for any claims for damages arising from the failure of the pump out system. Evidence shall be submitted to the Executive Manager, Infrastructure Services or delegate prior to the issue of the Occupation Certificate.

MANAGEMENT PLANS

85. PLAN OF MANAGEMENT - WASTE AND RECYCLING STORAGE

A Waste Management Plan must be submitted to Council's Executive Manager, Environmental Sustainability (or delegate) and include including the following where relevant.

- (a) All arrangements including relevant and current contracts for recyclables and all other waste (collection and disposal)
- (b) The waste storage area and bins must be cleaned and maintained regularly with appropriate lighting.
- (c) Confer with Sydney Water and any other relevant contractor to ensure a valid Trade Waste Agreement is in place for all trade wastes. Copies of these agreements shall be forwarded to Council.
- (d) The role and responsibility of managing composting facilities (if provided).
- (e) Clear signage identifying the different bin types, space for reusable items such as crates and pallets, bulky household waste and problem waste must be displayed.
- (f) The recycling bins must be placed alongside the general waste bins for ease of access and to encourage recycling habits.
- (g) For commercial premises whose waste contains 20% or more food waste, a daily waste collection is required, unless an alternative is agreed upon with Council.
- (h) Responsibilities for transporting bins from the storage points to the nominated collection area, cleaning of bins, cleaning of storage areas and booking and transporting bulky waste for Council pick up must be outlined in contracts with the building manager, cleaners and tenants.
- (i) All waste and recycling bins must only be placed out on Council footpath for collection the morning of the collection day (no earlier than 5:30am) and retrieved from the kerbside as early as possible the same day of collection.
- (j) The bins must be placed for collection in a location that does not impede pedestrian access along the footpath or impact the neighbouring properties.
- (k) The occupant/body corporate shall be provided with at least one copy of the Waste Management Plan. An additional copy of the plan is be available on site when requested.
- (I) At no times shall bins or other products (e.g. kegs and pallets) be stored on the public domain (e.g. footpaths).
- (m) Details of ongoing waste management strategy are to be documented within the SWRMP and reviewed every 5 years to employ updated waste reduction strategies and technologies.

OTHER MATTERS

86. ALLOCATION OF STREET NUMBER/S

The redevelopment of the property has led to the following allocation of primary and sub-premises numbering:

- No. 56 primary address site number
- Campbell Parade primary address location.

The primary address site number for the property shall be a minimum of 75mm high and shall be positioned 600mm-1500mm above ground level, located near the pedestrian entry point and be clearly visible on the site boundary that fronts Campbell Parade.

The following sub addressing principles will apply:

- Shop G01 for the commercial sub-address sites within the building correlating with the Retail lower ground and ground floor plans for the building,
- Nos. 2-5 for the residential sub-address site within the building correlating with apartment Nos. 1 4 on the floor plans for the building.

The address number for a sub-address site shall consist of the sub-address followed by the number of the primary address site.

The address number for a sub-address site shall not consist of the primary address number on its own.

Sub-address numbers shall be applied in a logical sequence and within a primary address site shall be unique regardless of the type of the address.

The primary and sub-address numbers are to be positioned on the site prior to the issue of the Occupation Certificate.

Any variation to the above premises numbering requires a new application for a Change of street number and/or location to be lodged with Council.

E. OPERATIONAL MATTERS

The following operational conditions must be complied with at all times, throughout the use and operation of the development or use.

GENERAL MATTERS

87. SUBDIVISION

This consent does not include any form of subdivision of the development.

In respect to any future subdivision and the allocation of car parking and storage spaces, those spaces are not permitted to be subdivided as individual allotments and are to be part lots allocated to individual residential allotments or identified as common property as shown on the approved plans. Parts allotments are to be generally allocated in accordance with the parking and storage requirements of Waverley Development Control Plan 2012. No exclusive use of common property shall occur without the prior consent of Council.

88. USE OF PLANT ROOMS

The 'plant' room/s shall be used exclusively for the housing of plant and mechanical equipment and must not be used for storage of goods or any other purpose.

89. REFRIGERATION UNITS & MECHANICAL PLANT

Refrigeration motors/units and other mechanical plant (i.e. air conditioning) are not to be installed outside the building without the prior consent of Council in order to assess the cumulative impacts of noise to adjoining properties. All plant is to be installed within the confines of the building and be acoustically treated to ensure that it within the acceptable limits.

90. AIR EMISSIONS

The use of the premises shall not give rise to air impurities in contravention of the Protection of the Environment Operations Act, 1997.

91. NOISE EMISSIONS

The use of the premises shall not give rise to the transmission of "Offensive noise" as defined in the Protection of the Environment Operations Act 1997 to any place of different occupancy.

92. ON-GOING MAINTENANCE - LANDSCAPING

Landscaping is to be maintained generally in accordance with the Approved Landscape Plans and the required Landscape Management Plan for the life of the development. If any plant dies or is removed, it is to be replaced with the same or similar species. The landscaping is to be managed as "common property" and maintained collectively to ensure that a cohesive landscaped solution is maintained. This is to be reflected in any future by-laws or Building Management Statement, should the development be subdivided.

Reason: To ensure that the high-quality landscape solution is appropriately maintained for the life of the development.

93. ONGOING FLOODING REQUIREMENTS

- (a) Materials which may be damaged by flood waters, materials which may be mobilised during flooding and materials which may cause pollution must be stored above freeboard level.
- (b) There must be no modifications made to flood compatible fencing.
- (c)There must be no filling or blocking of the open, underfloor areas below freeboard level.
- (d) The site flood emergency response warning systems and plan are to be regularly maintained, reviewed and/or updated and should be in good working order at all times.

94. ONGOING MAINTENANCE - STORMWATER DRAINAGE SYSTEM

Council will need to be provided with an OSD, pump system and Stormwater Quality Improvement Devices maintenance activities. At a minimum, the pump system and the detention facility must be:

- Kept clean and free from silt, rubbish and debris.
- Be maintained so that it functions in a safe and efficient manner.
- Not be altered without prior consent in writing of the Council.

95. RAINWATER HARVESTING AND REUSE

The operation of all devices or appliances installed within the development approved by this consent as required by conditions pertinent to rainwater harvesting and rainwater reuse must be maintained in good operating order at all times.

96. ONGOING MAINTENANCE - STORMWATER TREATMENT SYSTEM

The stormwater treatment system must be maintained in accordance with the manufacturer's or designer's specification for the life of the development. Council will need to be provided with a Maintenance Schedule that supports the routine maintenance activities.

PARKING AND ACCESS

97. PARKING ALLOCATION

- (a) Ownership of car park lot spaces within the basement shall be limited to parties owning a lot within the buildings on-site.
- (b) A minimum of one car space and a maximum of two car spaces shall be allocated to any residential unit/dwelling to ensure equitable allocation overall.

(c) Car parking spaces shall not be independent lots, but rather part lots attached to units in any future Subdivision Plans.

98. PARKING PERMITS

Occupants of the building are not to be eligible for resident parking permits under Council's Residents Preferential Parking permits scheme.

99. VEHICLE ACCESS

All vehicles including service vehicles entering and exiting the building are to do so in a forward direction.

Any vehicle utilising a car, motorcycle or bicycle space is to be parked fully within the confines of the site and is not to park over the public footway at any time.

100. ADJUSTMENTS TO STREET SIGNS

Any street signs required to be removed as a result of the works shall be relocated at the applicant and/or owner's expense in accordance with Council's requirements.

F. ADVISORY MATTERS

The following advisory matters are provided as additional information to ensure compliance with the relevant legislation and requirements. You must also check other Commonwealth and NSW Acts and Regulations which may apply to the works or use approved in this application.

AD1. POST CONSENT CONDITIONS REQUIRING COUNCIL INPUT

Various conditions require further input, review or approval by Council in order to be satisfied following the determination of the application (that is, post consent). In those instances, please adhere to the following process to avoid delays:

- Please read your conditions carefully.
- Information to be submitted to Council should be either via email to info@waverley.nsw.gov.au or via the NSW Planning Portal (if required).
- Attention the documentation to the relevant officer/position of Council (where known/specified in condition).
- Include DA reference number.
- Include condition number/s seeking to be addressed.
- Where multiple conditions need Council input, please try to group the documentation / email/s into relevant subjects (multiple emails for various officers may be necessary, for example).
- Information to be submitted in digital format refer to 'Electronic lodgement guidelines' on Council's website. Failure to adhere to Council's naming convention may result in documentation being rejected.
- Where files are too large for email, the digital files should be sent to Council via CD/USB. Council does not support third party online platforms (data in the cloud) for receipt of information.
- Please note, in some circumstances, additional fees and/or additional documents (hard copy) may be required.
- Council's standard for review (from date the relevant officer receives documentation) is 14 days. Times may vary or be delayed if information is not received in this required manner.

AD2. DIAL BEFORE YOU DIG

Underground assets may exist in the area that is subject to your application. In the interests of health and safety and in order to protect damage to third party assets please contact Dial Before You Dig at www.1100.com.au or telephone on 1100 before excavating or erecting structures (this is the law in NSW). If alterations are required to the configuration, size, form or design of the development upon contacting the Dial Before You Dig service, an amendment to the development consent (or a new development application) may be necessary. Individuals owe asset owners a duty of care that must be observed when working in the vicinity of plant or assets. It is the individual's responsibility to anticipate and request the nominal location of plant or assets on the relevant property via contacting the Dial Before You Dig service in advance of any construction or planning activities.

AD3. SYDNEY WATER REQUIREMENTS

You are required to submit your plans to the appropriate Sydney Water office to determine whether the development will affect Sydney Water's sewer and water mains, stormwater drains and/or easements.

If you are increasing the density of the site, a Section 73 Compliance Certificate under the Sydney Water Act 1994 must be obtained. The application must be made through an authorised Water Servicing Coordinator, for details see the Sydney Water website.

Following application a "Notice of Requirements" will be forwarded detailing water and sewer extensions to be built and charges to be paid. Please make early contact with the Coordinator, since building of water/sewer extensions can be time consuming and may impact on other services and building, driveway or landscape design.

AD4. SYDNEY WATER CERTIFICATE

A Section 73 Compliance Certificate under the Sydney Water Act 1994 must be obtained. **Application** must be made through an authorised Water Servicing Coordinator, for details see the Sydney Water website.

Following application a "Notice of Requirements" will be forwarded detailing water and sewer extensions to be built and charges to be paid. Please make early contact with the Coordinator, since building of water/sewer extensions can be time consuming and may impact on other services and building, driveway or landscape design.

AD5. TELECOMMUNICATIONS ACT 1997 (COMMONWEALTH)

Telstra (and its authorised contractors) are the only companies that are permitted to conduct works on Telstra's network and assets. Any person interfering with a facility or installation owned by Telstra is committing an offence under the Criminal Code Act 1995 (Cth) and is liable for prosecution. Furthermore, damage to Telstra's infrastructure may result in interruption to the provision of essential services and significant costs. If you are aware of any works or proposed works which may affect or impact on Telstra's assets in any way, you are required to contact: Telstra's Network Integrity Team on Phone Number 1800810443.

AD6. EXCAVATION TO BE LIMITED

Excavation shall be limited to that shown in the approved plans. Any further excavation will require Council approval.

AD7. SEPARATE APPLICATIONS FOR USE/FIT OUT

Specific development applications are to be lodged for the approval of Council in connection with the initial usage of any retail or commercial areas within the development, prior to the occupation of the premises, unless otherwise permitted under SEPP (Exempt and Complying Development Codes) 2008.

AD8. SEPARATE APPLICATION FOR SIGNAGE

No signage has been proposed in this application, therefore any advertising or signage requires the separate approval from Council, unless deemed Exempt Development under Division 2 of the SEPP (Exempt and Complying Development) 2008.

AD9. TREE REMOVAL/PRESERVATION

Any trees not identified for removal in this application have not been assessed and separate approval may be required. Any pruning of trees on adjoining properties required for the erection of scaffolding and/or the construction of the building may also require approval.

AD10. BUILDING TO BE WRAPPED

The applicant is encouraged to investigate possibilities of extracting an image of the completed building onto the hoarding and mesh surrounding the site during the demolition and construction stages of the development to minimise the visual intrusion of what is otherwise a large single coloured mesh 'block' during this time. Any advertising on the hoarding requires Council's written approval.

AD11. OUTDOOR DINING

Any proposal to utilise an area external of the building for dining will be subject to a separate application to Council and if approved will require the applicant and/or owners to sign a lease agreement.

AD12. SIGNS/GOODS IN THE PUBLIC WAY

No signs or goods are to be placed on the footway or roadway adjacent to the property.

AD13. SUITABLY QUALIFIED ACOUSTIC CONSULTANT

In these conditions, reference to a suitably qualified acoustic consultant means an individual who possesses the qualifications to render them eligible for membership of both the Australian Acoustics Society and Institution of Engineers Australia at the grade of member or an individual who is employed by a member firm of the Association of Australian Acoustic Consultants.

AD14. SITE RECTIFICATION WORKS

The vacant site is to be maintained in a safe and secure manner. Fencing is to be erected around the permitter of the site once demolition has been completed to secure the site. The site is to be protected from windblown soil loss and stormwater erosion at all times.

If the site is commenced to be developed and there is suspension in activity for 6months (or suspensions of activity which in the aggregate exceed 6 months), resulting in a building site which has an appearance not acceptable to Council, then the Council will have the readily enforceable rights to:

- (i) Require certain works including but not limited to:
 - (a) make the building/site safe and of an appearance acceptable to Council.
 - (b) Allow the ground level to be landscaped and of an appearance acceptable to Council from any public vantage point; or
 - (c) For the hole to be covered to allow it to be landscaped and made attractive from any public vantage point.
 - (d) AND to call on such bank guarantee to cover the cost thereof.
- (ii) In the event of default, have the right to enter and carry out these works and to call upon security in the nature of a bank guarantee to cover the costs of the works.

DEVELOPMENT APPLICATION


56 CAMPBELL PARADE, BONDI BEACH, NSW 2026



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Application No: DA-367/2022

Date Received: 09/06/2023

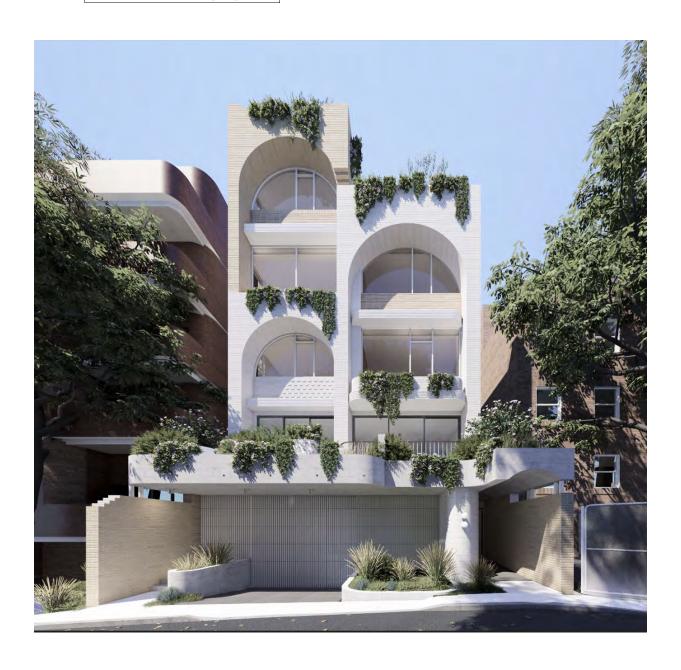

56 CAMPBELL PARADE

BONDI BEACH

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EXISTING TO BE RETAINED EXISTING TO BE DEMOLISHED NEW STRUCTURE

EXISTING WINDOW / DOOR NEW WINDOW / DOOR

W/D

ARCHITECTS NICHOLAS + **ASSOCIATES**

NOMINATED ARCHITECT

PATRICK NICHOLAS NSW 6672

STUDIO 6, 1 MARY'S PLACE SURRY HILLS NSW 2010 T+61 2 8353 9500

DEVELOPMENT APPLICATION COVER PAGE + PHOTOMONTAGE

PROJECT ADDRESS: 56 CAMPBELL PARADE, BONDI BEACH

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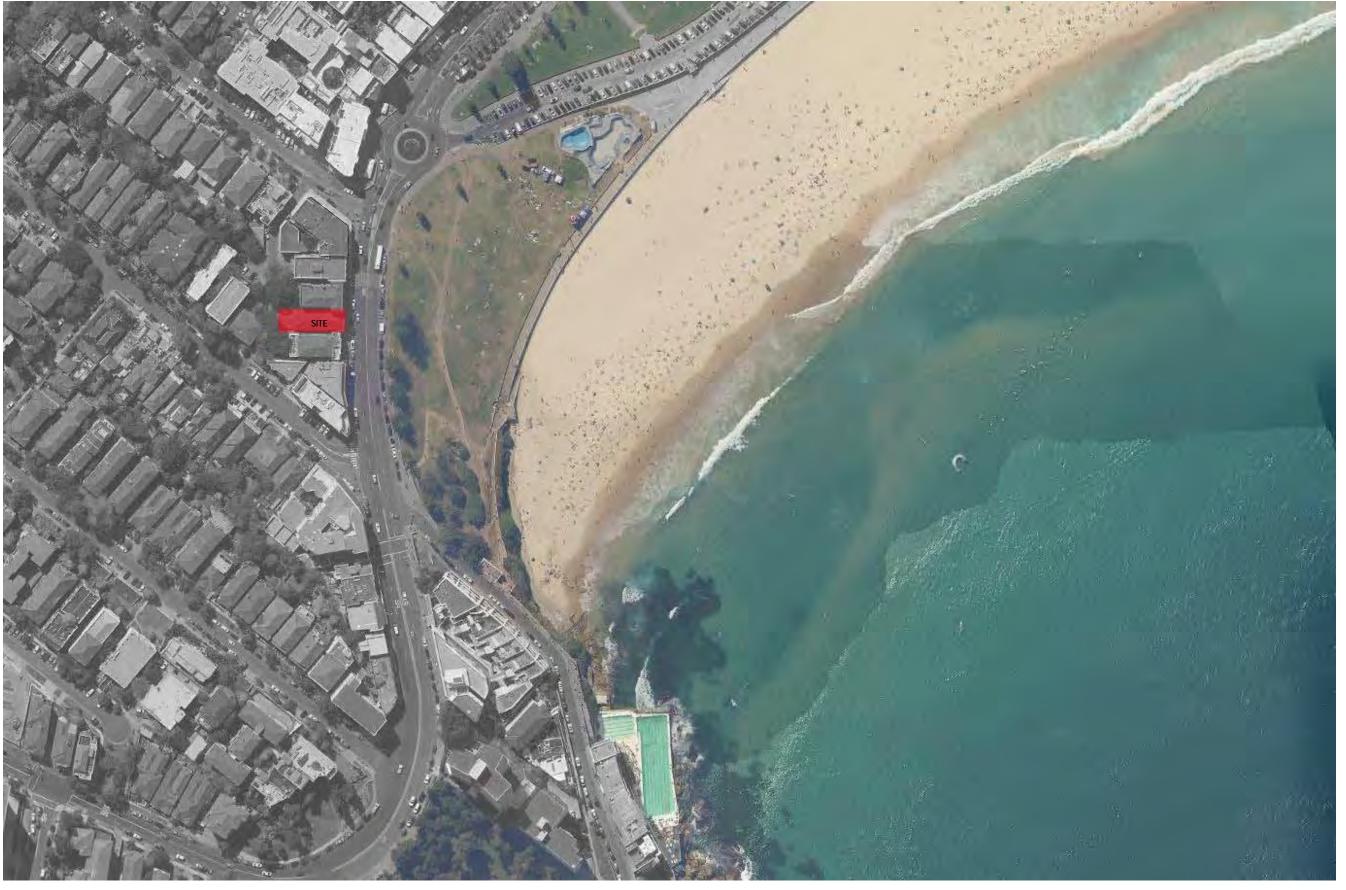
CAM2105

ROB DEUTSCH

DRAWING NO:

DA000

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SITE CONTEXT

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SURVEY SPOT LEVEL

W/D

EXISTING TO BE RETAINED EXISTING TO BE DEMOLISHED

NEW STRUCTURE

EXISTING LEVEL EXISTING WINDOW / DOOR NEW WINDOW / DOOR

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NOMINATED ARCHITECT

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DRAWING NO: DA002

CAM2105

JOB NO:

DEVELOPMENT APPLICATION

DRAWING TITLE:
SITE CONTEXT

PROJECT ADDRESS: 56 CAMPBELL PARADE, BONDI BEACH

ROB DEUTSCH

Page 459 of 500 Date Received: 09/06/2023



No.36 4 Storey Contemporary Mixed Use Street Awning

Cairo Mansions Heritage Item 176

4 Storey Inter-war Free Classical Mixed use Street Awning

No.50 -54 Walhalla Court 4 Storey Interwar Residential Flat Building

No.56 2 Storey Inter-war Art Deco Shop Top Housing Fabric Awning

No.58 Mayfair

No.64-66 3 Storey Inter-war Mixed Use Street Awning

The Empire

4 Storey Inter-war Mixed Use Street Awning

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CAMPBELL PARADE

Subject Site

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NEW STRUCTURE

EXISTING TO BE RETAINED EXISTING TO BE DEMOLISHED

SURVEY SPOT LEVEL + 00.000 EXISTING LEVEL W/D

W/D

EXISTING WINDOW / DOOR NEW WINDOW / DOOR

ARCHITECTS NICHOLAS + **ASSOCIATES**

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DA004

DEVELOPMENT APPLICATION

ISSUE NO:

JOB NO:

CAM2105

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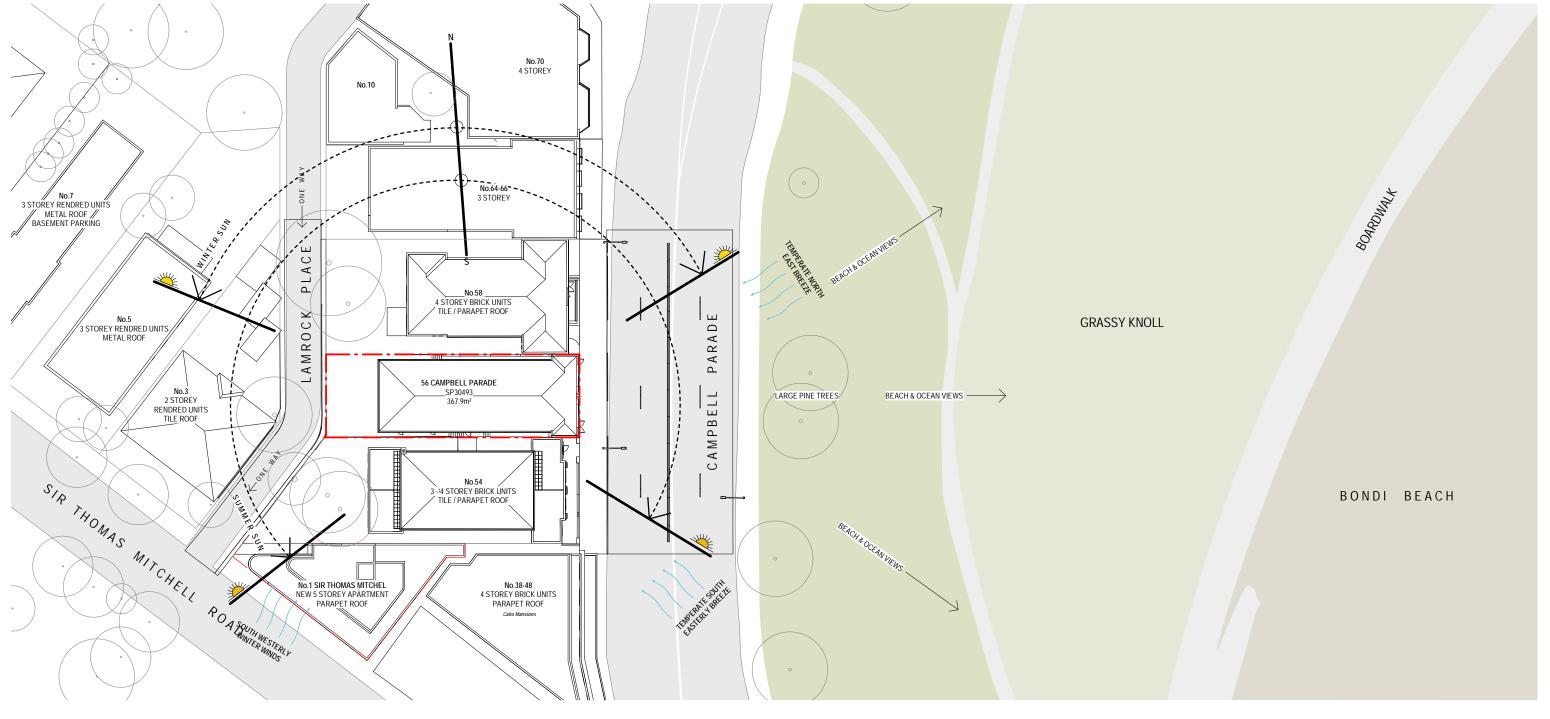
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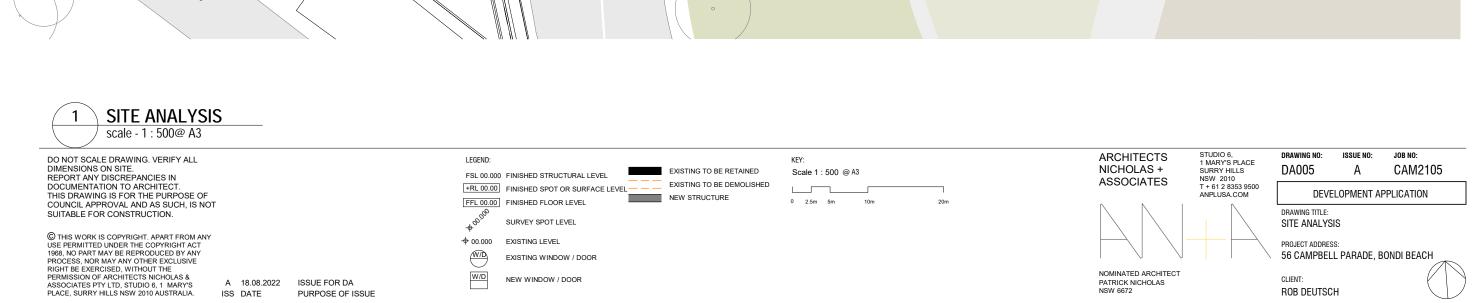
PROJECT ADDRESS: 56 CAMPBELL PARADE, BONDI BEACH

CLIENT: ROB DEUTSCH


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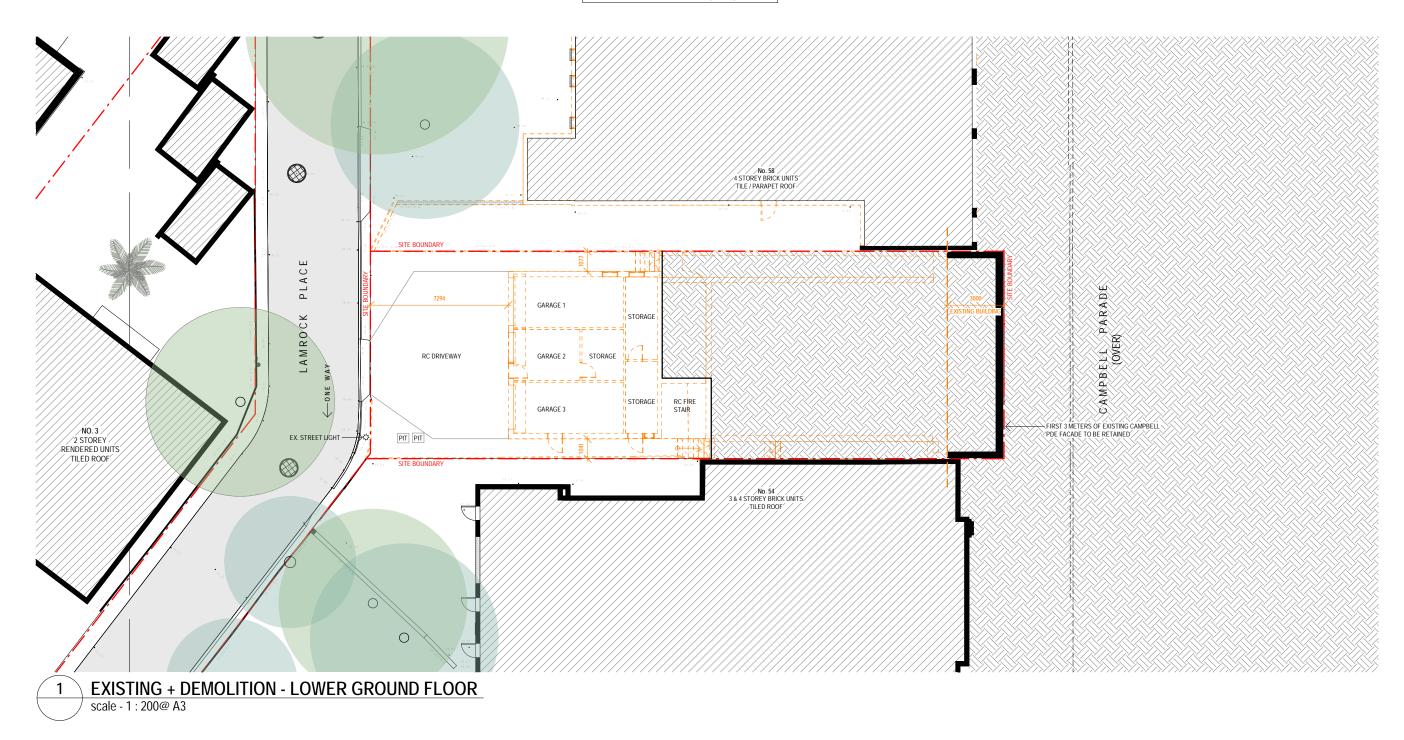



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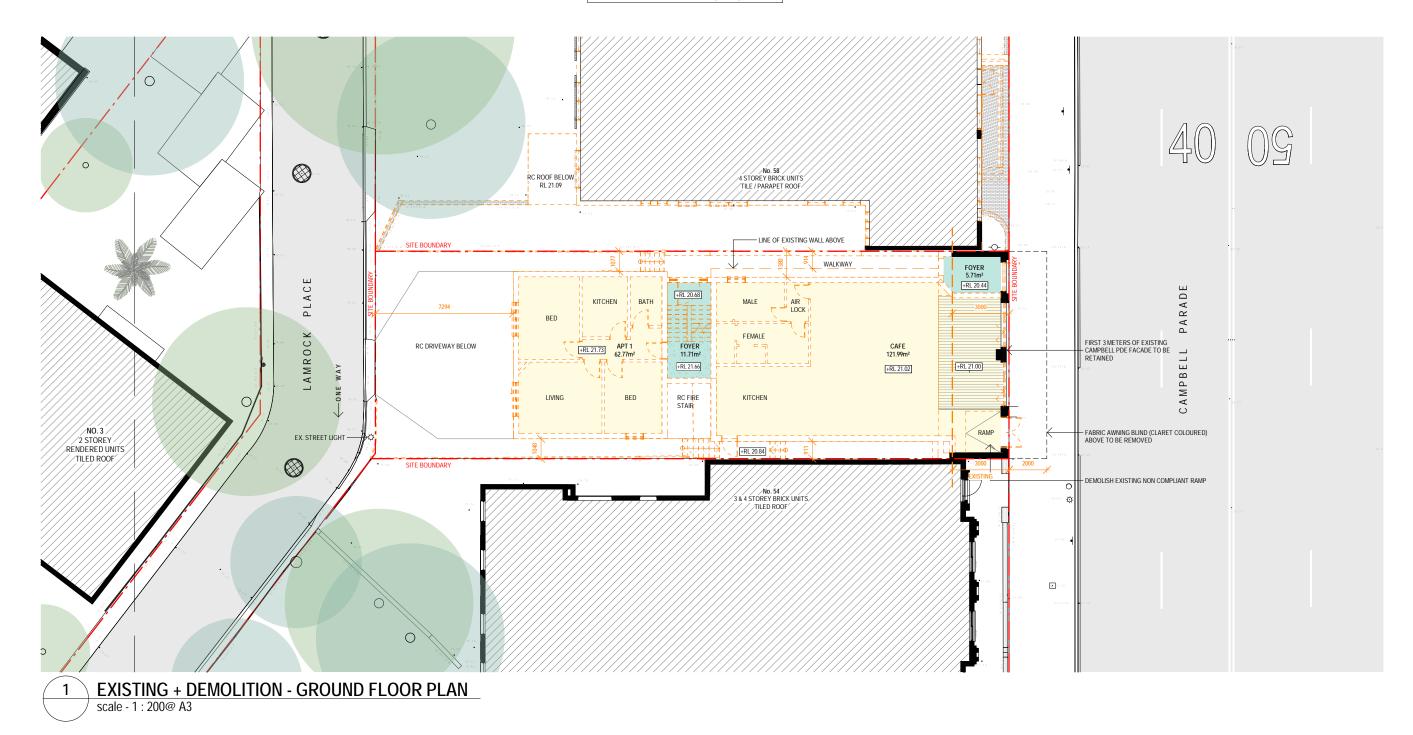
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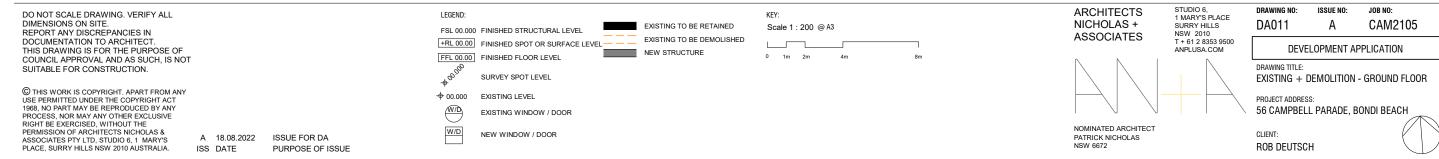




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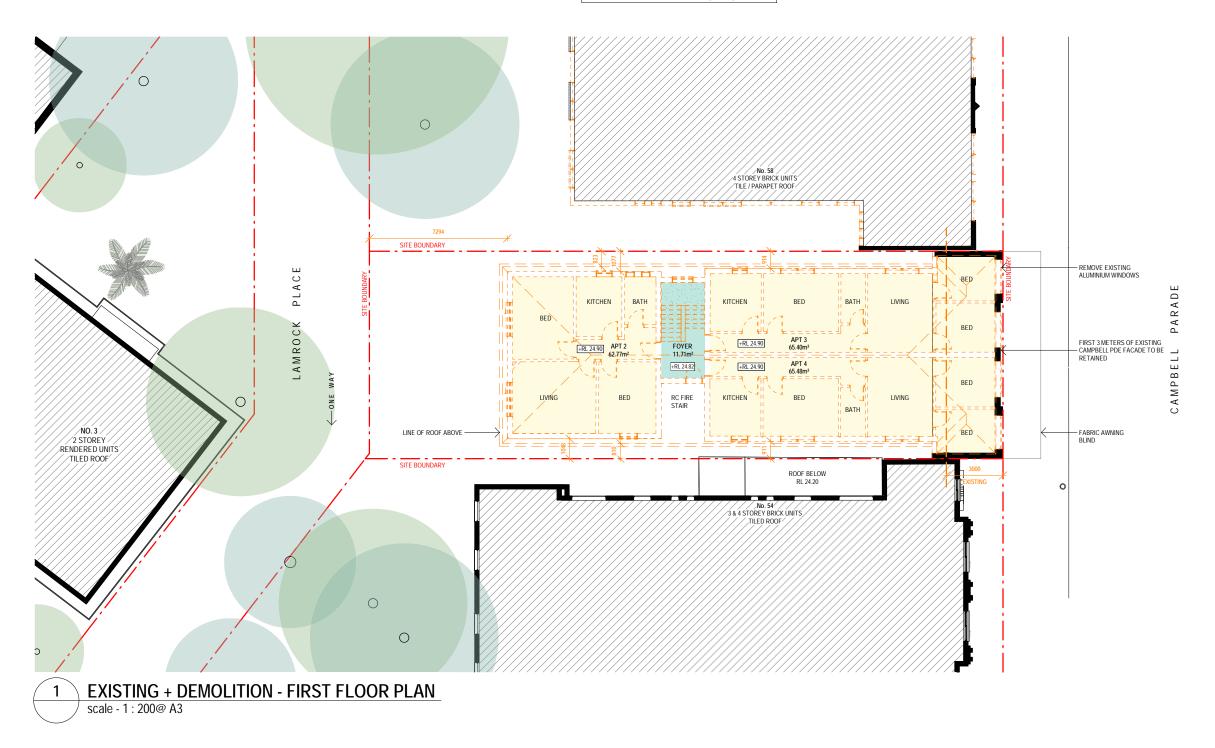
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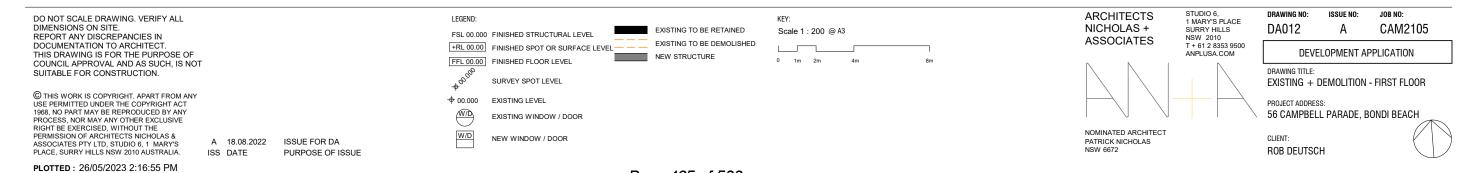


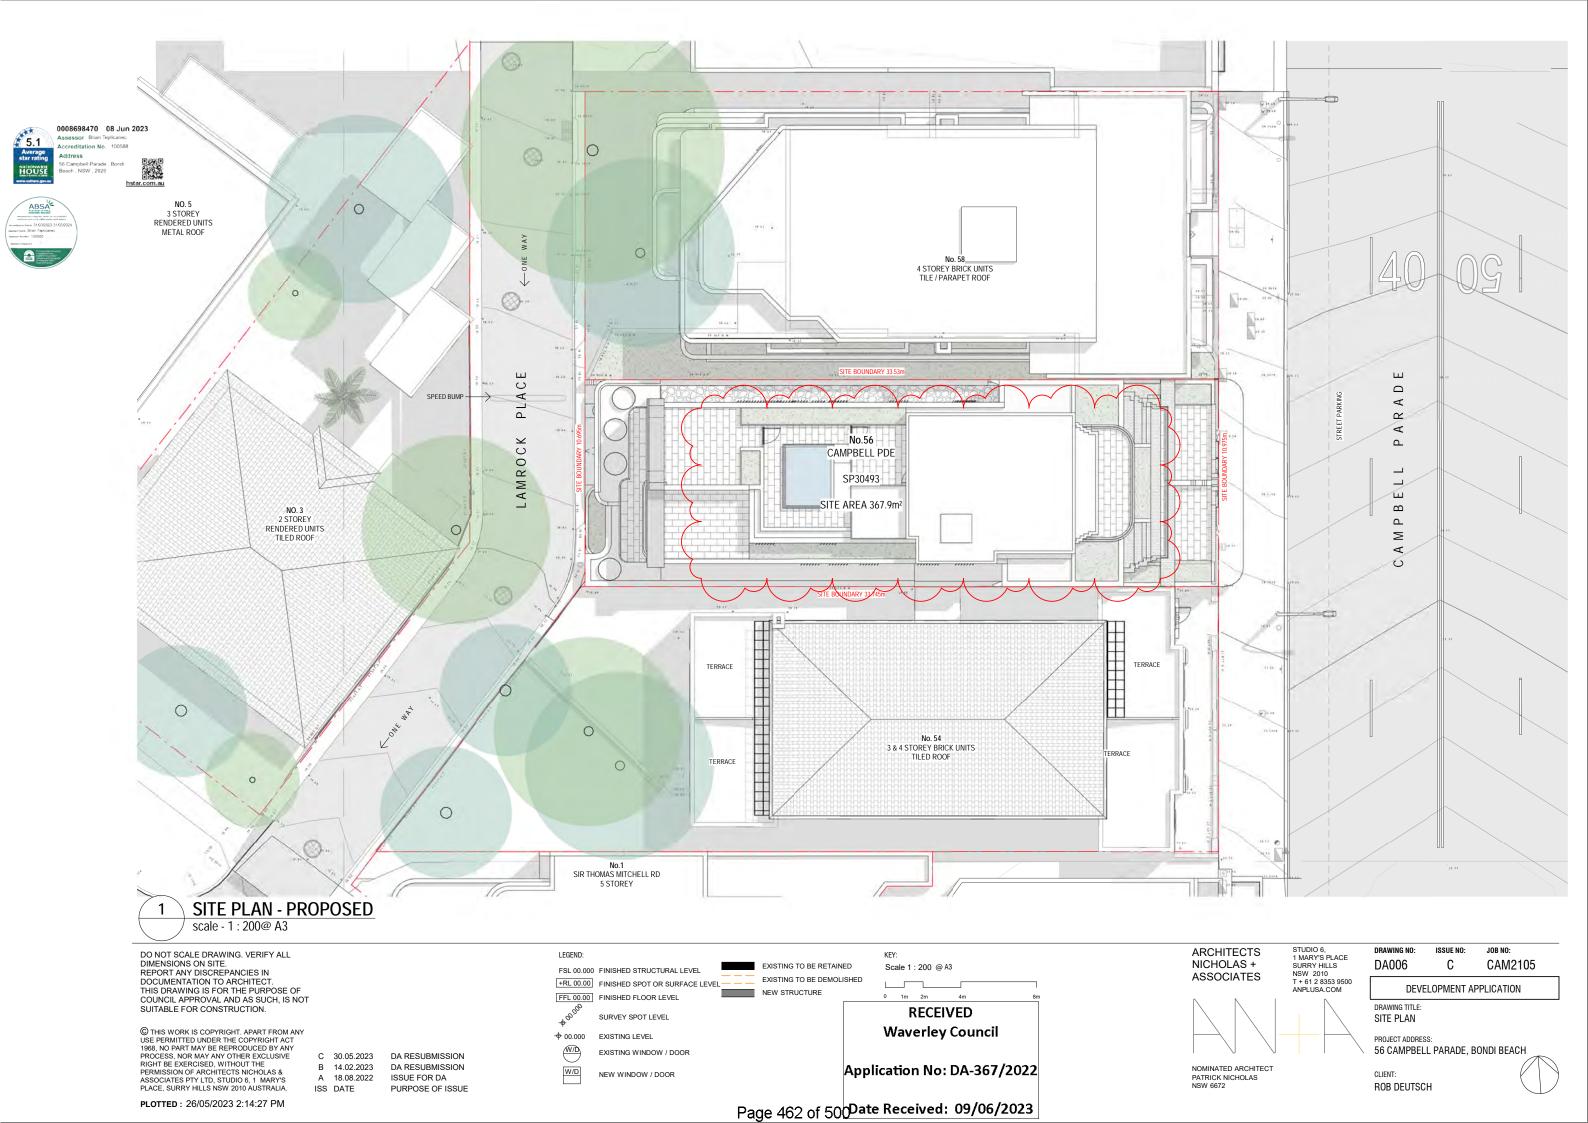

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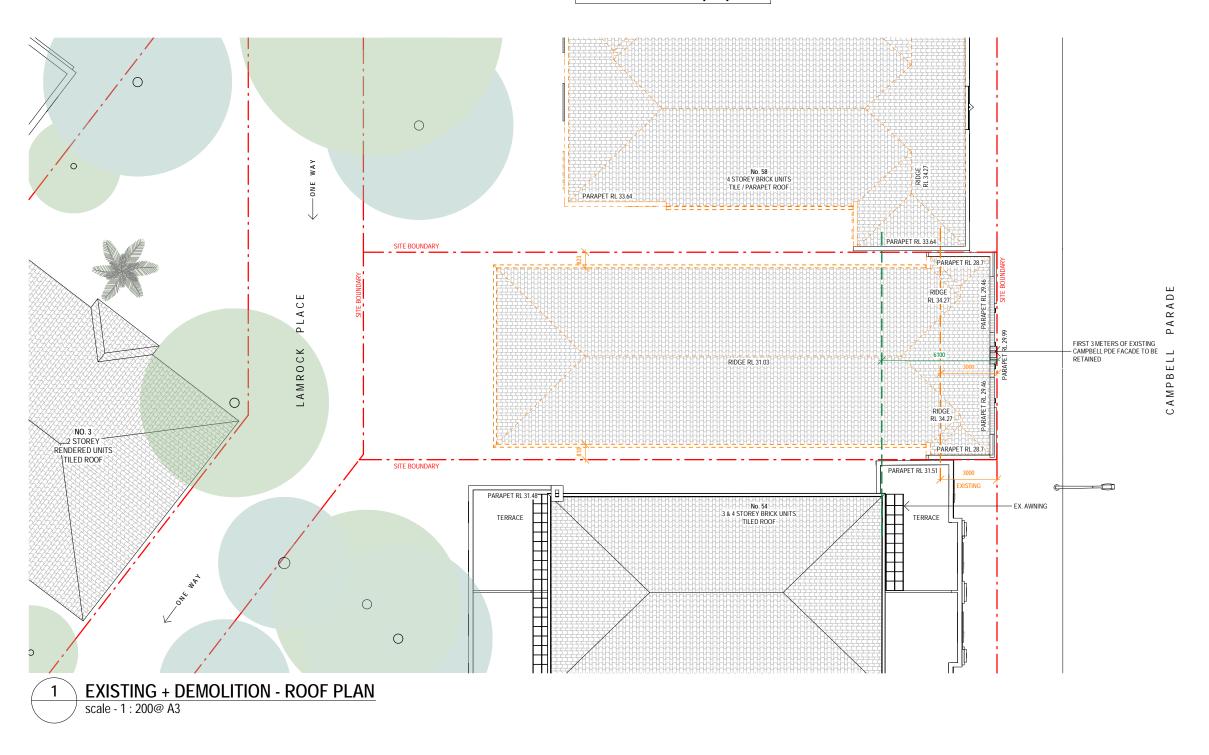
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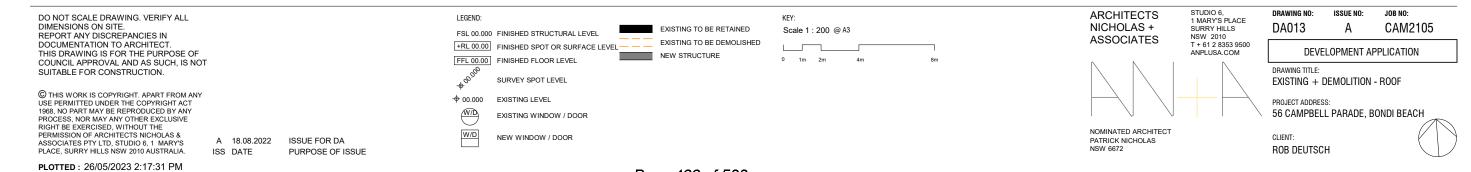


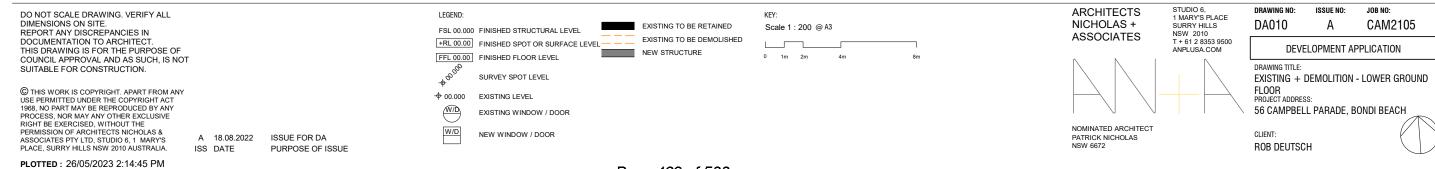

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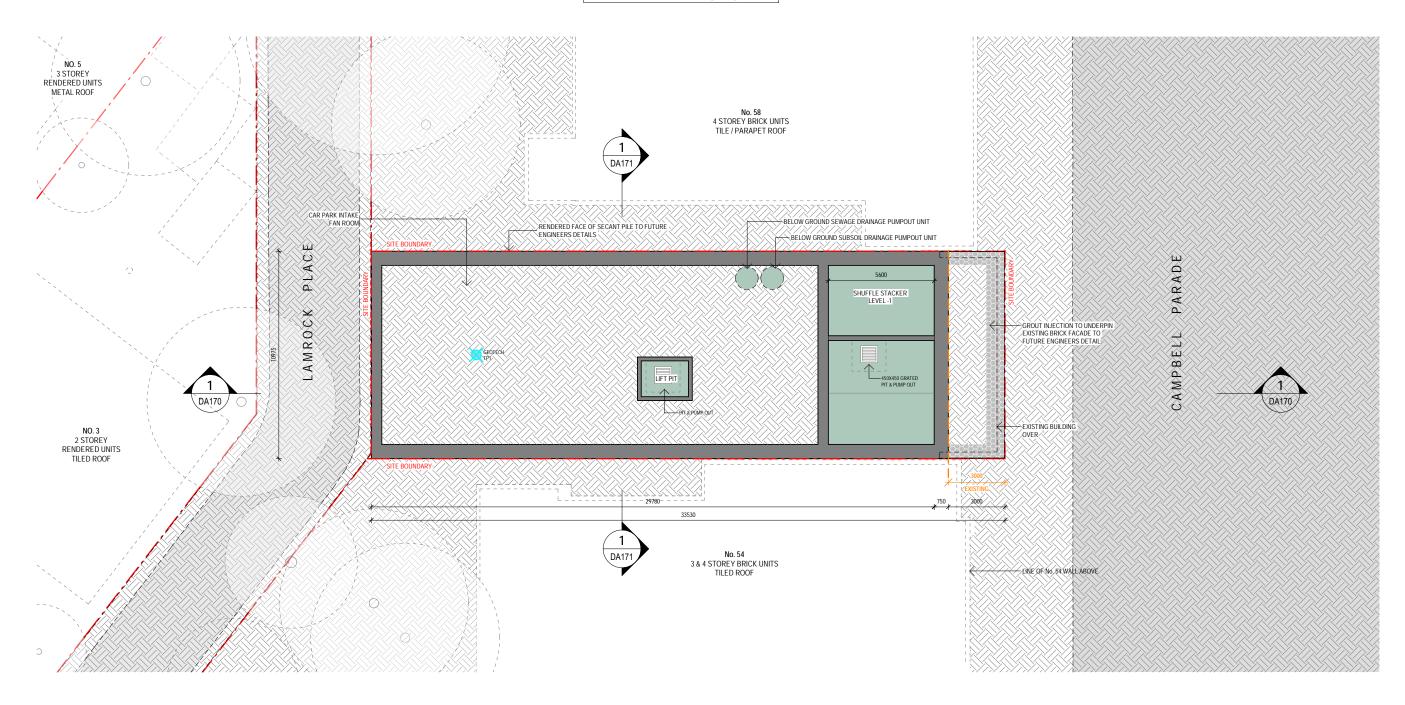
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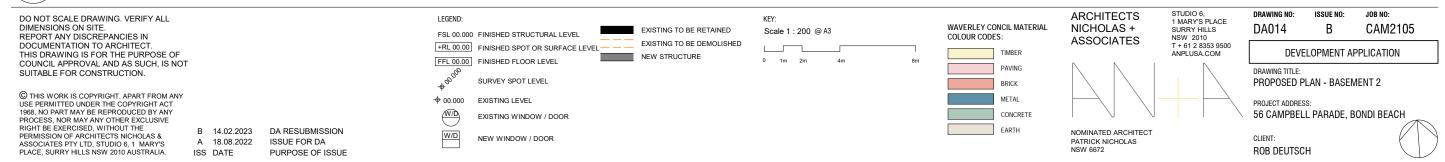


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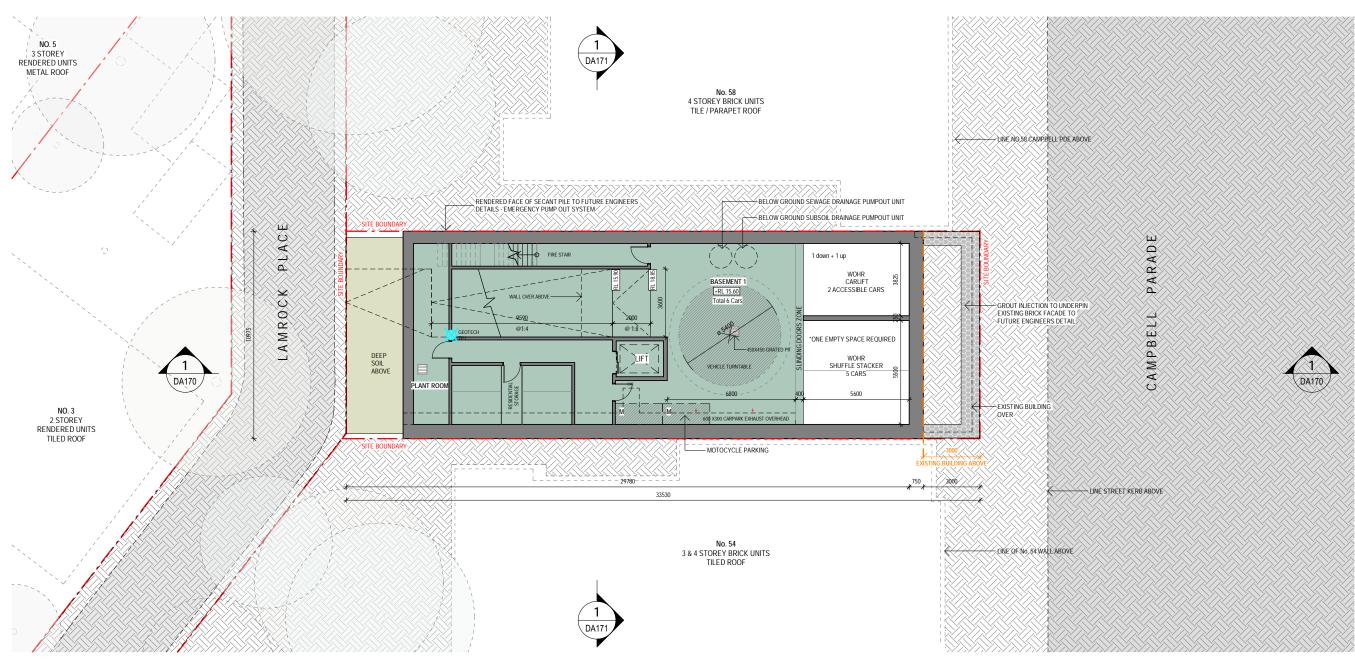
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Application No: DA-367/2022

Date Received: 09/06/2023

ABSA Thermal Notes - 56 Campbell Parade, Bondi Beach, NSW, 2026

xternal walls: Cavity Brick plus R1.0 insulation and plasterboard

External walks: Cavity Brick uninsulated and plasterboard - existing Glazing: Auminium Single Glaze Clear: U = 6.70: SHGC = 0.57 - Awning, Casement, Doors - Unit 2, Unit 3

Glazing: Aluminium Single Glaze Clear. U = 6.70. SHGC = 0.57. Awaring, Casement, Doors- Unit 2, Unit 3.

Glazing: Aluminium Single Glaze Clear. U = 6.70. SHGC = 0.70. - Siding, Fixed, Louvre - Unit 3.

Glazing: Aluminium Single Glaze High Solar Gan Low-E: U = 5.40. SHGC = 0.49. - Awaring, Casement, Doors- Unit 1. - All, Unit 2. FF13. - FF16, SF13. - SF15, Unit 3. - FF03. - FF07, SF07, SF07, SF07, SF07, Unit 4. - ALL.

Glazing: Aluminium Single Glaze High Solar Gan Low-E: U = 5.40. SHGC = 0.58. - Siding, Fixed, Louvre - Unit 1. - ALL, Unit 4. - ALL.

Glazing: Aluminium Single Glaze Low-Solar Gan Low-E: U = 5.6. SHGC = 0.41. - Unit 2. - SF18.

Glazing: Aluminium Single Glaze Low-Solar Gan Low-E: U = 5.6. SHGC = 0.41. - Unit 1. - SF18.

Glazing: Aluminium Double Glaze Low-Solar Gan Low-E: U = 5.6. SHGC = 0.41. - Unit 1. - SF18.

Glazing: Aluminium Single Glaze Low-Solar Gan Low-E: U = 5.6. SHGC = 0.41. - Unit 1. - SF18.

Glazing: Aluminium Single Glaze Low-Solar Gan Low-E: U = 5.6. SHGC = 0.41. - Unit 1. - SF18.

Glazing: Aluminium Single Glaze Low-Solar Gan Low-E: U = 5.6. SHGC = 0.41. - Unit 1. - SF18.

Glazing: Aluminium Single Glaze Low-Solar Gan Low-E: U = 5.6. SHGC = 0.41. - Unit 1. - SF18.

Glazing: Aluminium Single Glaze Low-Solar Gan Low-E: U = 5.6. SHGC = 0.41. - Unit 1. - SF18.

Glazing: Aluminium Single Glaze Low-Solar Gan Low-E: U = 5.6. SHGC = 0.41. - Unit 1. - SF18.

Glazing: Aluminium Single Glaze Low-Solar Gan Low-E: U = 5.6. SHGC = 0.58. - SHGC = 0.47. - Unit 1. - SF18.

Glazing: Aluminium Single Glaze Low-Solar Gan Low-E: U = 5.6. SHGC = 0.58. - SHGC = 0.41. - Unit 1. - SF18.

Glazing: Aluminium Single Glaze Low-Solar Gan Low-E: U = 5.6. SHGC = 0.58. - SHGC = 0.41. - Unit 1. - SF18.

Glazing: Aluminium Single Glaze Low-Solar Gan Low-E: U = 5.6. SHGC = 0.58. - SHGC = 0.41. - Unit 1. - SF18.

Glazing: Aluminium Single Glaze Low-Solar Gan Low-E: Unit 1. - SF18.

Glazing: Aluminium Single Glaze Low-Solar Gan Low-E: Unit 1. - SF18.

Glazing: Aluminium Single Glaze Low-Solar Gan Low-E: Unit 1. - SF18.

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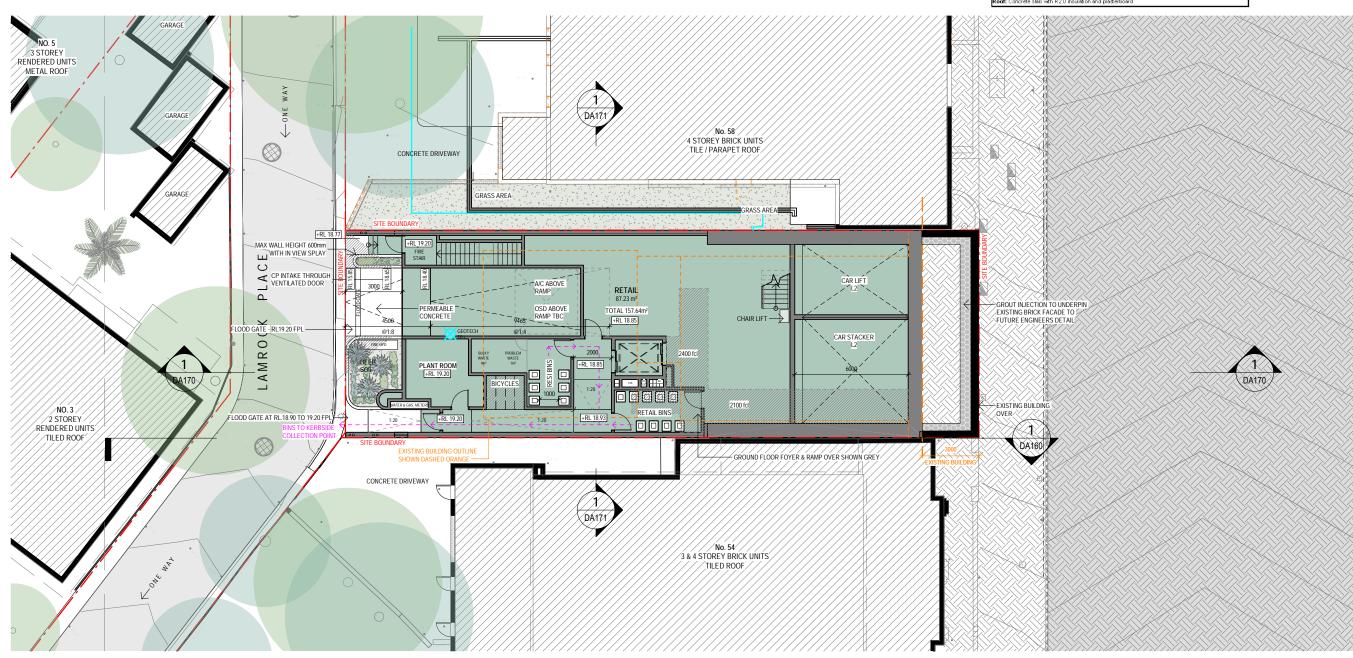
0008698470 08 Jun 2023

Accreditation No. 100588

Address


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HOUSE






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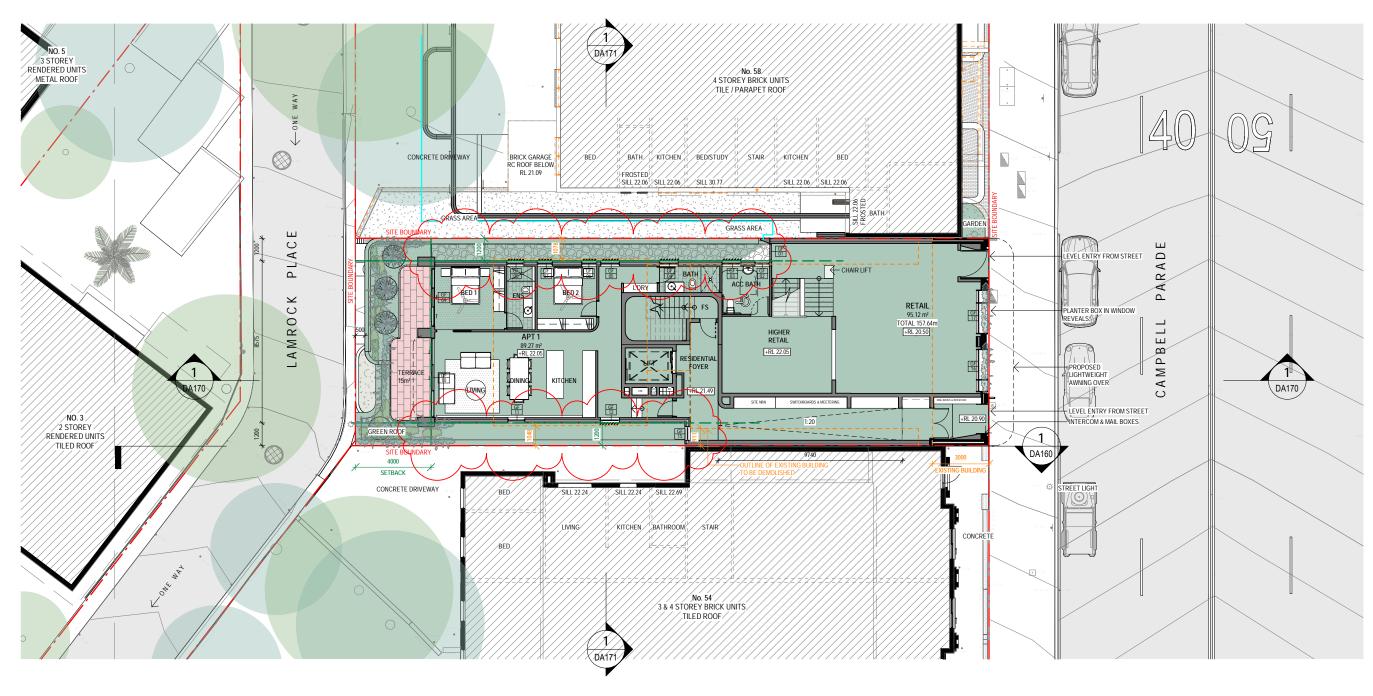
Application No: DA-367/2022

Date Received: 09/06/2023

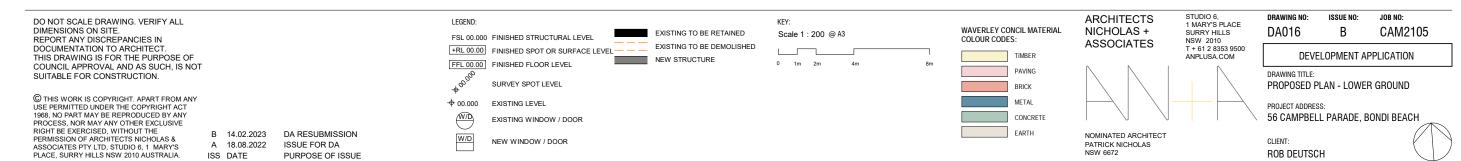



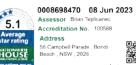



PROPOSED - GROUND FLOOR scale - 1 : 200@ A3


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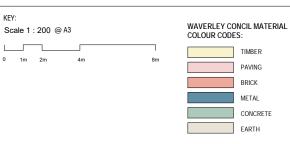
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C 30.05.2023 B 14.02.2023 A 18.08.2022 ISS DATE

DA RESUBMISSION DA RESUBMISSION ISSUE FOR DA PURPOSE OF ISSUE



NEW WINDOW / DOOR

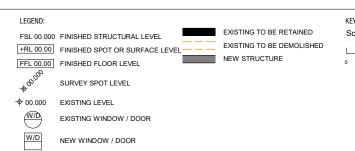

STUDIO 6, 1 MARY'S PLACE SURRY HILLS NSW 2010 T + 61 2 8353 9500 **ARCHITECTS** NICHOLAS + **ASSOCIATES** NOMINATED ARCHITECT PATRICK NICHOLAS NSW 6672

DRAWING NO: DA017 56 CAMPBELL PARADE, BONDI BEACH

ISSUE NO: JOB NO: CAM2105

DEVELOPMENT APPLICATION

DRAWING TITLE:

PROPOSED PLAN - GROUND PROJECT ADDRESS:

CLIENT: ROB DEUTSCH


Application No: DA-367/2022

Date Received: 09/06/2023







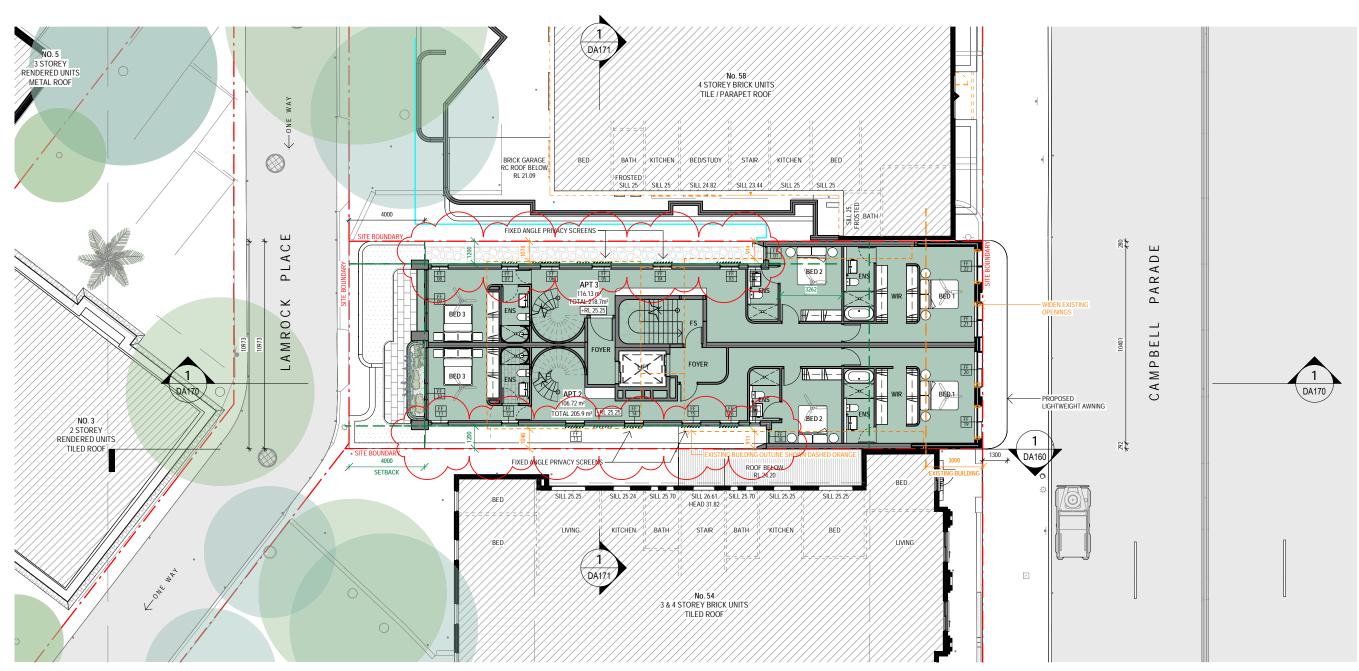



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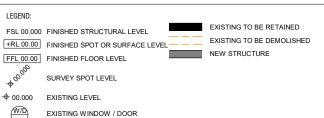
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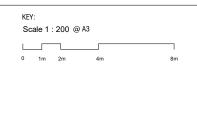
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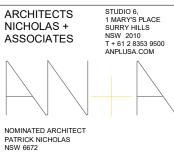
W/D

NEW WINDOW / DOOR









DRAWING NO: ISSUE NO: JOB NO: DA018 CAM2105 DEVELOPMENT APPLICATION

PROPOSED PLAN - FIRST FLOOR

PROJECT ADDRESS: 56 CAMPBELL PARADE, BONDI BEACH CLIENT:

ROB DEUTSCH


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Application No: DA-367/2022

Date Received: 09/06/2023



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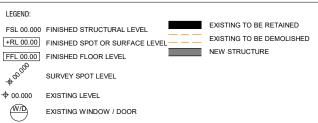
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B 30.05.2023 A 18.08.2022 ISS DATE

DA RESUBMISSION ISSUE FOR DA PURPOSE OF ISSUE

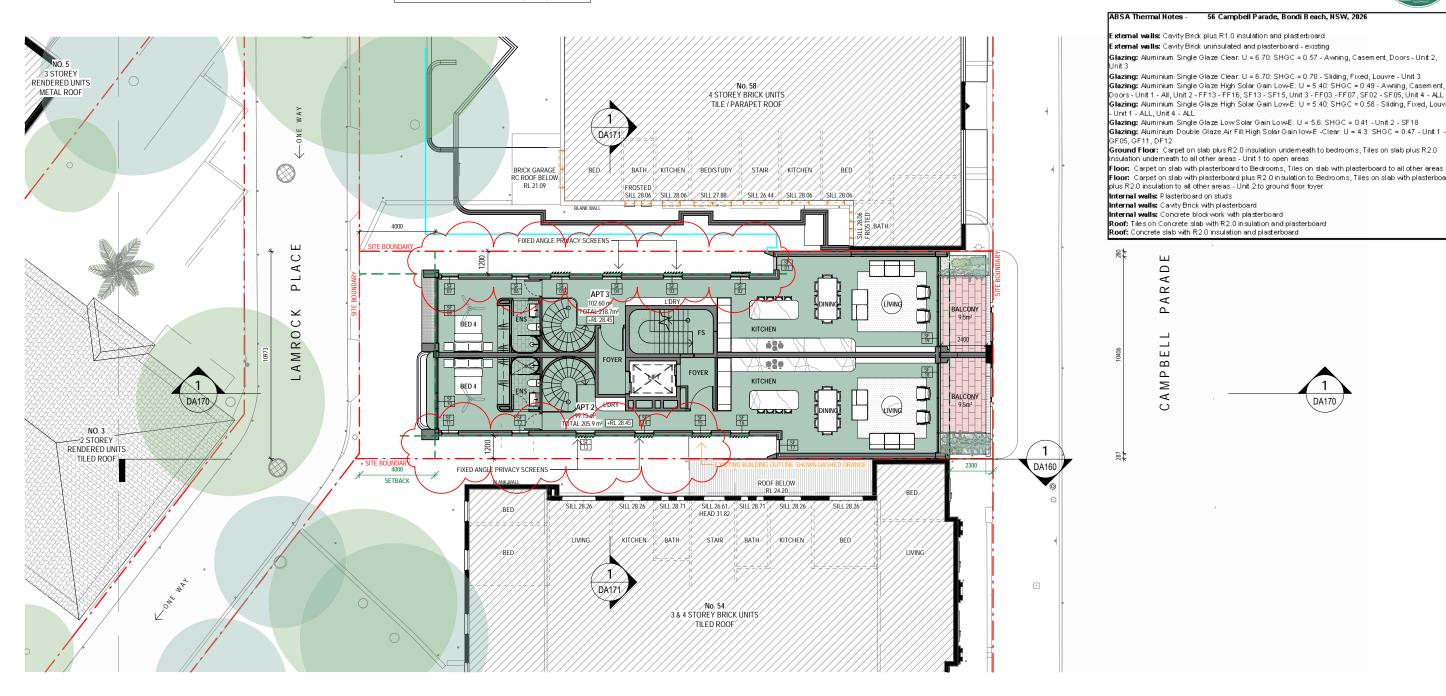W/D

NEW WINDOW / DOOR



Scale 1: 200 @ A3 COLOUR CODES:

WAVERLEY CONCIL MATERIAL BRICK MFTAI CONCRETE NOMINATED ARCHITECT

ARCHITECTS NICHOLAS + **ASSOCIATES**

PATRICK NICHOLAS NSW 6672

1 MARY'S PLACE SURRY HILLS NSW 2010 T+61 2 8353 9500

DRAWING NO: ISSUE NO: JOB NO: DA019 CAM2105 В

DEVELOPMENT APPLICATION

PROPOSED PLAN - SECOND FLOOR

PROJECT ADDRESS:

56 CAMPBELL PARADE, BONDI BEACH

CLIENT: **ROB DEUTSCH**


Application No: DA-367/2022

Date Received: 09/06/2023



0008698470 08 Jun 2023



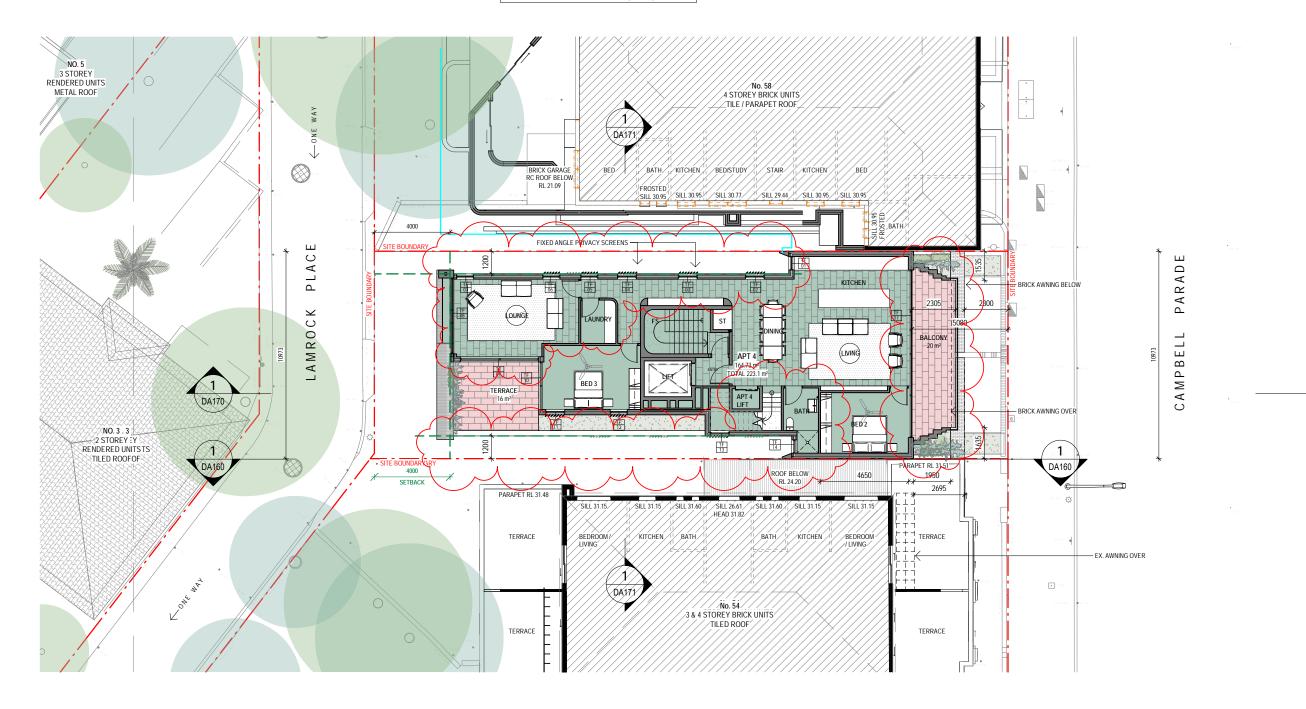



PROPOSED - THIRD FLOOR PLAN

scale - 1 : 200@ A3


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DA RESUBMISSION DA RESUBMISSION ISSUE FOR DA PURPOSE OF ISSUE



W/D

NEW WINDOW / DOOR

Scale 1: 200 @ A3 COLOUR CODES:

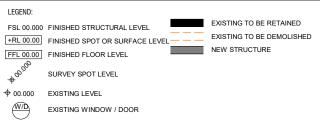ARCHITECTS WAVERLEY CONCIL MATERIAL NICHOLAS + **ASSOCIATES** CONCRETE NOMINATED ARCHITECT

STUDIO 6, 1 MARY'S PLACE SURRY HILLS NSW 2010 T + 61 2 8353 9500

DRAWING NO: ISSUE NO: JOB NO: DA020 CAM2105

DEVELOPMENT APPLICATION

DRAWING TITLE:

PROPOSED PLAN - THIRD FLOOR

PROJECT ADDRESS: 56 CAMPBELL PARADE, BONDI BEACH

CLIENT: ROB DEUTSCH

PATRICK NICHOLAS NSW 6672

BRICK


MFTAI

Application No: DA-367/2022

Date Received: 09/06/2023





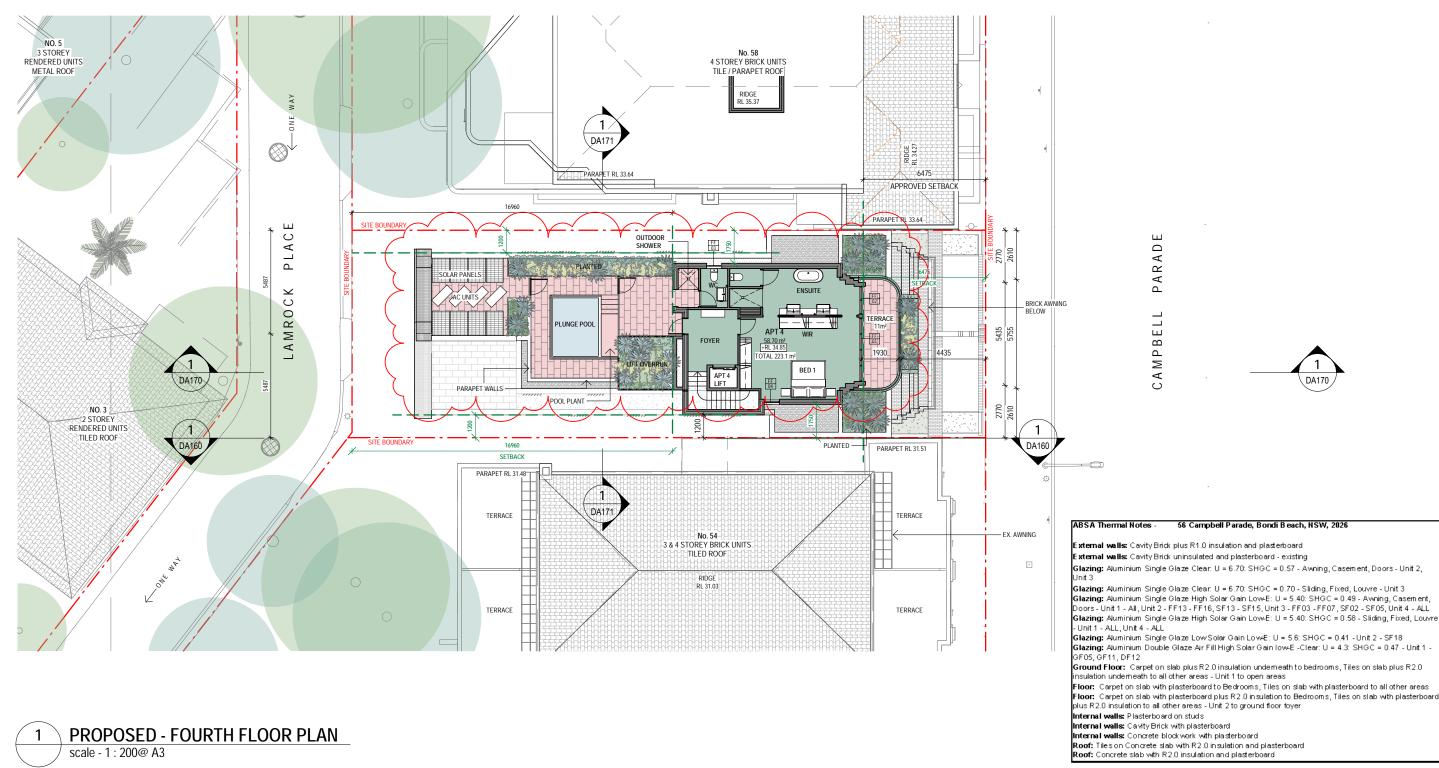

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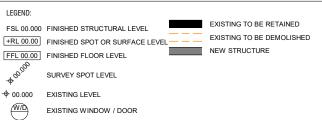
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W/D

NEW WINDOW / DOOR



WAVERLEY CONCIL MATERIAL Scale 1: 200 @ A3 COLOUR CODES:

ARCHITECTS NICHOLAS + **ASSOCIATES** NOMINATED ARCHITECT

PATRICK NICHOLAS NSW 6672

PAVING

BRICK

METAL

FARTH

CONCRETE

STUDIO 6 1 MARY'S PLACE SURRY HILLS NSW 2010 T+61 2 8353 9500

DRAWING NO: ISSUE NO: JOB NO: DA021 CAM2105

DEVELOPMENT APPLICATION

DRAWING TITLE:

PROPOSED PLAN - FOURTH FLOOR

PROJECT ADDRESS: 56 CAMPBELL PARADE, BONDI BEACH

CLIENT: ROB DEUTSCH


Application No: DA-367/2022

Date Received: 09/06/2023



0008698470 08 Jun 2023
Assessor Brian Teplicanec
Accreditation No. 100588
Address
56 Campbell Parade , Bordi
Beach , NSW , 2028



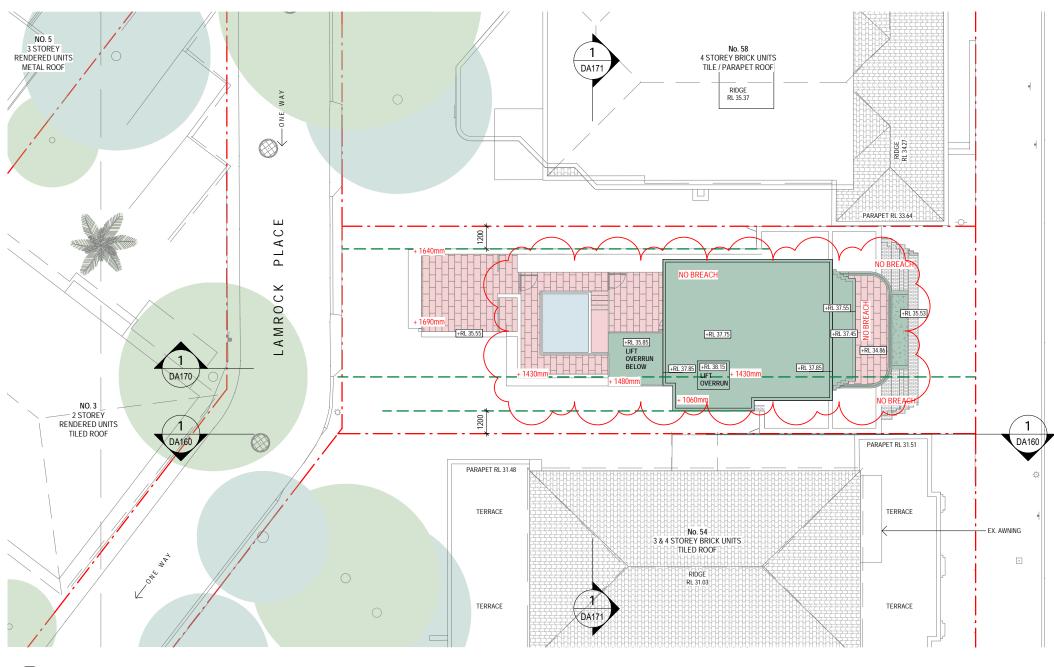


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PARADE


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1 PROPOSED - ROOF PLAN scale - 1 : 200@ A3


STUDIO 6, 1 MARY'S PLACE SURRY HILLS NSW 2010 T + 61 2 8353 9500 ANPLUSA.COM ARCHITECTS DRAWING NO: ISSUE NO: JOB NO: DO NOT SCALE DRAWING. VERIFY ALL DIMENSIONS ON SITE. REPORT ANY DISCREPANCIES IN DOCUMENTATION TO ARCHITECT. WAVERLEY CONCIL MATERIAL NICHOLAS + DA022 CAM2105 EXISTING TO BE RETAINED Scale 1: 200 @ A3 FSL 00.000 FINISHED STRUCTURAL LEVEL COLOUR CODES: **ASSOCIATES** EXISTING TO BE DEMOLISHED +RL 00.00 FINISHED SPOT OR SURFACE LEVEL DEVELOPMENT APPLICATION THIS DRAWING IS FOR THE PURPOSE OF COUNCIL APPROVAL AND AS SUCH, IS NOT NEW STRUCTURE FFL 00.00 FINISHED FLOOR LEVEL PAVING DRAWING TITLE: SUITABLE FOR CONSTRUCTION. SURVEY SPOT LEVEL PROPOSED PLAN - ROOF BRICK © THIS WORK IS COPYRIGHT. APART FROM ANY USE PERMITTED UNDER THE COPYRIGHT ACT 1968, NO PART MAY BE REPRODUCED BY ANY PROCESS, NOR MAY ANY OTHER EXCLUSIVE RIGHT BE EXERCISED, WITHOUT THE PERMISSION OF ARCHITECTS NICHOLAS & ASSOCIATES PTY LTD, STUDIO 6, 1 MARY'S PLACE, SURRY HILLS NSW 2010 AUSTRALIA. METAL ♦ 00.000 EXISTING LEVEL PROJECT ADDRESS: W/D 56 CAMPBELL PARADE, BONDI BEACH CONCRETE EXISTING WINDOW / DOOR C 30.05.2023 DA RESUBMISSION B 14.02.2023 DA RESUBMISSION EARTH W/D NOMINATED ARCHITECT NEW WINDOW / DOOR CLIENT: PATRICK NICHOLAS NSW 6672 A 18.08.2022 ISSUE FOR DA ROB DEUTSCH ISS DATE PURPOSE OF ISSUE



PROPOSED GROUND

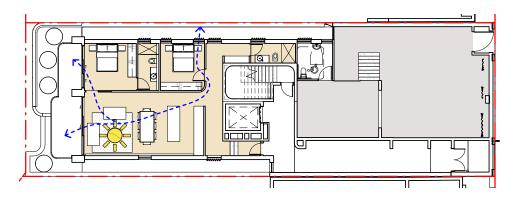

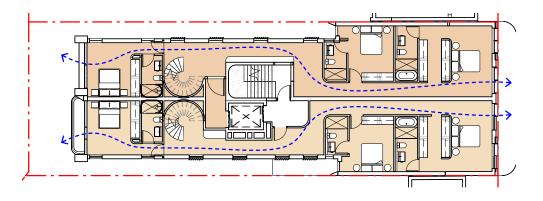PROPOSED FIRST

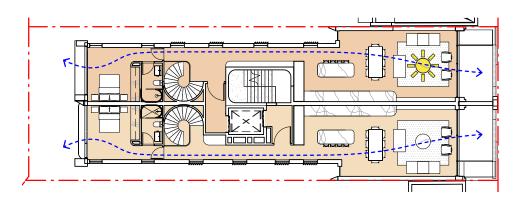

PROPOSED SECOND

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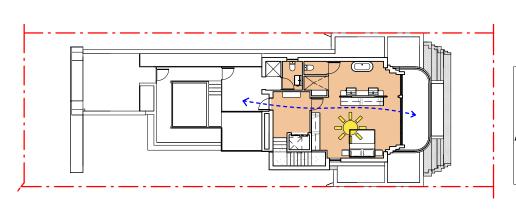
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ISS DATE

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DA RESUBMISSION DA RESUBMISSION ISSUE FOR DA PURPOSE OF ISSUE

EXISTING TO BE RETAINED FSL 00.000 FINISHED STRUCTURAL LEVEL EXISTING TO BE DEMOLISHED +RL 00.00 FINISHED SPOT OR SURFACE LEVEL NEW STRUCTURE FFL 00.00 FINISHED FLOOR LEVEL SURVEY SPOT LEVEL + 00.000 EXISTING LEVEL W/D EXISTING WINDOW / DOOR W/D NEW WINDOW / DOOR



RECEIVED Waverley Council

Application No: DA-367/2022

Date Received: 09/06/2023

PROPOSED ROOF

PROPOSED THIRD

NATURAL CROSS VENTILATION REQUIREMENT :

60% OF RESIDENTIAL UNITS SHOULD BE NATURALLY CROSS VENTILATED TOTAL OF 4 UNITS
2 APARTMENTS SHOULD BE NATURALLY CROSS VENTILATED

NATURAL CROSS VENTILATION PROVIDED:

TOTAL OF 4 UNITS ARE NATURALLY CROSS VENTILATED 100% OF RESIDENTIAL UNITS ARE NATURALLY CROSS VENTILATED

ADG SOLAR ACCESS REQUIREMENT:

LIVING ROOMS & PRIVATE OPEN SPACES OF AT LEAST 70% OF APARTMENTS IN A BUILDING RECEIVE A MINIMUM OF 2 HOURS DIRECT SUNLIGHT BETWEEN 9AM & 3PM

A MAXIMUM OF 15% OF APARTMENTS IN A BUILDING RECEIVE NO DIRECT SUNLIGHT BETWEEN 9AM & 3PM IN MID-WINTER

SOLAR ACCESS PROVIDED:

TOTAL OF 3 UNITS (75% OF 4 APARTMENTS) RECEIVE MINIMUM DIRECT SUNLIGHT ON 21 JUNE BETWEEN 9AM & 3PM

STUDIO 6, 1 MARY'S PLACE SURRY HILLS NSW 2010 T+61 2 8353 9500 **ARCHITECTS** NICHOLAS + **ASSOCIATES** PROJECT ADDRESS: 56 CAMPBELL PARADE, BONDI BEACH NOMINATED ARCHITECT PATRICK NICHOLAS NSW 6672

DA100 CAM2105

DRAWING NO:

DEVELOPMENT APPLICATION


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JOB NO:


CROSS VENTILATION, SOLAR ACCESS

CLIENT:


ROB DEUTSCH

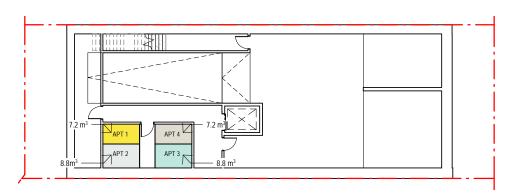


PROPOSED BASEMENT 1

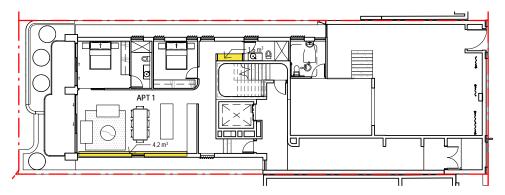


PROPOSED GROUND

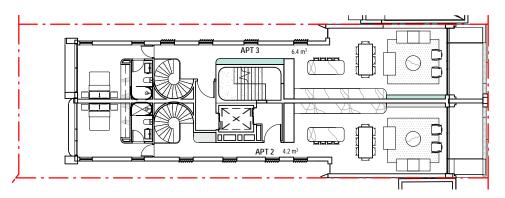


PROPOSED SECOND

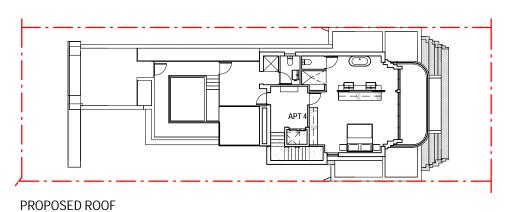

PROPOSED LOWER GROUND

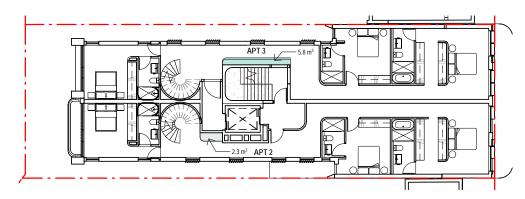

PROPOSED FIRST

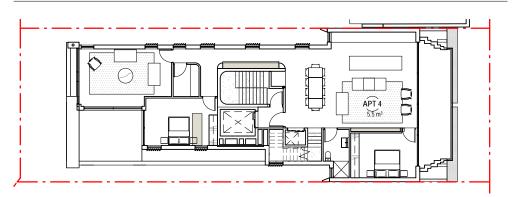

PROPOSED THIRD

STORAGE PROVIDED:

FULL HEIGHT STORAGE JOINERY UNITS PROVIDED

WITHIN EACH APARTMENT			
APT NO.	TYPE	VOLUME TOTAL	VOLUME INT.(ADG 50%)
APT 1	2 BED	13 m ³	5.8 m ³
APT 2	4 BED	21 m ³	12.2 m ³
APT 3	4 BED	15.3 m ³	6.5 m ³
APT 4	3 BED	12.7 m ³	5.5 m ³

Design criteria In addition to storage in kitchens, bathrooms and bedrooms, the following storage is provided: $4m^3$ 6m³ 1 bedroom apartments 8m³ 2 bedroom apartments 10m3 At least 50% of the required storage is to be located within the apartment

RECEIVED Waverley Council

Application No: DA-367/2022

Date Received: 09/06/2023


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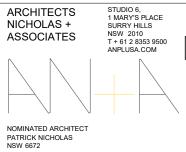
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ISS DATE

A 14.02.2023 DA RESUBMISSION PURPOSE OF ISSUE





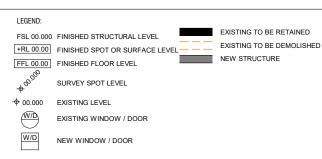

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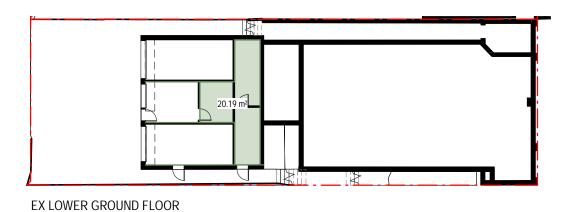
DEVELOPMENT APPLICATION

DRAWING TITLE: STORAGE PLANS

PROJECT ADDRESS: 56 CAMPBELL PARADE, BONDI BEACH


CLIENT: ROB DEUTSCH

Page 477 of 500




Application No: DA-367/2022

Date Received: 09/06/2023

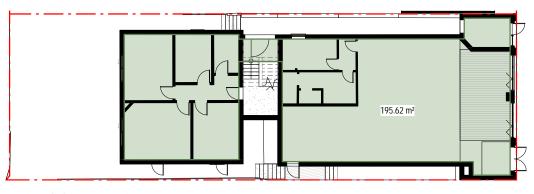

EXISTING GROUND FLOOR

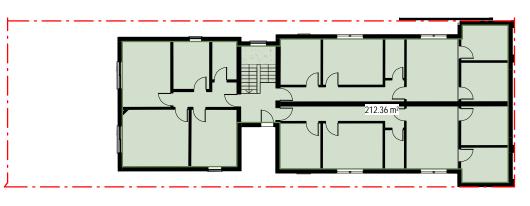

EXISTING FIRST FLOOR

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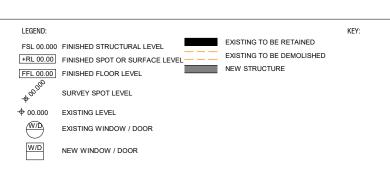
A 18.08.2022

ISS DATE

ISSUE FOR DA

PURPOSE OF ISSUE

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ARCHITECTS NICHOLAS + **ASSOCIATES**

PATRICK NICHOLAS NSW 6672

STUDIO 6, 1 MARY'S PLACE SURRY HILLS NSW 2010 T + 61 2 8353 9500 NOMINATED ARCHITECT

SITE METRICS

367.9m²

1104m²

3:1

428.17m²

1.16 : 1

AREA

20.19 m²

195.62 m² 212.36 m²

428.17 m²

SITE AREA =

ALLOWABLE GFA

ALLOWABLE (FSR)

EXISTING EXISTING GFA =

EXISTING GFA SCHEDULE

EX LOWER GROUND FLOOR

EX GROUND FLOOR

EX FIRST FLOOR TOTAL GFA

EXISTING . FSR

LEVEL

DA120

DRAWING NO:

DEVELOPMENT APPLICATION

ISSUE NO:

JOB NO:


CAM2105

DRAWING TITLE: EXISTING GFA PLANS

PROJECT ADDRESS: 56 CAMPBELL PARADE, BONDI BEACH


CLIENT: ROB DEUTSCH

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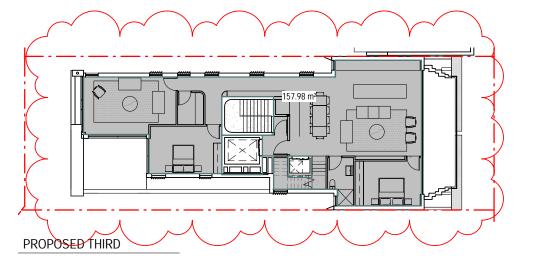


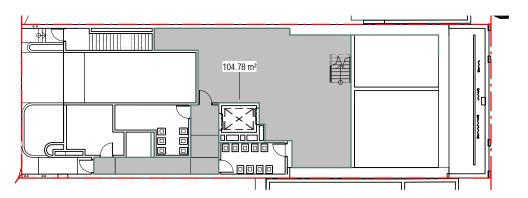
PROPOSED LOWER GROUND


PROPOSED GROUND

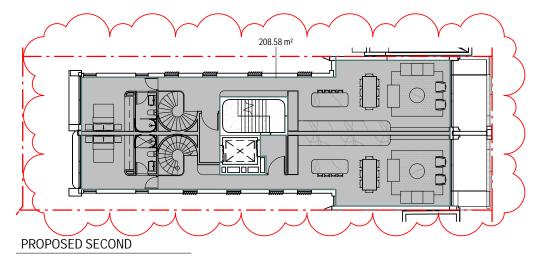

226.51 m²



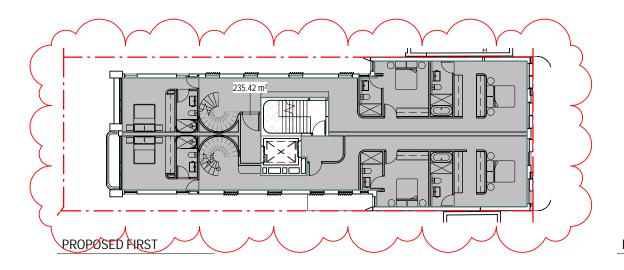

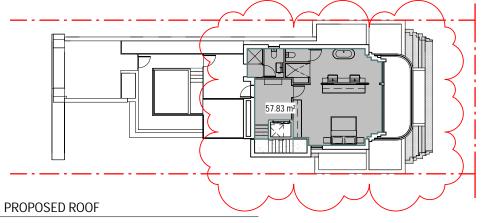

SITE METRICS

SITE AREA = 367.9m² ALLOWABLE GFA 1104m² ALLOWABLE (FSR) 3:1

EXISTING

EXISTING GFA = 428.17m² EXISTING . FSR 1.16:1

PROPOSED

PROPOSED GFA = PROPOSED FSR

991.09 m² 2.69:1 (991.09/367.9)

PROPOSED GFA SCHEDULE


LEVEL PROPOSED LOWER GROUND PROPOSED GROUND PROPOSED FIRST PROPOSED SECOND PROPOSED THIRD PROPOSED ROOF TOTAL GFA

GFA m² 104.78 m² 226.51 m² 235.42 m² 208.58 m² 157.98 m² 57.83 m² 991.09 m²

4

JOB NO:

NSA SHEDULE

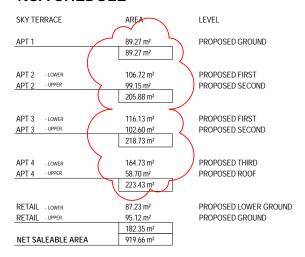

TOTAL APARTMENTS

RECEIVED Waverley Council

Application No: DA-367/2022

Date Received: 09/06/2023

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PLOTTED: 6/06/2023 11:40:41 AM

C 30.05.2023 B 14.02.2023 A 18.08.2022 ISS DATE

DA RESUBMISSION DA RESUBMISSION ISSUE FOR DA PURPOSE OF ISSUE

FSL 00.000 FINISHED STRUCTURAL LEVEL +RL 00.00 FINISHED SPOT OR SURFACE LEVEL FFL 00.00 FINISHED FLOOR LEVEL SURVEY SPOT LEVEL **→** 00.000 EXISTING LEVEL EXISTING WINDOW / DOOR W/D

NEW WINDOW / DOOR

EXISTING TO BE RETAINED EXISTING TO BE DEMOLISHED

NOMINATED ARCHITECT

ARCHITECTS

NICHOLAS +

ASSOCIATES

STUDIO 6, 1 MARY'S PLACE SURRY HILLS NSW 2010 T + 61 2 8353 9500

DRAWING NO:

ISSUE NO: DA121 CAM2105


DEVELOPMENT APPLICATION

DRAWING TITLE: PROPOSED GFA PLANS


PROJECT ADDRESS: 56 CAMPBELL PARADE, BONDI BEACH

CLIENT: ROB DEUTSCH

Page 479 of 500

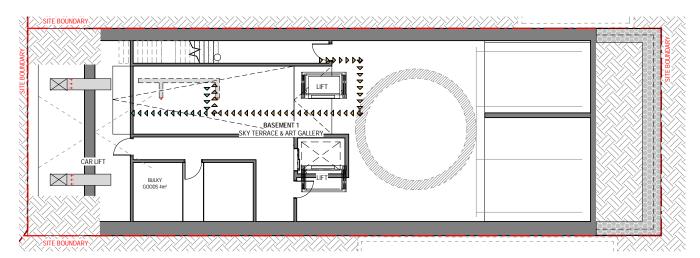


PROPOSED - BASEMENT 1 WASTE MANAGEMENT

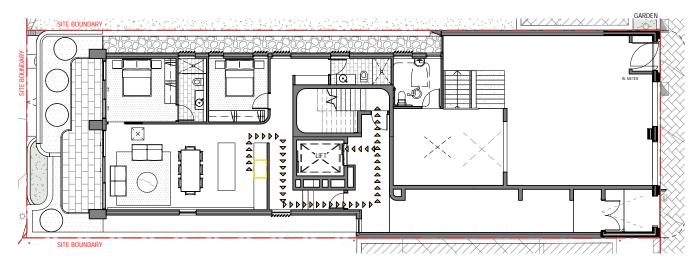


PROPOSED - GROUND FLOOR WASTE MANAGEMENT

Application No: DA-367/2022


Date Received: 09/06/2023

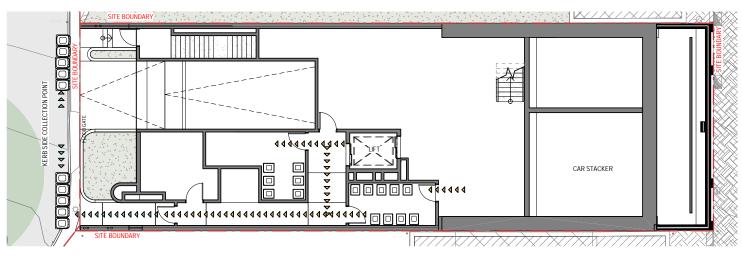

PROPOSED - LOWER GROUND WASTE MANAGEMENT

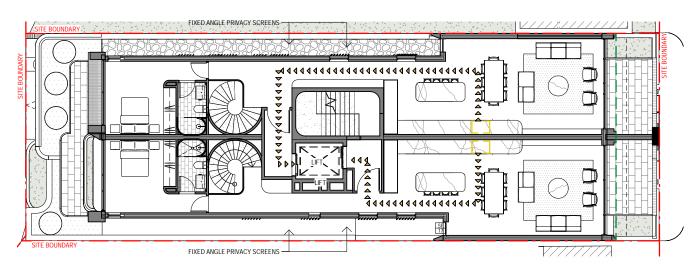

PROPOSED - SECOND FLOOR WASTE MANAGEMENT

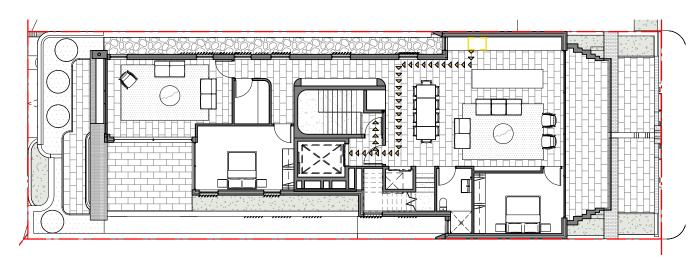

PROPOSED - THIRD FLOOR WASTE MANAGEMENT

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PLOTTED: 26/05/2023 2:57:18 PM

A 18.08.2022 ISS DATE

ISSUE FOR DA PURPOSE OF ISSUE + 00.000 W/D NEW WINDOW / DOOR

EXISTING TO BE RETAINED FSL 00.000 FINISHED STRUCTURAL LEVEL EXISTING TO BE DEMOLISHED +RL 00.00 FINISHED SPOT OR SURFACE LEVEL NEW STRUCTURE FFL 00.00 FINISHED FLOOR LEVEL SURVEY SPOT LEVEL EXISTING LEVEL EXISTING WINDOW / DOOR

Scale 1: 200 @ A3

STUDIO 6, 1 MARY'S PLACE SURRY HILLS NSW 2010 T + 61 2 8353 9500 **ARCHITECTS** NICHOLAS + **ASSOCIATES** NOMINATED ARCHITECT PATRICK NICHOLAS NSW 6672

DRAWING NO: ISSUE NO: DA130

DEVELOPMENT APPLICATION


JOB NO:

CAM2105

DRAWING TITLE: WASTE MANAGEMENT PLAN

PROJECT ADDRESS: 56 CAMPBELL PARADE, BONDI BEACH

CLIENT: ROB DEUTSCH

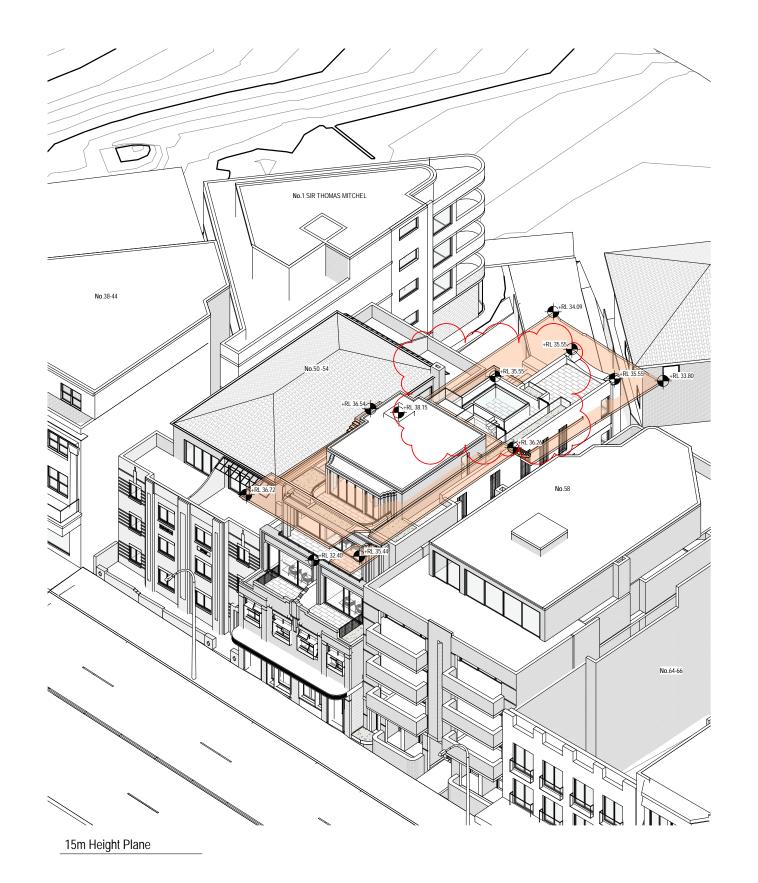

Application No: DA-367/2022

Date Received: 09/06/2023


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PLOTTED: 26/05/2023 2:57:49 PM

C 30.05.2023 A 18.08.2022 ISS DATE

DA RESUBMISSION DA RESUBMISSION ISSUE FOR DA PURPOSE OF ISSUE



ARCHITECTS NICHOLAS + **ASSOCIATES** NOMINATED ARCHITECT

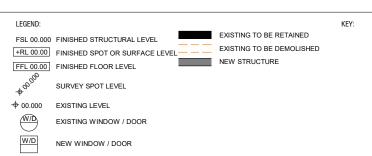PATRICK NICHOLAS NSW 6672

STUDIO 6, 1 MARY'S PLACE SURRY HILLS NSW 2010 T + 61 2 8353 9500 ANPLUSA.COM

DEVELOPMENT APPLICATION

ISSUE NO:

JOB NO:

CAM2105

HEIGHT PLANE


DRAWING NO:

DA140


PROJECT ADDRESS: 56 CAMPBELL PARADE, BONDI BEACH

CLIENT: ROB DEUTSCH

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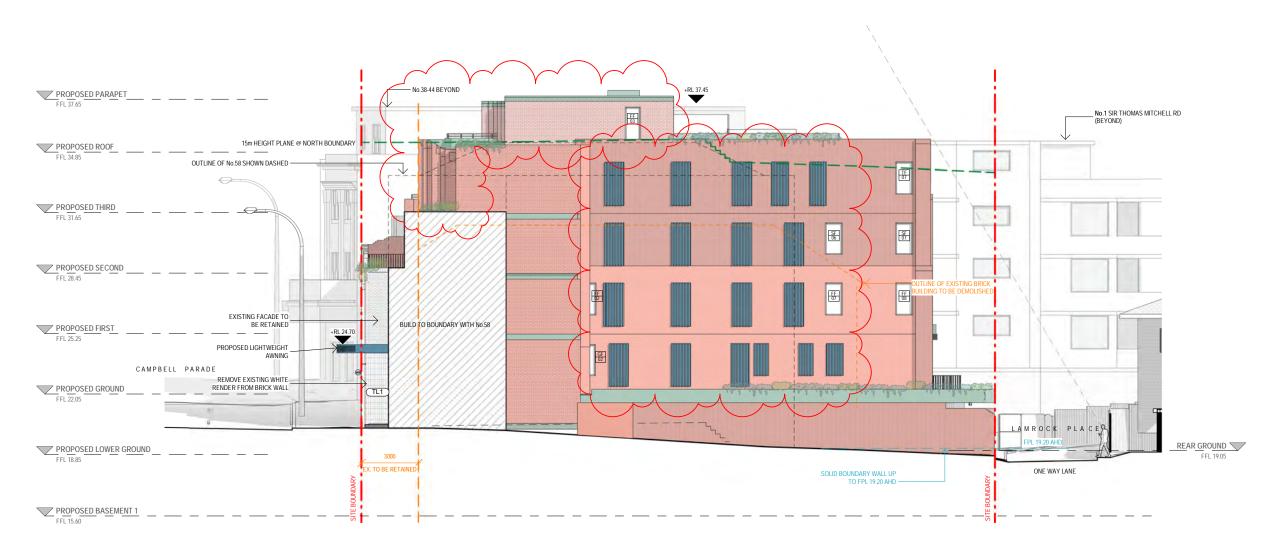


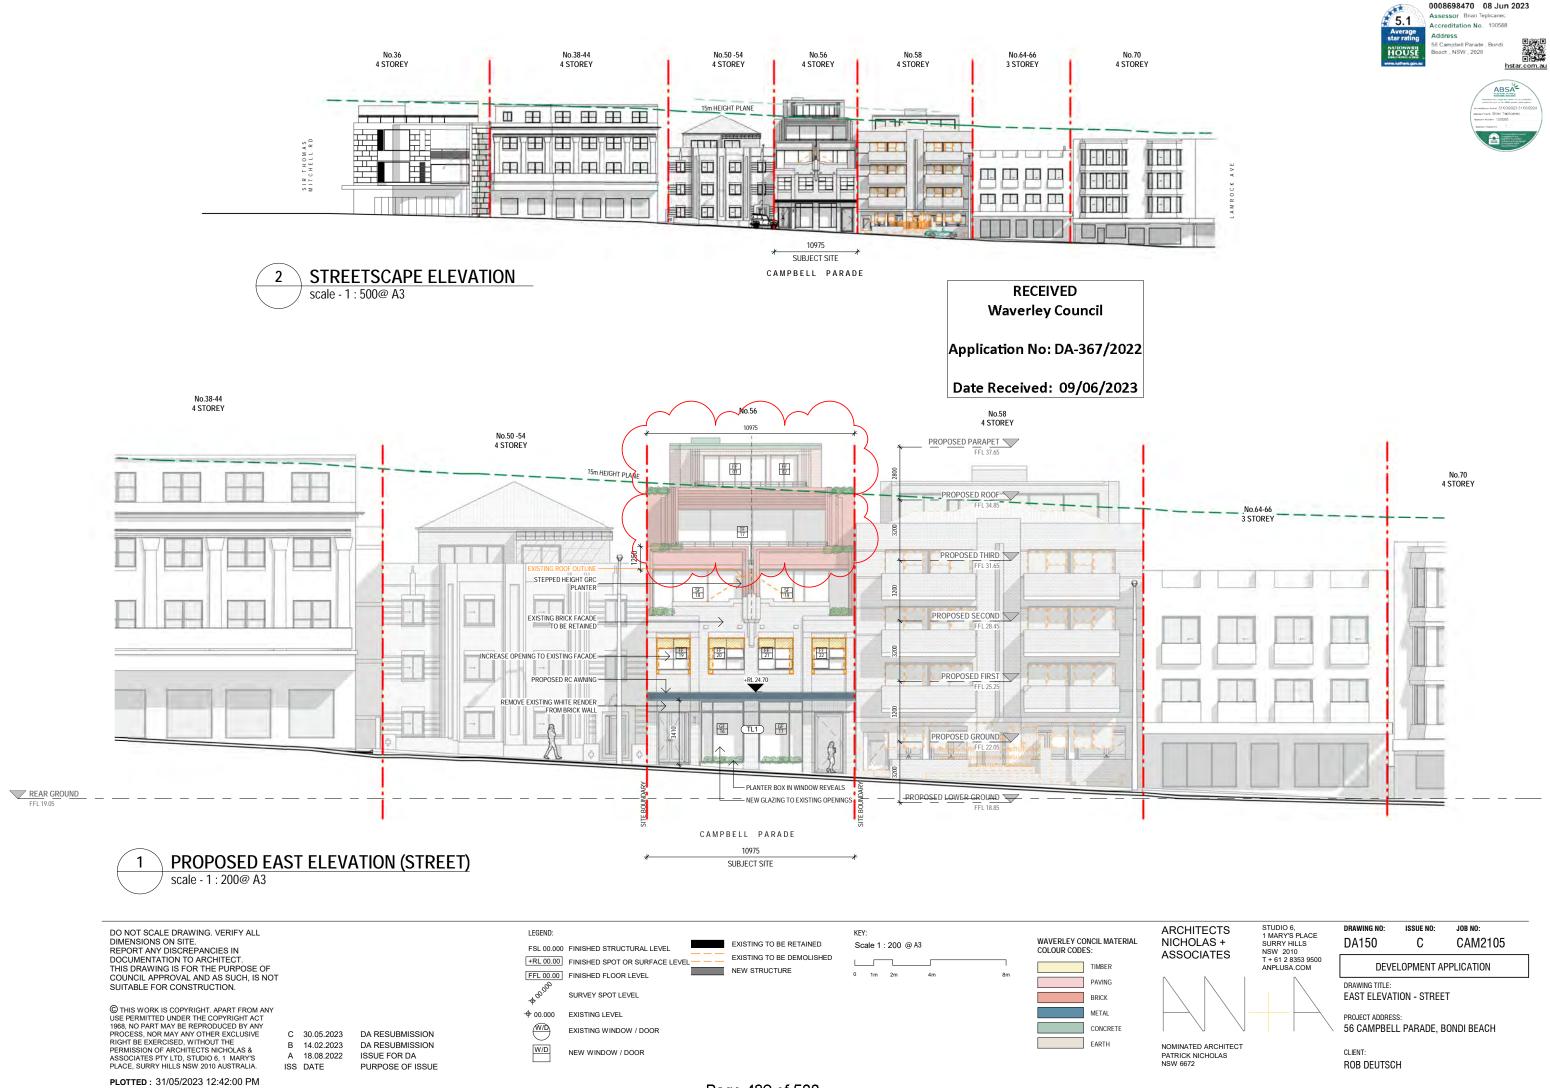Application No: DA-367/2022


Date Received: 09/06/2023

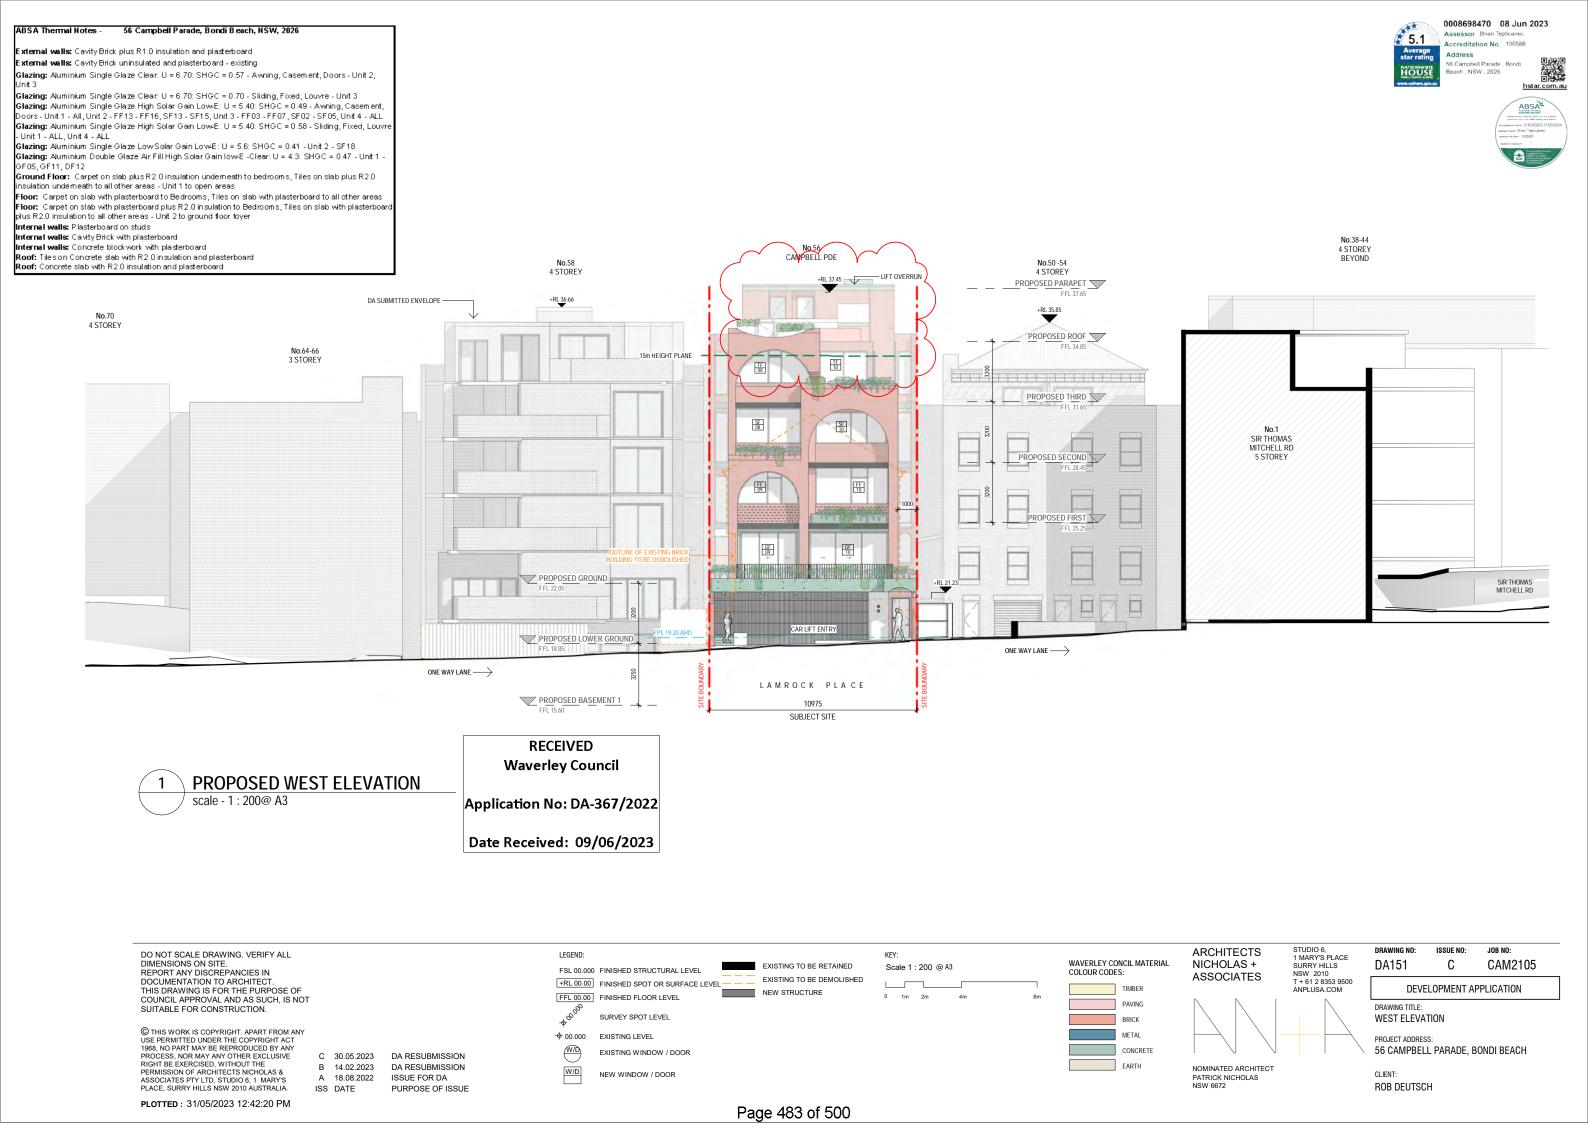







1 PROPOSED NORTH ELEVATION scale - 1 : 200@ A3

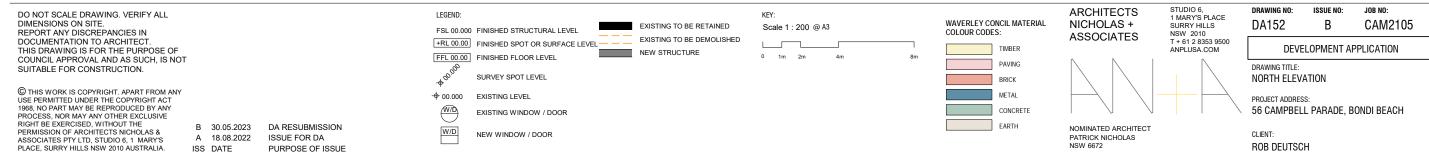

PLOTTED: 31/05/2023 12:42:39 PM

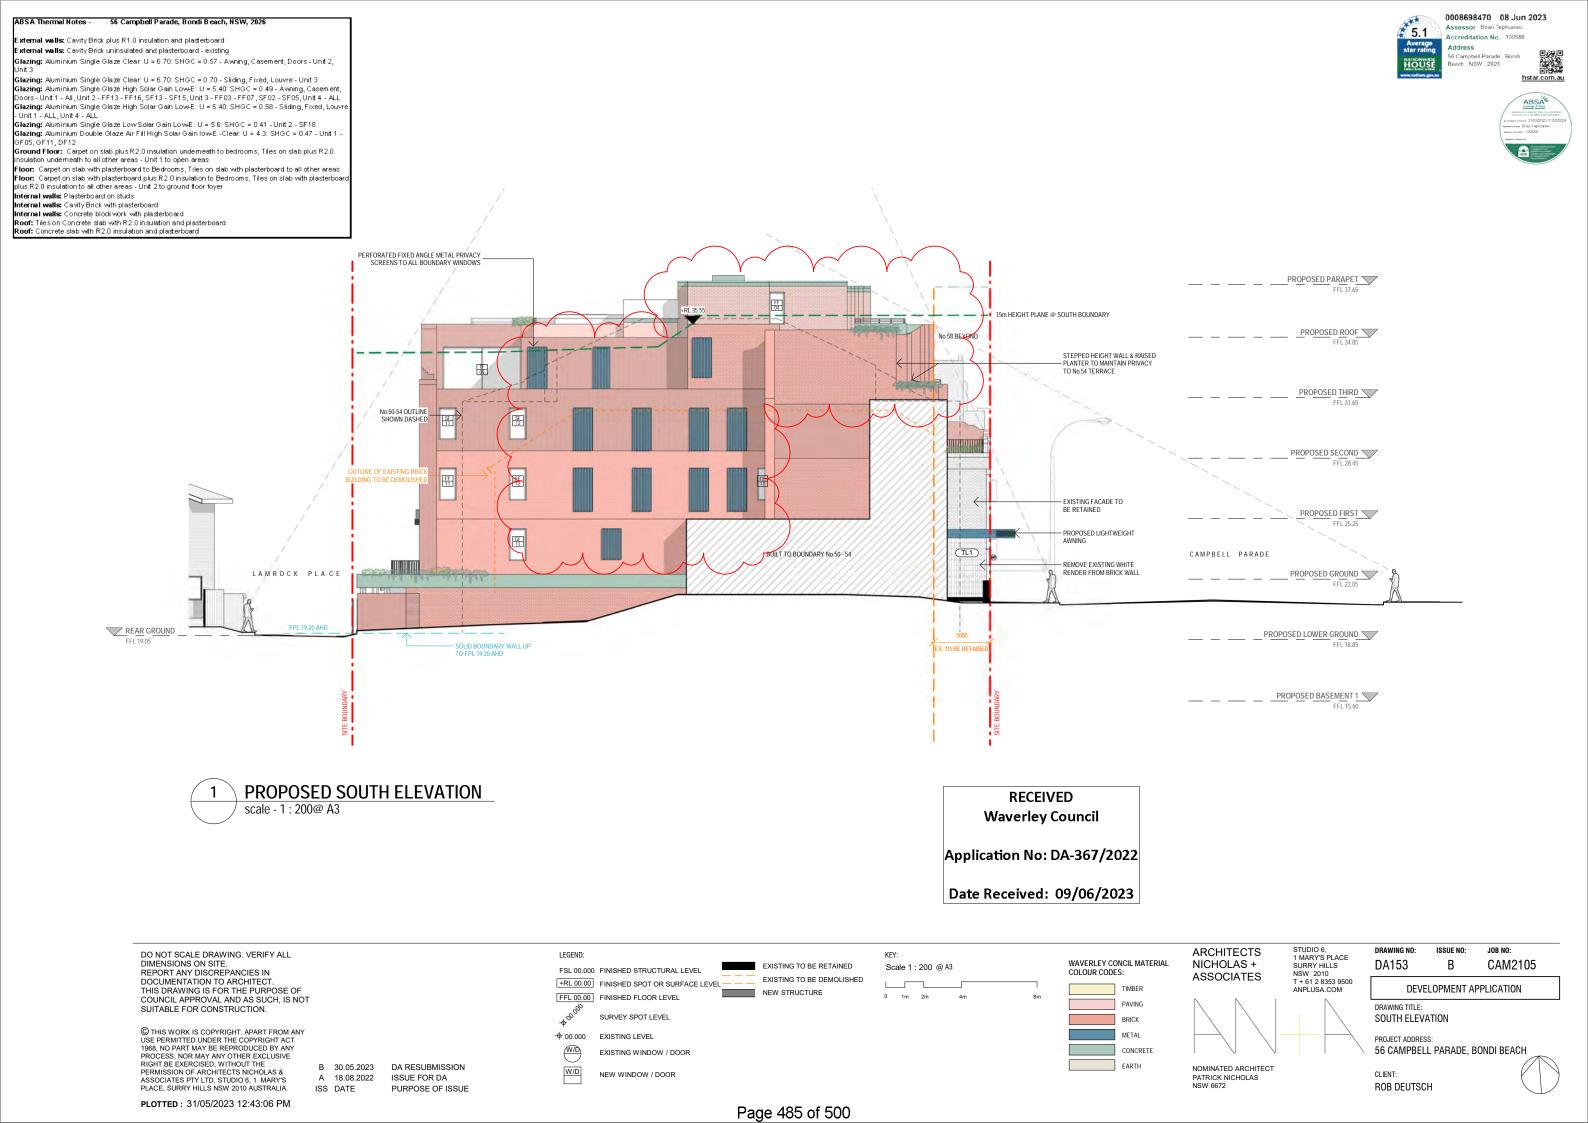

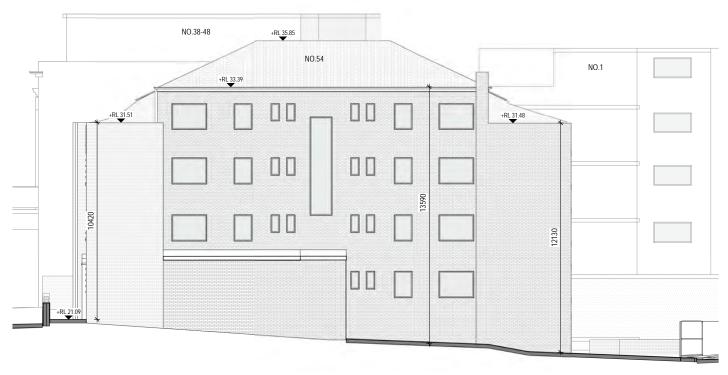

NORTH ELEVATION - NO 54 scale - 1 : 200@ A3


> **RECEIVED Waverley Council**

Application No: DA-367/2022

Date Received: 09/06/2023

W/D

NEW WINDOW / DOOR

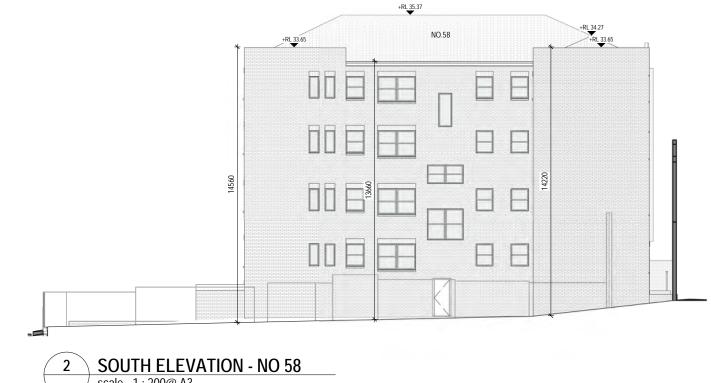

scale - 1 : 200@ A3


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PLOTTED: 26/05/2023 3:00:08 PM

A 14.02.2023 ISS DATE

DA RESUBMISSION PURPOSE OF ISSUE



Scale 1: 200 @ A3

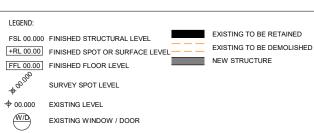STUDIO 6, 1 MARY'S PLACE SURRY HILLS NSW 2010 T + 61 2 8353 9500 ANPLUSA.COM **ARCHITECTS** NICHOLAS + **ASSOCIATES** NOMINATED ARCHITECT PATRICK NICHOLAS NSW 6672

DRAWING NO: ISSUE NO: JOB NO: DA160 CAM2105


CLIENT:

ROB DEUTSCH

DEVELOPMENT APPLICATION

NEIGHBOURS' WALL HEIGHT STUDY

PROJECT ADDRESS: 56 CAMPBELL PARADE, BONDI BEACH

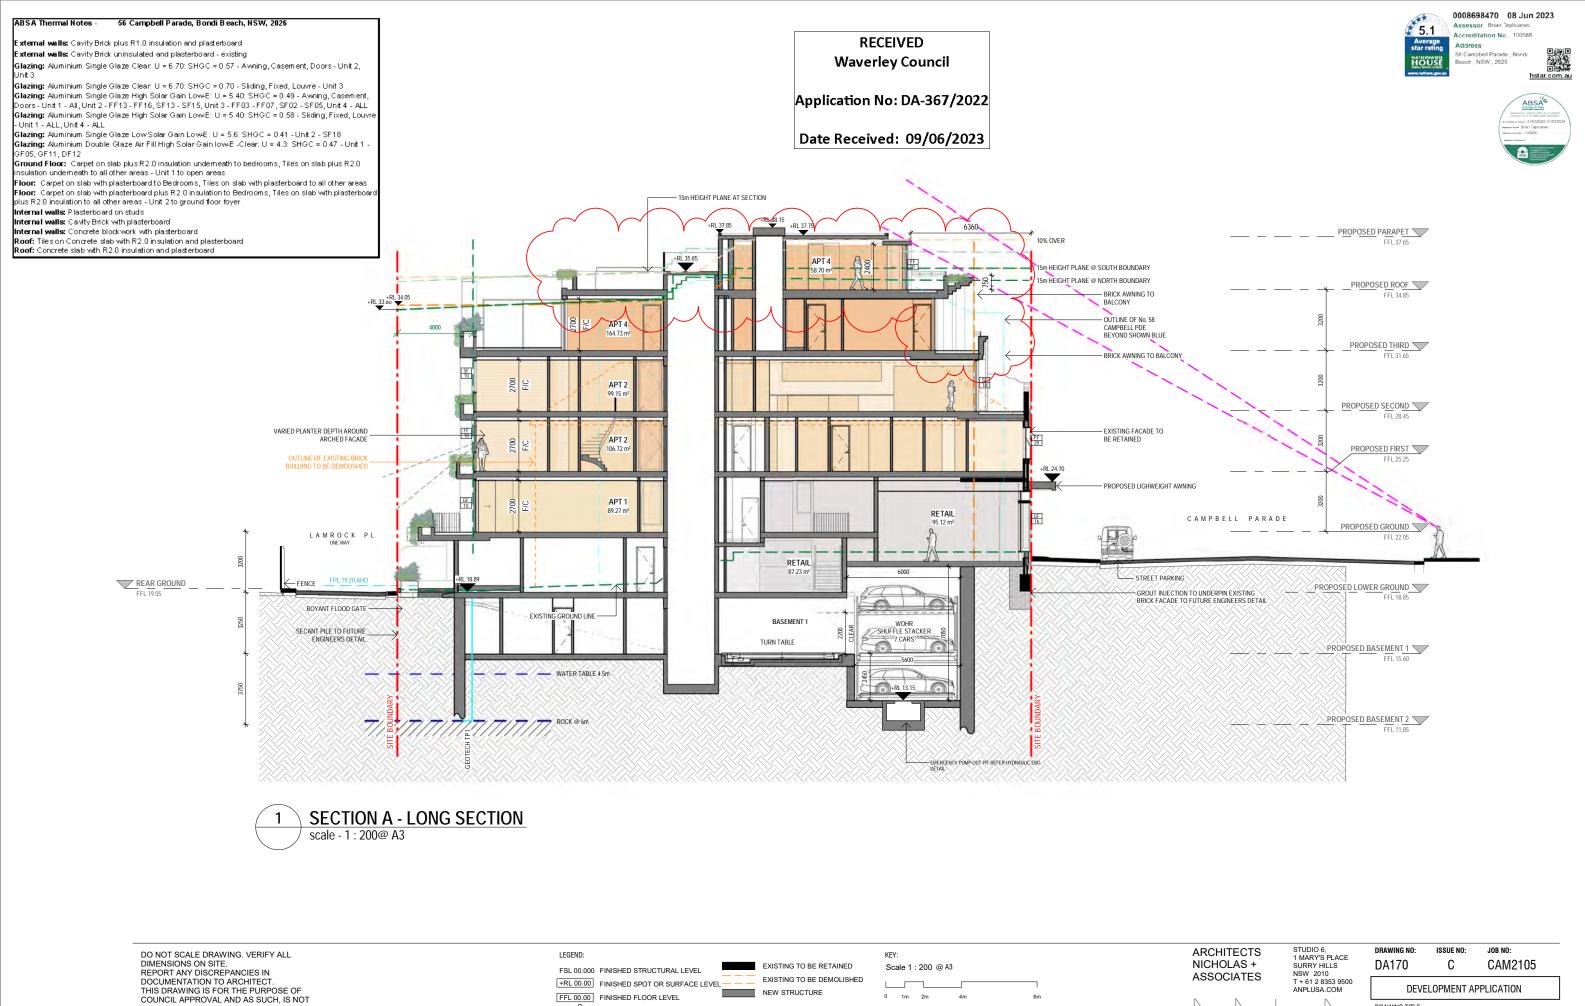



DRAWING TITLE:

DA RESUBMISSION

DA RESUBMISSION

PURPOSE OF ISSUE

ISSUE FOR DA

C 30.05.2023

B 14.02.2023

A 18.08.2022

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FFL 00.00 FINISHED FLOOR LEVEL


→ 00.000

W/D

W/D

SURVEY SPOT LEVEL

EXISTING LEVEL

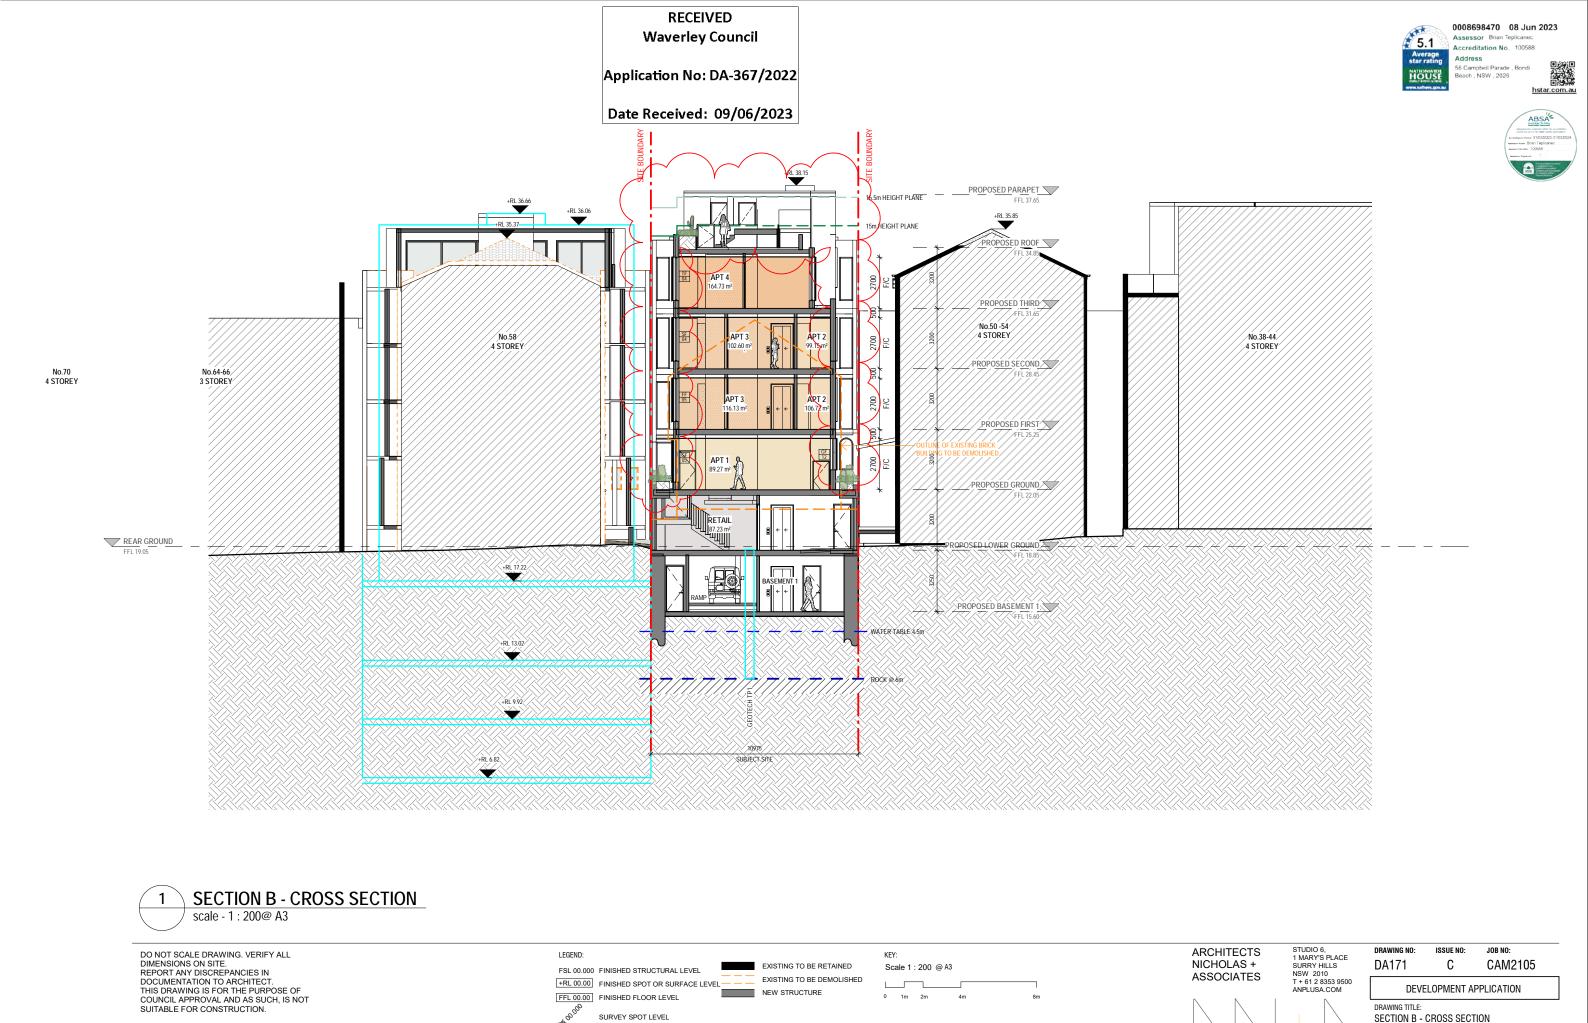

PROJECT ADDRESS:

ROB DEUTSCH

CLIENT:

NOMINATED ARCHITECT

PATRICK NICHOLAS NSW 6672 56 CAMPBELL PARADE, BONDI BEACH

+ 00.000

W/D

W/D

EXISTING LEVEL

EXISTING WINDOW / DOOR

NEW WINDOW / DOOR

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PLOTTED: 26/05/2023 3:00:36 PM

C 30.05.2023

A 18.08.2022

ISS DATE

DA RESUBMISSION DA RESUBMISSION

PURPOSE OF ISSUE

ISSUE FOR DA

ARCHITECTURAL DRAWING LIST

SHEET NO	SHEET NAME	REV	DATE
DA000	COVER PAGE + PHOTOMONTAGE	С	30.05.2023
DA001	DRAWING REGISTER + BASIX + FINISHES SCHEDULE	С	30.05.2023
DA002	SITE CONTEXT	Α	18.08.2022
DA004	STREETSCAPE ANALYSIS	Α	18.08.2022
DA005	SITE ANALYSIS	Α	18.08.2022
DA006	SITE PLAN	С	30.05.2023
DA010	EXISTING + DEMOLITION - LOWER GROUND FLOOR	Α	18.08.2022
DA011	EXISTING + DEMOLITION - GROUND FLOOR	Α	18.08.2022
DA012	EXISTING + DEMOLITION - FIRST FLOOR	Α	18.08.2022
DA013	EXISTING + DEMOLITION - ROOF	Α	18.08.2022
DA014	PROPOSED PLAN - BASEMENT 2	В	14.02.2023
DA015	PROPOSED PLAN - BASEMENT 1	В	14.02.2023
DA016	PROPOSED PLAN - LOWER GROUND	В	14.02.2023
DA017	PROPOSED PLAN - GROUND	С	30.05.2023
DA018	PROPOSED PLAN - FIRST FLOOR	В	30.05.2023
DA019	PROPOSED PLAN - SECOND FLOOR	В	30.05.2023
DA020	PROPOSED PLAN - THIRD FLOOR	С	30.05.2023
DA021	PROPOSED PLAN - FOURTH FLOOR	С	30.05.2023
DA022	PROPOSED PLAN - ROOF	С	30.05.2023
DA100	CROSS VENTILATION, SOLAR ACCESS	С	30.05.2023
DA101	STORAGE PLANS	Α	14.02.2023
DA120	EXISTING GFA PLANS	Α	18.08.2022
DA121	PROPOSED GFA PLANS	С	30.05.2023
DA130	WASTE MANAGEMENT PLAN	Α	18.08.2022
DA140	HEIGHT PLANE	С	30.05.2023
DA150	EAST ELEVATION - STREET	С	30.05.2023
DA151	WEST ELEVATION	С	30.05.2023
DA152	NORTH ELEVATION	В	30.05.2023
DA153	SOUTH ELEVATION	В	30.05.2023
DA160	NEIGHBOURS' WALL HEIGHT STUDY	Α	14.02.2023
DA170	SECTION A - LONG SECTION	С	30.05.2023
DA171	SECTION B - CROSS SECTION	С	30.05.2023
DA700	VIEW FROM SUN - JUNE 21 - 9AM	С	30.05.2023
DA701	VIEW FROM SUN - JUNE 21 - 10AM	С	30.05.2023
DA702	VIEW FROM SUN - JUNE 21 - 11AM	С	30.05.2023
DA703	VIEW FROM SUN - JUNE 21 - 12PM	С	30.05.2023
DA704	VIEW FROM SUN - JUNE 21 - 1PM	С	30.05.2023
DA705	VIEW FROM SUN - JUNE 21 - 2PM	С	30.05.2023
DA706	VIEW FROM SUN - JUNE 21 - 3PM	С	30.05.2023
DA708	SHADOW PLAN - JUNE 21 - 9AM	С	30.05.2023
DA709	SHADOW PLAN - JUNE 21 - 12PM	С	30.05.2023
DA710	SHADOW PLAN - JUNE 21 - 3PM	С	30.05.2023

	56 C	impbell Street Bondi I	Beach				
SUMMAR	RY OF BASI	X COMMITMEN	NTS FC	RE	ACH L	INIT	
This is a sun Re	for to the CURRE	X Commitments as deb NT BASIX Certificate fo Bons refer to basix row	r Complete	BAS	CX Certifica ils.	de.	
WATER COM	MITMENTS						
Fixtures							
4 Star Showe	r Heads	Yes (> 6 but <= 7.5 L/min)					
5 Star Kitcher	/ Basin Taps	Yes	4 Star To	ilet	et Yes		
THERMAL CO	MFORT COM	AITMENTS - Refer to	TPA Sp	ecifi	cation or	plans	
ENERGY COM	MITMENTS						
Hot Water	Gas instantane	ous 6 Star					
Cooling	Living	3 Phase A/C Zoned EE			EER 3.	EER 3.0 - 3.5	
System	Bedrooms	Ceiling Fars + 3 Phase AIC Zoned EER 3.0 -			1-35		
Heating	Living	3 Phase A/C Zoned EER 3.0 - 3.1			1-35		
System	Bedrooms	3 Phase A/C Zoned EER 3.0 -			1-35		
	1 x Bathroom	Fan ducted to exterior Manual o			Toke		
Ventilation	Kitchen	Fair ducted to exterior			Manual on/off		
	Laundry	Fan ducted to exterior			Manual coloff		
Natural	Window/Skylight in Kitchen As drawn						
Lighting	Window/Skyli	mandage and property of the control of		s drawn			
Artificial	Number of bea	śrooms	Al		dicated	Yes	
Lighting		ing/Dining rooms	Alt		dicated	Yes	
(rooms to be	Kitchen		Yes			Yes	
primarily lit by fluorescent or		All Bathrms/Toilets Y				Yes	
LED lights)	Laundry			Dedicated		Yes	
	All Hallways		Yes	De	dicated	Yes	
OTHER COM				-		-	
Out & Indoor o		No Ventilated refrigerator space			Yes		
Stove/Oven		Gas cooktop & electric					
Alternative En		taic System: 2.3kW cor 15KL, no heating, pur					

Building Su	23		BSA	Reference: 174	
Building Sustainability Assessments enquiries@buildingsustainability.net.au			Ph: (02) 4962 34 www. buildingsustainability.net.		
		portant Note			
The Assessor Assessor and	specification was used to Certificate. If the propose NatHERS certificates will uns for building sealing & v	d construction I no longer be	varies to those detail valid. Assessments a	led below than it essume that the	
 Thermal co Thermal bri Floor insule 	MASOY & the BCA variations restriction in accordance is take for Class 1 dwellings fron for Class 1 dwellings aling in accordance with S	with Vol 1 Sect in accordance as per Part 3.	ion J1.2 or Vol 2: Part with Part 3.12.1.2(c) 12.1.5(a)(ii): (iii) 8 (e)	3.12.1.1 & 3.12.1.4(d) or (c), (d) & (e)	
1	Thermal Performance Sp	ecifications (does not apply to ga	rage)	
	Il Construction			Added Insulate	
Cavity Brick				R1.	
Lightweight	& Brick Veneer			R2.	
Internal Wal	Construction			Added Insulation	
Plasterboon	on study (internal to unit	10		No	
	w/Core Filled Blocks + PB		esident libbly on group	nd floor) R1	
	In/Core Filled Blocks + Pla				
	(party wall between units)		positive in the second	No	
Ceiling Con				Aridad Insulate	
Plasterboar		D1560	ellings adjacent to roo	Facil decks about	
Roof Const		Absorptance		Added Insulate	
Concrete		NutriSA0.701		No.	
CONCERN	Concrete de	alest (Suer or)		190	
Floor Const	ruction Covere	0		Added Insulate	
Lipput Proups	As drawn (if not noted de		and the same t		
Controls			seed MIDDELLE		
Concrete					
		Uvalire	SMSC Range	Area so	
Windows	Glass and frame type	U value 4.80	SHGC Range 0.46 - 0.56	Aree sq. Unit 1, 2 &	
Windows Performance	Glass and frame type glazing type A	4.80	0.46 - 0.56	Unit 1:28	
Windows Performance Performance	Glass and frame type glazing type A glazing type B	4.80	0.46 - 0.56	Area sq. Unit 1, 2 & Unit 1, 2 & Unit	
Windows Performance Performance	Glass and frame type glazing type A glazing type B glazing type A	4.80 4.80 2.20	0.46 - 0.56 0.53 - 0.65 0.29 - 0.35	Unit 1, 2 & Unit 1, 2 & Unit	
Windows Performance Performance Performance	Glass and frame type glazing type A glazing type B glazing type A glazing type B	4.80 4.80 2.20 2.2)	0.46 - 0.56 0.53 - 0.65 0.29 - 0.35 0.35 - 0.43	Unit 1, 2 & Unit 1, 2 & Unit Unit	
Windows Performance Performance Performance Performance Type A window	Glass and frame type glazing type A glazing type B glazing type A glazing type B es are earning windows, bibble es are earning windows, bibble	4.80 4.80 2.20 2.2) s, casements, 5	0.46 - 0.56 0.53 - 0.65 0.29 - 0.35 0.35 - 0.43 Fin Turn windows, entry	Unit 1, 2 & Unit 1, 2 & Unit Unit Unit doors, french door	
Windows Performance Performance Performance Type A window Type B window	Glass and frame type glazing type A glazing type B glazing type B glazing type B es are saming eindows, biblic as are double hung windows.	4.80 4.80 2.20 2.20 5, casements 3 sliding aindown	0.46 - 0.56 0.53 - 0.65 0.29 - 0.35 0.35 - 0.43 if in tim eindows, entry 6 doors, feed windows,	Unit 1, 2 & Unit 1, 2 & Unit Unit Unit doors, franch door sticker doors, too	
Windows Performance Performance Performance Performance Type A window	Glass and frame type glazing type A glazing type B glazing type A glazing type B es are earning windows, bibble es are earning windows, bibble	4.80 4.80 2.20 2.20 5, casements 3 sliding aindown	0.46 - 0.56 0.53 - 0.65 0.29 - 0.35 0.35 - 0.43 Fin Turn windows, entry	Unit 1, 2 & Unit 1, 2 & Unit Unit Unit doors, french door	
Windows Performance Performance Performance Performance Type A window Skylights U and SHGC	Glass and frame type glazing type A glazing type B glazing type B glazing type B es are saming eindows, biblic as are double hung windows.	4.80 4.80 2.20 2.20 b, casements, 1 skiding aindows U SHG0	0.46 - 0.56 0.53 - 0.65 0.29 - 0.35 0.35 - 0.43 in Turn windows, entry 6 doors, field windows, 2. Area sig m	Unit 1, 2 & Unit 1, 2 & Unit 1, 2 & Unit Unit doors, franch door stacker doors, low Detail	
Windows Performance Performance Performance Performance Type A window Skylights U and SHGC	Glass and frame type glazing type A glazing type B glazing type B glazing type B glazing type B s are earlied without, biblic is are double harg windows. Glass and frame type waste are according to AFRC in the range specified	4.80 4.80 2.20 2.20 b, casements, 1 skiding aindows U SHG0	0.46 - 0.55 0.53 - 0.65 0.29 - 0.35 0.35 - 0.43 7 - 10.43 6 doors, field windows, entry 6 doors, field windows, Area sig m	Unit 1, 2 & Unit 1, 2 & Unit 1, 2 & Unit 2, 2 & Unit 3, 2 & Unit 5, 2 & Unit 6 Unit 6 Unit 6 Unit 6 Unit 7 Unit 7 Unit 7 Unit 7 Unit 8 Unit 8 Unit 8	
Windows Performance Performance Performance Performance Type A window Type B window Skyllights U and SWGC SHGC is with Shade elem	Glass and frame type glazing type A glazing type B glazing type B glazing type B glazing type B s are earlied without, biblic is are double harg windows. Glass and frame type waste are according to AFRC in the range specified	4.80 4.80 2.20 2.23 b, casements, I sliding aindows U SHGO	0.46 - 0.55 0.53 - 0.65 0.29 - 0.35 0.35 - 0.43 7 - 10.43 6 doors, field windows, entry 6 doors, field windows, Area sig m	Unit 1, 2 & Unit 1, 2 & Unit 1, 2 & Unit 2, 2 & Unit 3, 2 & Unit 5, 2 & Unit 6 Unit 6 Unit 6 Unit 6 Unit 7 Unit 7 Unit 7 Unit 7 Unit 8 Unit 8 Unit 8	
Windows Performance Performance Performance Performance Type A window Type B window Skylights U and SHGC SHOC is with Shade elem All shade side	Glass and frame type glazing type A glazing type B, glazing type B glazing type B of glazing type B or are sening endows, biblio as we double hings endows, biblio as we double hings endows. Siles are according to AFRC or the range specified end to glazing type with the sample specified endouble mentals.	4.80 4.80 2.20 2.23 b, casements, I sliding aindows U SHGO	0.46 - 0.56 0.53 - 0.65 0.53 - 0.65 0.29 - 0.35 0.35 - 0.42 in that windows, entry 6 born, lead windows, Area sig m (ctit may be used if the 1 (deaver, visce	Unit 1, 2 8 Unit 1, 2 8 Unit 1, 2 8 Unit 0, 2 8 Unit 0 1,	
Windows Performance Performance Performance Performance Type A windo Type 8 windo Skyllights U and SvGC SvHOC is with Shade elem All shade sin Ceiling Pen	Glass and frame type glassing type A glassing type B glassing type B glassing type B glassing type A glassing type A serial extending electronic colors are double large vertices. Glass and frame type to the samps specified in the range specified entitle are according to AFRC in the range specified entitle colors.	4.80 4.80 2.20 2.20 5, casements, 3 diding alindows U SHGI	0.46 - 0.56 0.53 - 0.55 - 0.29 - 0.35 0.29 - 0.35 0.35 - 0.42 In Turn enclose, entry 6 doors. Read windows Area sig m (eaves, vene (downloans, vene (downloans, vene (downloans, vene (downloans, each (downloa	Unit 1, 2 & Unit 1, 2 & Unit 1, 2 & Unit Unit doos, franch doors blicker doors, less Detail I visie is tower & 5 modatis, awarings a	
Windows Performance Performance Performance Performance Performance Type A window Type B window Skyllights U and SHGC is with Shade elser All shade elser All shade elser Modelled as Modelled as	Glass and frame type glazing type A glazing type B, glazing type B, glazing type B glazing type B glazing type B glazing type B as are earling windows, bibliot as on cloudle fining windows. Glass and formet type without any according to AFRC glazing appointed with using appointed with the single appoint	4.80 4.80 2.20 2.21 b, cacements 1 sliding aindows U SHG0 Alternate prod	0.46 - 0.56 0.33 - 0.65 0.33 - 0.65 0.39 - 0.36 0.35 - 0.42 if is fair sincleus, entry 4 doors, fairly windows, entry 4 doors, water 4 fairly windows, windows, water 4 fairly wi	Unit 1, 2 8 Unit 1, 2 8 Unit 1, 2 8 Unit Unit Unit doors, french door stricker doors, leav Detail J vision is cover 6.5 endates, everyage e endates, everyage e endates, everyage e	
Windows Performance Performance Performance Performance Type A window Skylights U and SHGC is with Shade elem All shade aim Celling Pero Modelled as Modelled as	Glass and frame type glazong type A glazong type B et al. (1997) and type B et are earning windows, 100-100 and et al. (1997) and et al. (1997). (1997) and et al. (1997) a	4.80 4.80 2.20 2.21 b, cacements 1 sliding aindows U SHG0 Alternate prod	0.46 - 0.56 0.33 - 0.65 0.33 - 0.65 0.39 - 0.36 0.35 - 0.42 if is fair sincleus, entry 4 doors, fairly windows, entry 4 doors, water 4 fairly windows, windows, water 4 fairly wi	Unit 1, 2 8 Unit 1, 2 8 Unit 1, 2 8 Unit Unit Unit doors, french door stricker doors, leav Detail J vision is cover 6.5 endates, everyage e endates, everyage e endates, everyage e	

EXTERNAL FINISHES SCHEDULE / PALETTE

CAMPBELL PDE



EXTERNAL TILE - TL1
TILE OR BRICK TO REPLACE EXISTING RENDERED CAMPBELL PDE FACADE
COLOUR/TONE TO MATCH EXISTING BRICKWORK





WINDOWS & DOORS PORTERS - POPCORN WHITE RENDER / PAINT - P1

AMENDED



BRICK - BRK1 SAN SELMO BRENTA TEXTURED



BRICK - BRK2 SAN SELMO CORSO ARNO RAW



WINDOWS & DOORS PORTERS - POPCORN WHITE



VERTICAL BATTEN - ALUMINIUM (NON-COMBUSTIBLE) GARAGE DOOR

RECEIVED Waverley Council

Application No: DA-367/2022

Date Received: 07/06 /2023

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FSL 00.000 FINISHED STRUCTURAL LEVEL FFL 00.00 FINISHED FLOOR LEVEL SURVEY SPOT LEVEL + 00.000 EXISTING LEVEL W/D EXISTING WINDOW / DOOR

NEW WINDOW / DOOR

W/D

+RL 00.00 FINISHED SPOT OR SURFACE LEVEL

EXISTING TO BE RETAINED EXISTING TO BE DEMOLISHED NEW STRUCTURE

ARCHITECTS NICHOLAS + **ASSOCIATES**

NOMINATED ARCHITECT

PATRICK NICHOLAS NSW 6672

STUDIO 6, 1 MARY'S PLACE SURRY HILLS NSW 2010 T+61 2 8353 9500

SCHEDULE

ISSUE NO:

JOB NO:

CAM2105

DRAWING REGISTER + BASIX + FINISHES 56 CAMPBELL PARADE, BONDI BEACH

DEVELOPMENT APPLICATION

CLIENT: ROB DEUTSCH

DRAWING NO:

DA001

Page 489 of 500

DEVELOPMENT APPLICATION

56 CAMPBELL PARADE, BONDI BEACH, NSW 2026

RECEIVED Waverley Council

Application No: DA-367/2022

Date Received: 07/06/2023







56 CAMPBELL PARADE

BONDI BEACH

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NEW WINDOW / DOOR

W/D

EXISTING TO BE RETAINED EXISTING TO BE DEMOLISHED NEW STRUCTURE

EXISTING LEVEL EXISTING WINDOW / DOOR ARCHITECTS NICHOLAS + **ASSOCIATES**

NOMINATED ARCHITECT PATRICK NICHOLAS NSW 6672

STUDIO 6, 1 MARY'S PLACE SURRY HILLS NSW 2010 T+61 2 8353 9500 DA000 CAM2105 DEVELOPMENT APPLICATION

DRAWING NO:

JOB NO:

COVER PAGE + PHOTOMONTAGE

PROJECT ADDRESS: 56 CAMPBELL PARADE, BONDI BEACH

ROB DEUTSCH

Page 490 of 500


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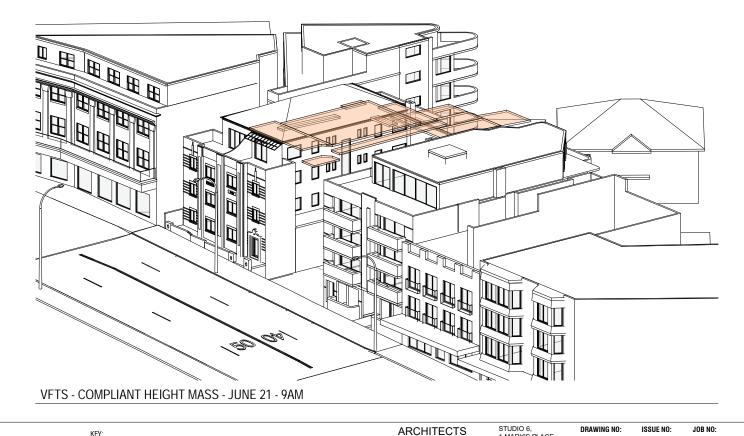
AMENDED **PLANS**

RECEIVED Waverley Council

Application No: DA-367/2022

Date Received: 07/06/2023



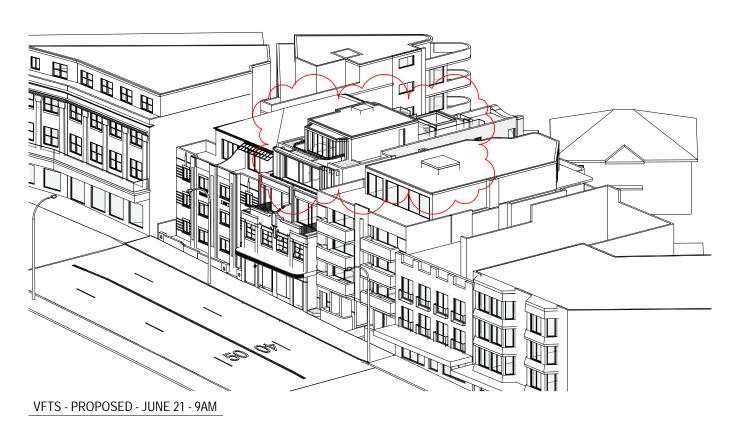


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STUDIO 6, 1 MARY'S PLACE SURRY HILLS NSW 2010 T + 61 2 8353 9500 NICHOLAS + **ASSOCIATES** NOMINATED ARCHITECT PATRICK NICHOLAS NSW 6672

DA700 PROJECT ADDRESS:

CAM2105 DEVELOPMENT APPLICATION

VIEW FROM SUN - JUNE 21 - 9AM

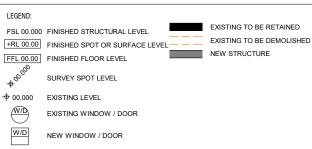56 CAMPBELL PARADE, BONDI BEACH

ROB DEUTSCH

Page 491 of 500


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AMENDED **PLANS**

RECEIVED Waverley Council

Application No: DA-367/2022

Date Received: 07/06/2023

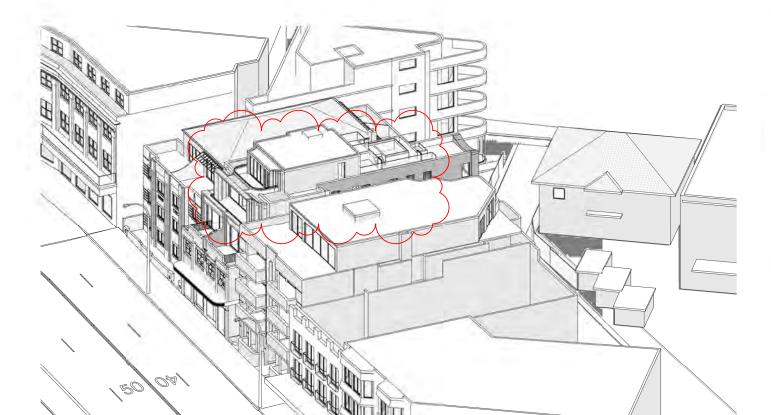

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VFTS - EXISTING - JUNE 21 - 10AM

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B 14.02.2023 A 18.08.2022 ISS DATE

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FSL 00.000 FINISHED STRUCTURAL LEVEL +RL 00.00 FINISHED SPOT OR SURFACE LEVEL FFL 00.00 FINISHED FLOOR LEVEL SURVEY SPOT LEVEL + 00.000 EXISTING LEVEL

EXISTING TO BE RETAINED EXISTING TO BE DEMOLISHED NEW STRUCTURE

EXISTING WINDOW / DOOR

W/D

NEW WINDOW / DOOR

ARCHITECTS NICHOLAS + **ASSOCIATES**

NOMINATED ARCHITECT

PATRICK NICHOLAS NSW 6672

STUDIO 6, 1 MARY'S PLACE SURRY HILLS NSW 2010 T + 61 2 8353 9500

DEVELOPMENT APPLICATION VIEW FROM SUN - JUNE 21 - 10AM

DRAWING NO:

DA701

ISSUE NO:

JOB NO:

CAM2105

PROJECT ADDRESS: 56 CAMPBELL PARADE, BONDI BEACH

00 0 O.1 150 VFTS - EXISTING - JUNE 21 - 11AM


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AMENDED **PLANS**

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Application No: DA-367/2022

Date Received: 07/06/2023



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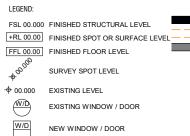
VFTS - PROPOSED - JUNE 21 - 11AM
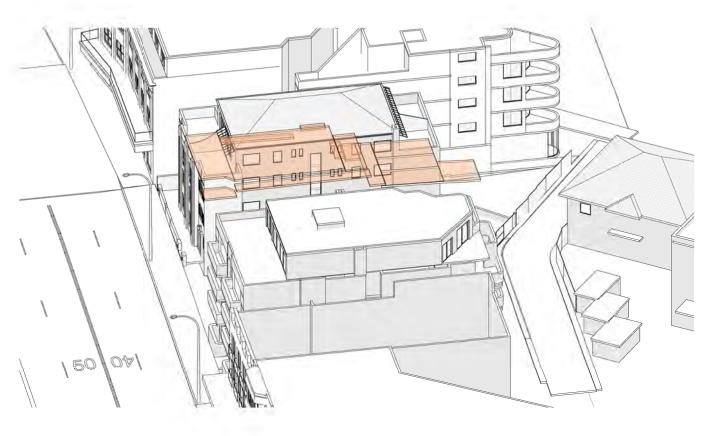
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PLOTTED: 26/05/2023 3:01:49 PM

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NEW WINDOW / DOOR

EXISTING TO BE RETAINED EXISTING TO BE DEMOLISHED NEW STRUCTURE

NOMINATED ARCHITECT PATRICK NICHOLAS NSW 6672

STUDIO 6, 1 MARY'S PLACE SURRY HILLS NSW 2010 T + 61 2 8353 9500 NICHOLAS + **ASSOCIATES**

ARCHITECTS

DA702 CAM2105 DEVELOPMENT APPLICATION

ISSUE NO:

JOB NO:

DRAWING NO:

VIEW FROM SUN - JUNE 21 - 11AM

PROJECT ADDRESS: 56 CAMPBELL PARADE, BONDI BEACH


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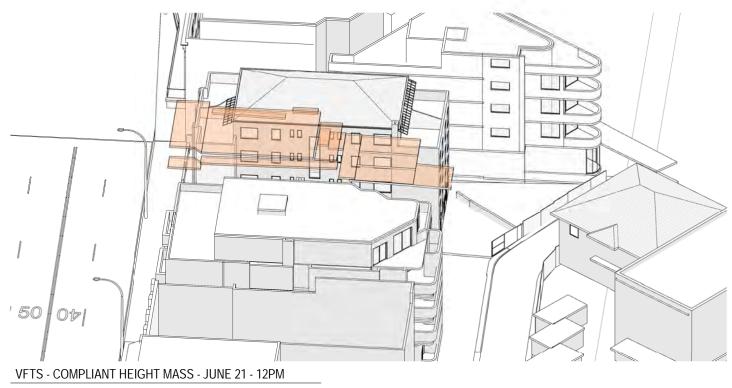
AMENDED PLANS

RECEIVED Waverley Council

Application No: DA-367/2022

Date Received: 07/06/2023



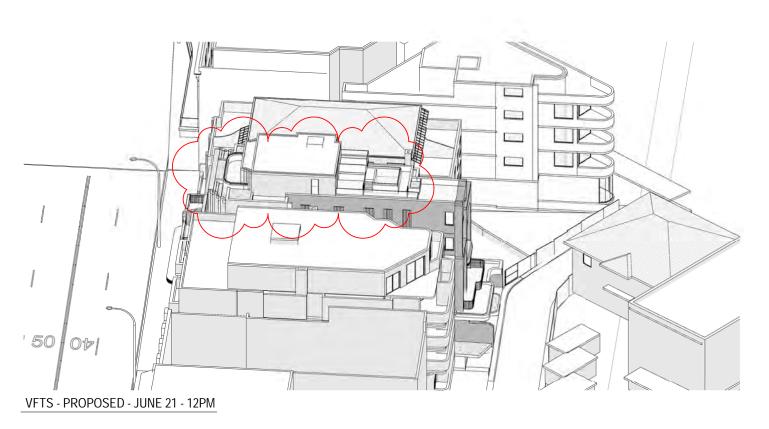

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NEW WINDOW / DOOR

W/D

EXISTING TO BE RETAINED EXISTING TO BE DEMOLISHED NEW STRUCTURE

PATRICK NICHOLAS NSW 6672

STUDIO 6, 1 MARY'S PLACE SURRY HILLS NSW 2010 T+61 2 8353 9500 NICHOLAS + **ASSOCIATES** NOMINATED ARCHITECT

ARCHITECTS

DRAWING NO: DA703

ISSUE NO: JOB NO: CAM2105

DEVELOPMENT APPLICATION


VIEW FROM SUN - JUNE 21 - 12PM PROJECT ADDRESS: 56 CAMPBELL PARADE, BONDI BEACH

CLIENT: ROB DEUTSCH

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VFTS - EXISTING - JUNE 21 - 1PM



VFTS - PROPOSED - JUNE 21 - 1PM

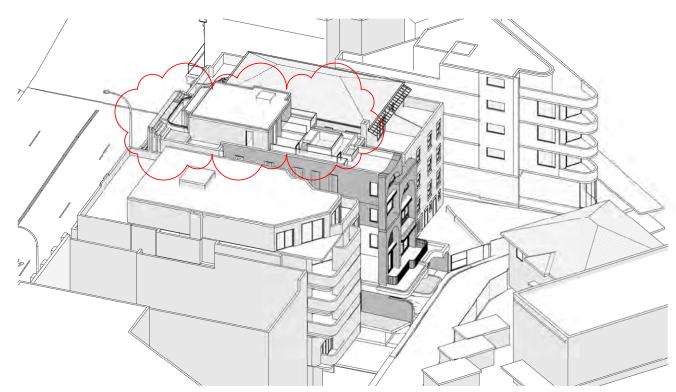AMENDED PLANS

RECEIVED Waverley Council

Application No: DA-367/2022

Date Received: 07/06/2023



VFTS - COMPLIANT HEIGHT MASS - JUNE 21 - 1PM

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NEW WINDOW / DOOR

W/D

EXISTING TO BE RETAINED EXISTING TO BE DEMOLISHED NEW STRUCTURE

NOMINATED ARCHITECT PATRICK NICHOLAS NSW 6672

ARCHITECTS

NICHOLAS +

ASSOCIATES

STUDIO 6, 1 MARY'S PLACE SURRY HILLS NSW 2010 T + 61 2 8353 9500

DRAWING NO: DA704

ISSUE NO: JOB NO: CAM2105


DEVELOPMENT APPLICATION

VIEW FROM SUN - JUNE 21 - 1PM


PROJECT ADDRESS: 56 CAMPBELL PARADE, BONDI BEACH

CLIENT: ROB DEUTSCH

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VFTS - EXISTING - JUNE 21 - 2PM

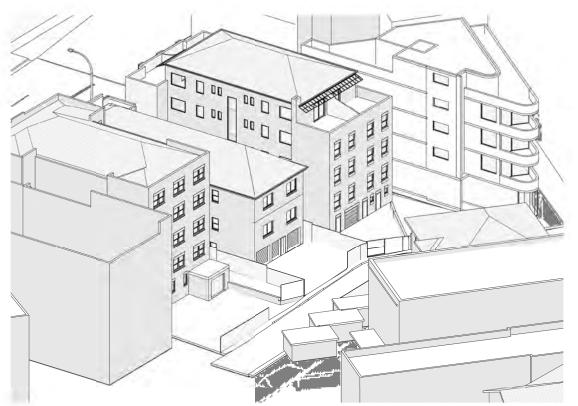


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AMENDED **PLANS**

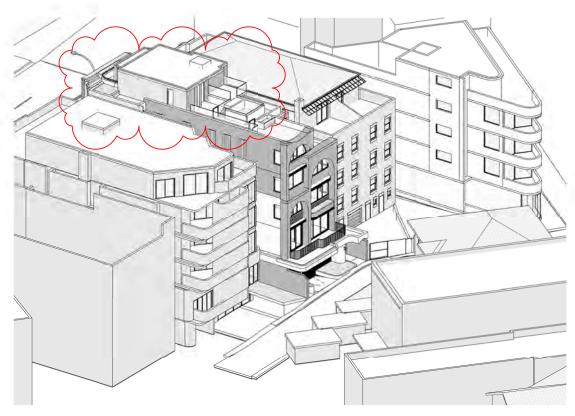RECEIVED Waverley Council

Application No: DA-367/2022

Date Received: 07/06/2023

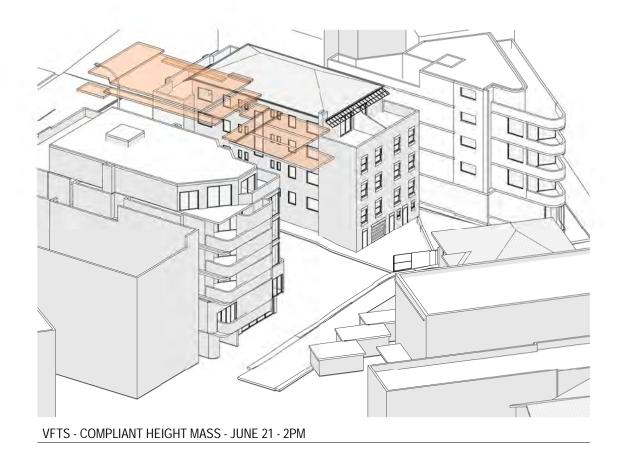

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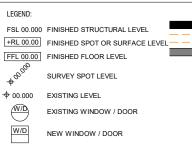
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B 14.02.2023 A 18.08.2022 ISS DATE

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EXISTING TO BE RETAINED EXISTING TO BE DEMOLISHED NEW STRUCTURE

NICHOLAS + **ASSOCIATES** NOMINATED ARCHITECT PATRICK NICHOLAS NSW 6672

ARCHITECTS

STUDIO 6, 1 MARY'S PLACE SURRY HILLS NSW 2010 T+61 2 8353 9500

DRAWING NO: DA705

ISSUE NO: JOB NO: CAM2105

DEVELOPMENT APPLICATION

VIEW FROM SUN - JUNE 21 - 2PM

PROJECT ADDRESS: 56 CAMPBELL PARADE, BONDI BEACH

0 0 0 0 0 0 1 VFTS - EXISTING - JUNE 21 - 3PM



VFTS - PROPOSED - JUNE 21 - 3PM

PLANS AMENDED

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Application No: DA-367/2022

Date Received: 07/06/2023



VFTS - COMPLIANT HEIGHT MASS - JUNE 21 - 3PM


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EXISTING TO BE RETAINED EXISTING TO BE DEMOLISHED NEW STRUCTURE

NEW WINDOW / DOOR

W/D

NOMINATED ARCHITECT PATRICK NICHOLAS NSW 6672

ARCHITECTS

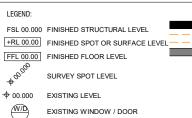NICHOLAS +

ASSOCIATES

STUDIO 6, 1 MARY'S PLACE SURRY HILLS NSW 2010 T + 61 2 8353 9500

DRAWING NO: DA706

ISSUE NO: JOB NO: CAM2105

DEVELOPMENT APPLICATION


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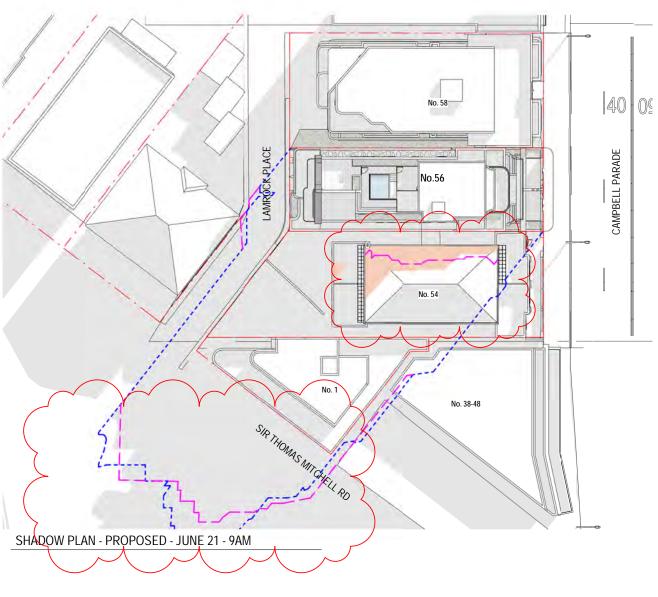
VIEW FROM SUN - JUNE 21 - 3PM

56 CAMPBELL PARADE, BONDI BEACH

CLIENT: ROB DEUTSCH

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PLANS AMENDED

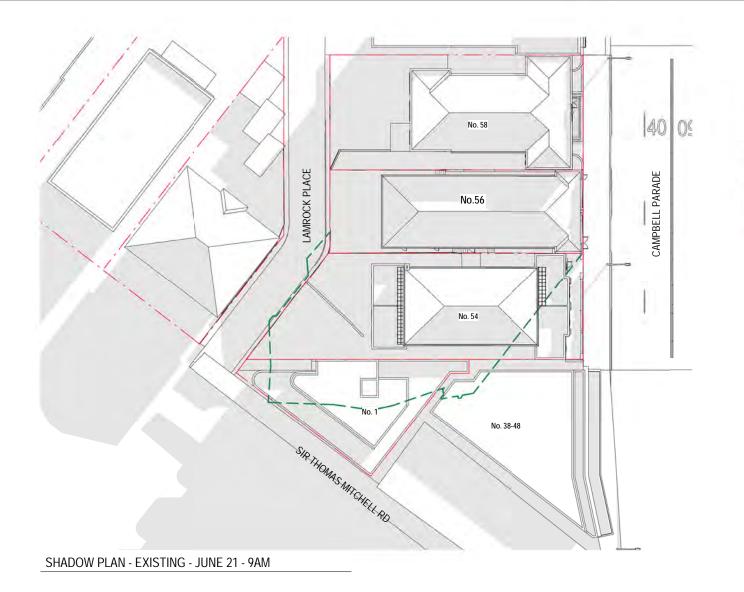

Application No: DA-367/2022

RECEIVED Waverley Council

Date Received: 07/06/2023


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STUDIO 6, 1 MARY'S PLACE SURRY HILLS NSW 2010 T + 61 2 8353 9500 **ARCHITECTS** NICHOLAS + **ASSOCIATES** NOMINATED ARCHITECT PATRICK NICHOLAS NSW 6672

DRAWING NO: DA708

DEVELOPMENT APPLICATION

JOB NO:


CAM2105

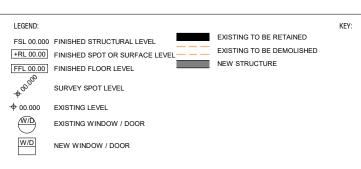OUTLINE OF COMPLIANT DCP SHADOW ENVELOPE

SHADOW PLAN - JUNE 21 - 9AM

ISSUE NO:

PROJECT ADDRESS: 56 CAMPBELL PARADE, BONDI BEACH

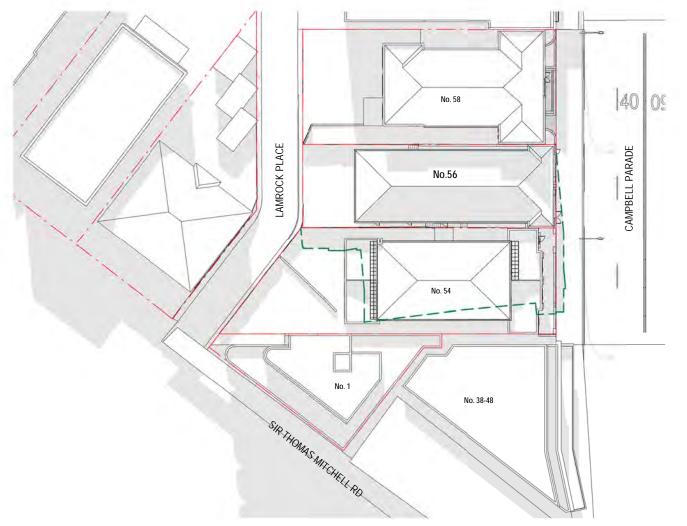

CAMPBELL PARADE SHADOW PLAN - PROPOSED - JUNE 21 - 12PM

SHADOW PLAN - EXISTING - JUNE 21 - 12PM

PLANS AMENDED



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OUTLINE OF COMPLIANT DCP SHADOW ENVELOPE

Application No: DA-367/2022

Date Received: 07/06/2023


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DA709

ISSUE NO: CAM2105

DEVELOPMENT APPLICATION

JOB NO:

DRAWING NO:

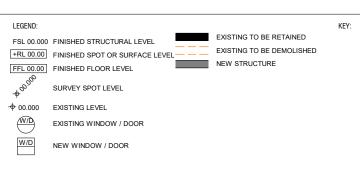SHADOW PLAN - JUNE 21 - 12PM


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AMENDED **PLANS**



Waverley Council

Application No: DA-367/2022

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Date Received: 07/06/2023
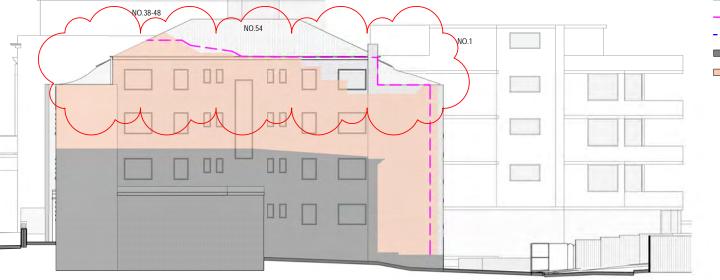
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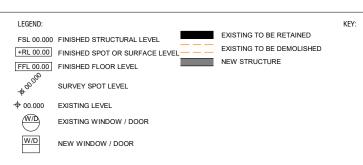
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DRAWING NO: ISSUE NO: DA710

AREA OF ADDITIONAL SHADOW OF PROPOSED BUILDING

DEVELOPMENT APPLICATION

SHADOW PLAN - JUNE 21 - 3PM

PROJECT ADDRESS: 56 CAMPBELL PARADE, BONDI BEACH

ROB DEUTSCH