

DATE: 22 February 2023

A meeting of the **WAVERLEY LOCAL PLANNING PANEL** will be held by video conference at:

12.00PM WEDNESDAY, 22 FEBRUARY 2023

QUORUM: Three Panel members.

APOLOGIES: By email to WLPP@waverley.nsw.gov.au

AGENDA

WLPP-2302 Apologies

WLPP-2302.DI

Declarations of Interest

The Chair will call for any declarations of interest.

WLPP-2302.1 Page 5

50 Gilbert Street, DOVER HEIGHTS NSW 2030 - Modification to increase the height and floor space of the dual occupancies, alter internal layout, pool size and location, windows, enclosure of rear balcony, enlargement of terraces, excavation, and various other alteration. (DA-289/2021)

Report dated 14 February 2023 from the Development and Building Unit.

Council Recommendation: That the application be REFUSED for the reasons contained in the report.

WLPP-2302.2 Page 49

16 Rawson Avenue, Queens Park, NSW 2022 - Modification to increase the height and floor space of the dual occupancies, alter internal layout, pool size and location, windows, enclosure of rear balcony, enlargement of terraces, excavation and various other alteration. (DA- 296/2022)

Report dated 14 February 2023 from the Development and Building Unit.

Council Recommendation: That the application be APPROVED in accordance with the conditions contained in the report.

WLPP-2302.3 Page 87

11 Pembroke Street, Bronte, NSW 2024 - Alterations to extend existing attic space to unit 1. (DA-417/2022)

Report dated 14 February 2023 from the Development and Building Unit.

Council Recommendation: That the application be REFUSED for the reasons contained in the report.

WLPP-2302.4 Page 128

446 Bronte Road, BRONTE NSW 2024 - Alterations and additions to dwelling house including extension of carport. (DA-288 2022)

Report dated 14 February 2023 from the Development and Building Unit.

Council Recommendation: That the application be APPROVED in accordance with the conditions contained in the report.

WLPP-2302.5 Page 162

32 Gardyne Street, BRONTE NSW 2024 - Alterations and additions to dwelling house including second floor addition and balconies. (DA-375/2022)

Report dated 14 February 2023 from the Development and Building Unit.

Council Recommendation: That the application be REFUSED for the reasons contained in the report.

WLPP-2302.6 Page 218

301 Bondi Road, BONDI NSW 2026 - Installation of 3 x car stackers to existing residential flat building accessed from Glen Street. (DA-392/2022)

Report dated 14 February 2023 from the Development and Building Unit.

Council Recommendation: That the application be REFUSED for the reasons contained in the report.

WLPP-2302.7 Page 250

6/88 Beach Road, BONDI BEACH NSW 2026 - Alterations and additions to the upper level of Unit 6 to extend the existing top floor and provide solar panels on the roof. (DA-366/2022)

Report dated 14 February 2023 from the Development and Building Unit.

Council Recommendation: That the application be REFUSED for the reasons contained in the report

WLPP-2302.8 Page 287

12 Princess Street, ROSE BAY NSW 2029 Modifications to approved dual occupancy, including extension of basement, ground and first floor levels. (DA-462/2021/A)

Report dated 14 February 2023 from the Development and Building Unit.

Council Recommendation: That the application be REFUSED for the reasons contained in the report.

WLPP-2302.9 Page 346

100 Francis Street, BONDI BEACH NSW 2026 - Alterations and additions to dwelling including new first floor addition. (DA-334/2022)

Report dated 14 February 2023 from the Development and Building Unit.

Council Recommendation: That the application be REFUSED for the reasons contained in the report.

WLPP-2302.10 Page 404

124-126 Campbell Parade, BONDI BEACH NSW 2026 - Modification to basement levels, unit layouts, unit amalgamation and change of roof, including increase to overall building height. (DA-323/2019)

Report dated 14 February 2023 from the Development and Building Unit.

Council Recommendation: That the application be APPROVED in accordance with the conditions contained in the report.

WLPP-2302.11 Page 544

15 & 17 O'Brien St Bondi Beach & 156 Glenayr Ave Bondi Beach - AMENDED: Demolition of existing buildings and construction of a new four storey mixed use shoptop housing development comprising basement parking, ground floor retail tenancies and 14 residential units. (DA-83/2022)

Report dated 14 February 2023 from the Development and Building Unit.

Council Recommendation: That the application be APPROVED in accordance with the conditions contained in the report





Report to the Waverley Local Planning Panel

Application number	DA-289/2021/A	
Application number	DA-203/2021/A	
Site address	50 Gilbert Street, Dover Heights	
Proposal	Modification to increase the height and floor space of the dual occupancies, alter internal layout, pool size and location, windows, enclosure of rear balcony, enlargement of terraces, excavation and various other alteration.	
Description of Approved Development	Demolition of the existing dual occupancy and construction of a three storey dual occupancy with integrated parking, roof top terrace, two swimming pools and Strata subdivision.	
Date of lodgement	21 October 2022	
Owner	Proprietors of Strata Plan 5848	
Applicant	BJB Architects Pty Ltd	
Submissions	Nil	
Amended cost of works	\$2,795,188	
Principal Issues	 Height and FSR development standards breach; Overshadowing neighbour's windows; Rear building line; and Excavation. 	
Recommendation	That the application be REFUSED for the reasons contained in the report.	

SITE MAP



1. PREAMBLE

1.1. Executive Summary

The modification application seeks to modify development consent, known as DA-289/2021 for the demolition of the existing dual occupancy and construction of a three storey dual occupancy with integrated parking, roof top terrace, two swimming pools and Strata subdivision at the site known as 50 Gilbert Street, Dover Height. In summary, the proposed modifications are to increase the height and floor space of the approved dual occupancies, alter internal layout, pool size and location, windows, enclosure of rear balcony, enlargement of terraces, excavation and various other alteration.

The principal issues arising from the assessment of the application are as follows:

- Height and Floor Space Ratio (FSR) development standards breach;
- Overshadowing neighbours windows;
- Rear building line; and
- Excavation.

The assessment finds these issues unacceptable as both the additional height and FSR results in adverse amenity impacts to surrounding properties and does not maintain solar access to the first floor windows of the dwelling located on the adjoining property. The changes to the rear building line and significant excavation to the rear yard do not respond well to site constraints. The modifications are not within the public interest and cannot be supported.

No submissions were received.

The application has been assessed against the relevant matters for consideration under section 4.55(2) the *Environmental Planning and Assessment Act 1979* and is recommended for approval subject refusal.

1.2. Site and Surrounding Locality

A site visit was carried out during the assessment of the original development application.

The site is identified as SP 5848, known as 50 Gilbert Street, Dover Heights and is located to the east of the intersection of Roberts Street and Gilbert Street.

The site is rectangular in shape with a western frontage to Gilbert Street measuring 13.47m and a site length measuring 54.3m. The lot has an area of 731.6m² and it falls from the rear boundary towards the front boundary by approximately 9.65m. The rear yard falls approximately 6.57m from the rear boundary to the back of the dwelling, making half of this area unusable. A sewage pipe runs along the length of the northern boundary.

The site was formerly occupied by a three storey brick dual occupancy with a single driveway entrance provided from Gilbert Street, splitting into two driveways on site to two garages located at ground floor level. The front yard is grassed with a mature palm tree located in the north western corner of the site.

The rear yard has a shared concrete terrace area covered with a canvas shade structure and steps lead up to a small timber shed, which is located in the yard which is overgrown with dense vegetation.

The site is adjoined by a dwelling and a dual occupancy on either side both with basement garages, swimming pools and roof terraces. The locality is characterised by a variety of low residential developments along the western side of Gilbert Street and medium residential developments along the eastern side of Gilbert Street.

Figures 1 to 6 are photos of the site and its context.



Figure 1: Easterly view of the front façade of the subject site at 50 Gilbert Street.



Figure 3: North westerly view of the existing windows on 48 Gilbert Street.



Figure 2: South easterly view of the rear yard of the subject site.



Figure 4: South westerly view of the existing windows on 52 Gilbert Street.



Figure 5: Easterly view of the front façade of 52 Gilbert Street, the neighbouring dual occupancy located to the south.

1.3. Details of Approved Development

The original development application, known as DA-289/2021 for the demolition of the existing dual occupancy and construction of a three storey dual occupancy with integrated parking, roof top terrace, two swimming pools and Strata subdivision, was approved on 8 December 2021 by the Waverley Local Planning Panel. Demolition of all the buildings has commenced.

There are no particular conditions from the development consent which have direct relevance to this modification application.

1.4. Proposal

The modification application has been submitted under section 4.55(2) of the *Environmental Planning* and Assessment Act 1979. It seeks consent for the following modifications to the approved development:

Lower Ground Floor:

• New internal reconfiguration, relocating the laundry on the lower ground floor and extended plant room to both dwellings;

Ground Floor Plan:

A new pantry to replace the laundry location to both dwellings;

First Floor:

- The enclosure of the rear balcony on the first floor, allowing for bedroom extension and the addition of a new ensuite to both dwellings;
- Extension of the master bedroom with the new ensuite layout;
- Alterations and removal of windows, resulting in a west-east orientated development;
- Alteration to the floor to ceiling height on the first floor, from 2.60m to 2.70m. Overall building height increase of 0.35m;

External:

- Redesign of the private open space, involving excavation works and including enlargement of the terraces, a minor decrease of the landscaped area, and revised pool size and location;
- Alterations to path and stairs to facilitate entry to laundry door on House A; and
- Landscaping works to rear yard and first floor.

2. ASSESSMENT

The following matters are to be considered in the assessment of this modification application under relevant sections of the *Environmental Planning and Assessment Act 1979* (the Act).

2.1. Section 4.55 – Modification of consents – generally

For section 4.55(2) – Other impact

The application is made under section 4.55(2) of the Act.

The quantitative and qualitative elements and impacts between the approved development and the development, as proposed to be modified, are not considered overly dissimilar as demonstrated in the following sections of this report. In this regard, the proposal is considered to be *substantially the same* as the originally approved development with regard to matters arising from the NSW Land and Environment Court case of *Moto Projects (No 2) Pty Ltd v North Sydney Council (1999) 106 LGERA 298*.

The application was publicly notified and no submissions were received. The issues and matters raised in public submissions are discussed in section 2.3.4 of this report.

2.2. Evaluation of Matters for Consideration under Section 4.15

In accordance with section 4.55(3) of the Act the following is an assessment of the proposed modifications of the development consent against the relevant matters for consideration under section 4.15(1) of the Act.

2.2.1. Planning Instruments and Development Control Plans

The following is an assessment against relevant environmental planning instruments, including State environmental planning policies (SEPPs), and development control plans.

State Environmental Planning Policies (SEPPs)

The following SEPPs apply from the 1st March 2022 and have been considered acceptable in the assessment of this development application:

SEPP (Building Sustainability Index – BASIX) 2004

Waverley Local Environmental Plan 2012 (Waverley LEP 2012)

The land use definition of the approved development as a dual occupancy remains unchanged and continues to be permitted development in the R2 zone under Waverley LEP 2012.

The quantities of the approved development, as proposed to be modified, have changed as outlined in **Table 1** of this report in relation to principal development standards under Waverley LEP 2012. All other relevant provisions of Waverley LEP 2012 are non-compliant for the reasons discussed below.

Table 1: Waverley LEP 2012 Compliance Table

Provision	Approved	Proposed Modified	Compliance
4.3 Height of buildings8.5m	The approved development has a maximum height of 9.6m, representing a variation of 1.15m (13.53%) from the height standard.	The modification proposes a maximum height of 9.954m, an increase of 0.35m. This results in a variation of 1.45m (17.1%) from the height standard.	No
 4.4 Floor space ratio and 4.4A Exceptions to floor space ratio 0.5:1 (365.8m²) 	The approved dual occupancy provides a GFA of 395m², consequently having an FSR of 0.54:1, which represents a 7.98% variation to the FSR development standard.	The modified dual occupancy proposes a GFA of 433.4m², with an FSR of 0.592:1, which represents a 18.4% variation to the FSR development standard.	No
6.2 Earthworks	The development largely follows the natural sloping topography of the site and minor earthworks are proposed towards the front and middle area of the site for the basement parking.	The rear pools, decks and surrounding landscaping are proposed to be lowered by 0.9m to 2.35m. This allows the rear yard to be kept on the same level as the rear terrace which will result in significant excavation to the sloping yard. The extent of the excavation is not clearly shown by the applicant. No geotechnical report has been submitted.	No

The following is a detailed discussion of exceedances of particular development standards under Waverley LEP 2012 as a result of the approved development, as proposed to be modified.

Height of Buildings

The proposed modifications result in a net increase of building height of 0.35m, resulting in an overall building height of 9.954m. This culminates in an overall exceedance of the height of buildings development standard by 1.45m or 17.1%. The net increase of building height due to the proposed modifications represents 3.57% of the overall exceedance of the standard.

The applicant has provided some written justification for the non-compliance with the height of buildings development standard and has based the justification on the performance of the proposal against the objectives of the development standard. The relevant objectives of the development standard are as follows:

- (a) to ensure building heights preserve the environmental amenity of neighbouring properties and public spaces and, if appropriate, the sharing of views,
- (c) to maintain satisfactory solar access to existing buildings and public areas,
- (d) to establish building heights that are consistent with the desired future character of the locality.

The justification provided by the applicant to support the increased exceedance of the height of buildings development standard is summarised as follows:

- The proposal involves an adjustment to the floor to ceiling height on the first level from 2.6m to 2.7m, resulting in an overall building height increase of 0.35m to the glass balustrade of the roof terrace. Notably, the additional height breach relates to a lightweight architectural element, being the roof slab portion above the height limit and the well recessed transparent balustrades. The additional height non-compliance will not cause any adverse environmental impacts to the adjoining properties.
- The proposed modifications are considered minor as they do not substantially add to the height
 of the development or result in a significant increase in FSR, nor do they generate any additional
 adverse or unreasonable external amenity impacts beyond what was originally approved. It is
 considered that this proposal represents a superior outcome by improving the practicality and
 amenity of each dwelling.
- The proposed built form will remain as a high quality addition to this particular character of Gilbert Street which contains ground level garaging with 2 habitable levels above. The proposed height, bulk and scale will remain as contributory to the streetscape of Gilbert Street and local character in this part of Dover Heights.
- The proposed modifications do not generate any adverse or unreasonable streetscape, visual bulk, or amenity impacts. There will be no additional adverse external amenity impacts associated with the modifications, including no adverse overshadowing, visual or acoustic privacy, visual bulk, or view loss, above and beyond that already approved.

<u>Planner's comment:</u> The Architectural plans are misleading as the floor to ceiling height differs from 2.7m in Section A – Part A and 2.9m in Section B (see **Figure 7**), which would explain the 0.3m increase to the overall building height. The applicant has argued the height increase responds to market expectations which is not a sufficient planning argument in justifying contravening the development standard. The subject site is located in the lowest part of the eastern side of Gilbert Street and is naturally lower than the neighbouring dwellings.

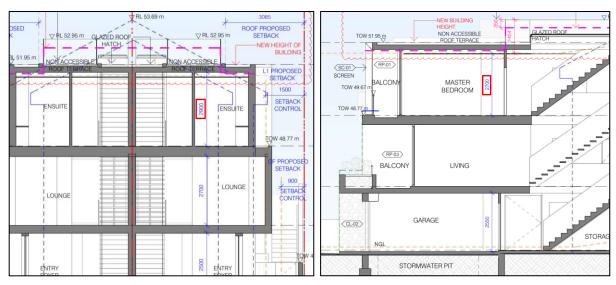


Figure 6: Section A – Part A and Section B through the building showing different floor to ceiling heights of the approved development, as proposed to be modified

The approved height is 9.6m and was supported on the basis that it reasonably maintained solar access into adjoining properties. Amendments to the plans in the original DA ensured that the edge of the roof parapet was set at RL51.60 to allow sufficient sunlight into all the first floor windows to 52 Gilbert Street at 9am. The increased height causes the edge of the roof to overshadow 3 of the 6 neighbours' windows, as clearly demonstrated by the 9am sun's eye diagrams below (see Figures 8 and 9). The modified plans do not preserve the environmental amenity of neighbouring properties and result in unreasonable impacts. The applicant's justification fails to address each of the objectives of the height of building development standard and the application is recommended for refusal.

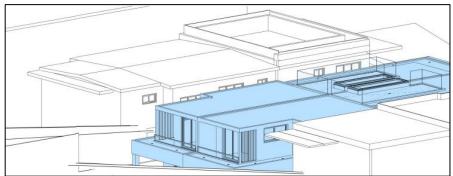


Figure 7: Approved 9am sun's eye diagram maintaining solar access to windows at 52 Gilbert St.

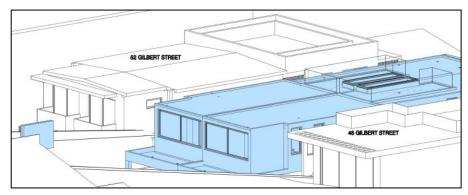


Figure 8: Proposed 9am sun's eye diagram overshadowing 52 Gilbert St.

The approved development, as proposed to be modified, will not achieve and be inconsistent with the relevant objectives of the height of buildings development standard. Therefore, the net exceedance is deemed unacceptable and is not supported.

Floor Space Ratio (FSR)

The proposed modifications result in a net increase of gross floor area (GFA) of 39.4m², resulting in an overall FSR of 0.592:1 (433.4m²). This culminates in an overall exceedance of the FSR development standard by 67.6m² or 18.4%. The net increase of FSR due to the proposed modifications represents 10.42% of the overall exceedance of the standard.

The applicant has provided some written justification for the non-compliance with the FSR development standard and has based the justification on the performance of the proposal against the objectives of the development standard. The relevant objectives of the development standard are as follows:

- (b) to provide an appropriate correlation between maximum building heights and density controls,
- (c) to ensure that buildings are compatible with the bulk and scale of the desired future character of the locality,
- (d) to establish limitations on the overall scale of development to preserve the environmental amenity of neighbouring properties and the locality.

The justification provided by the applicant to support the increased exceedance of the FSR development standard is summarised as follows:

• The updated plans include recalculated GFA diagrams which include the lift once and 2 of the 3 staircases. The updated FSR is now 0.592:1. The proposed FSR is considered to be acceptable as the built form remains compatible with the established form and character of housing in this section of Gilbert Street (ie. garage with 2 levels above plus roof terraces). The proposed extension of GFA towards the rear remains a substantial distance from the rear boundary whilst also remaining compatible with the rear alignment of both adjoining properties. The extension of the built form towards the rear has no adverse visual bulk or amenity impacts upon the rear neighbours given they are substantially elevated and separated from the subject site.

- The majority of the proposed increase in gross floor area relates to extending the front and rear bedrooms by enclosing the rear balcony on the first floor, allowing for a new ensuite. The slightly reduced balcony dimension at the front will retain articulation and retains the character of the streetscape presentation. The image on the front of the plans confirms that the modification will generate any inconsistency with the original design intent whilst also remaining compatible with the developed properties on either side.
- The additions at the rear improve amenity for the bedrooms and do not generate any adverse visual bulk or shadow impacts to the neighbours on either side. There are no visual bulk or amenity impacts to the rear as the dwellings to the rear/east are substantially elevated above the subject site and look out and over the built form. The rear alignment is consistent and compatible with other built forms along this section of Gilbert Street.
- The proposal remains within a low density residential environment as determined by the substantial front and rear setbacks and extensive landscaped areas. The additional floor space is sited towards the rear and is not evident from the public domain whilst the slight increase to the main bedrooms will not discernibly alter the streetscape presentation to Gilbert Street.
- The proposed built form will remain as a high quality addition to this particular character of Gilbert Street which contains ground level garaging with 2 habitable levels above. The proposed height, bulk and scale will remain as contributory to the streetscape of Gilbert Street and local character in this part of Dover Heights.
- There is no intensification of land use as there is no significant increase in floor space, and the proposal maintains the number of bedrooms as approved. A minor increase in floor space has been proposed in order to make necessary internal amenity improvements. However, this remains appropriate for the site.

<u>Planner's comment:</u> The proposed development substantially increases the building envelope on first floor level and the additional southern side ensuite to the rear bedroom results in additional overshadowing as demonstrated in the sun's eye diagrams. This modification results in adverse amenity impacts to surrounding properties and therefore does not meet the objectives of both development standards. The applicant's justification fails to address the FSR objectives.

While the originally approved development exceeded the FSR development standard, the extent of the exceedance was supported as the building envelope of the approved development was deemed contextually appropriate and satisfactory in relation to considerations under clause 4.6 of the LEP. The discernible increase of the building envelope of the approved development, as proposed to be modified, particularly the first floor extension, is deemed to be inappropriate. The cumulative extent of the FSR development standard exceedance represent a complete overdevelopment of the site and is at odds with the objectives of the FSR development standard, particularly as it does not adequately preserve the environmental amenity of neighbouring properties and minimise the adverse impacts on the amenity of the locality. The application is recommended for refusal partly due to this matter.

The approved development, as proposed to be modified, will not achieve and be inconsistent with the relevant objectives of the FSR development standard. Therefore, the net exceedance is deemed unacceptable and is not supported.

Waverley Development Control Plan 2012 (Waverley DCP 2012) – Amendment No.9

The approved development, as proposed to be modified, continues to comply with the relevant parts and sections of Waverley DCP 2012. Only the following parts and sections of Waverley DCP 2012 that apply to the proposed modifications are outlined in **Tables 2** and **3** of this report and detailed discussion below these tables.

Table 2: Waverley DCP 2012 – Part B General Provisions Compliance Table

Development Control	Compliance	Comment
6. Stormwater	Yes	Satisfactory. Refer to section 3 of this report on referral commentary in relation to stormwater.
12. Design Excellence	No	The dual occupancy is relatively unchanged from the front façade, however the modifications to the rear of the site on the first floor do not promote a good site specific design and results in adverse amenity impacts.
13. Excavation	No	The rear pools, decks and surrounding landscaping are proposed to be lowered 0.9m-2.35m to be kept the rear yard on the same level as the rear terrace which will result in significant excavation to the sloping yard. The extent of the excavation is not clearly shown by the applicant.

Table 3: Waverley DCP 2012 – Part C2 Low Density Residential Development Compliance Table

Development Control	Compliance	Comment
2.0 General Objectives		
 Appropriate scale Does not detract from amenity of other dwellings or view corridors 	No	The proposal contravenes all general objectives of this part of the DCP.
2.1 Height		
Flat roof dwelling houseMaximum wall height of 7.5m	No	A maximum 9.3m wall height is proposed on the southern elevation, which is due to the significant slope of the site. The excessive wall height will result in unreasonable overshadowing and streetscape impacts.
2.2 Setbacks		
2.2.1 Front and rear building lines		The rear terraces have extended 1m into the rear setback, which is 1.7m past the predominant rear

Development Control	Compliance	Comment
Predominant front building linePredominant rear	No	building line shown in the orange dotted line on the ground floor plan. This structure extends past the neighbouring buildings and is not supported.
building line at each floor level	Yes	The first floor front building line is extended 0.5m forward and is in line with the predominant building line.
	Yes	The rear first building line is preserve as the approve balcony is infilled.
2.3 Streetscape and visual im	pact	
New development to be compatible with	Yes	The modifications maintain the approved contemporary development.
streetscape contextReplacement windows to	Yes	The new window proportions along the north and south elevation are acceptable.
complement the style and proportions of existing dwelling		Existing vegetation is retained, where possible, and the landscape plan submitted demonstrates extensive planting across the site and through
Significant landscaping to be maintained.	Yes	planter boxes at ground and first floor.
2.5 Visual and acoustic privac	у	
Habitable windows are not to directly face habitable windows or open space of neighbouring dwellings unless direct views are screened or other appropriate measures are incorporated into the design	No	The modified windows along both the northern and southern elevations at ground and first floor levels, still directly face an existing window on neighbour's property and have not been appropriately screened.
2.6 Solar access		
 Minimum of three hours of sunlight to living areas and principal open space areas on 21 June 	Yes	The dwellings maintain three hours of sunlight to living and principal open space. Amendments to the plans in the original DA ensured that the edge of the roof parapet was
Minimum of three hours of sunlight maintained to at least 50% of principal open space areas of adjoining properties on	No	set at RL51.60 to allow sufficient sunlight into all the first floor windows to 52 Gilbert Street at 9am. The increased height causes the edge of the roof to overshadow 3 of the 6 neighbours windows, as clearly demonstrated by the 9am
 Avoid unreasonably overshadowing of solar collectors (including habitable windows). 	No	suns eye diagrams. The modified plans do not preserve the environmental amenity of neighbouring properties and result in unreasonable impacts.

Development Control	Compliance	Comment
2.9 Landscaping and open spa	ce	
 Overall open space: 40% of site area Overall landscaped area: 15% of site area 	Yes Yes	No change to the open space area at 64%. Additional landscaping at 34% (254.4m²) of the total site area is proposed as landscaped area.
2.10 Swimming pools and spa	pools	
Located in the rear of property	Yes	The swimming pools are still located in the rear yard but the coping level is lowered from RL46.55 to RL45.65.

2.2.2. Other Impacts of the Development

The proposal is considered to have a significant detrimental effect relating to environmental, social or economic impacts on the locality, and is recommended for refusal.

2.2.3. Suitability of the Site for the Development

The site is considered suitable for the proposal.

2.2.4. Any Submissions

The application was notified for 14 days between 11 November 2022 and 29 November 2022 in accordance with the *Waverley Community Development Participation and Consultation Plan*.

No submissions were received.

2.2.5. Public Interest

The proposal is considered to have a detrimental effect on the public interest, is recommended for refusal.

3. REFERRALS

The following internal and external referral comments were sought:

3.1. Stormwater

As per Council's Water Management Technical Manual (WMTM), Council will not approve the construction of any new structures (including habitable dwellings, eaves and balconies, garages, impervious fences, swimming pools and retaining walls) over an existing below ground drainage system or within the confines of an easement. Where any structure is proposed to be built over Council's below ground drainage system or within the confines of the required drainage easement, details are to be provided to Council's satisfaction prior to a construction certificate being issued.

3.2. Tree Management

No tree comments were received during the assessment period.

4. CONCLUSION

The modification application seeks to modify development consent, known as DA-289/2021 for the demolition of the existing dual occupancy and construction of a three storey dual occupancy with integrated parking, roof top terrace, two swimming pools and Strata subdivision at the site known as 50 Gilbert Street, Dover Height. In summary, the proposed modifications are to increase the height and floor space of the dual occupancies, alter internal layout, pool size and location, windows, enclosure of rear balcony, enlargement of terraces, excavation and various other alteration.

The principal issues arising from the assessment of the application are as follows:

- Height and FSR development standards breach;
- Overshadowing neighbours windows;
- Rear building line; and
- Excavation.

The assessment finds these issues unacceptable as both the additional height and FSR results in adverse amenity impacts to surrounding properties and does not maintain solar access to the first floor windows located on the adjoining property. The changes to the rear building line and significant excavation to the rear yard do not respond well to the site constraints. The modifications are not within the public interest and cannot be supported.

No submissions were received.

The application has been assessed against relevant sections of the Act and is recommended for refusal.

5. RECOMMENDATION TO WAVERLEY LOCAL PLANNING PANEL

That the modification application be REFUSED by the Waverley Local Planning Panel for the reasons contained in Appendix A.

Report prepared by:	Application reviewed by:
E. Ron	
Edwina Ross	Ben Magistrale
Development Assessment Planner	Manager, Development Assessment (Area 2)
Date: 3/02/2023	Date: 7 February 2023

Reason for WLPP referral:

The consent authority for the original development application was the WLPP, this modification is made under section 4.55(2) of the Act and relates to:

1. Departure from any development standard in an EPI by more than 10% and original application was determined by the WLPP.

APPENDIX A - REASONS FOR REFUSAL

Having regard to sections 4.15(1) and 4.55(2) of the *Environmental Planning and Assessment Act 1979* (the Act), the modification application is refused for the following reasons:

- 1. The proposal does not satisfy the objectives of the Act, as stipulated in section 1.3 (g), because the proposal does not promote good design and amenity of the built environment.
- 2. The proposal does not satisfy section 4.15 (1)(a)(i) of the Act, as the proposal does not satisfy the Waverley Local Environmental Plan (WLEP) 2012, in particular, the following provisions:
 - a. Clause 4.3(1)(a) and (d) of WLEP as the proposal will exceed the maximum height of buildings development standard permitted for the site and will consequently result in unacceptable impacts on neighbouring properties and the streetscape and public spaces. The modification application fails to consider and address the implications of the non-compliance of the height of buildings development standard in terms of its associated environmental impact and consistency or performance with the objectives of the development standard.
 - b. Clause 4.4(1)(b) to (d) and (2) of WLEP as the proposal will exceed the maximum floor space ratio (FSR) development standard permitted for the site, which represents an overdevelopment of the site. The application performs poorly against the relevant objectives of the FSR development standard and will consequently result in unacceptable impacts on neighbouring properties and the streetscape and public spaces.
- 3. The proposal does not satisfy section 4.15 (1)(a)(iii) of the Act, as the proposal is contrary to Waverley Development Control Plan (WDCP) 2012, in respect to the following provisions:

Part B14 - Excavation

a. The proposal is contrary to control (d) as objectives (a), (b) and (c) under Part B14 of WDCP as its net increase of volume of excavation is excessive and does not respect the natural and physical environment by failing to minimise site disturbance.

Part C2 - Low Density Residential Development

- a. The proposal is contrary to all the general objectives expressed under section 2.0.
- b. The proposal exceeds the maximum external wall height limit of 7m, which will result in unreasonable visual bulk, overshadowing and streetscape impacts. Therefore, it is contrary to control (a) and objectives (b) and (c) under section 2.1.
- c. The reduced rear setback of the ground floor level of the proposal does not comply with the predominant rear building line specified in control (a) under section 2.2.2 and is contrary to objectives (a), (b) and (c) under section 2.2.

- d. The amended windows to the northern and southern elevations continue to directly overlook existing neighbouring windows and does not comply with control (b) and objective (a) under section 2.5.
- e. The increased floor space, overall building height and reduced southern side setback of the first floor level of the proposal is expected to result in unreasonable overshadowing impacts upon southern adjoining properties, contrary to control (c) and objectives (a) and (b) under section 2.6.
- 4. The proposal does not satisfy section 4.15 (1)(a)(iv) of the Act, as the application does not satisfy the *Environmental Planning and Assessment Regulation 2021*, as insufficient documentation has been provided to properly assess the application, including but not limited to:
 - a. No proper justification on the further breach of the height of buildings and FSR development standards is provided in the written documentation, specifically no assessment is made against objectives of the height of buildings and FSR development standards.
- 5. The proposal does not satisfy section 4.15 (1)(b) of the Act, as the proposal will have an adverse environmental impact in the locality as it represents an overdevelopment of the subject site, is excessive in terms of bulk and scale, undesirable and unacceptable impact on the streetscape, and would adversely impact upon the amenity of the locality and surrounding built environment.
- 6. The proposal is contrary to 4.15 (1)(c) of the Act, as the development is excessive in building height, bulk and scale and is therefore considered unsuitable for the site.
- 7. The proposal is not considered to be in the public interest for the reasons outlined above, contrary to section 4.15 (1)(e) of the Act.

50 GILBERT STREET, DOVER HEIGHTS

S4.55(2) MODIFICATION TO APPROVED CONSENT NO. DA-289/2021

RECEIVED Waverley Council

Application No: DA-289/2021/A

Date Received: 09/11/2022

DRAWING REGISTER

DIAWING HEGISTER					
Drawing No.	Revision	Date	Title		
A0001 COVERSHEET					
2021-006 - A0001	E	03.11.2022	COVER SHEET		
A1000 SITE PLAN					
2021-006 - A1001	E	03.11.2022	SITE ANALYSIS PLAN		
2021-006 - A1002	E	03.11.2022	SITE PLAN		
A1100 GA PLANS					
2021-006 A1101	E	03.11.2022	LOWER GROUND FLOOR- DRIVEWAY		
2021-006 - A1102	E	03.11.2022	GROUND FLOOR PLAN		
2021-006 - A1103	E	03.11.2022	FIRST FLOOR PLAN		
2021-006 - A1104	E	03.11.2022	ROOF PLAN		
A1200 SECTIONS					
2021-006 - A1201A	E	03.11.2022	SECTION A - PART A		
2021-006 A1201B	E	03.11.2022	SECTION A - PART B		
2021-006 - A1202	E	03.11.2022	SECTION B		
2021-006 - A1203	E	03.11.2022	SECTION C		
A1300 ELEVATIONS					
2021-006 - A1301	E	03.11.2022	WEST ELEVATION		
2021-006 - A1302	E	03.11.2022	NORTH ELEVATION		
2021-006 - A1303	E	03.11.2022	SOUTH ELEVATION		
2021-006 - A1304	E	03.11.2022	EAST ELEVATION		
A1400 CALCULATIONS					
2021-006 - A1401	E	03.11.2022	CALCULATIONS - FSR		
2021-006 - A1402	E	03.11.2022	CALCULATIONS - OPEN AREA AND POS		
2021-006 - A1403	E	03.11.2022	CALCULATIONS - LANDSCAPE		

SUMMARY OF PROPOSED MODIFICATIONS

BASEMENT LEVEL

- RELOCATING PLANT ROOM TO SIDE TO PROVIDE EXTERNAL ACCESS TO STORMWATER & RAINWATER TANK.
- RELOCATE LAUNDRY ROOM TO THIS LEVEL.
- ASSOCIATED OSD AND STORMWATER UPDATE TO STORMWATER ENGINEER'S DRAWINGS.

GROUND LEVE

- INTERNAL MODIFICATION CONSISTS OF KITCHEN LAYOUT WITH PANTRY, POWDER ROOM SHIFTED AND LAUNDRY MOVED TO BASEMENT.
- REDUCTION IN NUMBER OF SIDE WINDOWS
- MINOR INCREASE TO TERRACE AREA TO ALIGN WITH SIDE STAIR.
- MODIFIED POOL AND DECK AREA

LEVEL

- FRONT BALCONIES MODIFICATION TO SHIFT FORWARD AND SLIGHT INCREASE TO MASTER BEDROOM
- REAR BEDROOM EXTENDED TO PREVIOUSLY APPROVED BALCONY, REMOVED BALCONY AND NEW ENSUITE.



ARCHITECT



t: 02 8970 5417 e: studio@bjbarchitects.com.au a: 3,09/77 Dunning Ave, Rosebery NSW 2018

BJB Architects Pty Ltd Nominated Architect: Barry Babikian NSW Reg No. 8806

ISSUE	AMENDMENT	DATE
Α	DRAFT S4.55	08.04.2022
В	DRAFT S4.55	21.04.2022
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D	S4.55 FINAL	13.05.2022
E	REVISION AS PER RFI #1	03.11.2022

PROJECT

50 GILBERT STREET, DOVER HEIGHTS

S4.55(2) MODIFICATION TO APPROVED CONSENT NO. DA-289/2021

RN

	COVER SHEET
/ED	

DATE: 03.11.202


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Application No: DA-289/2021/A

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BJB Architects Pty Ltd Nominated Architect: Barry Babikian NSW Reg No. 8806 NORTH



ISSUE	AMENDMENT	DATE
А	DRAFT S4.55	08 04 2022
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PROJECT

50 GILBERT STREET, DOVER HEIGHTS
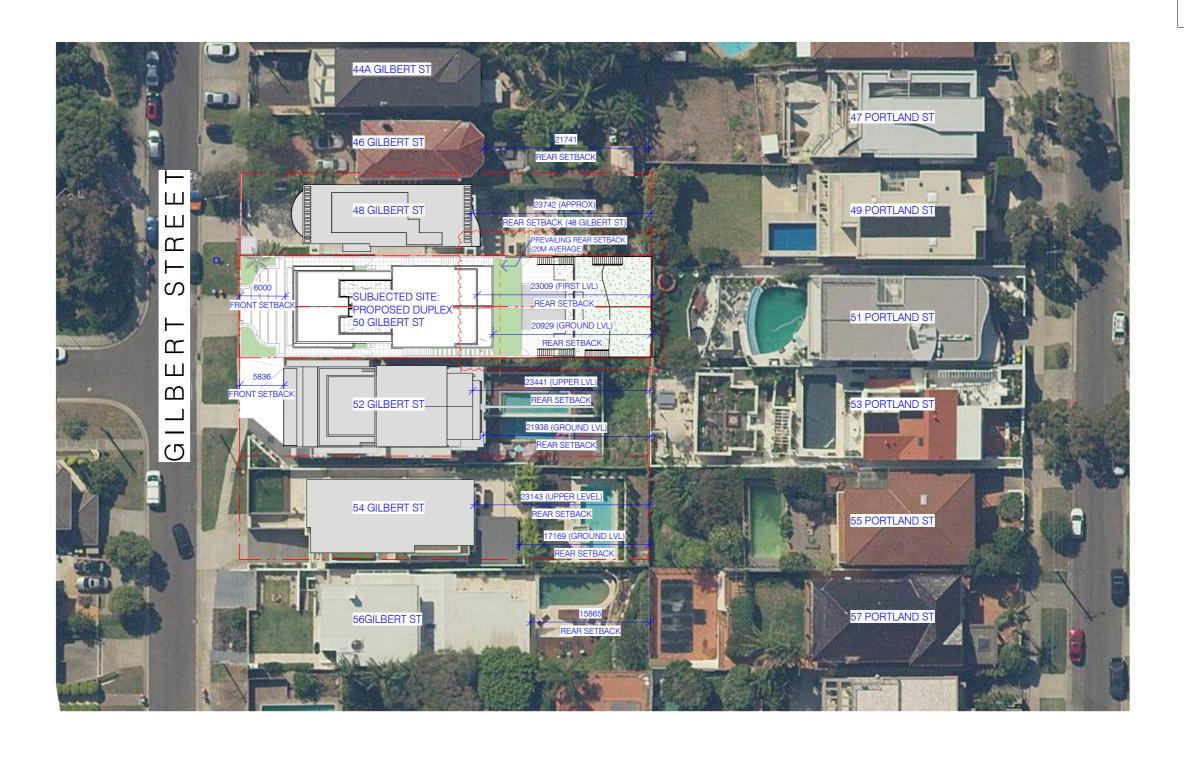
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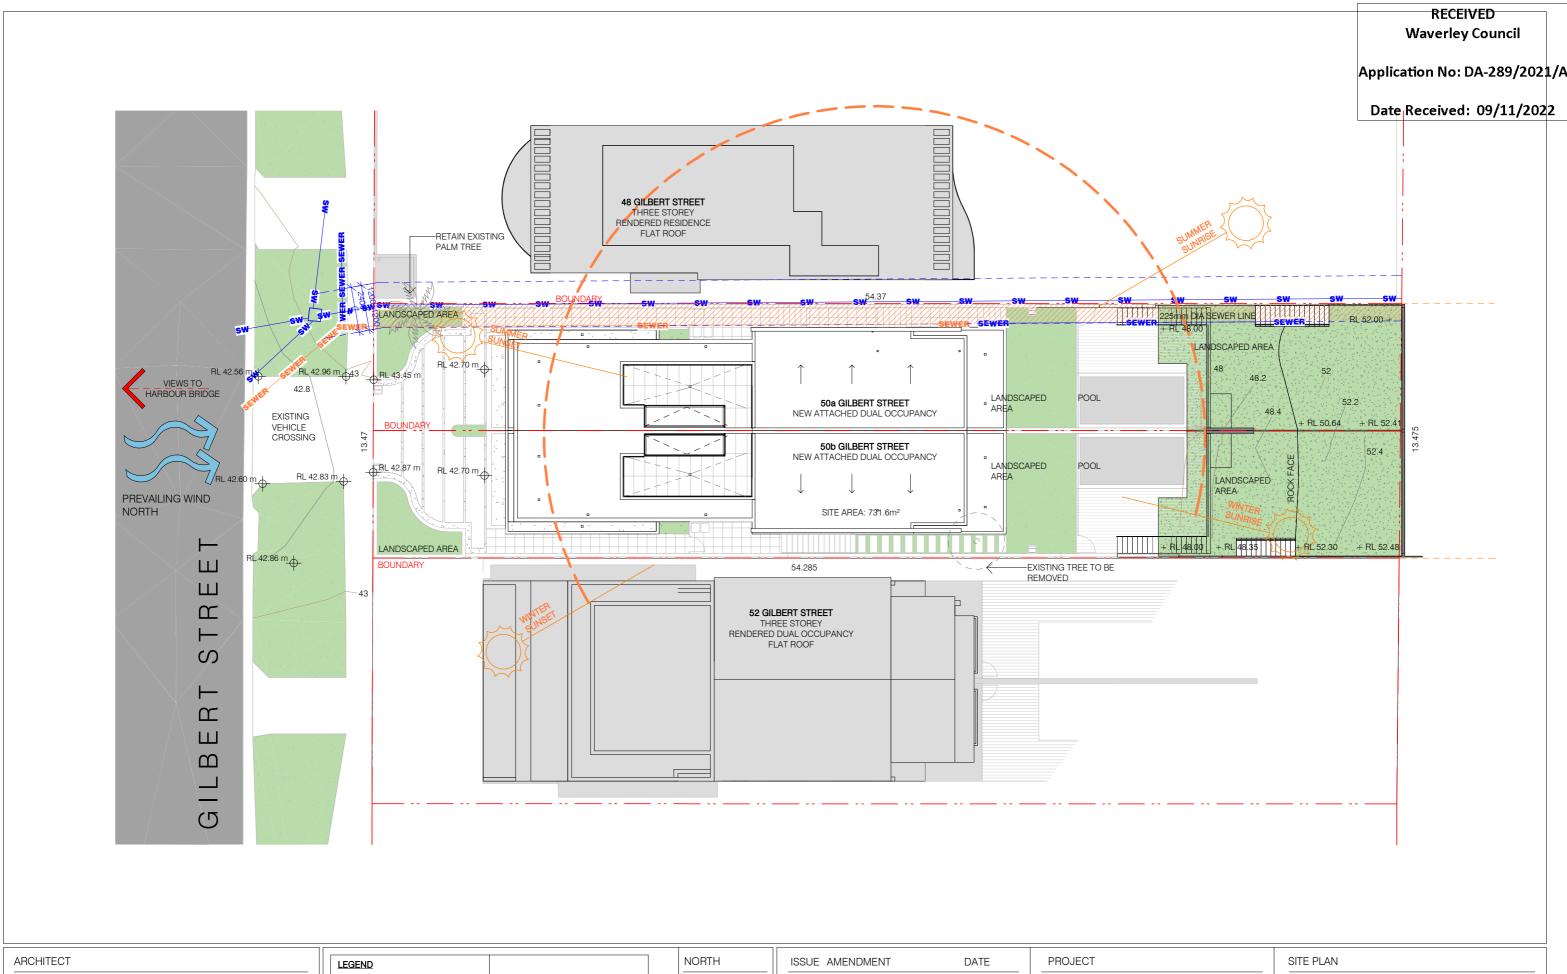
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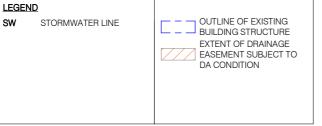
2021-006





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BJB Architects Pty Ltd Nominated Architect: Barry Babikian NSW Reg No. 8806



NORTH
NORTH

	ISSUE	AMENDMENT	DATE
	Α	DRAFT S4.55	08.04.2022
	B	DRAFT S4.55	21.04.2022
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l	E	REVISION AS PER RFI #1	03.11.2022

50 GILBERT STREET, DOVER HEIGHTS

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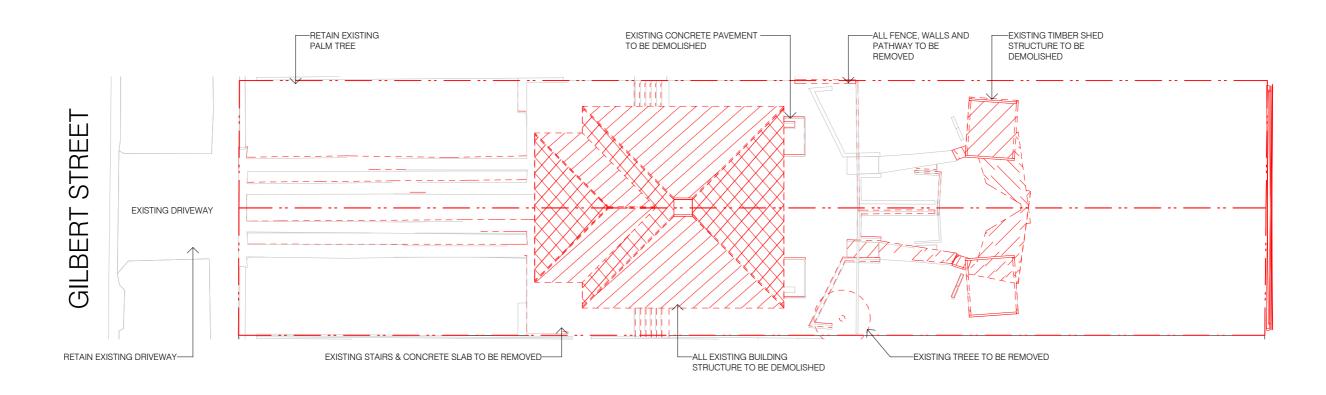
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DATE: 03.11.2022

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Application No: DA-289/2021/A

Date Received: 09/11/2022



DEMOLITION REQUIREMENTS:

ALL DEMOLITION WORK MUST BE CARRIED OUT IN ACCORDANCE WITH THE FOLLOWING:

- COMPLIANCE WITH THE REQUIREMENT OF AUSTRALIAN STANDARD AS 2601 'THE DEMOLITION OF STRUCTURES WITH SPECIFIC REFERENCE TO HEALTH AND SAFETY OF THE PUBLIC, HEALTH AND SAFETY OF THE SITE PERSONNEL, PROTECTION OF ADJOINING BUILDINGS AND PROTECTION OF THE IMMEDIATE ENVIRONMENT.
- ALL WORKS INVOLVING THE DEMOLITION, REMOVAL, TRANSPORT AND DISPOSAL OF ASBESTOS CEMENT MUST BE CARRIED OUT IN ACCORDANCE WITH THE WORKSAFE CODE OF PRACTICE FOR REMOVAL OF ASBESTOS' AND THE REQUIREMENTS OF THE WORKCOVER AUTHORITY OF NSW AND THE DEPARTMENT OF ENVIRONMENT, CLIMATE CHANGE AND WATER.
- ALL BUILDING MATERIALS ARISING FROM THE DEMOLITION MUST BE DISPOSED OF IN AN APPROVED MANNER IN ACCORDANCE WITH PART B1 OF WAVERLEY COUNCIL DEVELOPMENT CONTROL PLAN 2012 WASTE AND ANY APPLICABLE REQUIREMENTS OF THE DEPARTMENT OF ENVIRONMENT, CLIMATE
- SANITARY DRAINAGE, STORMWATER DRAINAGE, WATER, ELECTRICITY AND TELECOMMUNICATIONS MUST BE DISCONNECTED IN ACCORDANCE WITH THE REQUIREMENTS OF THE RESPONSIBLE AUTHORITIES.


- THE GENERATION OF DUST AND NOISE ON SITE MUST BE CONTROLLED.
- THE SITE MUST BE SECURED TO PROHIBIT UNAUTHORISED ENTRY.
 SUITABLE PROVISION MUST BE MADE TO CLEAN THE WHEELS AND BODIES OF ALL VEHICLES LEAVING
 THE SITE TO PREVENT THE TRACKING OF DEBRIS AND SOIL ONTO THE PUBLIC WAY.
- ALL TRUCKS AND VEHICLES ASSOCIATED WITH THE DEMOLITION, INCLUDING THOSE DELIVERING TO OR REMOVING MATERIAL FROM THE SITE, MUST ONLY HAVE ACCESS TO THE SITE DURING WORK
- HOURS NOMINATED BY COUNCIL AND ALL LOADS MUST BE COVERED. ALL VEHICLES TAKING MATERIALS FROM THE SITE MUST BE LOADED WHOLLY WITHIN THE PROPERTY UNLESS OTHERWISE PERMITTED BY COUNCIL.
- NO WASTE COLLECTION SKIPS, SOIL, EXCAVATION OR DEMOLITION MATERIAL FROM THE SITE MUST BE DEPOSITED ON THE PUBLIC ROAD, FOOT PATH, PUBLIC PLACE OR COUNCIL OWNED PROPERTY WITHOUT THE APPROVAL OF COUNCIL.

ARCHITECT



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BJB Architects Ptv Ltd Nominated Architect: Barry Babikian NSW Reg No. 8806

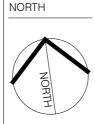

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50 GILBERT STREET, DOVER
HEIGHTS

S4.55(2) MODIFICATION TO APPROVED CONSENT NO. DA-289/2021

PROJECT

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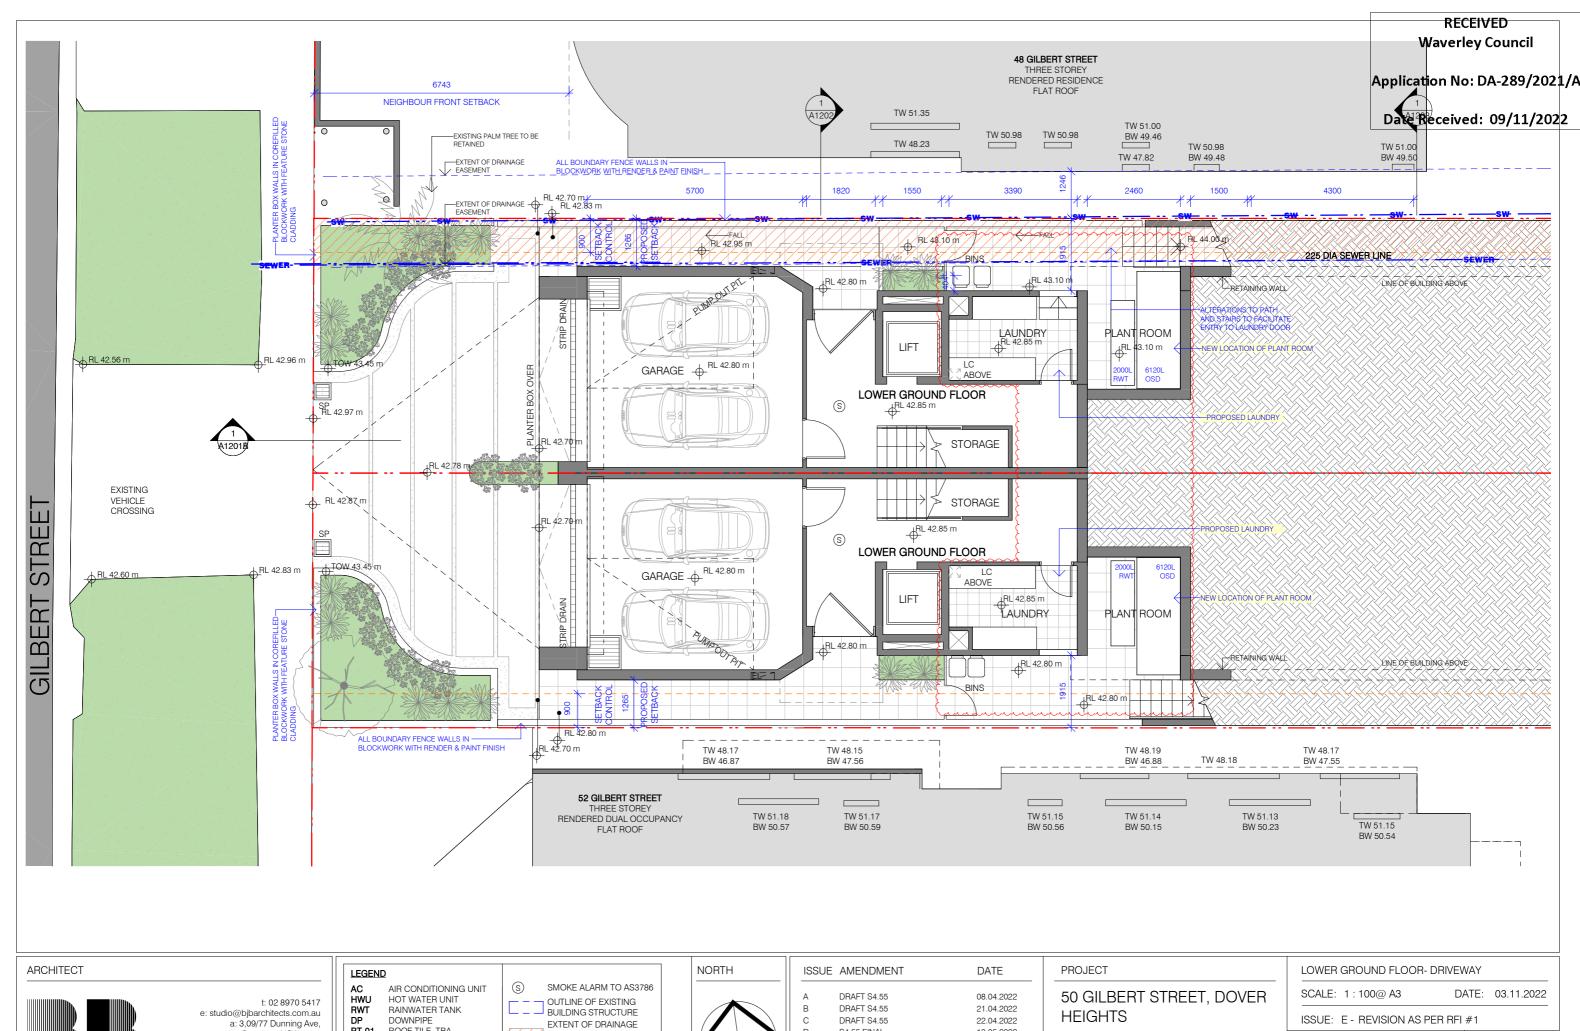
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DEMOLITION PLAN

SCALE: 1:200@ A3	DATE: 03.11.2022

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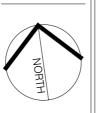




Rosebery NSW 2018

BJB Architects Ptv Ltd Nominated Architect Barry Babikian NSW Reg No. 8806

ROOF TILE, TBA EASEMENT SUBJECT TO STORMWATER PIT STORMWATER LINE DA CONDITION SW PS S4.55 ADDITIONAL AREA PRIVACY SCREEN LAUNDRY CHUTE S4.55 ALTERATIONS




D S4.55 FINAL 13.05.2022 REVISION AS PER RFI #1 03.11.2022


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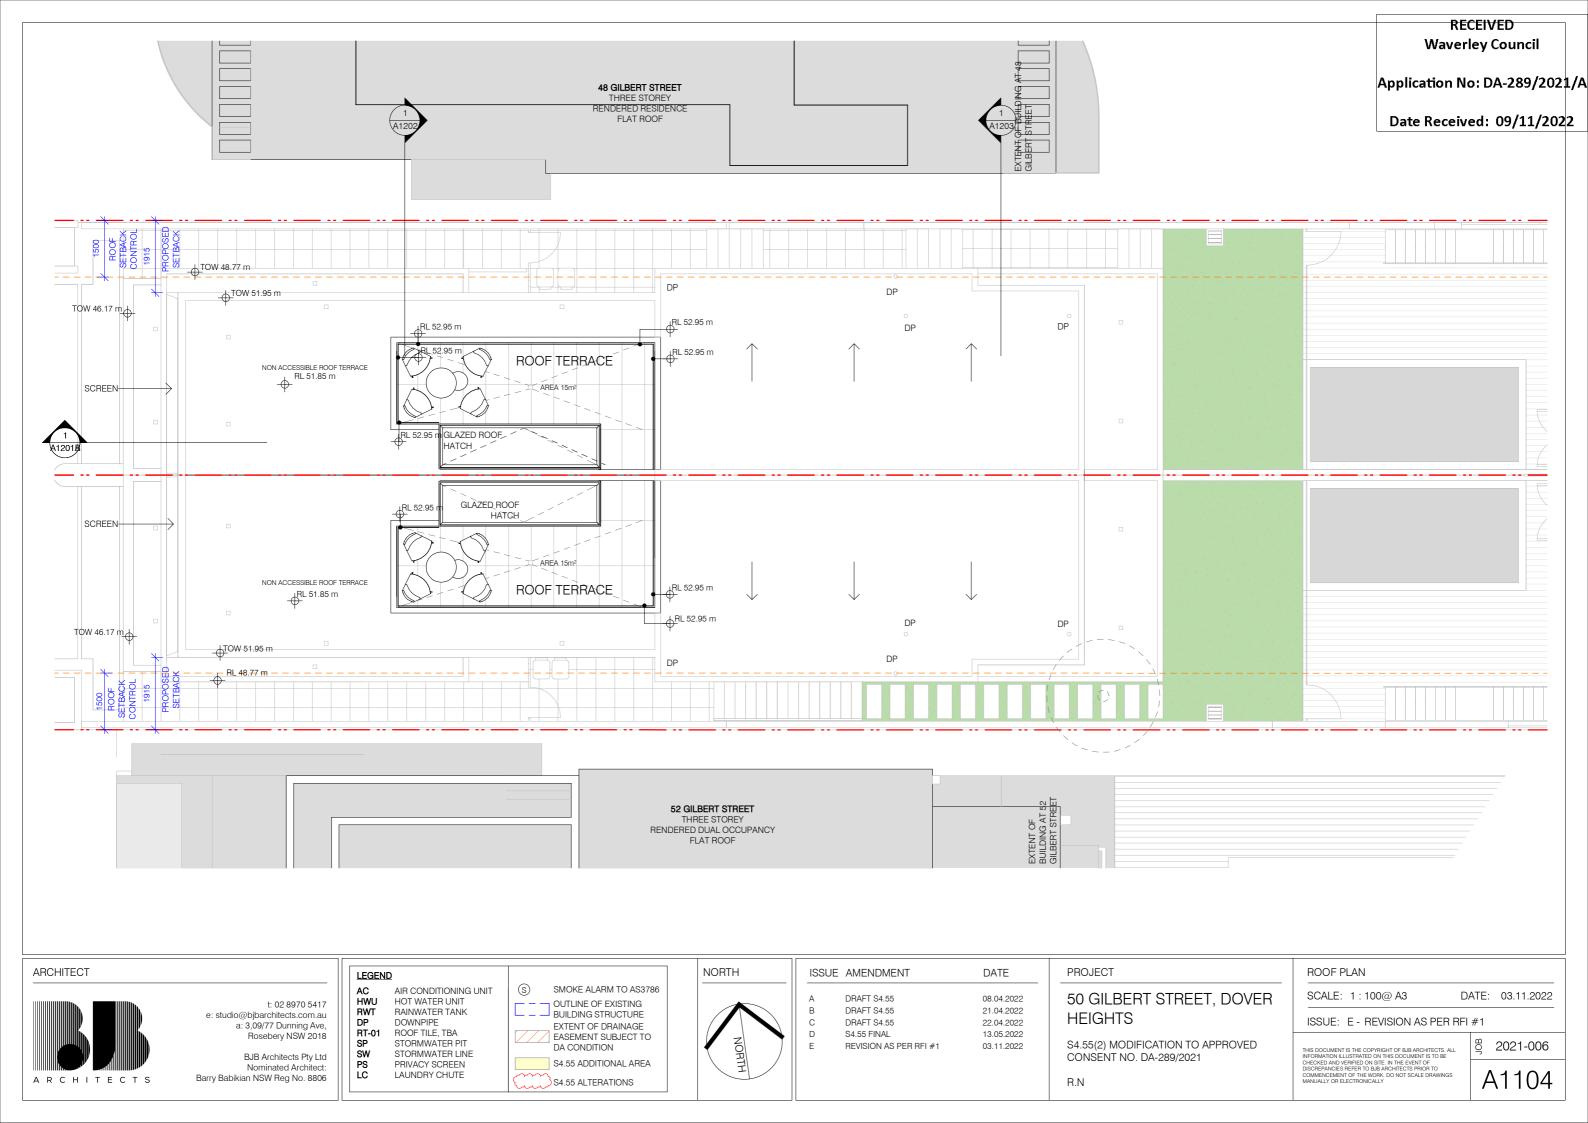
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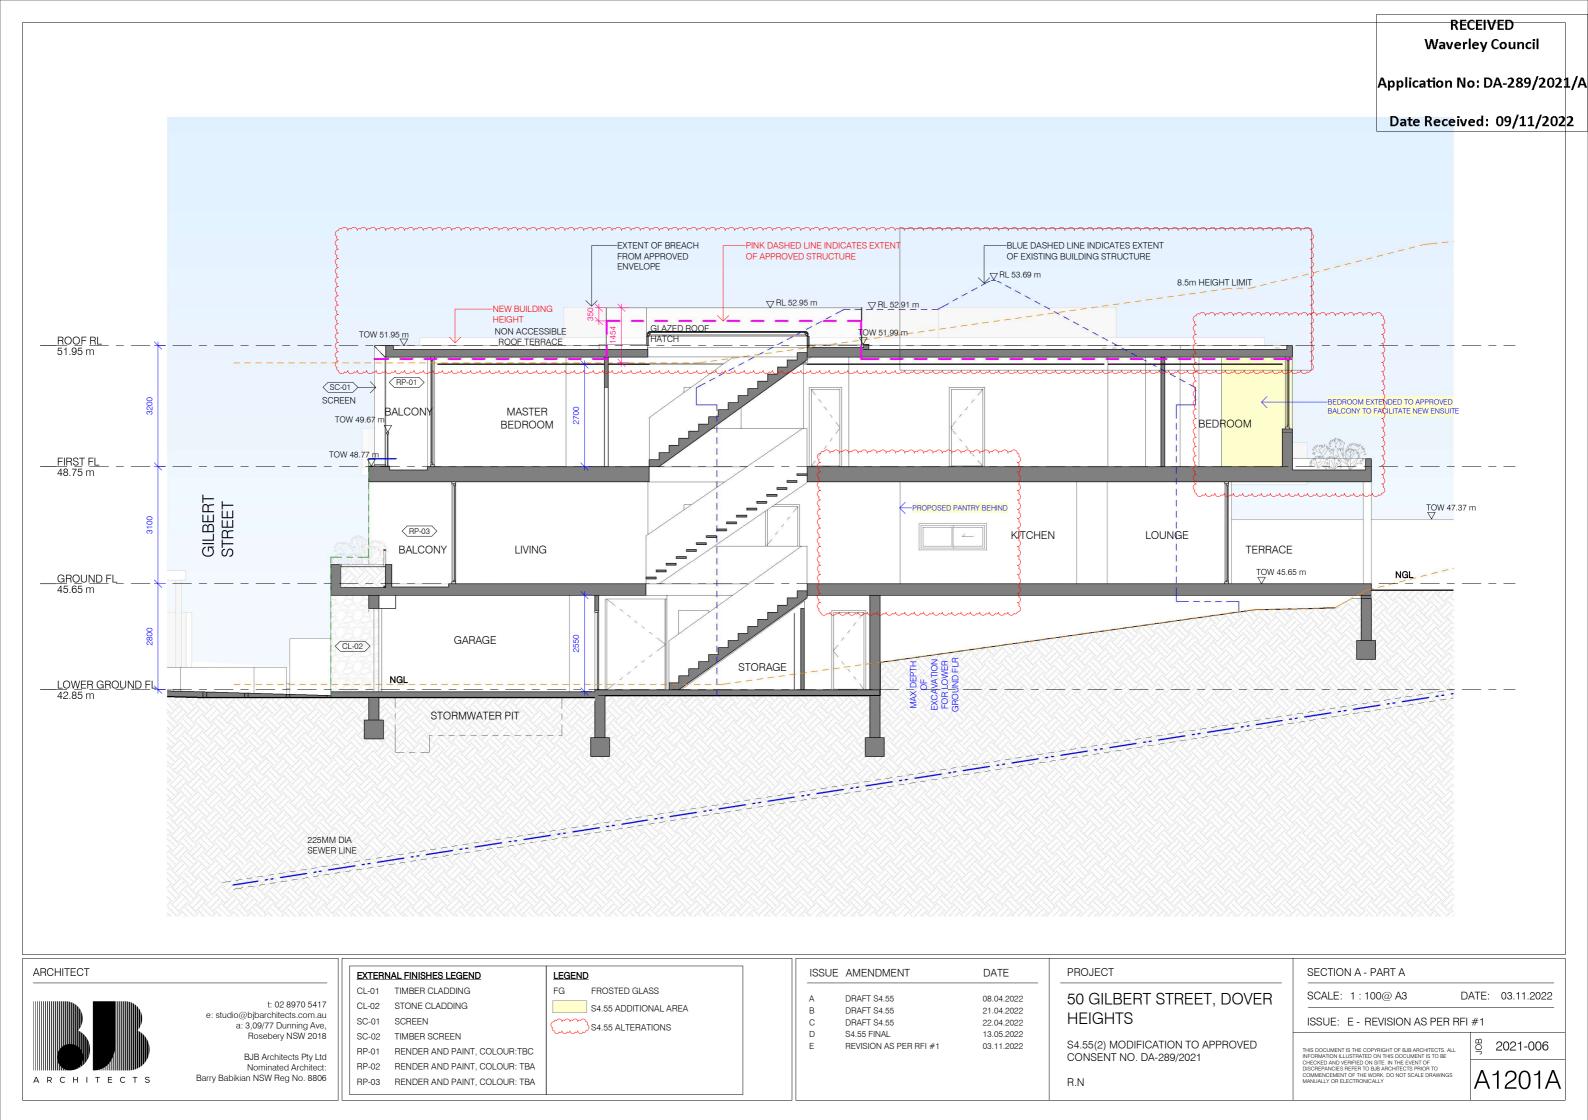
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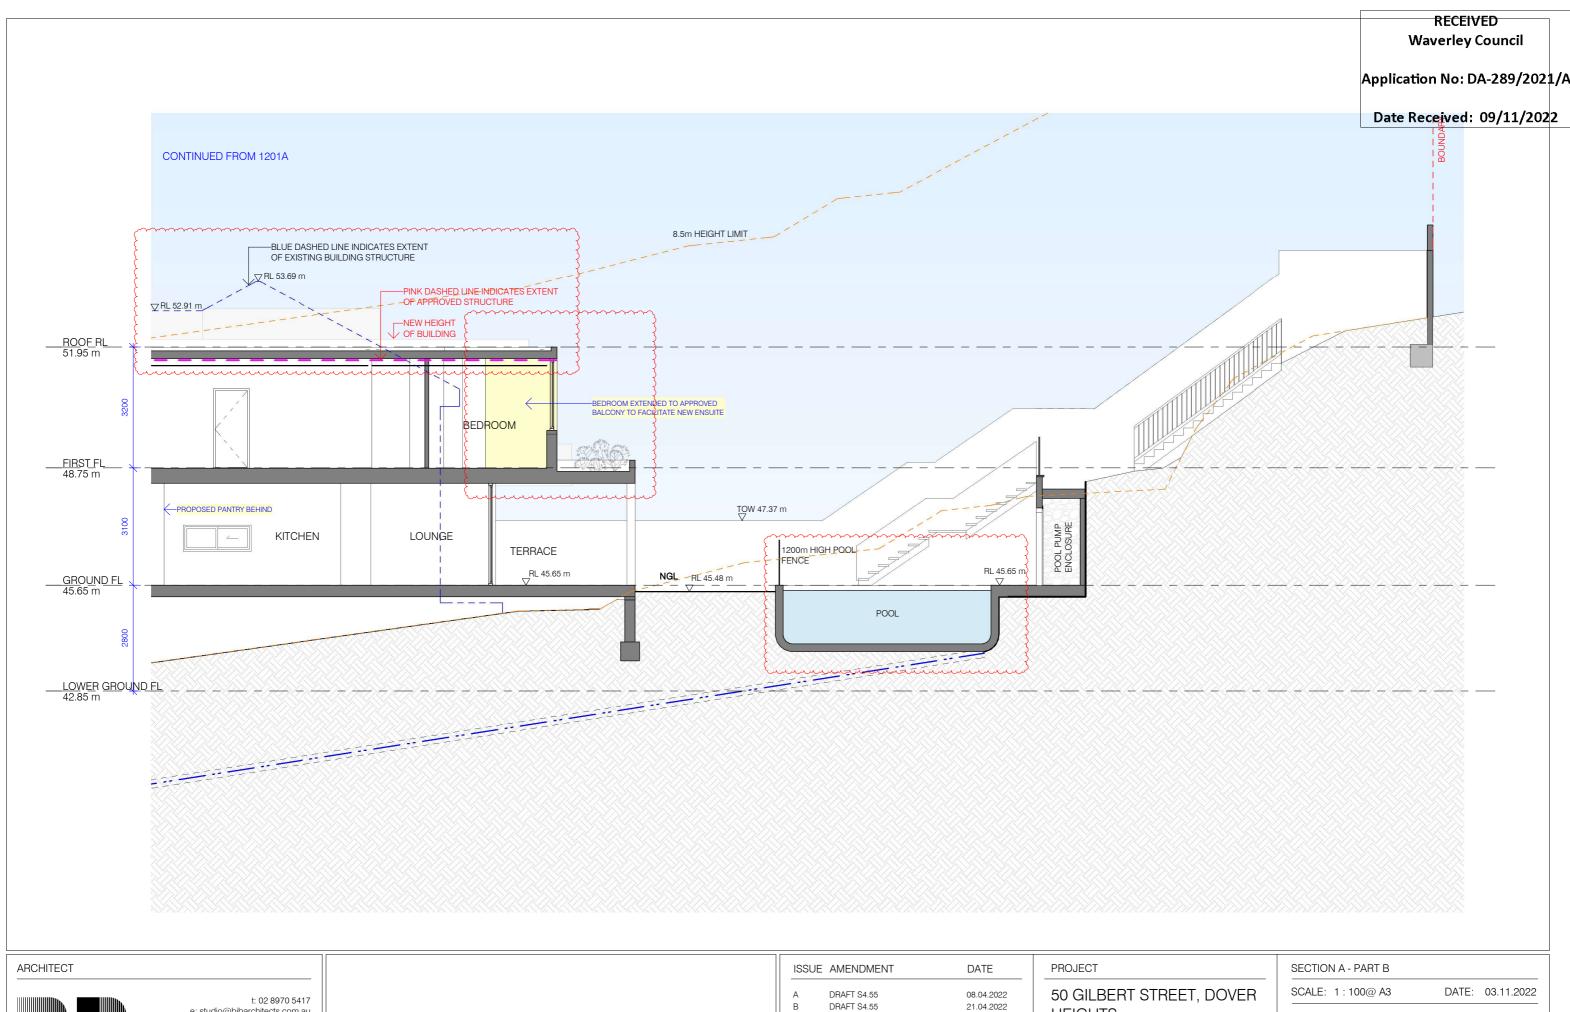
2021-006







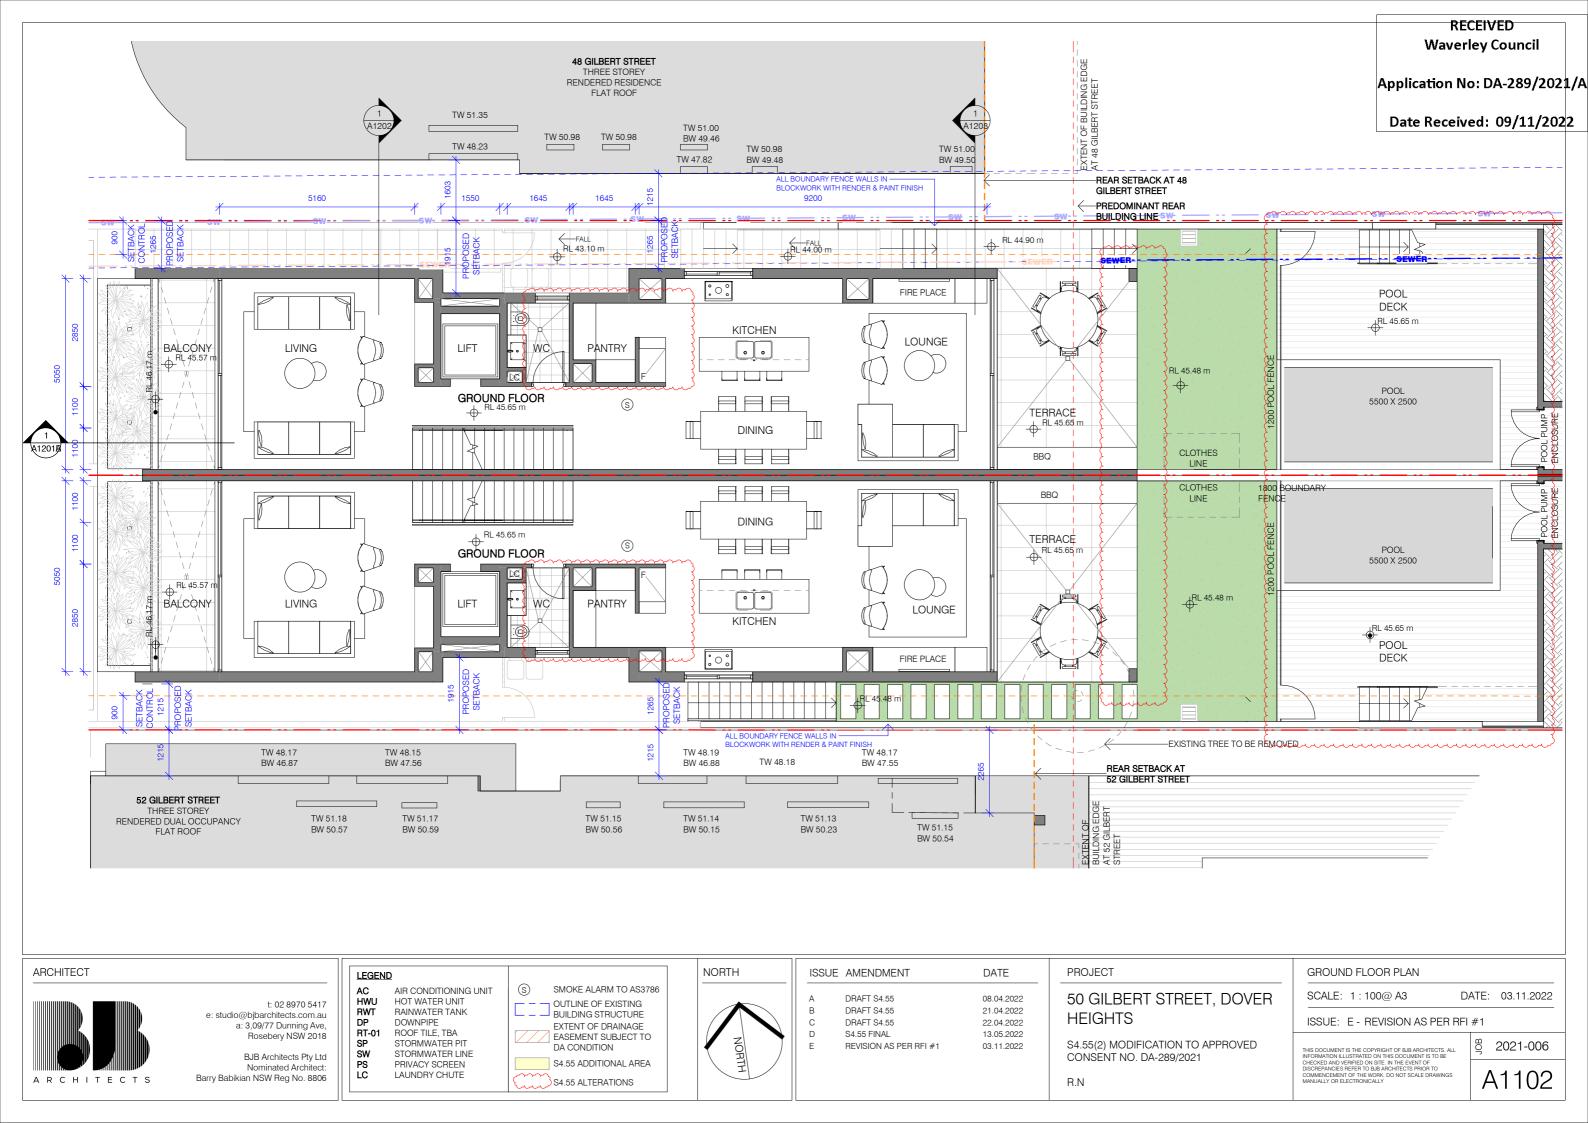

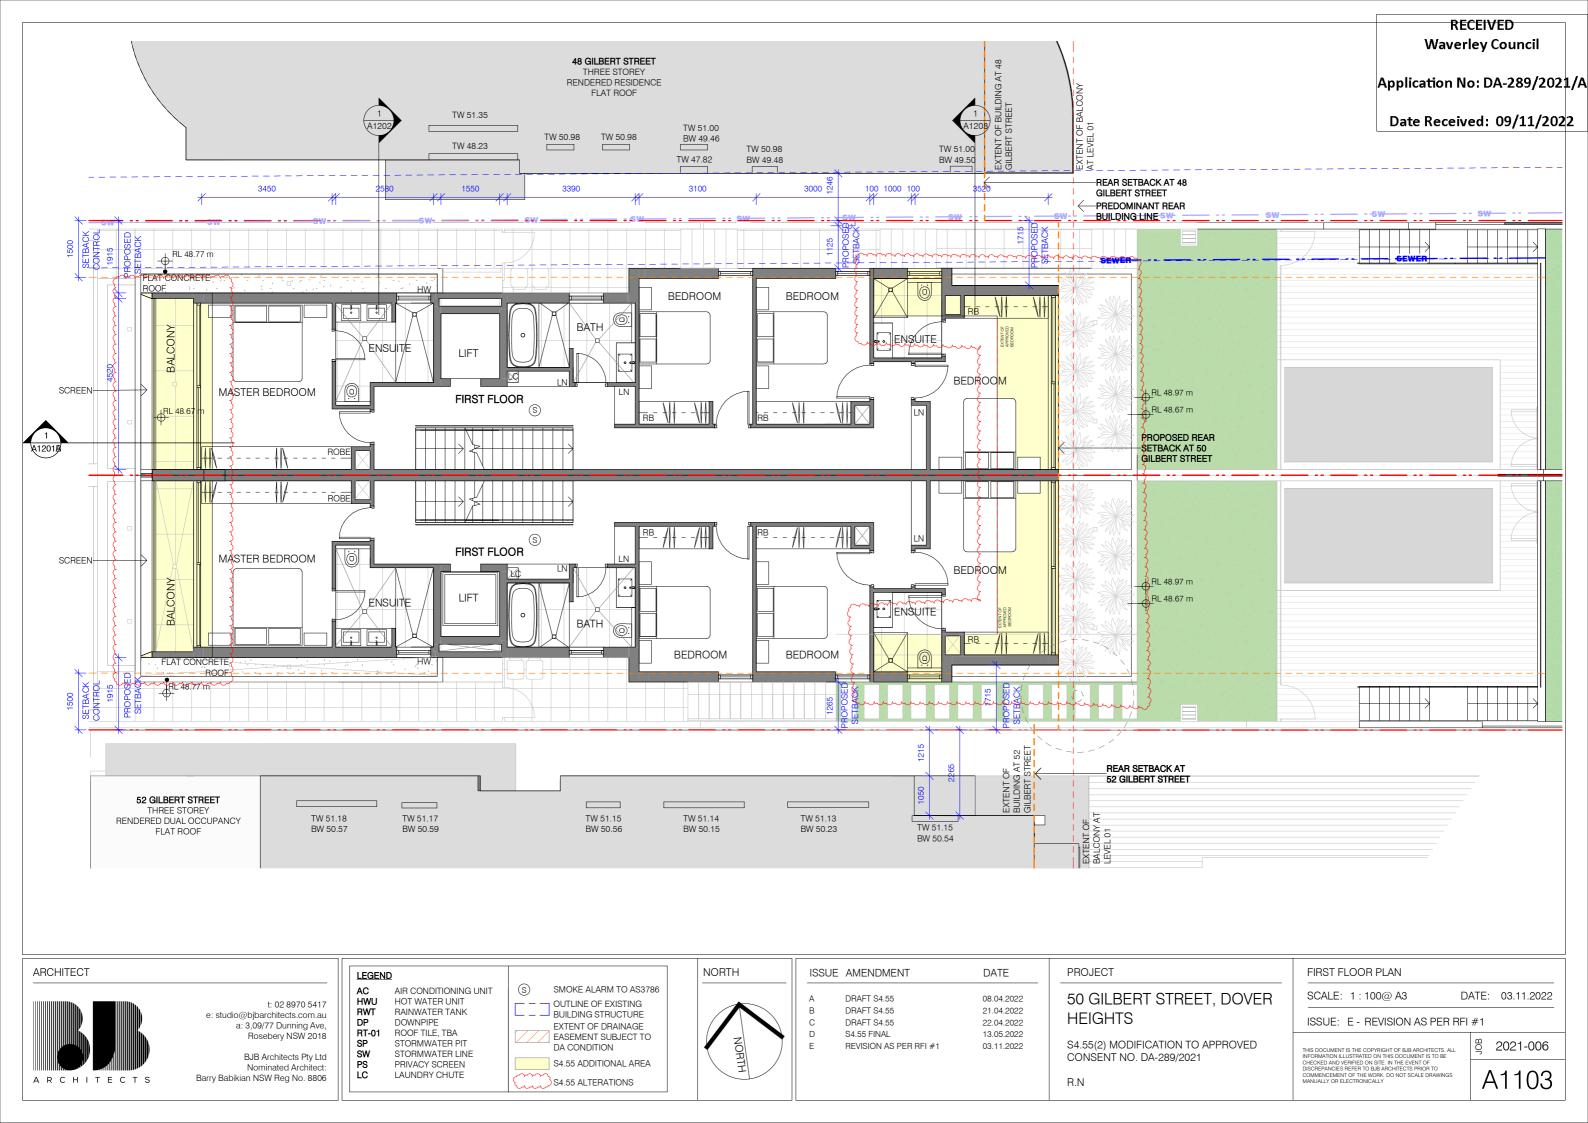



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BJB Architects Pty Ltd Nominated Architect: Barry Babikian NSW Reg No. 8806

ISSUE	AMENDMENT
A	DRAFT S4.55
В	DRAFT S4.55
С	DRAFT S4.55
D	S4.55 FINAL
E	REVISION AS PER RFI #1
I	

HEIGHTS 22.04.2022 13.05.2022

03.11.2022

S4.55(2) MODIFICATION TO APPROVED CONSENT NO. DA-289/2021

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2021-006

A1201B

-PINK DASHED LINE INDICATES
EXTENT OF APPROVED STRUCTURE -BLUE DASHED LINE INDICATES EXTENT OF EXISTING BUILDING STRUCTURE RL 53.69 m ROOF PROPOSED ROOF PROPOSED ♥RL 52.95 m GLAZED ROOF SETBACK ▽RL 52.95 m HATCH -NEW HEIGHT OF BUILDING 8.5m HEIGHT LIMIT RL 51.95 m L1 PROPOSEI SETBACK SETBACK 1500 1500 SETBACK SETBACK ENSUITE ENSUITE CONTROL CONTROL TOW 48.77 m **TO**W 48.77 m FIRST_FL 48.75 m SETBACK SETBACK 900 900 LOUNGE SETBACK SETBAC LOUNGE GROUND FL 45.65 m TOW 44.20 m TOW 44.20 m ENTRY ENTRY FOYER FOYER NGL LOWER GROUND FL 42.85 m ∇R 42 85 m 48 GILBERT STREET THREE STOREY 50b GILBERT STREET
NEW ATTACHED DUAL OCCUPANCY 52 GILBERT STREET
THREE STOREY
RENDERED DUAL OCCUPANCY 50a GILBERT STREET NEW ATTACHED DUAL OCCUPANCY RENDERED RESIDENCE FLAT ROOF 225mm DIA SEWER **PROJECT** SECTION B **ARCHITECT** ISSUE AMENDMENT DATE EXTERNAL FINISHES LEGEND **LEGEND** CL-01 TIMBER CLADDING FROSTED GLASS SCALE: 1:100@ A3 DATE: 03.11.2022 50 GILBERT STREET, DOVER DRAFT S4.55 08.04.2022 t: 02 8970 5417 CL-02 STONE CLADDING S4.55 ADDITIONAL AREA DRAFT S4.55 21.04.2022 e: studio@bjbarchitects.com.au **HEIGHTS** SC-01 SCREEN DRAFT S4.55 22.04.2022 ISSUE: E - REVISION AS PER RFI #1 a: 3,09/77 Dunning Ave, S4.55 ALTERATIONS D S4.55 FINAL 13.05.2022 Rosebery NSW 2018 SC-02 TIMBER SCREEN REVISION AS PER RFI #1 03.11.2022 RENDER AND PAINT, COLOUR:TBC BJB Architects Pty Ltd

RP-02

Nominated Architect:

Barry Babikian NSW Reg No. 8806

ARCHITECTS

RENDER AND PAINT, COLOUR: TBA

RP-03 RENDER AND PAINT, COLOUR: TBA

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Application No: DA-289/2021/A

Date Received: 09/11/2022

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2021-006

Application No: DA-289/2021/A Date Received: 09/11/2022 -PINK DASHED LINE INDICATES EXTENT OF APPROVED STRUCTURE -BLUE DASHED LINE INDIOATES EXTENT OF EXISTING BUILDING STRUCTURE 1715 1715 1 PROPOSED 1 L1 PROPOSED ▽RL 52.95 m SETBACK SETBACK NEW HEIGHT OF BUILDING-ROOF RL 51.95 m __1500 -SETBACK CONTROL SETBACK CONTROL EXTENSION OF BEDROOM
TO FACILITATE ENSUITE BEDROOM BEDROOM TO FACILITATE ENSUITE T**∮**W 48.97 m TOW 48.97 m ▽RL 48.85 m FIRST FL 48.75 m SETBACK SETRACK KITCHEN KITCHEN SETBA LOWER GROUND FL 42.85 m 48 GILBERT STREET
THREE STOREY
RENDERED RESIDENCE 50a GILBERT STREET NEW ATTACHED DUAL OCCUPANCY 52 GILBERT STREET 50b GILBERT STREET THREE STOREY
RENDERED DUAL OCCUPANCY NEW ATTACHED DUAL OCCUPANCY **ARCHITECT PROJECT** SECTION C ISSUE AMENDMENT DATE EXTERNAL FINISHES LEGEND **LEGEND** CL-01 TIMBER CLADDING FG FROSTED GLASS SCALE: 1:100@ A3 DATE: 03.11.2022 50 GILBERT STREET, DOVER DRAFT S4.55 08.04.2022 t: 02 8970 5417 CL-02 STONE CLADDING S4.55 ADDITIONAL AREA DRAFT S4.55 21.04.2022 e: studio@bjbarchitects.com.au **HEIGHTS** SCREEN SC-01 DRAFT S4.55 22.04.2022 ISSUE: E - REVISION AS PER RFI #1 a: 3,09/77 Dunning Ave, S4.55 ALTERATIONS D S4.55 FINAL 13.05.2022 Rosebery NSW 2018 SC-02 TIMBER SCREEN REVISION AS PER RFI #1 S4.55(2) MODIFICATION TO APPROVED 2021-006 03.11.2022 THIS DOCUMENT IS THE COPYRIGHT OF BUB ARCHITECTS. ALL INFORMATION ILLUSTRATED ON THIS DOCUMENT IS TO BE CHECKED AND VERRIED ON SET IN THE EVENT OF DISCREPANCIES REFER TO BUB ARCHITECTS PRIOR TO COMMENCEMENT OF THE WORK. DO NOT SCALE DRAWINGS MANUALLY OR ELECTRONICAL. RENDER AND PAINT, COLOUR:TBC CONSENT NO. DA-289/2021 BJB Architects Pty Ltd

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RP-02 RENDER AND PAINT, COLOUR: TBA

RP-03 RENDER AND PAINT, COLOUR: TBA

Nominated Architect:

Barry Babikian NSW Reg No. 8806

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Waverley Council Application No: DA-289/2021/A Date Received: 09/11/2022 GLAZED ROOF HATCH -GLAZED ROOF HATCH APPROVED BUILDING -RIDGE RL 53.69 m GLAZED -GLAZED APPROVED BUILDIN HEIGHT BALUSTRADE BALUSTRADE ▽ RL 52.95 m -NEW BUILDING HEIGHT L1 PROPOSED L1 PROPOSED SETBACK SETBACK 8.5m HEIGHT 3LIMIT 1500 1500 SETBAC SETBACK CONTR <u>FIRST FL</u> 48.75 m (RP-03) OF PROPOS SETBACK SETBACK 900 SETBACK OW 46.57 m GROUND FI 45.65 m TOW 43.45 m OW 43.45 m LOWER GROUND FL 42.85 m 48 GILBERT STREET THREE STOREY 50b GILBERT STREET NEW ATTACHED DUAL OCCUPANCY 50a GILBERT STREET 52 GILBERT STREET NEW ATTACHED DUAL OCCUPANCY THREE STOREY RENDERED RESIDENCE RENDERED DUAL OCCUPANCY FLAT ROOF FLAT ROOF **ARCHITECT PROJECT** WEST ELEVATION ISSUE AMENDMENT DATE EXTERNAL FINISHES LEGEND **LEGEND** CL-01 TIMBER CLADDING FROSTED GLASS SCALE: 1:100@ A3 DATE: 03.11.2022 50 GILBERT STREET, DOVER DRAFT S4.55 08.04.2022 t: 02 8970 5417 CL-02 STONE CLADDING S4.55 ADDITIONAL AREA DRAFT S4.55 21.04.2022

DRAFT S4.55

S4.55 FINAL

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Barry Babikian NSW Reg No. 8806

ARCHITECTS

a: 3,09/77 Dunning Ave,

Rosebery NSW 2018

BJB Architects Pty Ltd

Nominated Architect:

SC-01

SC-02

RP-02

SCREEN

TIMBER SCREEN

RENDER AND PAINT, COLOUR:TBC

RENDER AND PAINT, COLOUR: TBA

RP-03 RENDER AND PAINT, COLOUR: TBA

S4.55 ALTERATIONS

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HEIGHTS

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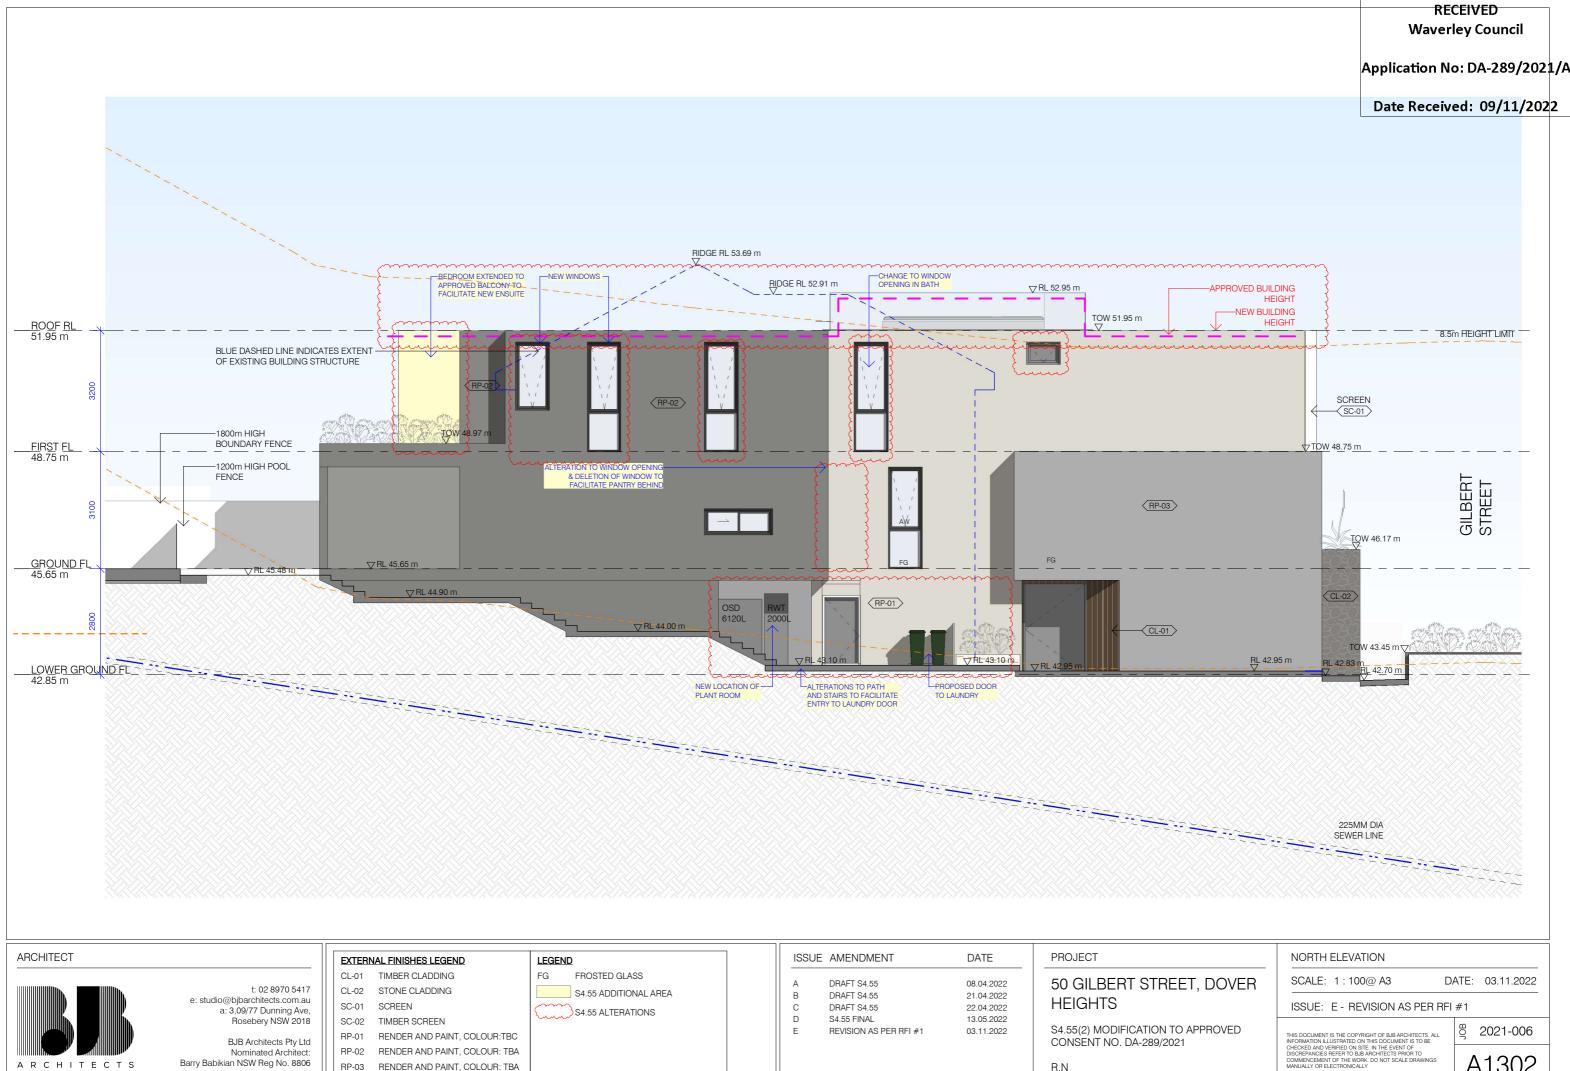
CONSENT NO. DA-289/2021

22.04.2022

13.05.2022

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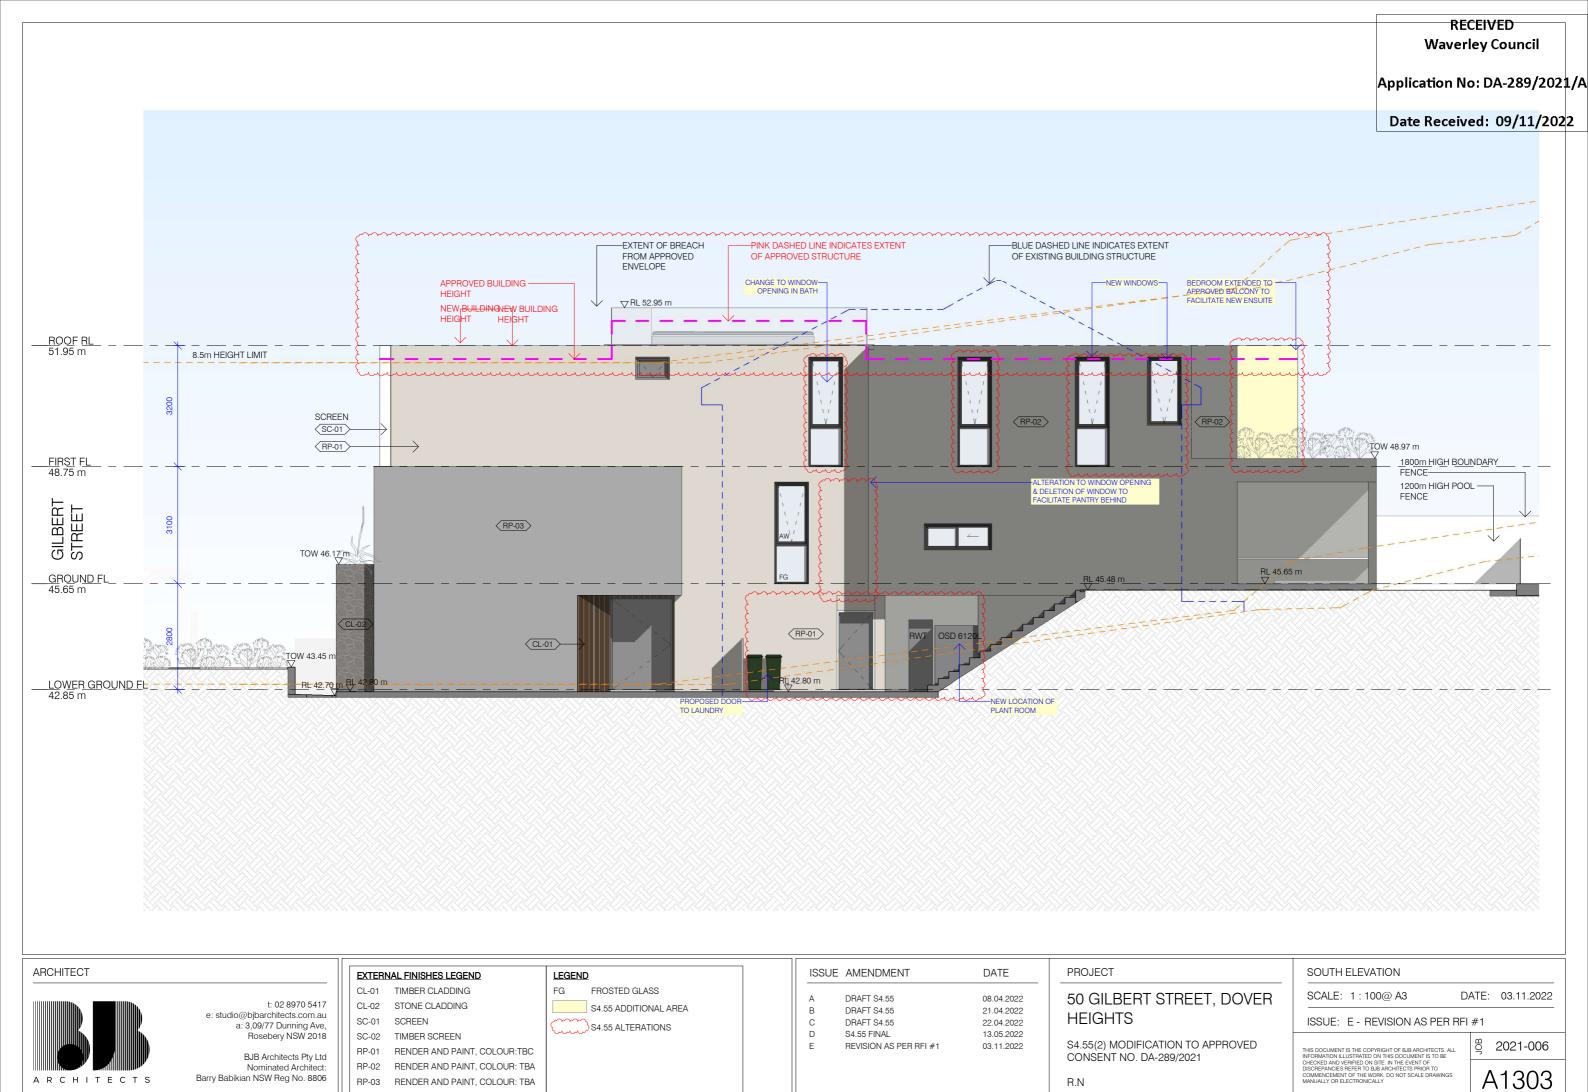


R.N

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RP-03 RENDER AND PAINT, COLOUR: TBA

ARCHITECTS



R.N

RP-03 RENDER AND PAINT, COLOUR: TBA




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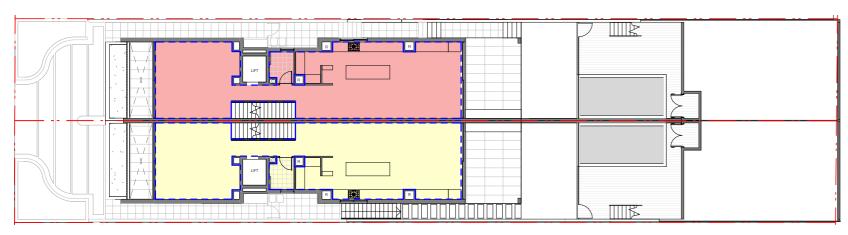
RP-03 RENDER AND PAINT, COLOUR: TBA

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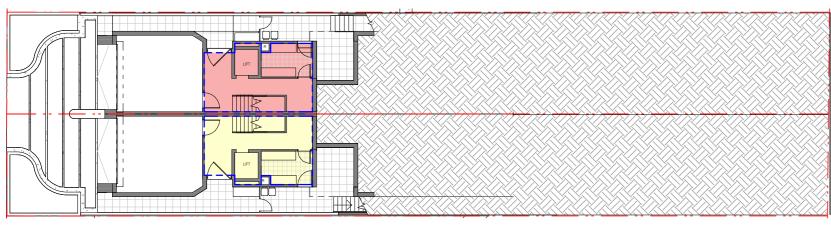
A1304



FSR - FIRST FL 1:250

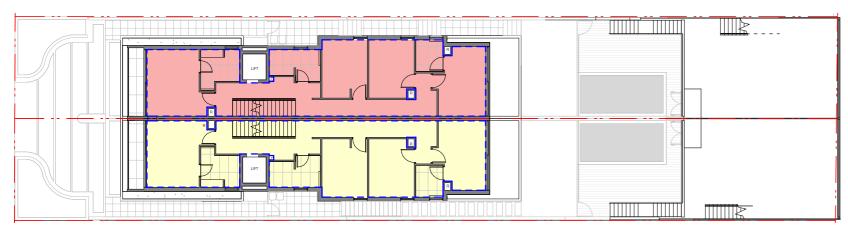

FSR - GROUND FL 1:250



FSR - LOWER GROUND FL



ARCHITECT

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BJB Architects Pty Ltd Nominated Architect: Barry Babikian NSW Reg No. 8806

LEGEND

RISER LAUNDRY CHUTE ISSUE AMENDMENT DATE DRAFT S4.55 08.04.2022 DRAFT S4.55 21.04.2022 DRAFT S4.55 22.04.2022 S4.55 FINAL 13.05.2022 REVISION AS PER RFI #1 03.11.2022

PROJECT 50 GILBERT STREET, DOVER **HEIGHTS**

S4.55(2) MODIFICATION TO APPROVED CONSENT NO. DA-289/2021

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CALCULATIONS - FSR

SCALE: As indicated@ A3 DATE: 03.11.2022

ISSUE: E - REVISION AS PER RFI #1

S4.55 CHANGES

NO CHANGE

NO CHANGE

NO CHANGE

NO CHANGE

 $+11.1 \text{ m}^2$

 $+15.6 \, \mathrm{m}^2$

19.7 m²

433.4 m²

(0.592:1)

- 7.0 m²

30.7 m²

87.3 m²

98.7m²

216.7 m²

RECEIVED

Waverley Council

Application No: DA-289/2021/A

Date Received: 09/11/2022

2021-006

A1401

FSR CALCULATIONS

PERMISSIBLE AREA

GROUND FLOOR

FIRST FLOOR

LOWER GROUND FLOOR

TOTAL (PER DWELLING)

GROSS TOTAL FSR

PROPOSED AREAS (PER DWELLING)

SITE AREA

FSR

APPROVED DA

182.9 m² (PER DWELLING)

731.6 m²

365.8 m²

19.6 m²

94.3 m²

83.1 m²

197.0 m²

394.0 m²

(0.54:1)

PROPOSED FSR - HOUSE A

PROPOSED FSR - HOUSE B

0.5:1


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PRIVATE OPEN SPACE - GROUND FL

| | | | | | | UP-----

OPEN AREA - GROUND FL



OPEN AREA - LOWER GROUND FL

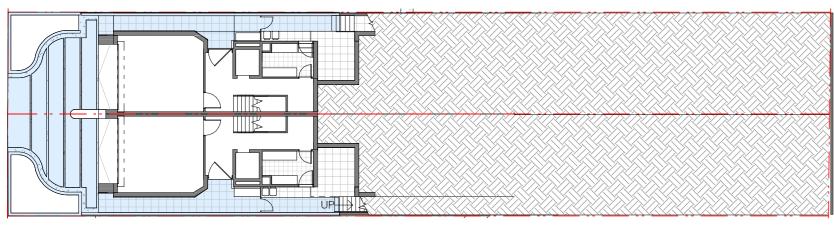PRIVATE OPEN SPACE

SITE AREA - 731.6 m²

Application No: DA-289/2021/A

RECEIVED **Waverley Council**

Date Received: 09/11/2022

REQUIRED POS min 25m²

(PER DWELLING WITH MIN WIDTH AND

DEPTH OF 3m)

PROPOSED POS 73.7 m²

(PER DWELLING. DIMENSIONS AS SHOWN)

PROPOSED PRIVATE OPEN SPACE

OPEN AREA

SITE AREA - 731.6 m² FSR - 0.5:1 PERMISSIBLE AREA - 365.8 m²

REQUIRED OPEN AREA 292.64m²

(40% OF TOTAL SITE AREA)

PROPOSED OPEN AREA 472.5m²

(64.5% OF TOTAL SITE AREA)

PROPOSED OPEN AREA

ARCHITECT t: 02 8970 5417 e: studio@bjbarchitects.com.au a: 3,09/77 Dunning Ave, Rosebery NSW 2018 BJB Architects Pty Ltd Nominated Architect: Barry Babikian NSW Reg No. 8806

ISSUE AMENDMENT DATE DRAFT S4.55 08.04.2022 DRAFT S4.55 21.04.2022 DRAFT S4.55 22.04.2022 S4.55 FINAL 13.05.2022 REVISION AS PER RFI #1 03.11.2022

50 GILBERT STREET, DOVER **HEIGHTS**

PROJECT

S4.55(2) MODIFICATION TO APPROVED CONSENT NO. DA-289/2021

ISSUE: E - REVISION AS PER RFI #1

CALCULATIONS - OPEN AREA AND POS

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SCALE: As indicated@ A3

2021-006 A1402

DATE: 03.11.2022

LANDSCAPE

Application No: DA-289/2021/A

Date Received: 09/11/2022

RECEIVED **Waverley Council**

SITE AREA - 731.6 m²

REQUIRED LANDSCAPE 109.74 m²


(15% OF TOTAL SITE AREA)

PROPOSED LANDSCAPE 254.4 m²


(34.7% OF TOTAL SITE AREA)

PROPOSED LANDSCAPE AREA

LANDSCAPE - GROUND FL

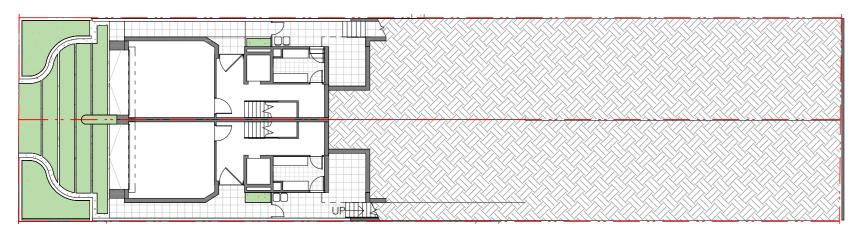

LANDSCAPE - LOWER GROUND FL

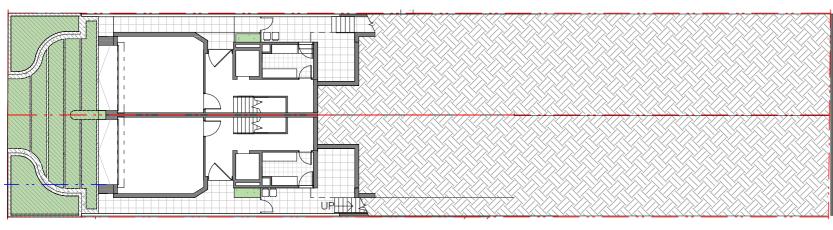

LANDSCAPE FOB - LOWER GROUND FL

LANDSCAPE AT FRONT OF BUILDING

TOTAL AREA - 80.7 m²

REQUIRED LANDSCAPE 40.1 m²

(50% OF OPEN AREA AT FRONT)

PROPOSED LANDSCAPE 64.73 m²

(80.7% OF TOTAL SITE AREA)

OPEN AREA AT FRONT OF BUILDING

LANDSCAPE AREA

ARCHITECT



t: 02 8970 5417 e: studio@bjbarchitects.com.au a: 3,09/77 Dunning Ave, Rosebery NSW 2018

BJB Architects Pty Ltd Nominated Architect: Barry Babikian NSW Reg No. 8806

ISSUE AMENDMENT DATE DRAFT S4.55 08.04.2022 DRAFT S4.55 21.04.2022 DRAFT S4.55 22.04.2022 S4.55 FINAL 13.05.2022 REVISION AS PER RFI #1 03.11.2022

PROJECT

50 GILBERT STREET, DOVER **HEIGHTS**

S4.55(2) MODIFICATION TO APPROVED

CONSENT NO. DA-289/2021

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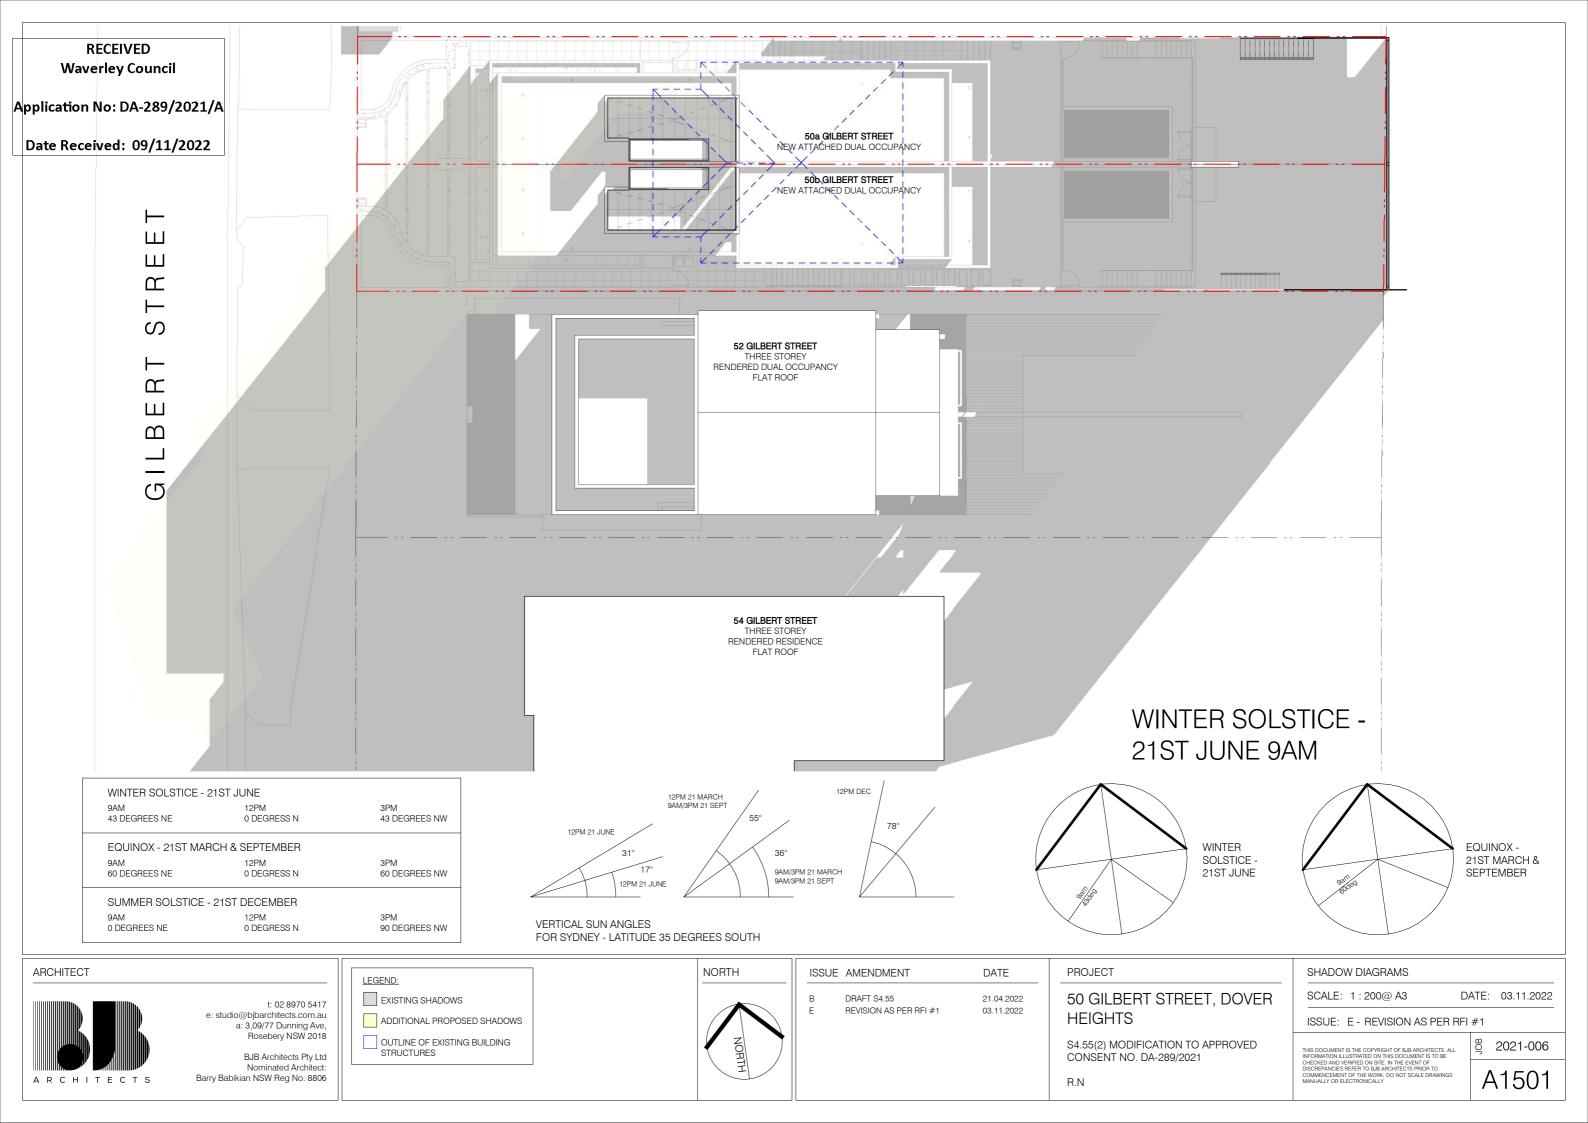
CALCULATIONS - LANDSCAPE SCALE: As indicated@ A3


ISSUE: E - REVISION AS PER RFI #1


2021-006


DATE: 03.11.2022


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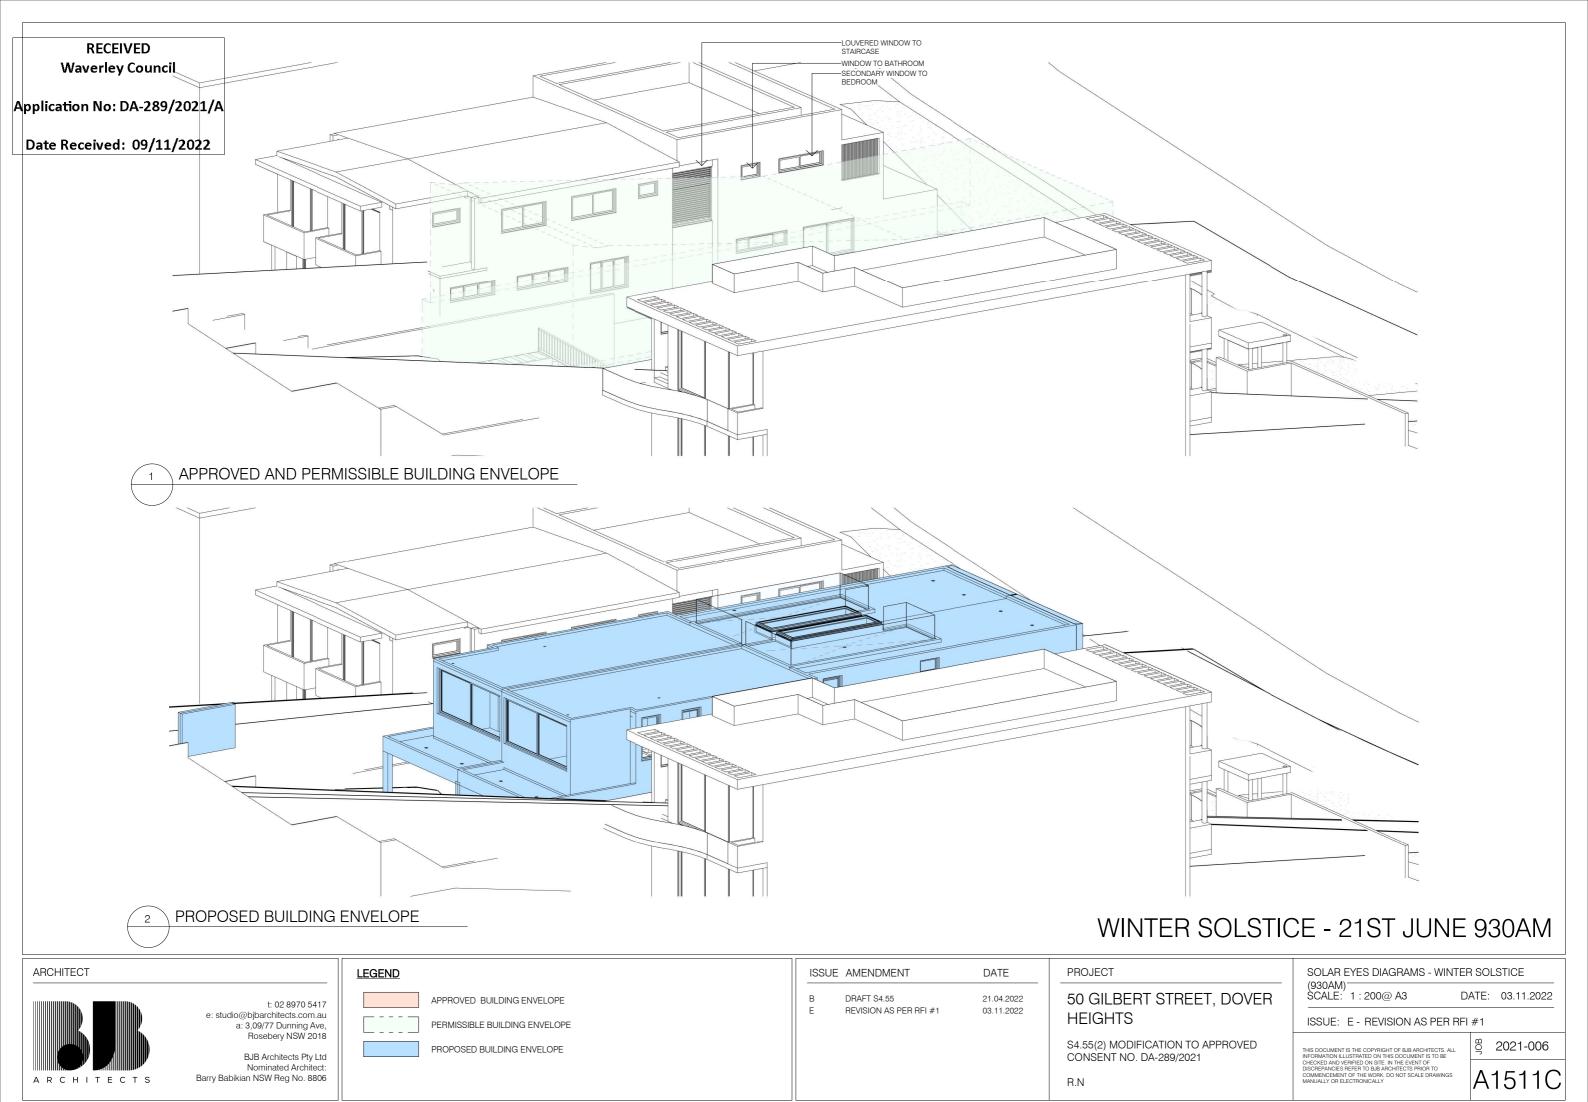





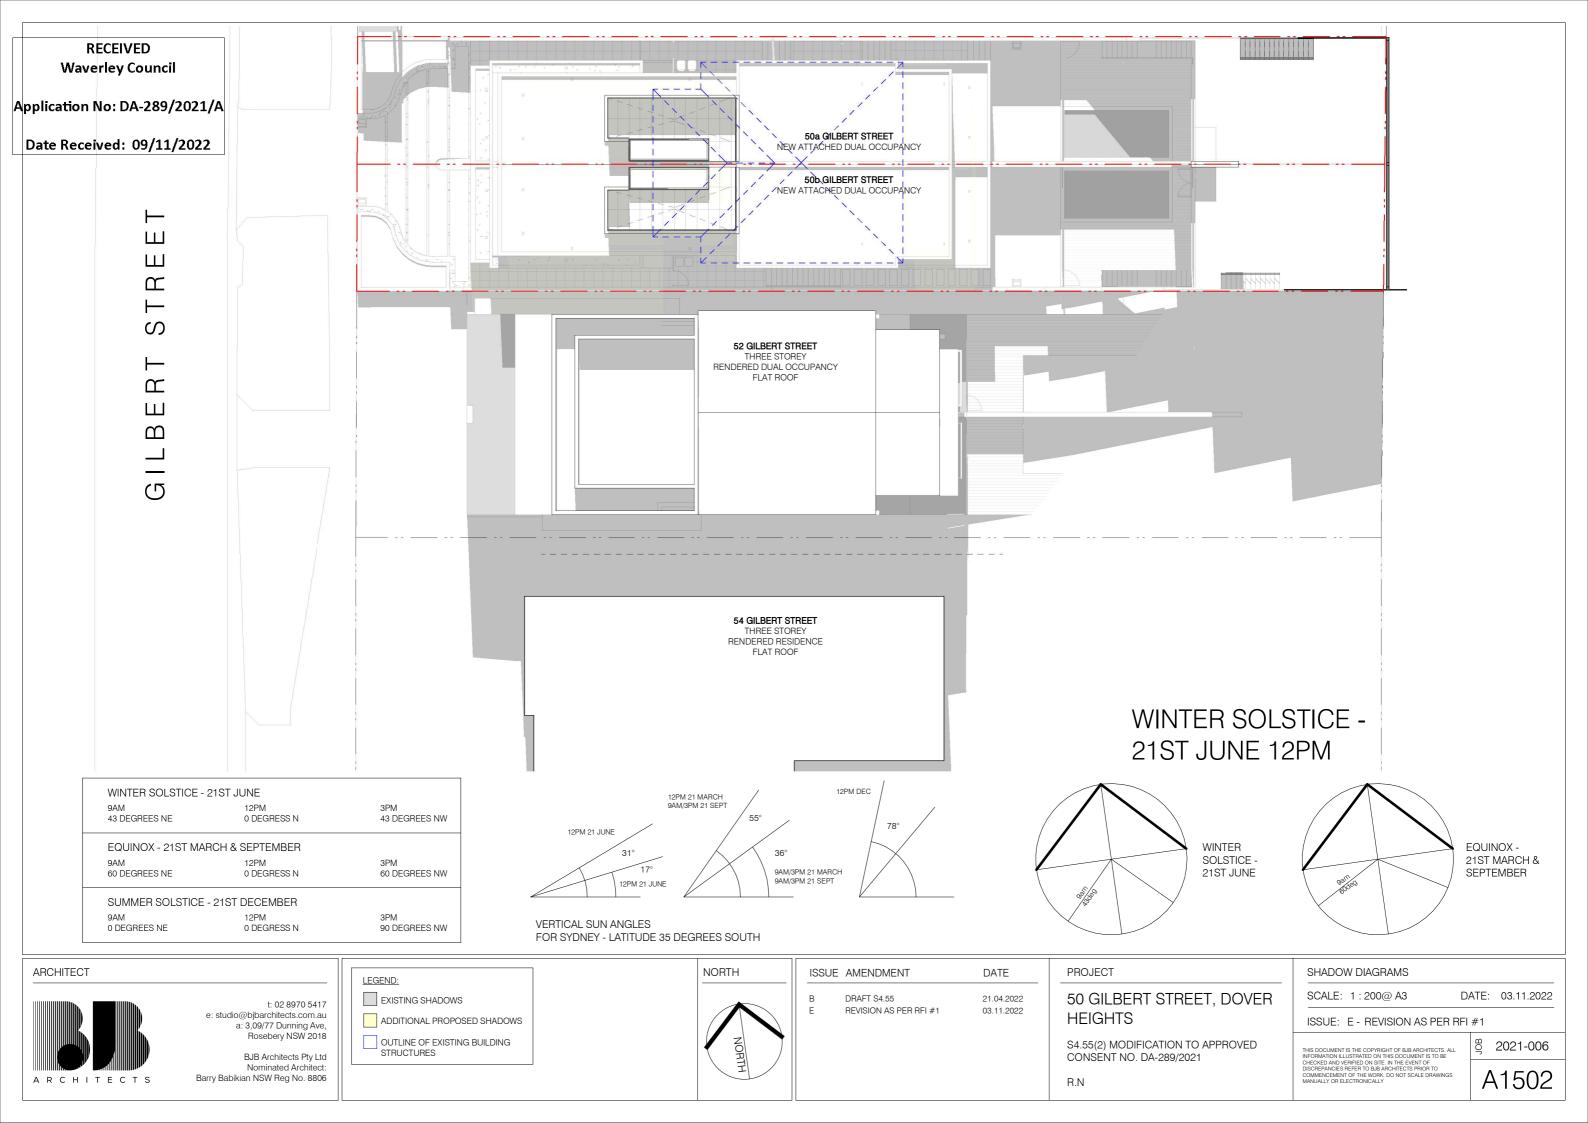

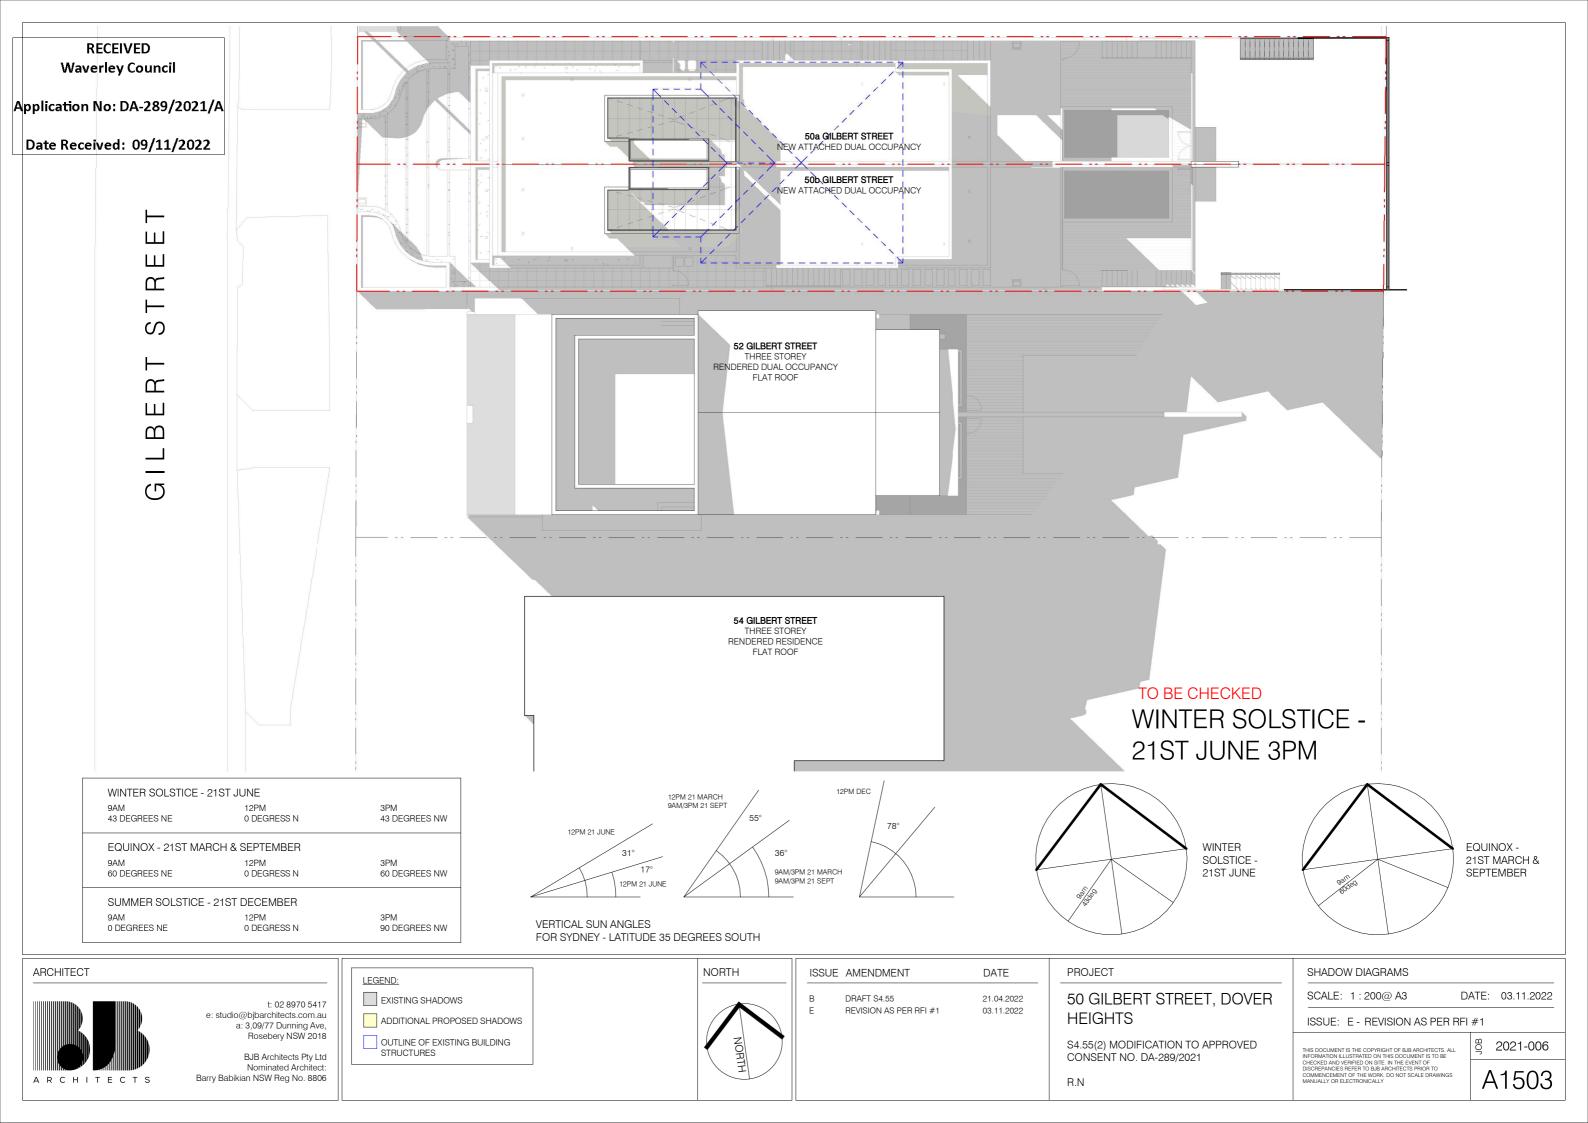

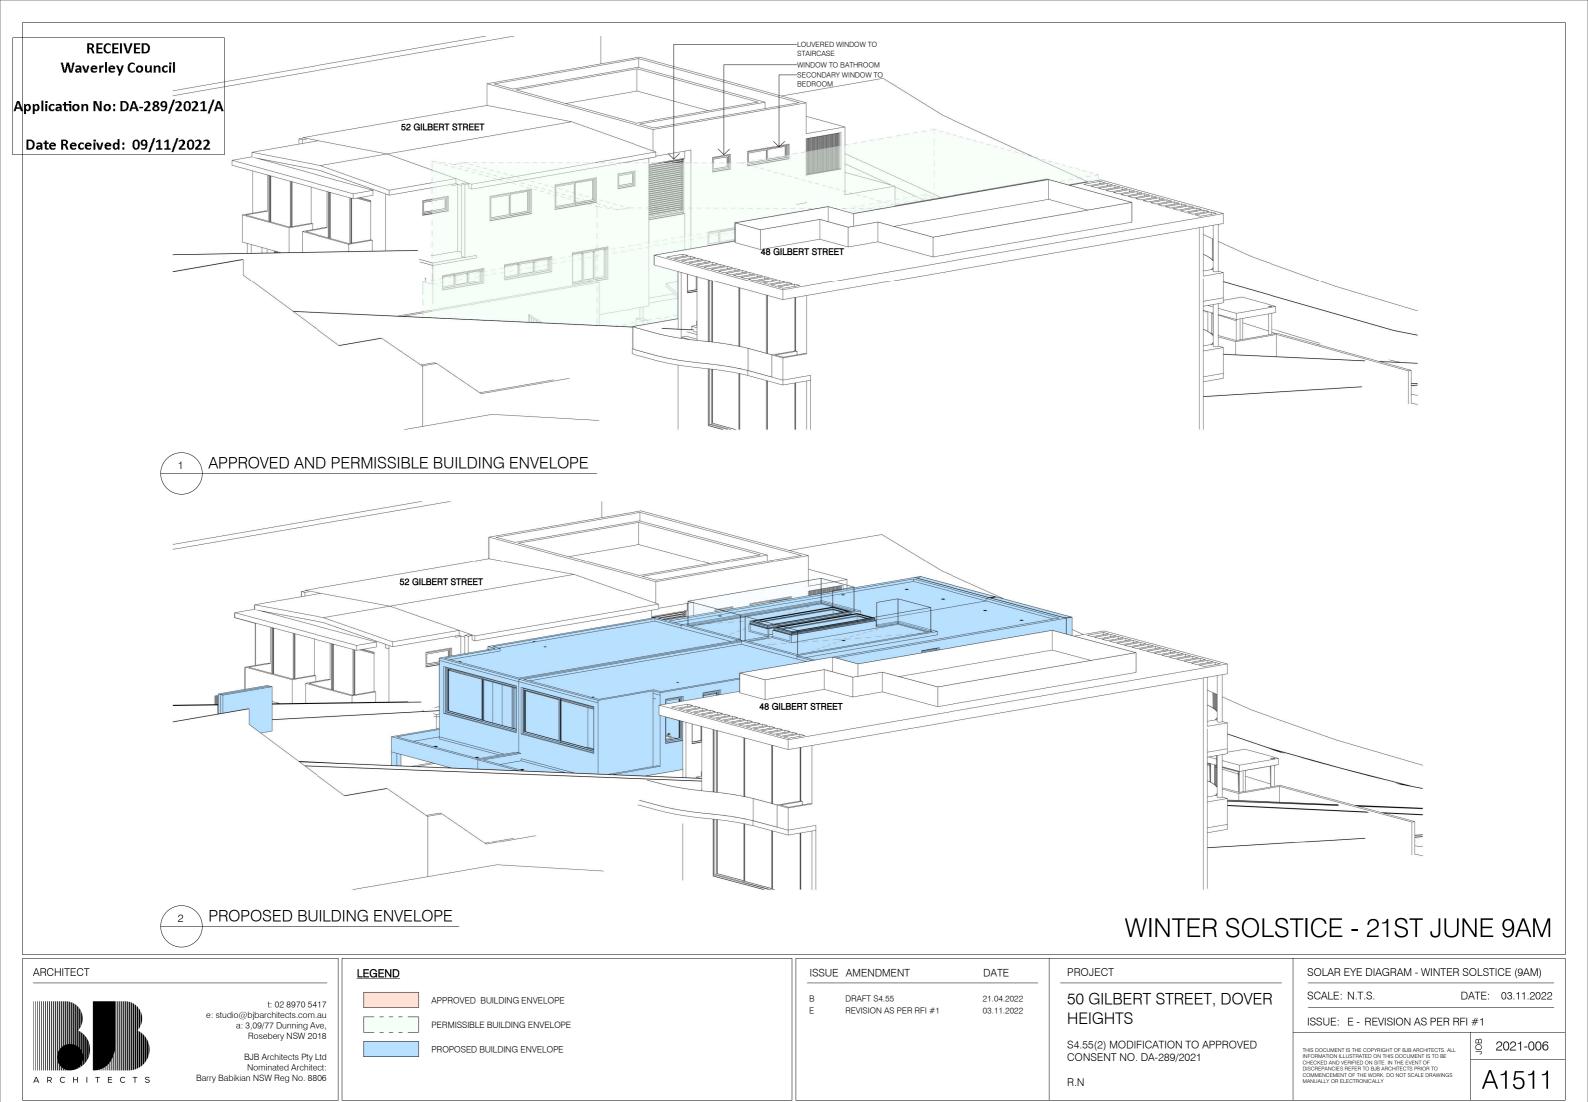

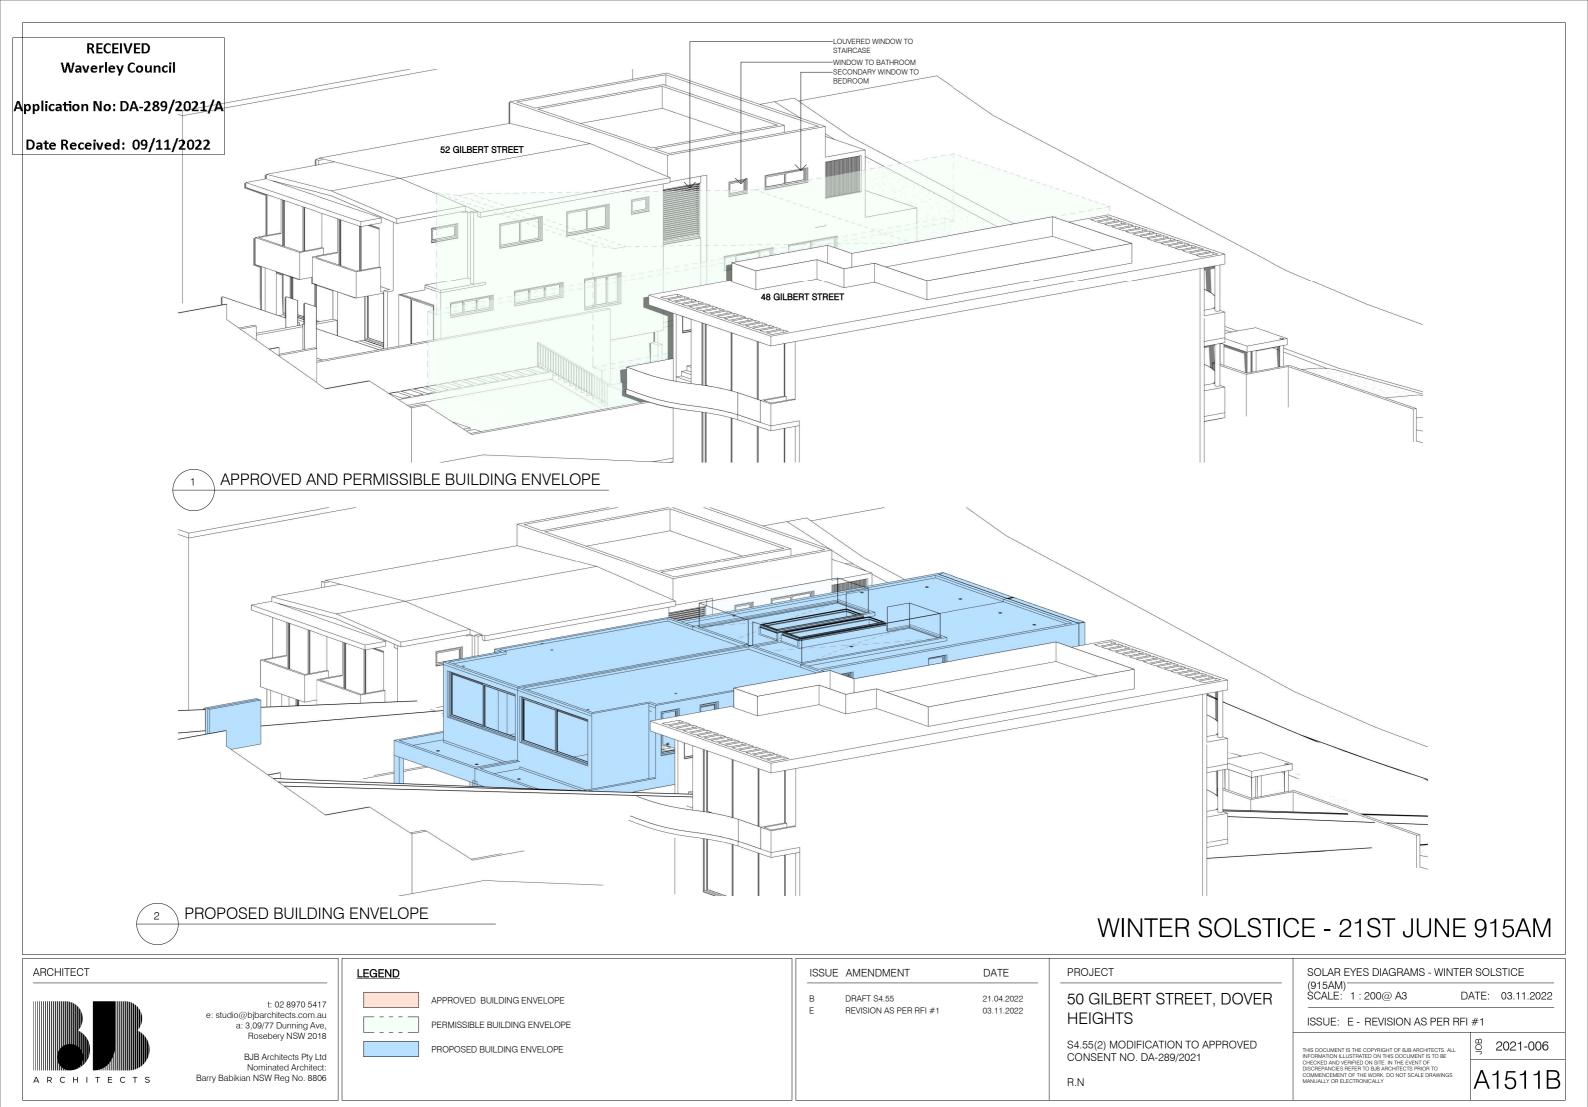


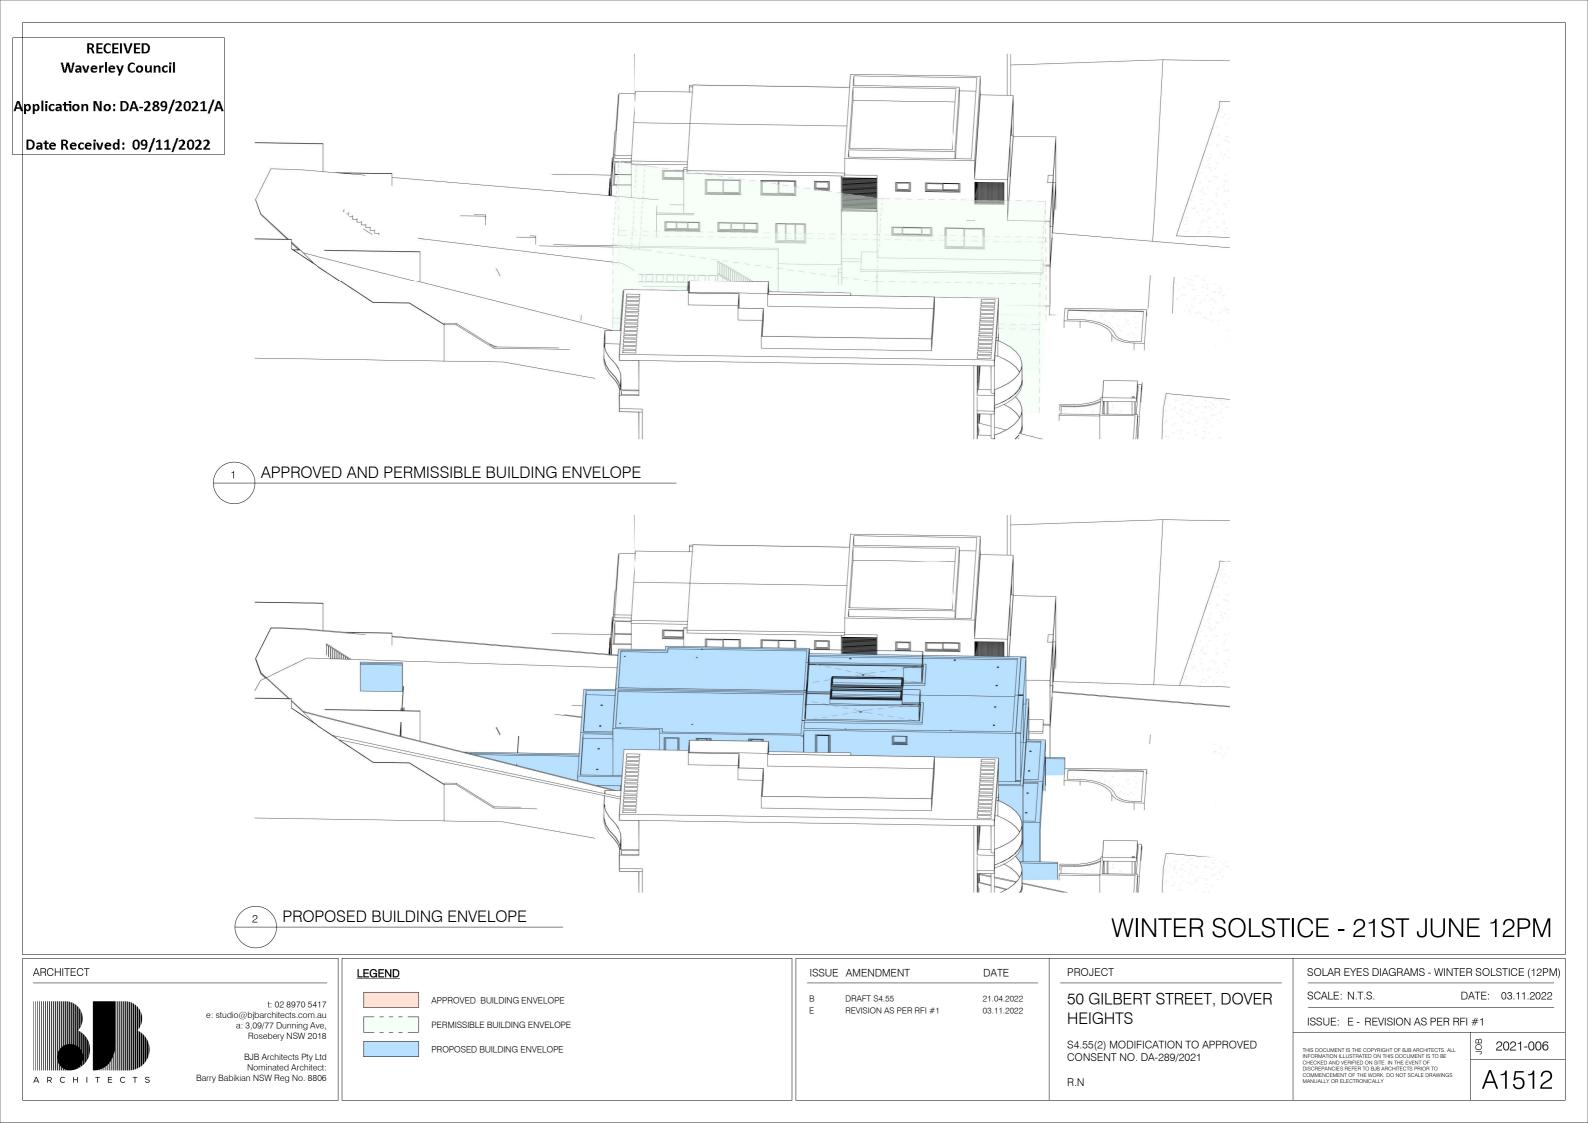


RECEIVED Waverley Council

Application No: DA-289/2021/A

Date Received: 09/11/2022

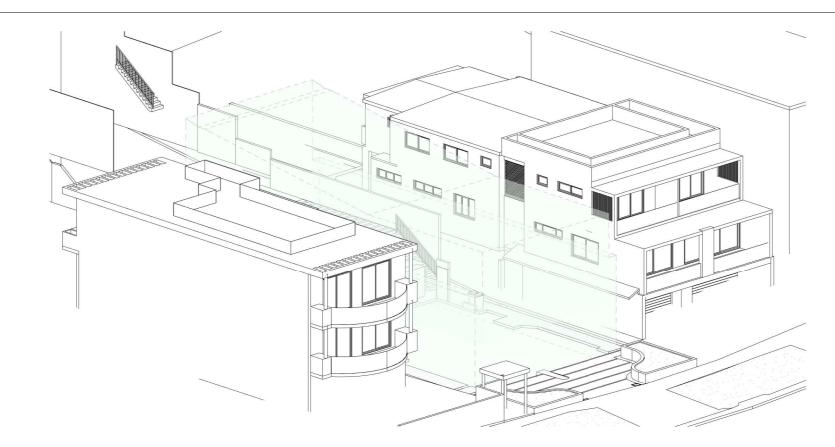



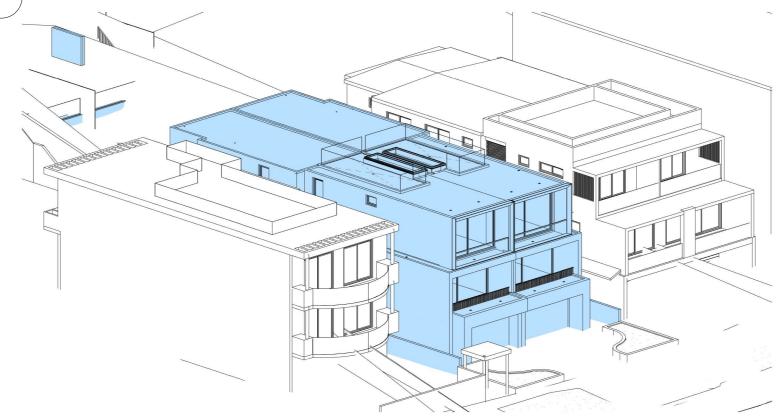

PROPOSED BUILDING ENVELOPE

WINTER SOLSTICE - 21ST JUNE 3PM

ARCHITECT



t: 02 8970 5417 e: studio@bjbarchitects.com.au a: 3,09/77 Dunning Ave, Rosebery NSW 2018

BJB Architects Pty Ltd Nominated Architect: Barry Babikian NSW Reg No. 8806

LEGEND

APPROVED BUILDING ENVELOPE



PERMISSIBLE BUILDING ENVELOPE



PROPOSED BUILDING ENVELOPE

ISSUE	AMENDMENT	DATE
В	DRAFT S4.55	21.04.202
E	REVISION AS PER RFI #1	03.11.202

PROJECT

50 GILBERT STREET, DOVER **HEIGHTS**

S4.55(2) MODIFICATION TO APPROVED

CONSENT NO. DA-289/2021

SOLAR EYES DIAGRAMS - WINTER SOLSTICE (3PM)

SCALE: N.T.S. DATE: 03.11.2022

ISSUE: E - REVISION AS PER RFI #1

2021-006 A1513





Report to Waverley Local Planning Panel

Application number	DA-296/2022	
Site address	16 Rawson Avenue, Queens Park	
Proposal	Alterations and additions to dwelling including new garage with roof terrace at the rear.	
Date of lodgement	15 July 2022	
Owner	Mr I W Beinart and Ms S H Beinart	
Applicant	DRE Design	
Submissions	Nil	
Cost of works	\$101,750.00	
Breach of FSR development standard Principal Issues Privacy Lack of landscaped area		
Recommendation	That the application be APPROVED in accordance with the conditions contained in the report.	

SITE MAP



1. PREAMBLE

1.1. Executive Summary

The development application seeks consent for alterations and additions to dwelling including new garage with roof terrace at the rear at the site known as 16 Rawson Street, Queens Park.

The principal issues arising from the assessment of the application are as follows:

- breach of FSR development standard
- privacy
- lack of landscaped area.

The assessment finds these issues acceptable for the reasons outlined within this report.

No neighbouring or Councillor submissions were received.

The application has been assessed against the relevant matters for consideration under section 4.15(1) of the *Environmental Planning and Assessment Act 1979*. It is recommended for approval subject to conditions of consent.

1.2. Site and Surrounding Locality

A site visit was carried out on 1 December 2022.

The site is identified as Lot 88 in DP 4042 known as 16 Rawson Avenue, Queens Park.

The site is rectangular in shape with a frontage of 6.095m to Rawson Avenue, and 6.095m to Rawson Lane at the rear. It has an area of 152m² and falls from the front towards the rear by approximately 2m.

The site is occupied by a two-storey attached dwelling (terrace) with secondary access provided from Rawson Lane at the rear.

The site is adjoined by two-storey attached dwellings (terraces) on either side. The locality is characterised by a variety of low density residential developments.

Figures 1 to 6 are photos of the site and its context.



Figure 1: Rear of the site facing south



Figure 2: Rear of the site facing north



Figure 3: View of 18 Rawson Street over the southern boundary



Figure 4: Rear of the subject site and 14 Rawson Street over northern boundary



Figure 5: Rear of the dwelling facing west



Figure 6: Rear of the site from Rawson Lane facing west

1.3. Relevant Development History

A search of Council's records revealed the following recent and relevant development history of the site:

- On 12 July 2001, Development Application L208/2001 was granted consent for refurbishment of the living space, kitchen, bathrooms and creation of an additional car space.
- On 5 June 2012, Development Application DA-580/2011 was granted consent for alterations and additions including a first floor addition to the dwelling.

1.4. Proposal

The development application seeks consent for alterations and additions to an attached dwelling and specifically includes:

- Demolition of the existing rear deck and garage.
- Construction of a new single car garage with storage, a sink and stairs to the rear patio.
- New rear patio.
- Rooftop terrace over the garage with planter boxes.
- Privacy screen on southern boundary.
- Replacement of window W01 to the ground floor eastern façade.
- New bi-fold doors to ground floor eastern façade.
- Landscaping.

1.5. Background

The following background is relevant to the proposal:

- On 15 July 2022, the subject development application (DA-296/2022) was lodged with Council.
- On 4 August 2022, a Stop the Clock letter was issued to the applicant requesting amended plans to address concerns raised in relation to the internal dimensions of the garage, privacy, and insufficient plan details and documentation.
- On 15 August 2022, the applicant submitted amended plans.
- On 18 August 2022, further amended plans were requested as the plans submitted did not fully address the amendments requested.
- On 9 September 2022, the applicant submitted amended plans. The amended plans form the basis
 of this assessment.
- On 16 January 2023, a deferral letter was issued to the applicant requesting a Clause 4.6 Variation Request to justify the proposed breach of the FSR development standard and amended plans detailing amendments to address concerns relating to privacy.
- On 23 January 2023, the applicant submitted amended plans and documentation.
- On 1 February 2023, an amended Clause 4.6 Variation Request was requested.
- On 2 February 2023, the applicant submitted an amended Clause 4.6.

2. ASSESSMENT

The following matters are to be considered in the assessment of this development application under section 4.15 of the *Environmental Planning and Assessment Act 1979* (the Act).

2.1. Planning Instruments and Development Control Plans

The following is an assessment against relevant legislation, environmental planning instruments, including State environmental planning policies (SEPPs), and development control plans.

2.1.1. State Environmental Planning Policies (SEPPs)

The following SEPPs apply from 1 March 2022 and have been considered acceptable in the assessment of this development application:

- SEPP (Building Sustainability Index BASIX) 2004
- SEPP (Transport and Infrastructure) 2021
- SEPP (Biodiversity and Conservation) 2021

State Environmental Planning Policy (Transport and Infrastructure) 2021.

The application was referred to Ausgrid for comment in accordance with Clause 2.48 of *State Environmental Planning Policy (Transport and Infrastructure) 2021* as the proposal includes development within 5m of an exposed overhead electricity power line.

Ausgrid raised no objection to the proposal. Refer to section 3.5 for Ausgrid's comments.

2.1.2. Waverley Local Environmental Plan 2012 (Waverley LEP 2012)

The relevant matters to be considered under the Waverley LEP 2012 are outlined below:

Table 1: Waverley LEP 2012 Compliance Table

Provision	Compliance	Comment		
Part 1 Preliminary				
1.2 Aims of plan	Yes	The proposal satisfies the aims of WLEP 2012.		
Part 2 Permitted or prohibited development				
Land Use Table R2 Low Density Residential Zone	Yes	The proposal is defined as ancillary to an attached dwelling and is permitted with consent in the R2 zone.		

Part 4 Principal development standards				
4.3 Height of buildings • 8.5m	Yes	The proposal has a height of 3.4m.		
 4.4 Floor space ratio and 4.4A Exceptions to floor space ratio 0.9378:1 or 142.54m² 	No	The proposal has an FSR of 1.03:1 or 156.9m ² exceeding the development standard by 14.36m ² or 10.07%.		
Part 5 Miscellaneous provisions				
5.10 Heritage conservation	Yes	The site is identified as being located within the Queens Park Heritage Conservation Area (C14). The proposal will not result in any adverse impacts on the setting or context of the conservation area.		
Part 6 Additional local provisions				
6.2 Earthworks	Yes	The proposal does not include any significant earthwork which would result in adverse impacts to the surrounding environment.		

The following is a detailed discussion of the issues identified in the compliance table above in relation to the Waverley LEP 2012.

Clause 4.6 Exceptions to Development Standards

The application seeks to vary the floor space ratio (FSR) development standard in clause 4.4 under Waverley LEP 2012.

The site is subject to a maximum floor space ratio development standard of 0.9378:1. The assessment has found the existing site to comprise an FSR of 0.9967:1 or 151.5m² representing a 6.28% variation.

The proposed development has an FSR of 1.03:1 or 156.9m², exceeding the standard by 14.36m² equating to a 10.07% variation. The subject proposal equates to an additional 5.4m² of GFA.

A written request has been submitted to Council in accordance with clause 4.6(3)(a) and (b) of Waverley LEP 2012 seeking to justify the contravention of the development standard by demonstrating:

- (a) That compliance with the development standard is unreasonable or unnecessary in the circumstances of the case; and
- (b) That there are sufficient environmental planning grounds to justify contravening the standard.

A copy of the applicant's written request has been provided to the Waverley Local Planning Panel for consideration.

Applicant's Written Request - Clause 4.6(3)(a) and (b)

The applicant seeks to justify the contravention of the FSR development standard on the following basis:

- (a) That compliance with the development standard is unreasonable or unnecessary in the circumstances of the case:
 - (i) The proposal satisfies the objectives of the floor space control (Clause 4.4) and the R2 zone under WLEP.
 - (ii) The proposal is consistent with the existing bulk of existing and new developments in the street and immediate locality.
 - (iii) The additional space created by the proposed works is minor and small-scale.
 - (iv) The development has been sensitively designed so as not to create any adverse amenity impacts.
 - (v) The building footprint is the same as the existing building onsite and the proposed building footprint is reflective and generally consistent with other developments in the street and locality.
 - (vi) The height, scale and form of the garage structure and terrace area is consistent with other existing and adjoining garage structures and built forms along the rear lane.
 - (vii) There is no additional bulk created by the additional floor space area which is within the structure and will not be visible externally from the street or laneway.
 - (viii) The terrace will provide for planter boxes around the perimeter and will soften the appearance of the area when viewed from the laneway.
- (b) That there are sufficient environmental planning grounds to justify contravening the standard:
 - (i) The proposal will provide a consistent built form outcome that satisfies the WDCP 2012 objectives and controls for ancillary structures and developments adjacent to laneways.
 - (ii) The additional floor space is considered to be minor and small scale in nature.
 - (iii) The additional floor space will not affect the public domain and will not be visible from the street, laneway or adjoining developments and will not affect the amenity of neighbouring properties ie, overlooking, overshadowing or impact on view loss.
 - (iv) The proposal is compliant with all the key statutory planning controls and will not affect the overall height, scale and bulk of the existing dwelling.

Consideration of Applicant's Written Request - Clause 4.6(4) (a) (i) and (ii)

Development consent must not be granted unless the consent authority is satisfied that:

(a) The applicant's written request has adequately addressed the matters required to be demonstrated by subclause 3 of clause 4.6 being that compliance with the development standard is unreasonable or unnecessary in the circumstances of the case, and that there are sufficient environmental planning grounds to justify contravening the standard; and

(b) The proposed development will be in the public interest because it is consistent with the objectives of the particular development standard and the objectives for development within the zone in which the development is proposed to be carried out.

Does the written request adequately address those issues at clause 4.6(3)(a)?

It is considered that the applicant has adequately addressed that compliance with the standard is unreasonable or unnecessary in the circumstances of the case and has referenced one or more of the following justifications as set out in *Wehbe v Pittwater Council* (2007) 156 LGERA 446:

- (a) the objectives of the development standard are achieved notwithstanding non-compliance with the standard;
- (b) to establish that the underlying objective or purpose is not relevant to the development with the consequence that compliance is unnecessary;
- (c) to establish that the underlying objective or purpose would be defeated or thwarted if compliance was required with the consequence that compliance is unreasonable;
- (d) to establish that the development standard has been virtually abandoned or destroyed by the Council's own actions in granting consents departing from the standard and hence compliance with the standard is unnecessary and unreasonable; and
- (e) to establish that "the zoning of particular land" was "unreasonable or inappropriate" so that "a development standard appropriate for that zoning was also unreasonable or unnecessary as it applied to that land" and that "compliance with the standard in that case would also be unreasonable or unnecessary.

The applicant specifically relies upon justification (a) outlined above to address clause 4.6(3)(a) of Waverley LEP 2012.

The proposal will satisfy the objectives of the zone and the FSR development standard and will not be of an unreasonable or incompatible bulk and scale when viewed from neighbouring properties or the streetscape. The area of additional calculable floor space is considered to be minor and will not result in any significant additional bulk or change within the streetscape.

Does the written request adequately address those issues at clause 4.6(3)(b)?

The applicant has adequately addressed that there are sufficient environmental planning grounds to justify contravening the development standard. The proposal will be in keeping with the context of the locality and will not result in adverse impacts on the amenity of the streetscape or neighbouring properties with regard to bulk and scale, overshadowing or views.

Is the development in the public interest?

The proposed development will be in the public interest because it is consistent with both the objectives of the particular development standard and the objectives for development within the zone in which the development is proposed to be carried out.

The objectives of the FSR development standard are as follows:

- (a) to ensure sufficient floor space can be accommodated within the Bondi Junction Centre to meet foreseeable future needs,
- (b) to provide an appropriate correlation between maximum building heights and density controls,
- (c) to ensure that buildings are compatible with the bulk and scale of the desired future character of the locality,
- (d) to establish limitations on the overall scale of development to preserve the environmental amenity of neighbouring properties and the locality.

The proposal will not be incompatible with the built form and scale of developments within the locality and will not result in adverse impacts on the streetscape or neighbouring properties with regard to bulk and scale, overshadowing or views.

The objectives of the R2 Low Density Residential zone are as follows:

- To provide for the housing needs of the community within a low density residential environment.
- To enable other land uses that provide facilities or services to meet the day to day needs of residents.
- To maximise public transport patronage and encourage walking and cycling.
- To ensure dwelling character, landscape character, neighbourhood character, streetscapes and amenity are maintained or enhanced over time.
- To encourage the supply of housing that meets the needs of the population, particularly housing for older people and people with disability.
- To promote development that incorporates planning and design measures that reduce the urban heat island effect.
- To improve the urban tree canopy by providing high levels of deep soil planting and additional landscaping.

The proposal will provide for the housing needs of the community within the low density residential environment. The proposal will be in keeping with the character of the locality and will not result in adverse impacts on residential amenity.

Conclusion

For the reasons provided above the requested variation to the FSR development standard is supported as the applicant's written request has adequately addressed the matters required to be addressed by clause 4.6 of the Waverley LEP 2012 and the proposed development would be in the public interest because it is consistent with the objectives of FSR development standard and the R2 zone.

2.1.3. Waverley Development Control Plan 2012 (Waverley DCP 2012) - Amendment No.9

The relevant matters to be considered under the Waverley DCP 2012 are outlined below:

Table 2: Waverley DCP 2012 – Part B General Provisions Compliance Table

Development Control	Compliance	Comment
1. Waste	Yes	Satisfactory.
Ecologically Sustainable Development	Yes	Satisfactory.
3. Landscaping and Biodiversity	No	The proposal does not satisfy the minimum landscaped area requirements, however a greater provision of landscaping will be required by condition (detailed later in this report) which will serve to improve privacy, soften the built form and positively contribute to the landscaped amenity of the locality.
6. Stormwater	Yes	Satisfactory.
 8. Transport Maximum parking rate: 1 space for 2 or less bedrooms 2 spaces for 3 or more bedrooms. 	Yes	The proposal provides for 1 car space. The design and location are satisfactory given the site constraints and surrounding development context.
9. Heritage	Yes	Satisfactory. Council's Heritage Advisor has reviewed the proposal and raised no objection on heritage grounds. The works are located at the rear of the site and will not result in any adverse impacts to the setting or context of the heritage conservation area.
10. Safety	Yes	Satisfactory.
12. Design Excellence	Yes	Satisfactory.
14. Excavation	Yes	Satisfactory.
16. Public Domain	Yes	Satisfactory.

Table 3: Waverley DCP 2012 – Part C2 Low Density Residential Development Compliance Table

Development Control	Compliance	Comment
2.0 General Objectives		
	Yes	The proposal does not contravene the general objectives of this part of the DCP.
2.2 Setbacks		
 2.2.1 Front and rear building lines Predominant front building line Predominant rear building line at each floor level 	Yes	The proposal does not include any changes to the front or rear building alignment.
2.2.2 Side setbacksMinimum of 0.9m (for height up to 8.5m)	No	The proposal includes a nil setback from the side boundaries which does not comply with the 900mm minimum setback requirement. Nil setbacks are however considered appropriate within the context of the site.
2.3 Streetscape and visual imp	act	
 New development to be compatible with streetscape context Significant landscaping to be maintained. 	Yes	The proposal will predominantly maintain the existing built form as viewed from the streetscape and will not be out of character with the context of the locality which comprises a variety of double width garages with terraces and landscaping above. Landscaping will be removed as part of the proposal, however new planting will be provided by way of landscaped perimeter planters which will serve to soften the built form as viewed from neighbouring properties and the streetscape.
2.4 Fences		
 Front: Maximum height of 1.2m Solid section no more than 0.6m high Side and Rear: Maximum height of 1.8m 	No	The proposal includes an increase to the height of the fence/wall along both side boundaries to greater than 1.8m in height. High boundary walls at the rear are not uncommon within the locality due to the provision of boundary-to-boundary garages with terraces above. The proposal will not result in adverse impacts on the neighbouring properties with regard to overshadowing and no submissions were received raising concerns in relation to the height of the fencing/walls proposed. The proposal is not considered to be unreasonable.

2.5 Visual and acoustic privacy

- Habitable windows are not to directly face habitable windows or open space of neighbouring dwellings unless direct views are screened or other appropriate measures are incorporated into the design
- External stairs are not acceptable.
- Maximum size of balconies: 10m² in area 1.5m deep
- Roof tops to be nontrafficable unless predominant in the immediate vicinity

No

The assessment has found that the terrace proposed over the roof of the garage would enable overlooking of the neighbouring properties habitable room windows and private open space.

During the assessment (at the request of Council), amended plans were provided which detail an increase to the width of the planter box along the northern boundary in order to enable mature landscaping to be provided and maintained for privacy screening. Landscaping to a minimum mature height of 1.6m was requested. The amended plans however detail landscaping to a mature height of 1.5 which would not maintain an adequate level of privacy. A condition of consent has therefore been included requiring landscaping to a minimum mature height of 1.6m.

Plans detailing a planter box along the southern side of the terrace, north of the stairs, were also requested. The applicant refrained from doing so on the basis that in their opinion the privacy screen proposed along the southern boundary would be sufficient, and the landscaping would limit solar access into the subject dwelling.

The assessment has found that the privacy screen along the common boundary would minimise downward views however, would not prevent direct sightlines into the first floor bedroom and adjoining balcony of the property neighbouring to the south at 18 Rawson Street.

In accordance with control (e), where an elevated deck is proposed, it is to have a maximum area of $10m^2$, and a maximum depth of 1.5m. The proposed deck currently comprises an area of $15.33m^2$ and a depth of 4.8m and therefore exceeds the control. To minimise the size of the deck so that it is more in keeping with the requirements of control (e) and to ensure adequate privacy is maintained, a condition of consent has been included which requires a planter box to be provided along the southern side of the deck with either a privacy screen or landscaping up to 1.6m to be provided.

		As conditioned, the proposal will maintain an adequate level of privacy.
2.6 Solar access		
 Minimum of three hours of sunlight to living areas and principal open space areas on 21 June Minimum of three hours of sunlight maintained to at least 50% I of principal open space areas of adjoining properties on 21 June. Avoid unreasonably overshadowing of solar collectors (including habitable windows). 	Yes	The proposal will not result in any adverse overshadowing impact on the neighbouring properties.
2.7 Views		
 Views from the public domain are to be maintained Development to be designed and sited so as to enable a sharing of views with surrounding dwellings particularly from habitable rooms and decks. 	Yes	The proposal will not result in any impact on public or private views.
2.8 Car parking		
 2.8.1 Design Approach Parking only allowed where site conditions permit Designed to complement the building and streetscape Car parking structures to be behind the front building line Driveways are to be located to minimise the loss of on street parking Parking to be provided from secondary streets or lanes where possible. 	Yes	On-site parking provided via the rear lane is in line with Council's preferred car parking hierarchy and the context of the locality. The design and built form of the proposal will be compatible with the character of the streetscape.
2.8.2 Parking rates	Yes	The proposal complies with the parking rates are set out under Part B8 of DCP 2012.

 2.8.3 Location Behind front building line for new dwellings Existing development to be in accordance with the hierarchy of preferred car parking locations 	Yes	The proposal will provide parking at the rear via Rawson Lane which is in accordance with the preferred parking hierarchy.
 2.8.4 Design Complement the style, massing and detail of the dwelling Secondary in area and appearance to the design of the residences No part of the façade is to be demolished to accommodate car parking Gates to have an open design 	Yes	The design of the garage is in keeping with the existing dwelling and the context of the streetscape.
2.8.5 Dimensions5.4m x 2.4m per vehicle	Yes	The proposal complies with the minimum dimensions for a single car parking space.
 2.8.6 Driveways Maximum of one per property Maximum width of 3m at the gutter (excluding splay) Crossings not permitted where 2 on street spaces are lost 	Yes	A single driveway at the rear of the property is proposed. The driveway exceeds the 3m maximum width requirement, however is acceptable as the driveway is existing and provides for reasonable manoeuvrability within the laneway.
2.9 Landscaping and open space	ce	
 Overall open space: 40% of site area Overall landscaped area: 15% of site area Outdoor clothes drying area to be provided 	No	Due to the existing site constraints, the proposal does not provide a minimum of 40% of the site as open space. The proposal will however maintain a provision of open space which is generally consistent with the existing provision of open space on the site.
		The proposal will result in the removal of the only existing area of landscaping currently provided within the site. Whilst this is highly undesirable, the constraints of the site have been considered. The landscaping proposed is not calculable as landscaped area in accordance with the WLEP 2012 landscaped area definition given it is contained within planters, however will contribute to the landscaped amenity of the

		locality, whilst also serving to provide privacy and to visually soften the built form as viewed from neighbouring properties and the streetscape.
2.13 Semi-detached dwellings a	and terrace styl	e development
 2.13.1 - Built form Additions to match the style of the original semidetached dwelling 	Yes	The proposal will read as a cohesive part of the existing dwelling.
 2.13.3 - Material finishes and detail for semi-detached dwellings Finishes and detailing are to be cohesive with the existing dwelling New windows to have a similar proportion to the existing 	Yes	The design and materials proposed will be compatible with existing dwelling and surrounding developments.
2.14 Dual Frontage Developmen	nt	
 2.14.1 - General Controls Primary and secondary frontage to be defined Appropriate forms to be provided to each street Privacy treatments to be provided for first floors above garages Pedestrian pass door provided for single width garage doors Garage studios and rear lane garage develops are to be provided with landscaping 	Yes	The landscaping proposed will soften the built form and enhance the amenity of the streetscape. A combination of privacy screens, landscaping and setbacks will serve to minimise privacy impacts as a result of the proposed elevated terrace.
 2.14.2 - Laneway Design Provisions Maximum external wall height of 3.6m Maximum overall height of 6m to the roof ridge Landscape character of the lane maintained External stairs not acceptable 	Yes	The height of the proposal will be generally consistent with the height of the existing garage, and less than 3.6m in height along the rear boundary. The flat roofed design will be compatible with the character of the laneway streetscape and will minimise impacts on the streetscape and neighbouring properties with regard to bulk and scale and overshadowing. Planting along the perimeter of the proposed terrace will positively contribute to the character of the laneway, whilst serving to minimise impacts on amenity. The external stairs will not be visible from the streetscape. Landscaping and the privacy screen proposed on the southern boundary will serve to

		minimise impacts on the privacy of the neighbouring property. The design and style of the proposal will be compatible with the existing dwelling
 2.14.3 Development in Heritage Conservation areas Single width garages or double with central divide Finishes and proportions to match the traditional construction in the area Overlooking to be mitigated Yard areas not to be roofed Box gutters on side boundaries to be avoided. 	Yes	The site is identified as being located within the Queens Park Conservation Area (C14). The proposal comprises works at the rear of the site only, adjacent the rear lane which is not considered to comprise the key heritage aspects of the conservation area. Council's Heritage Advisor has reviewed the proposal and raised no objection on heritage grounds. The proposal will not result in any adverse impacts on the setting, character or significance of the heritage conservation area.

2.2. Other Impacts of the Development

The proposal is considered to have no significant detrimental effect relating to environmental, social or economic impacts on the locality, subject to appropriate conditions being imposed.

2.3. Suitability of the Site for the Development

The site is considered suitable for the proposal.

2.4. Any Submissions

The application was notified for 14 days between 4 and 18 August 2022 in accordance with the *Waverley Community Development Participation and Consultation Plan*.

Following receipt of amended plans and additional information, the application was not re-notified as the proposal did not include any new or additional impacts on the neighbouring properties.

No submissions were received.

2.5. Public Interest

The proposal is considered to have no detrimental effect on the public interest, subject to appropriate conditions being imposed.

3. REFERRALS

The following internal and external referral comments were sought:

3.1. Traffic and Development

Council's Traffic Department raised no objection to the proposal subject to conditions.

3.2. Stormwater

Council's Stormwater Engineering Department raised no objection to the proposal subject to conditions.

3.3. Public Domain

Council's Public Domain Department reviewed the proposal and raised no objection on the grounds that the existing encroachment on Council land will be removed as a result of the proposal.

3.4. Heritage

Council's Heritage Advisor raised no objection to the proposal on heritage grounds.

3.5. Ausgrid

Ausgrid reviewed the proposal and provided the following comment:

Ausgrid does not object to the proposed development.

The applicant/developer should note the following comments below regarding any proposal within the proximity of existing electrical network assets.

Ausgrid Overhead Powerlines are in the vicinity of the development

The developer should refer to SafeWork NSW Document – Work Near Overhead Powerlines: Code of Practice. This document outlines the minimum separation requirements between electrical mains (overhead wires) and structures within the development site throughout the construction process. It is a statutory requirement that these distances be maintained throughout the construction phase.

Consideration should be given to the positioning and operating of cranes, scaffolding, and sufficient clearances from all types of vehicles that are expected be entering and leaving the site.

The "as constructed" minimum clearances to the mains must also be maintained. These distances are outlined in the Ausgrid Network Standard, NS220 Overhead Design Manual. This document can be sourced from Ausgrid's website at www.ausgrid.com.au.

It is the responsibility of the developer to verify and maintain minimum clearances onsite. In the event where minimum safe clearances are not able to be met due to the design of the

development, the Ausgrid mains may need to be relocated in this instance. Any Ausgrid asset relocation works will be at the developer's cost.

Additional information can be found in the Ausgrid Quick Reference Guide for Safety Clearances "Working Near Ausgrid Assets - Clearances". This document can be found by visiting the following Ausgrid website:

www.ausgrid.com.au/Your-safety/Working-Safe/Clearance-enquiries.

Should you have any enquiries, please contact Ausgrid at development@ausgrid.com.au.

4. CONCLUSION

The application has been assessed against the relevant matters for consideration under section 4.15(1) of the Act. It is recommended for approval subject to conditions of consent.

5. RECOMMENDATION TO WAVERLEY LOCAL PLANNING PANEL

That the development application be APPROVED by the Waverley Local Planning Panel subject to the conditions in Appendix A.

Report prepared by:	Application reviewed by:
K.Keenan.	dance
Karis Keenan	Kylie Lucas
Senior Development Assessment Planner	A/Manager, Development Assessment
Date: 3 February 2023	Date: 08/02/2023

Reason for WLPP referral:

3. Departure from any development standard in an EPI by more than 10%

APPENDIX A – CONDITIONS OF CONSENT

A. APPROVED DEVELOPMENT

1. APPROVED PLANS AND DOCUMENTATION

The development must be in accordance with:

(a) Architectural Plans prepared by DRE Design of Project No: 0544 including the following:

Plan Number and	Plan description	Plan Date	Date received by
Revision			Council
DA003, Rev D	Existing / Demolition Plan	15 August 2022	17 August 2022
DA004, Rev D	Site and Roof Plan	15 August 2022	17 August 2022
DA101, Rev D	Lower Ground Floor and Ground	20 January 2023	23 January 2023
	Floor		
DA102, Rev D	Upper Ground Floor and First Floor	15 August 2022	17 August 2022
DA200, Rev D	Sections	15 August 2022	17 August 2022
DA301, Rev D	Elevations	15 August 2022	17 August 2022
DA302, Rev D	Elevations	15 August 2022	17 August 2022
DA500, Rev D	Windows and Doors Schedule	15 August 2022	17 August 2022
DA600, Rev D	Area Calculations and Materials	15 August 2022	17 August 2022

- (b) Landscape Plan DA700 Rev D prepared by DRE Design dated 20 January 2023 and received by Council on 23 January 2023.
- (c) BASIX Certificate A455466 dated 20 April 2022.
- (d) Stormwater Details and documentation prepared by Mesh Group P/L Hydraulic Services Consultant dated 30 March 2022 and received by Council on 15 July 2022.
- (e) Clause 4.6 Variation Request prepared by Larissa Ozog dated February 2023 and received by Council on 2 February 2023.
- (f) Heritage Impact Statement prepared by DRE Design dated 28 June 2022, Rev A and received by Council on 15 July 2022.
- (g) The Site Waste and Recycling Management Plan (SWRMP) Part 1.

Except where amended by the following conditions of consent.

2. GENERAL MODIFICATIONS

The application is approved subject to the following plan amendments;

(a) A planter box with a minimum internal width of 600mm is to be provided along the southern side of the terrace, north of the staircase. The planter box is to comprise landscaping with a minimum mature height of 1.6m above the finished floor level of the terrace or include a privacy screen which measures 1.6m in height above the finished floor level of the terrace, with vertical blades fixed at a 45 degree angle in a north-west, south-east direction. (b) The landscape plan is to be amended to detail the 1.5m minimum mature height landscaping relaced with landscaping to achieve a minimum mature height of 1.6m above the finished floor level of the terrace.

The amendments are to be approved by the **Principal Certifying Authority** prior to the issue of any Construction Certificate.

B. PRIOR TO THE ISSUE OF A CONSTRUCTION CERTIFICATE

The requirements outlined in this section are to be provided to the satisfaction of the Principal Certifying Authority in all instances, except where a condition explicitly specifies that the approval of Council or a Council Officer is required.

GENERAL REQUIREMENTS

3. NO BUILDING OR DEMOLITION WORKS PRIOR TO RELEASE OF CONSTRUCTION CERTIFICATE

The building work, or demolition work, must not be commenced until:

- (a) a Construction Certificate has been obtained from Council or an Accredited Certifier in accordance with the *Environmental Planning and Assessment Act 1979*;
- (b) a Principal Certifying Authority has been appointed and Council has been notified of the appointment in accordance with the *Environmental Planning and Assessment Act 1979* and *Environmental Planning and Assessment Regulation 2000*; and
- (c) Council is given at least two days' notice in writing of the intention to commence the building works.

4. HOME BUILDING ACT

The builder or person who does the residential building work shall comply with the applicable requirements of Part 6 of the *Home and Building Act 1989*. In this regard a person must not contract to do any residential building work unless a contract of insurance that complies with this Act is in force in relation to the proposed work. It is the responsibility of the builder or person who is to do the work to satisfy the Principal Certifying Authority that they have complied with the applicable requirements of Part 6, before any work commences.

CONTRIBUTIONS, FEES & BONDS

5. SECTION 7.12 CONTRIBUTION

A monetary development contribution is payable to Waverley Council pursuant to section 7.12 of the *Environmental Planning and Assessment Act 1979* and the Waverley Council Development Contributions Plan 2006 in accordance with the following:

- (a) A cost report indicating the itemised cost of the development shall be completed and submitted to Council:
 - (i) Where the total development cost is less than \$500,000:

"Waverley Council Cost Summary Report"; or,

(ii) Where the total development cost is \$500,000 or more: "Waverley Council Registered Quantity Surveyor's Detailed Cost Report".

A copy of the required format for the cost reports are provided in the Waverley Council Contributions Plan 2006, available on Council's website.

- (b) As legislated in section 25K of the Environmental Planning and Assessment Regulation 2000, the levy must be paid in accordance with the following;
 - (i) A development valued at \$100,000 or less will be exempt from the levy;
 - (ii) A development valued at \$100,001 \$200,000 will attract a levy of 0.5% of the full cost of the development; or
 - (iii) A development valued at \$200,001 or more will attract a levy of 1% of the <u>full</u> cost of the development.

Prior to the issue of any Construction Certificate, evidence must be provided that the levy has been paid to Council in accordance with this condition or that the cost of works is less than \$100,000.

6. SECURITY DEPOSIT

A deposit (cash or cheque) for the amount of \$3,800.00 must be provided to Council for any damage caused to any property of the consent authority (ie. public land) as a consequence of the works and completing any public work (such as road work, kerbing and guttering, footway construction, stormwater drainage and environmental controls) required in connection with the consent.

This deposit (cash or cheque) must be provided to Council prior to the issue of any Construction Certificate. The full amount of the deposit, minus Council's costs for any repair of damage to Council property or rectification of unauthorised works on Council property, will be refunded after satisfactory completion all of works associated with this consent (including the required public works) to the person who paid the deposit.

7. LONG SERVICE LEVY

A long service levy, as required under section 34 of the *Building and Construction Industry Long Service Payments Act, 1986*, is to be paid in respect of this building work. Evidence that the levy has been paid is to be submitted to the Principal Certifying Authority prior to the issue of any Construction Certificate.

<u>Note</u>: Council acts as an agent for the Long Service Payment Corporation and the levy may be paid at Council's office. The levy rate is 0.35% of building work costing \$25,000 or more.

CONSTRUCTION & SITE MATTERS

8. EROSION & SEDIMENT CONTROL

A Soil and Water Management Plan (SWMP), also known as an Erosion and Sediment Control Plan must be prepared in accordance with Waverley Council's Water Management Technical Manual.

The SWMP must be approved by the Principal Certifying Authority prior to the issue of a Construction Certificate. A copy of the SWMP must be kept on site at all times and made available to Council officers upon request.

The recommendations of the SWMP must be implemented and maintained during all construction activities and until the site is fully stabilised following construction.

9. ENGINEERING DETAILS

Structural details are to be prepared and certified by a practicing Structural Engineer in connection with all structural components of the approved works, prior to the issue of the relevant Construction Certificate.

TRAFFIC MANAGEMENT

10. CONSTRUCTION TRAFFIC MANAGEMENT PLAN (CTMP)

The applicant is to submit a Construction Traffic Management Plan (CTMP) for the approval of Council's Executive Manager, Infrastructure Services, or delegate, prior to the issue of any Construction Certificate. For further information on what is required in the CTMP, please refer to Council's website at:

https://www.waverley.nsw.gov.au/building/development_applications/post_determination/development_applications - conditions of consent

STORMWATER & FLOODING

11. STORMWATER AND PUBLIC INFRASTRUCTURE MANAGEMENT

The stormwater plans prepared by DRE DESIGN P/L, Job No. 3172, DWG STW-100, Issue A, dated 30/03/2022 has been checked and considered satisfactory with respect to Councils stormwater requirements.

To ensure the management of stormwater runoff from the development is undertaken without impact to the subject site, neighbouring properties or receiving drainage system, stormwater runoff from the development shall be collected and piped by gravity flow in accordance with Councils Stormwater Management Technical Manual.

Any affected Council's infrastructure as the result of construction activities within the public domain area, inclusive of stormwater, stormwater outlet/s, kerb and gutter, pavement, grass verges and vehicle crossovers within the extent works shall be replaced as per Waverley Council Public Domain Technical Manual.

ENERGY EFFICIENCY & SUSTAINABILITY

12. BASIX

All requirements of the BASIX Certificate and NatHERS documentation are to be shown on the Construction Certificate plans and documentation.

WASTE

13. SITE WASTE AND RECYCLING MANAGEMENT PLAN

A Site Waste and Recycling Management Plan (SWRMP) - Part 2 is to be submitted to the Principal Certifying Authority prior to the issue of the relevant Construction Certificate, which outlines materials to be reused and/or recycled as a result of demolition and construction works. At least one copy of the SWRMP Part 2 is to be available on site at all times during construction. Copies of demolition and construction waste dockets that verify the facility that received the material for recycling or disposal and the quantity of waste received, must be retained on site at all times during construction.

C. COMPLIANCE PRIOR TO WORK COMMENCING AND DURING CONSTRUCTION

The requirements outlined in this section are to be provided to the satisfaction of the Principal Certifying Authority in all instances, except where a condition explicitly specifies that the approval of Council or a Council Officer is required.

PRIOR TO ANY WORKS

14. CONSTRUCTION SIGNS

Prior to commencement of any works on the site and during construction a sign shall be erected on the main frontage of the site detailing the name, address and contact details (including a telephone number) of the Principal Certifying Authority and principal contractor (the coordinator of the building works). The sign shall be clearly legible from the adjoining street/public areas and maintained throughout the building works.

15. DILAPIDATION REPORT

A Dilapidation report is to be prepared for any adjoining or nearby property that may be subject to potential damage as a result of any works being undertaken. The dilapidation report is be made available to affected property owners.

The report is to be dated, submitted to, and accepted by the Principal Certifying Authority, prior to any work commencing on the site.

Note: Any damage that may be caused is a civil matter. This consent does not allow or authorise any party to cause damage, trespass, or any other unlawful act and Council will not be held responsible for any damage that may be caused to adjoining buildings as a consequence of the development being carried out. Council will not become directly involved in disputes between the builder, owner, developer, its contractors and the owners of neighbouring buildings.

DEMOLITION & EXCAVATION

16. CONTROL OF DUST ON CONSTRUCTION SITES

The following requirements apply to demolition and construction works on site:

(a) Hazardous dust is not to be allowed to escape from the site. The use of fine mesh dust proof screens or other measures are recommended. Any existing accumulations of dust (e.g. ceiling voids and wall

cavities) must be removed by the use of an industrial vacuum fitted with a high efficiency particle air (HEPA) filter. All dusty surfaces and dust created from work are to be suppressed by a fine water spray. Water must not be allowed to enter the street and stormwater systems. Demolition is not to be performed during adverse winds, which may cause dust to spread beyond the site boundaries.

(b) All contractors and employees directly involved in the removal of hazardous dusts and substances are to wear protective equipment conforming to Australian Standard AS1716 Respiratory Protective Devices.

17. CLASSIFICATION OF WASTE/ DISPOSAL OF EXCAVATED SOILS

Prior to the exportation of waste (including fill or soil) from the site the material must be classified in accordance with the provisions of the Protection of the Environment Operations Act, 1997 and the NSW EPA Waste Classification Guidelines 2014.

18. EXCAVATION AND BACKFILLING

All excavations and backfilling associated with the erection or demolition of a building must be executed safely and in accordance with the appropriate professional standards and must be properly guarded and protected to prevent them from being dangerous to life or property.

If an excavation associated with the erection or demolition or a building extends below the level of the footings of a building on an adjoining allotment of land, the excavation is to be managed by a practising structural engineer.

CONSTRUCTION MATTERS

19. CONSTRUCTION HOURS

Demolition and building work must only be undertaken between the hours of 7am and 5pm on Mondays to Fridays and 8am to 3pm on Saturdays, with no work to be carried out on Sundays and public holidays.

Excavation works involving the use of heavy earth movement equipment, including rock breakers and the like, must only be undertaken between the hours of 7am and 5pm on Mondays to Fridays, with no such work to be carried out on Saturday, Sunday or a public holiday.

Noise from construction activities shall comply with the Protection of the Environmental Operations (Noise Control) Regulation 2017.

20. STOCKPILES, STORAGE OF MATERIALS AND LOCATION OF BUILDING OPERATIONS

All building materials and any other items associated with the development are to be stored within the property. No materials are to be stored on Council's footpath, nature strip, or road reserve without prior Council approval.

21. CONSTRUCTION INSPECTIONS

The building works are to be inspected during construction by the Principal Certifying Authority (PCA) in accordance with the *Building Legislation Amendment (Quality of Construction) Act 2002,* clause 162A of the *Environmental Planning and Assessment Regulation 2000* and the requirements of any other applicable legislation or instruments.

22. CERTIFICATE OF SURVEY - BOUNDARIES AND LOCATION OF BUILDING

A Certificate of Survey prepared by a Registered Surveyor setting out the boundaries of the site and the location of the building on the site is to be submitted to the Principal Certifying Authority to certify the building is located in accordance with the development consent plans.

23. TREATMENT OF BOUNDARY WALLS

The wall approved on the northern boundary with the neighbouring property is to be finished to the same standard as the remaining building and not left unfinished to ensure a consistent visual appearance.

24. WORK OUTSIDE PROPERTY BOUNDARY

This consent does not authorise any work outside the property boundary.

VEHICLE ACCESS & PUBLIC DOMAIN WORKS

25. RECONSTRUCT VEHICLE CROSSING

The existing vehicle crossing is to be demolished and a new crossing constructed to provide access to the proposed garage. A separate application is required for the vehicle crossing, with all work to be carried out with the approval of and in accordance with the requirements of Council.

Prior to the submission of the vehicle crossing application, works as executed drawings shall be submitted to Council for the approval of the Executive Manager Creating Waverley confirming the finished levels of the internal driveway between the property boundary and the garage floor comply with the approved driveway long sections.

26. VEHICULAR ACCESS - FINISHED LEVELS TO INVERT OF THE GUTTER

The finished level at the property boundary on both sides of the vehicle crossing is to be 110mm above the level of the invert of the existing concrete gutter.

D. PRIOR TO THE ISSUE OF AN OCCUPATION CERTIFICATE OR SUBDIVISION CERTIFICATE

The requirements outlined in this section are to be provided to the satisfaction of the Principal Certifying Authority in all instances, except where a condition explicitly specifies that the approval of Council or a Council Officer is required, prior to the issue of an Occupation Certificate or Subdivision Certificate, whichever applies.

CERTIFICATES, LICENCES, EASEMENTS AND RESTRICTIONS

27. FINAL OCCUPATION CERTIFICATE

Prior to occupation or use of the development, an Occupation Certificate must be obtained.

The Principal Certifying Authority must be satisfied that the requirements of the *Environmental Planning & Assessment Act 1979* have been satisfied including all critical stage inspections. Documentary evidence of all required inspections is to be submitted to Council.

28. CERTIFICATION OF BASIX COMMITMENTS

The Principal Certifying Authority shall certify that the all the undertakings in the approved BASIX certificate have been completed.

29. CERTIFICATION OF STORMWATER SYSTEM

Prior to issue of an occupation certificate, certification is to be provided from a suitably qualified Hydraulics Engineer, that the stormwater system has been constructed in accordance with the approved stormwater management plans and to best engineering practice.

30. CERTIFICATION OF NEWLY CONSTRUCTED AND RETAINED STORMWATER DRAINAGE SYSTEM

Prior to the issue of any Occupation Certificate, certification is to be provided from a suitably qualified and practicing Engineer or Plumber, that any new stormwater drainage system has been constructed in accordance with the Development Consent, Water Management Technical Manual, all applicable Codes, Policies, Plans, Standards, and good engineering practice. Similarly, any retained stormwater drainage system is unblocked, in good working order, and to be repaired/replaced to best practice. A copy of the certification must be submitted to Council.

E. OPERATIONAL MATTERS

The following operational conditions must be complied with at all times, throughout the use and operation of the development or use.

PARKING AND ACCESS

31. HEADROOM CLEARANCE

The headroom clearance on the entry and within the garage is to be a minimum of 2.2 metres.

ADVISORY MATTERS

The following advisory matters are provided as additional information to ensure compliance with the relevant legislation and requirements. You must also check other Commonwealth and NSW Acts and Regulations which may apply to the works or use approved in this application.

AD1. POST CONSENT CONDITIONS REQUIRING COUNCIL INPUT

Various conditions require further input, review or approval by Council in order to be satisfied following the determination of the application (that is, post consent). In those instances, please adhere to the following process to avoid delays:

Please read your conditions carefully.

- Information to be submitted to Council should be either via email to info@waverley.nsw.gov.au or via the NSW Planning Portal (if required).
- Attention the documentation to the relevant officer/position of Council (where known/specified in condition).
- Include DA reference number.
- Include condition number/s seeking to be addressed.
- Where multiple conditions need Council input, please try to group the documentation / email/s into relevant subjects (multiple emails for various officers may be necessary, for example).
- Information to be submitted in digital format refer to 'Electronic lodgement guidelines' on Council's website. Failure to adhere to Council's naming convention may result in documentation being rejected.
- Where files are too large for email, the digital files should be sent to Council via CD/USB. Council does not support third party online platforms (data in the cloud) for receipt of information.
- Please note, in some circumstances, additional fees and/or additional documents (hard copy) may be required.
- Council's standard for review (from date the relevant officer receives documentation) is 14 days. Times may vary or be delayed if information is not received in this required manner.

AD2. SYDNEY WATER REQUIREMENTS

You may be required to submit your plans to the appropriate Sydney Water office to determine whether the development will affect Sydney Water's sewer and water mains, stormwater drains and/or easements.

Contact Sydney Water for more information.

AD3. DIAL BEFORE YOU DIG

Underground assets may exist in the area that is subject to your application. In the interests of health and safety and in order to protect damage to third party assets please contact Dial Before You Dig at www.1100.com.au or telephone on 1100 before excavating or erecting structures (this is the law in NSW). If alterations are required to the configuration, size, form or design of the development upon contacting the Dial Before You Dig service, an amendment to the development consent (or a new development application) may be necessary. Individuals owe asset owners a duty of care that must be observed when working in the vicinity of plant or assets. It is the individual's responsibility to anticipate and request the nominal location of plant or assets on the relevant property via contacting the Dial Before You Dig service in advance of any construction or planning activities.

AD4. TELECOMMUNICATIONS ACT 1997 (COMMONWEALTH)

Telstra (and its authorised contractors) are the only companies that are permitted to conduct works on Telstra's network and assets. Any person interfering with a facility or installation owned by Telstra is committing an offence under the Criminal Code Act 1995 (Cth) and is liable for prosecution. Furthermore, damage to Telstra's infrastructure may result in interruption to the provision of essential services and significant costs. If you are aware of any works or proposed works which may affect or impact on Telstra's assets in any way, you are required to contact: Telstra's Network Integrity Team on 1800 810 443.

AD5. ALTERATIONS AND ADDITIONS ONLY


This consent is for alterations and additions to the existing building only and should during the course of construction a significant amount of the remaining fabric of the building be required to be removed, works must cease immediately and a new development application will be required to be submitted for assessment.

AD6. EXCAVATION TO BE LIMITED

Excavation shall be limited to that shown in the approved plans. Any further excavation will require Council approval.

AD7. TREE REMOVAL/PRESERVATION

Any trees not identified for removal in this application have not been assessed and separate approval may be required. Any pruning of trees on adjoining properties required for the erection of scaffolding and/or the construction of the building may also require approval.

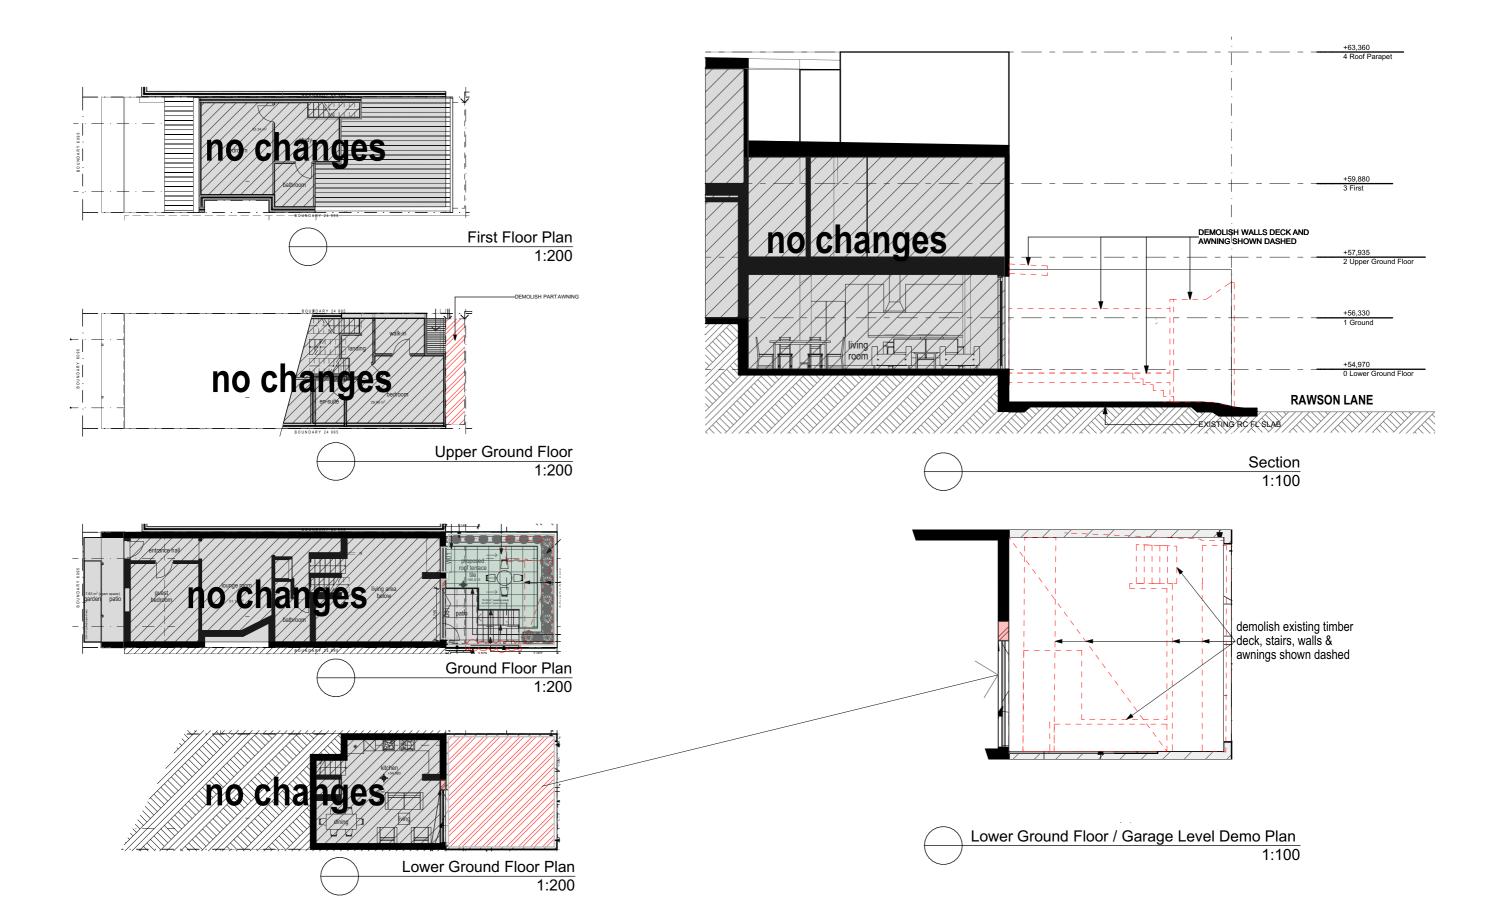

Revision:

C: Development Application 18 May 2022
D: Development Application 15 August 2022

Notes:

Use figured dimensions only / do not scale / comply with all relevant BCA/NCC, Australian Standards & Authorities requirements. These drawings are copyright of DRE Design.
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DRE Design

Architecture Urban Design & Planning
M: 0411 833 974
info@dredesign.com.au
www.dredesign.com.au
David Epstein Architect
ARB NSW Reg No. 9072 T/A DRE Design

Plot Date: 15/08/2022 **Project NO.** 0544

Project Status Development Application

Client Ian and Susan Beinart

Site: 16 Rawson Avenue, Queens Park NSW 2022

DRAWING TITLE:


Existing / Demo Plan

PROJECT NAME:
Proposed garage & terrace

REVISION NO.

D

DRAWING NO.

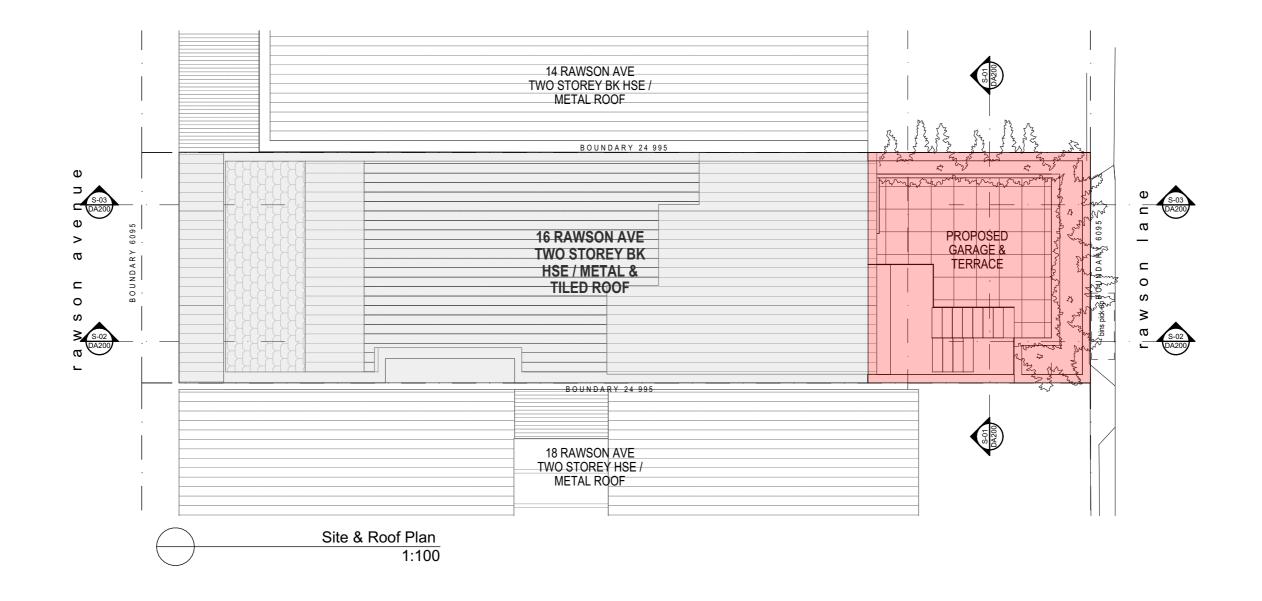

Revision:

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Plot Date: 15/08/2022 Project NO. 0544

Project Status Development Application

Client Ian and Susan Beinart

Site: 16 Rawson Avenue, Queens Park NSW 2022

DRAWING TITLE :

Site & Roof Plan


PROJECT NAME:

Proposed garage & terrace

REVISION NO.

D

DRAWING NO.

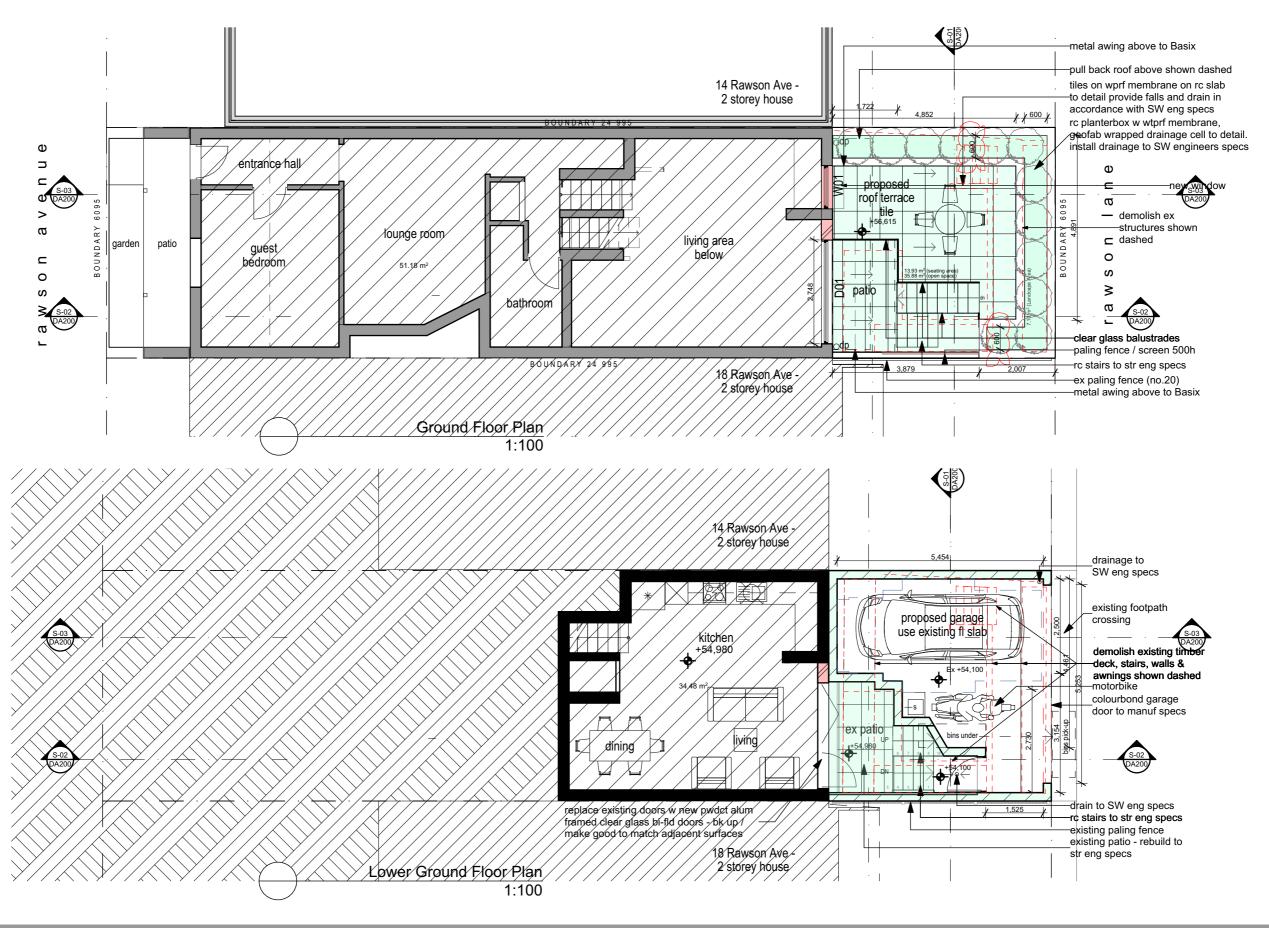



C: Development Application 18 May 2022 D: Development Application 20 Jan 2023

Notes:

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David Epstein Architect
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Plot Date: 20/01/2023 Project NO. 0544

Project Status Development Application

Client Ian and Susan Beinart

Site: 16 Rawson Avenue, Queens Park NSW 2022

DRAWING TITLE:

Lower Grnd & Grnd Fl Floor


PROJECT NAME:

Proposed garage & terrace

REVISION NO.

D

DRAWING NO.

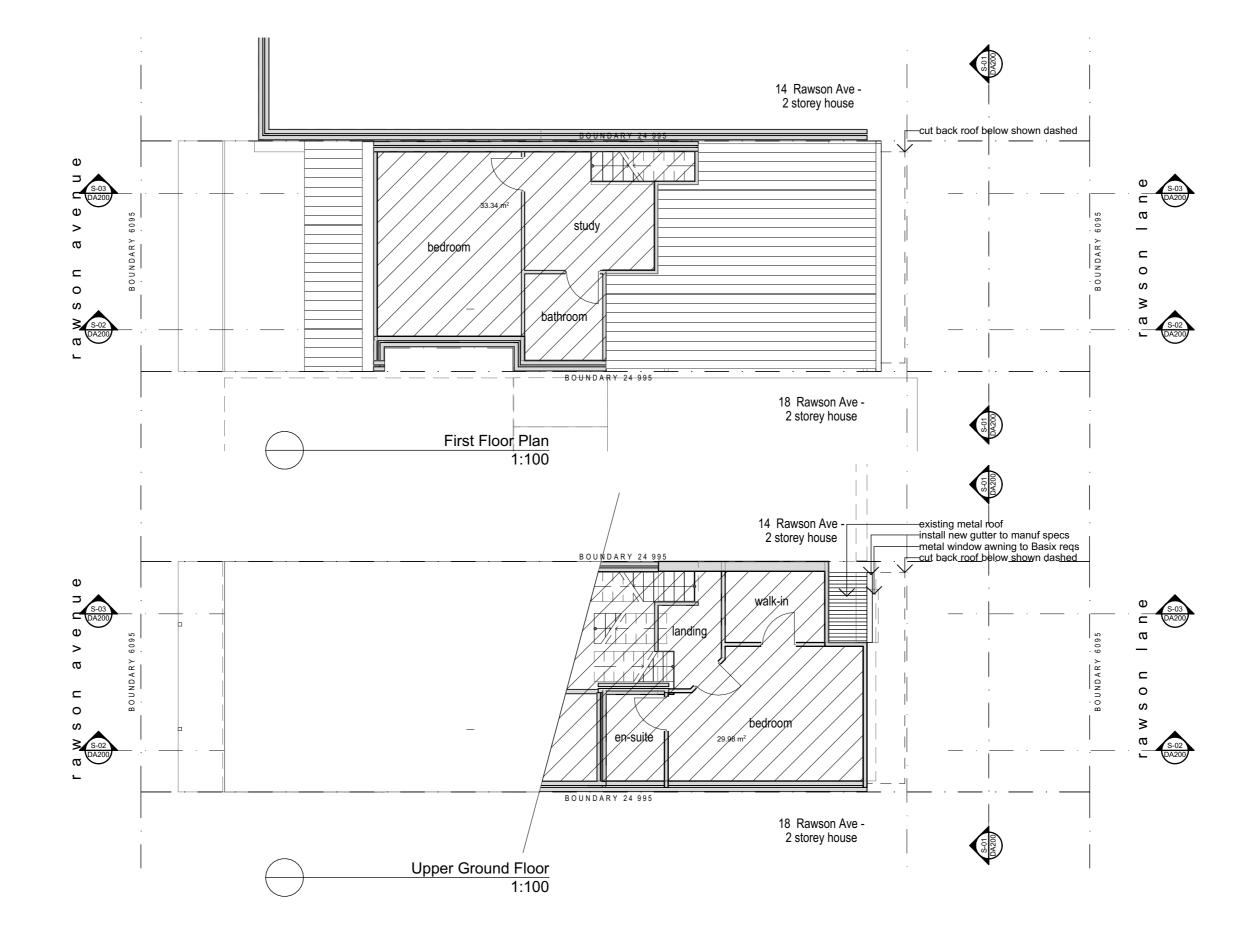

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DRE Design

Architecture Urban Design & Planning
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David Epstein Architect
ARB NSW Reg No. 9072 T/A DRE Design

Plot Date: 15/08/2022 Project NO. 0544

Project Status Development Application

Client Ian and Susan Beinart

Site: 16 Rawson Avenue, Queens Park NSW 2022

DRAWING TITLE:

Upper Grnd FI & 1st FI


PROJECT NAME:

Proposed garage & terrace

REVISION NO.

D

DRAWING NO.

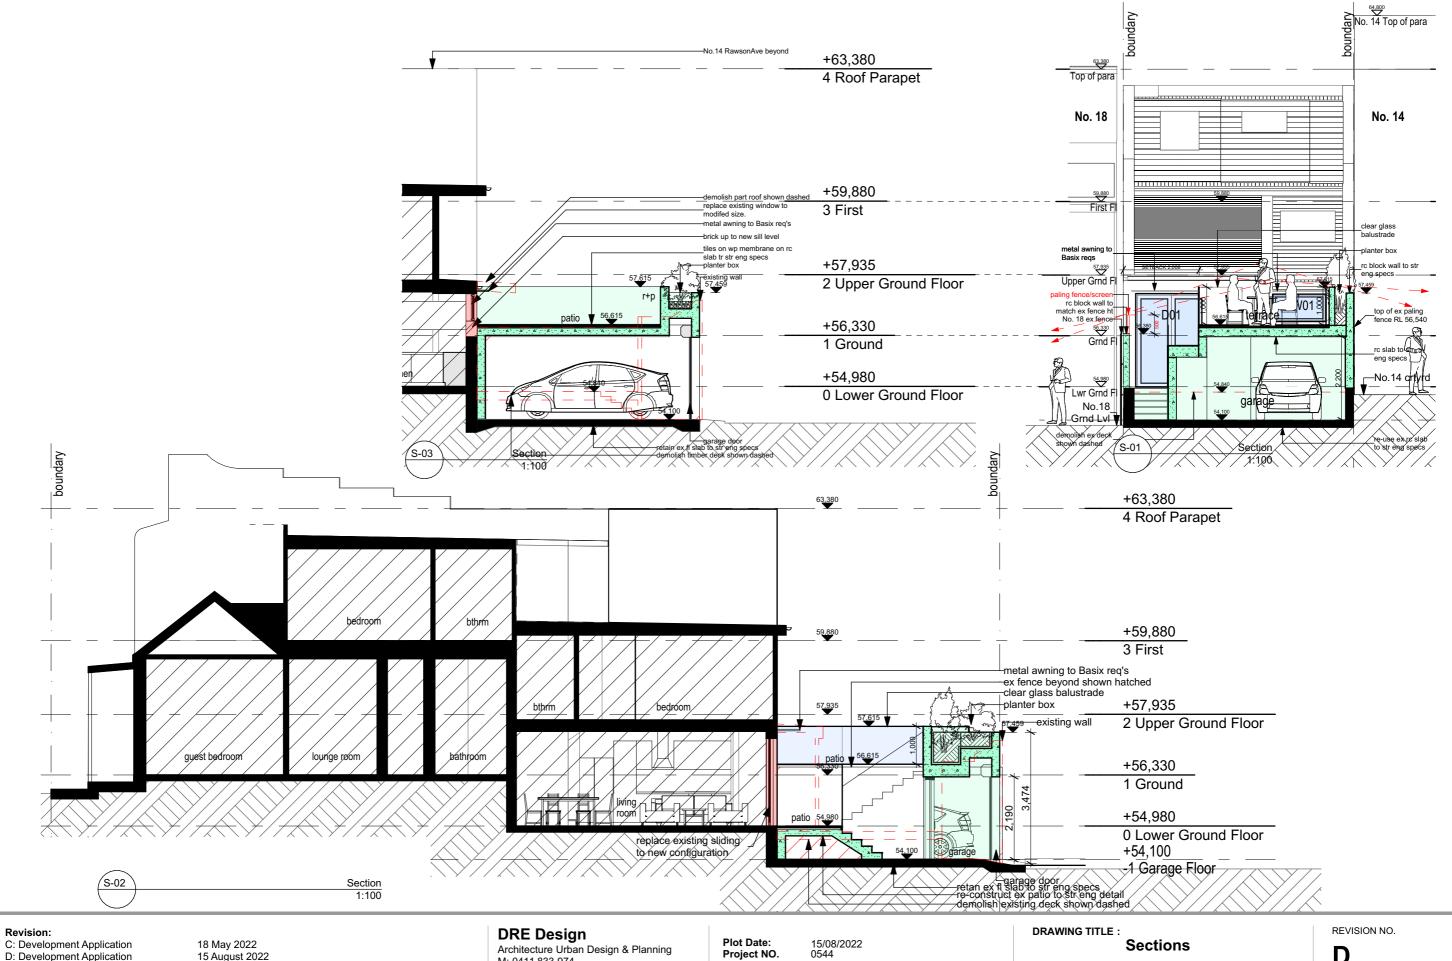

15 August 2022 D: Development Application

Notes:

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Project Status Development Application


Client Ian and Susan Beinart

Site: 16 Rawson Avenue, Queens Park NSW 2022 PROJECT NAME:

Proposed garage & terrace

D

DRAWING NO.

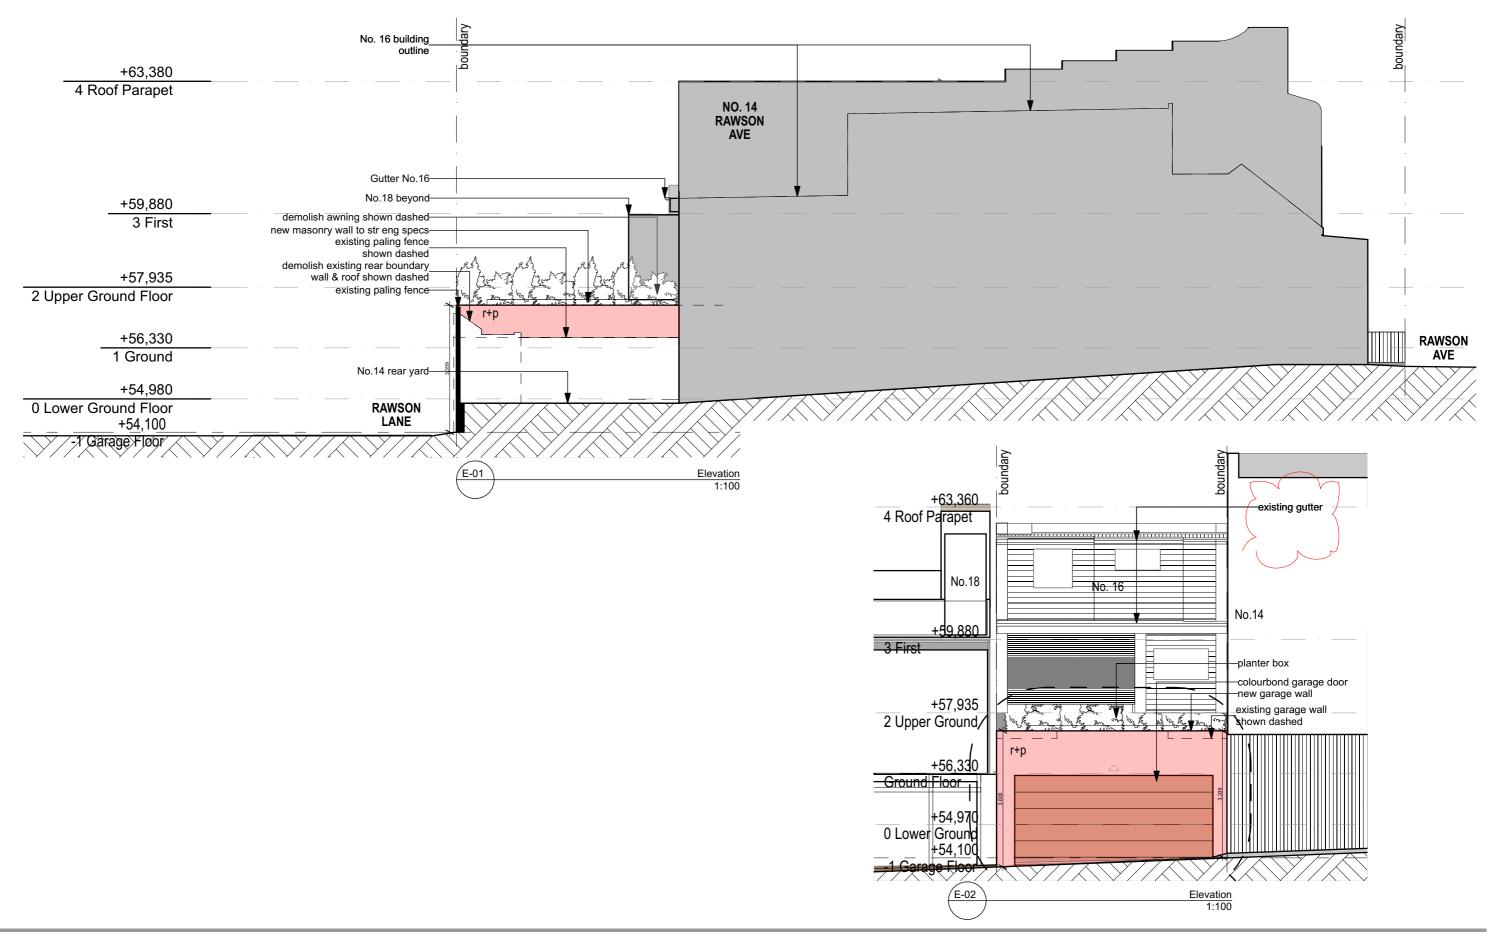

A: Preliminary plans for client approval 18 Jan 2022 18 Mar 2022 18 May 2022 B: For consultant input
C: Development Application

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Architecture Urban Design & Planning M: 0411 833 974 info@dredesign.com.au www.dredesign.com.au David Epstein Architect ARB NSW Reg No. 9072 T/A DRE Design Plot Date: Project NO. 7/9/2022 0544

Project Status Development Application

lan and Susan Beinart Client

Site: 16 Rawson Avenue, Queens Park NSW 2022 DRAWING TITLE:

Elevations


PROJECT NAME:

Proposed garage & terrace

REVISION NO.

D

DRAWING NO.

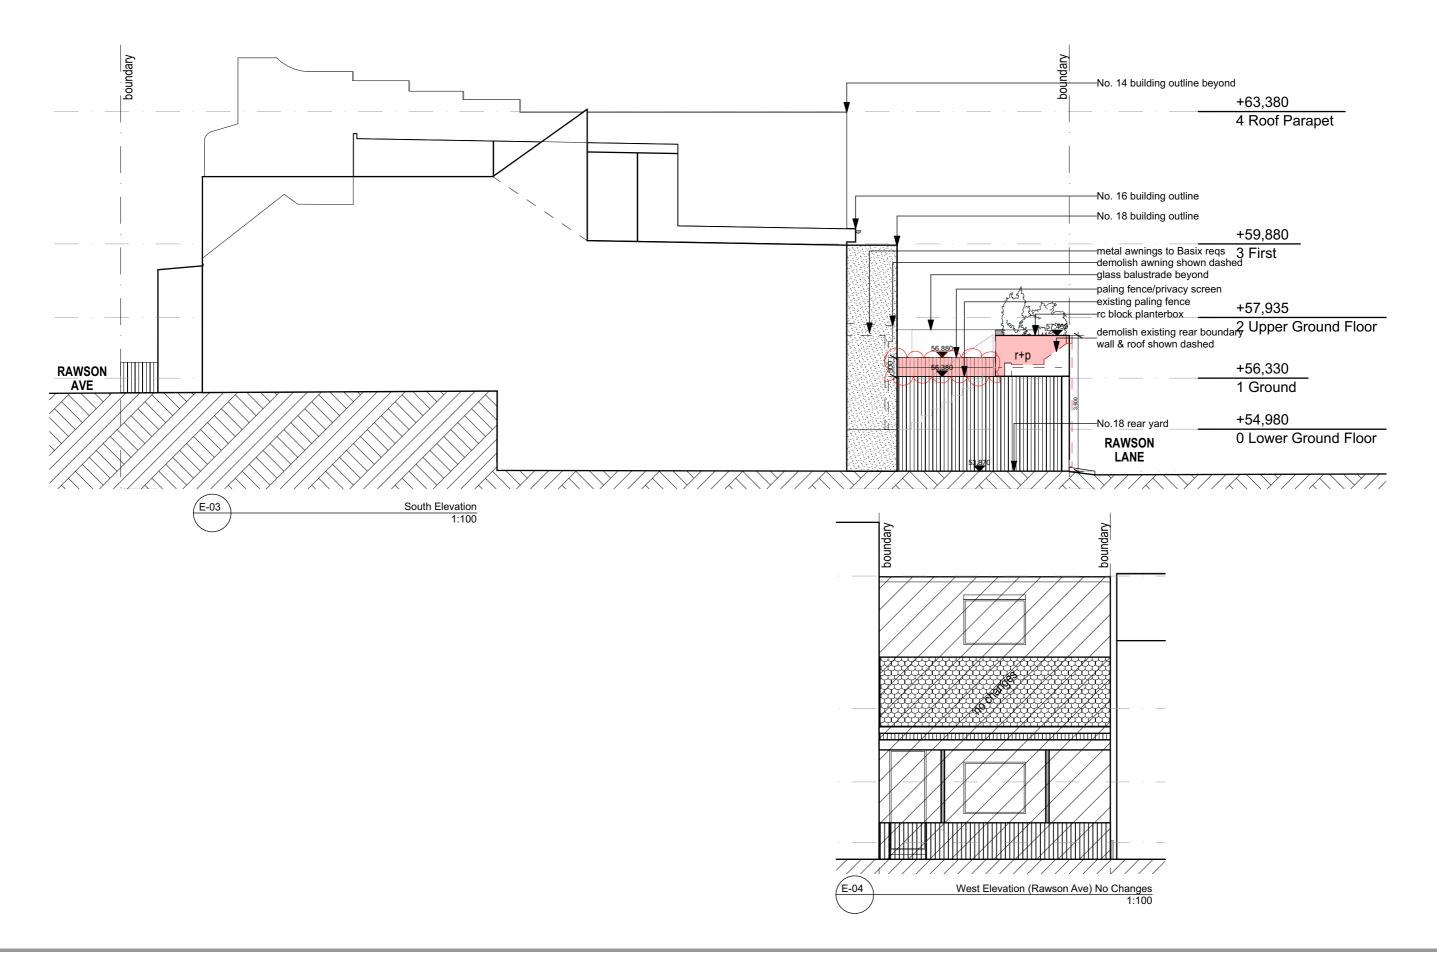

Revision:

C: Development Application 18 May 2022
D: Development Application 15 August 2022

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Project Status Development Application

Client Ian and Susan Beinart

Site: 16 Rawson Avenue, Queens Park NSW 2022

DRAWING TITLE:

Elevations


PROJECT NAME :


Proposed garage & terrace

REVISION NO.

D

DRAWING NO.

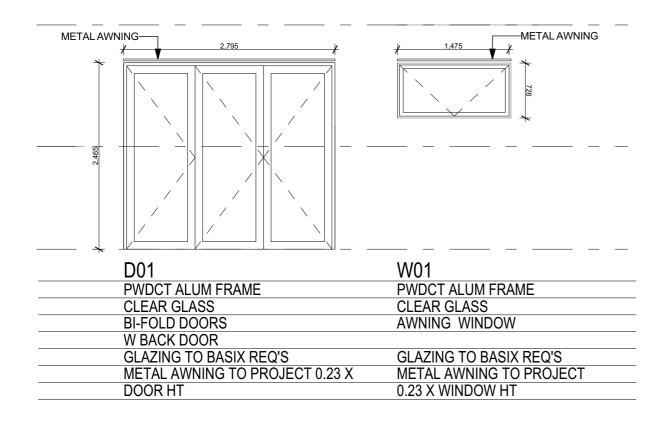

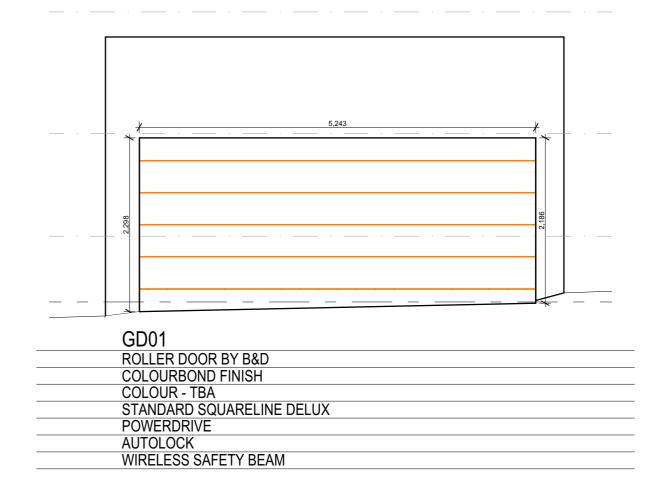

Basix Certificate Number: A455466

Windows and glazed doors glazing requirements

Window / door	Orientation	Area of	Oversha	dowing	Shading device	Frame and glass type
no.		glass inc. frame (m2)	Height (m)	Distance (m)		
W01	E	1.1	0	0	projection/height above sill ratio >=0.23	standard aluminium, single pyrolytic low-e, (U-value: 5.7, SHGC: 0.47)
D01	Е	6.9	0	0	projection/height above sill ratio >=0.23	standard aluminium, single pyrolytic low-e, (U-value: 5.7, SHGC: 0.47)

Revision:

C: Development Application 18 May 2022
D: Development Application 15 August 2022

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Plot Date: 15/08/2022 Project NO. 0544

Project Status Development Application

Client Ian and Susan Beinart

Site: 16 Rawson Avenue, Queens Park NSW 2022

DRAWING TITLE:

Windows / Doors Schedule

PROJECT NAME:

Proposed garage & terrace

REVISION NO.

D

DRAWING NO.





RENDERED WALLS / SELECTED PAVING



COLOURBOND GARAGE DOOR / RENDERED WALL

EXISTING GFA: 151.5m² 0.99:1 **EXISTING FSR:** MAX FSR (WLEP) 0.94:1 PROPOSED GFA 156.9m² PROPOSED FSR 1.03:1 (See attached Cl 4.6) WDCP 2012 Minimum Open Space 40% 15% Landscaped Area **Existing Open Space** 33m² (21%) Proposed Open Space 43.51m² (28.5%) Existing Landscape Area 3.9m² (2.5%) Proposed Landscape Area 11m² (7.2%)

Revision:

C: Development Application 18 May 2022 D: Development Application 20 Jan 2023

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Plot Date: 2/02/2023 Project NO. 0544

Project Status Development Application

Client Ian and Susan Beinart

Site: 16 Rawson Avenue, Queens Park NSW 2022

DRAWING TITLE:

Area Calculations + Materials


PROJECT NAME:

Proposed garage & terrace

REVISION NO.

D

DRAWING NO.

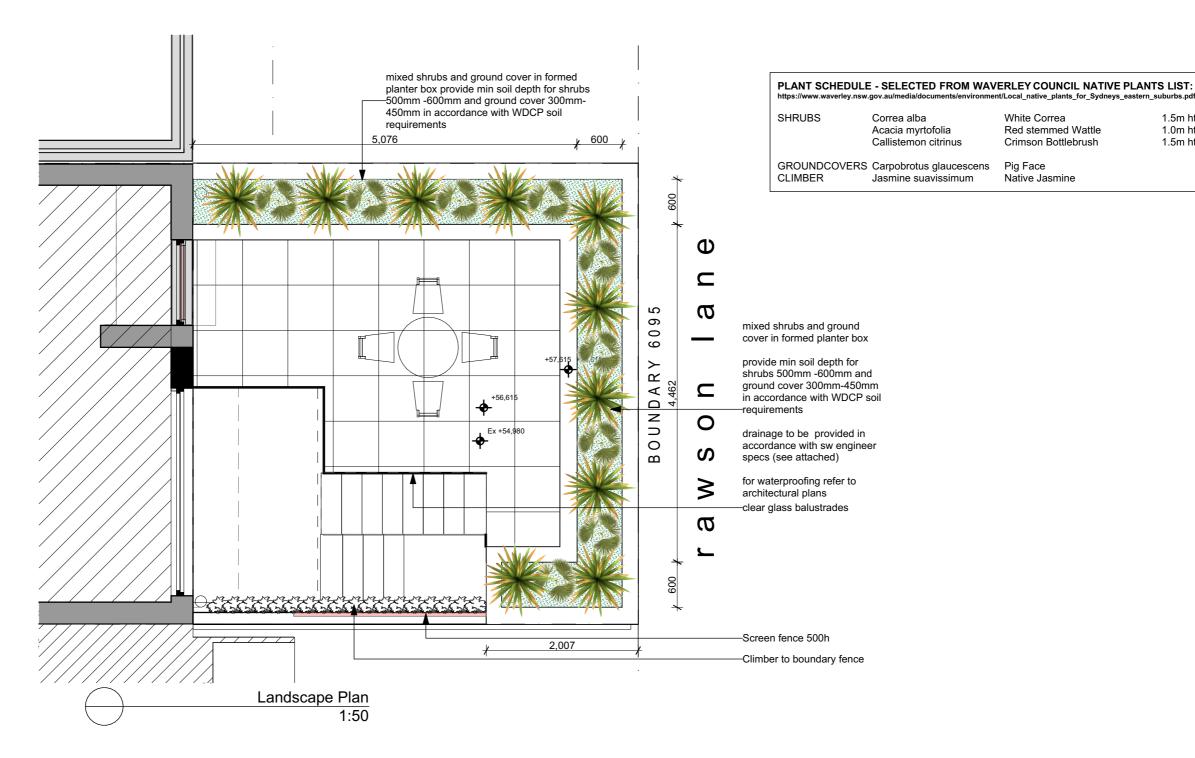

Revision:

C: Development Application 18 May 2022 D: Development Application 20 Jan 2023

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Architecture Urban Design & Planning M: 0411 833 974 info@dredesign.com.au www.dredesign.com.au David Epstein Architect ARB NSW Reg No. 9072 T/A DRE Design Plot Date: 20/01/2023 Project NO.

Project Status Development Application

Client Ian and Susan Beinart

16 Rawson Avenue, Queens Park NSW 2022

DRAWING TITLE:

Landscape Plan

PROJECT NAME:

Proposed garage & terrace

REVISION NO.

nt/Local_native_plants_for_Sydneys_eastern_suburbs.pdf

1.5m ht

1.0m ht

1.5m ht

White Correa

Native Jasmine

Pig Face

Red stemmed Wattle

Crimson Bottlebrush

DRAWING NO.





Report to the Waverley Local Planning Panel

Application number	DA-417/2022	
Site address	11 Pembroke Street, BRONTE NSW 2024	
Proposal	Alterations to extend existing attic space to Unit 1	
Date of lodgement	30 September 2022	
Owner	Strata Plan No 94480	
Applicant	Mr D Fleeting	
Submissions	Nil	
Cost of works	\$56,822.70	
Principal Issues	FSRHeight of BuildingDormer window	
Recommendation	That the application be REFUSED for the reasons contained in the report.	

SITE MAP



1. PREAMBLE

1.1. Executive Summary

The development application seeks consent for alterations to extend existing attic space to Unit 1 at the site known as 11 Pembroke Street, Bronte.

The principal issues arising from the assessment of the application are as follows:

- FSR.
- height of building.
- dormer window.

The assessment finds these issues unacceptable. The proposed breach of FSR is not justified and is against the objectives of the LEP.

The proposal for additional bulk is inconsistent with the streetscape.

No submissions were received.

No Councillor submissions were received.

The application has been assessed against the relevant matters for consideration under section 4.15(1) of the *Environmental Planning and Assessment Act 1979*. It is recommended for refusal.

1.2. Site and Surrounding Locality

A site visit was carried out on 9 November 2022.

The site is identified as Lot 1 in SP 94480, known as 1/11 Pembroke Street, Bronte.

The site is rectangular in shape with a frontage to Pembroke Street, measuring 18.29m, secondary frontage to Trafalgar Street measuring 23.775m and a tertiary frontage to a lane off Trafalgar Street measuring 18.29m. The site has an area of 434.8m² and is generally flat.

The site is occupied by a pair of semi-detached dwellings. The subject application relates to Unit 1 which is located fronting Pembroke Street with vehicular access to a double garage from Trafalgar Street. Unit 2 has frontage to Trafalgar Street and the laneway. There are no works proposed to Unit 2.

The site is adjoined by Waverley Cemetery to the south, two-storey detached dwellings to the north and east and a single-storey early education centre to the west. A variety of low density residential development and a neighbourhood centre to the north west characterises the locality.

Figures 1 to 6 are photos of the site and its context.



Figure 1: Streetview of the subject site across Trafalgar Street.



Figure 3: Streetview of the subject site from the rear laneway.



Figure 5: Streetview of the subject site across Pembroke Street.

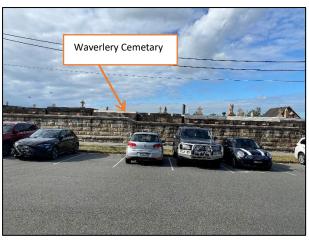


Figure 2: Streetview opposite the subject site along Trafalgar Street.



Figure 4: Streetview opposite of the subject site along the rear laneway.



Figure 6: Streetview opposite the subject site along Pembroke Street.

1.3. Relevant Development History

A search of Council's records revealed the following recent and relevant development history of the site:

DA-249/2015

- Approved 27 January 2016
- Demolition of existing dwelling and construction of a dual occupancy development and strata subdivision.

DA-249/2015/A

- o Approved 01 June 2017
- Amended plans to modify windows, doors, internal layout and lower the ground and first floor level to an approved dual occupancy development.

DA-249/2015/B

- o Approved 13 July 2018
- Section 4.55 (1A) modification of consent to reflect as built first floor balcony and external wall.

• SC-15/2020

- o Approved 13 May 2020
- Strata Subdivision into 2 lots.

1.4. Proposal

The development application seeks consent for alterations and additions to a semi-detached dwelling, involving the extension of the existing loft at the second floor level of the dwelling to provide an additional 9.5m² floor space. The proposed extension is to be contained within a flat roofed dormer window extending over the northern roof slope.

ASSESSMENT

The following matters are to be considered in the assessment of this development application under section 4.15 of the *Environmental Planning and Assessment Act 1979* (the Act).

2.1. Planning Instruments and Development Control Plans

The following is an assessment against relevant legislation, environmental planning instruments, including State environmental planning policies (SEPPs), and development control plans.

2.1.1. State Environmental Planning Policies (SEPPs)

The following SEPPs apply from the 01 March 2022 and have been considered acceptable in the assessment of this development application:

- SEPP (Building Sustainability Index BASIX) 2004
- SEPP (Biodiversity and Conservation) 2021
- SEPP (Resilience and Hazards) 2021

2.1.2. Waverley Local Environmental Plan 2012 (Waverley LEP 2012)

The relevant matters to be considered under the Waverley LEP 2012 for the proposed development are outlined below:

Table 1: Waverley LEP 2012 Compliance Table

Provision	Compliance	Comment
Part 1 Preliminary		
1.2 Aims of plan	Yes	The proposal is considered consistent with the aims of the plan.
Part 2 Permitted or prohibited de	velopment	
Land Use Table R2 low density residential zone	Yes	The land use is defined as a semi-detached dwelling, which is permitted with consent in the R2 zone.
Part 4 Principal development star	ndards	
4.3 Height of buildings■ 8.5m	No	The proposal has an overall building height of 9.1m, measured to the roof ridge at RL75.830 above the existing ground level. The proposal will exceed the development standard by 0.6m or 7%.
 4.4 Floor space ratio and 4.4A Exceptions to floor space ratio 0.63:1 	No	The proposal has a gross floor area (GFA) of 411.5m² or an FSR of 0.95:1 which equates to a 51% variation to the FSR development standard. The proposal provides an increase of 9.5m² from the existing GFA of 402m².
4.6 Exceptions to development standards	See discussion	The application is accompanied by a written request pursuant to clause 4.6 of Waverley LEP 2012 to vary the height and FSR development standards. A detailed discussion of the variation to the development standards is presented below this table.
Part 6 Additional local provisions		
6.1 Acid sulfate soils	Yes	The subject site is classified as Acid Sulfate soil class 5 in the relevant soil lands map. As the proposed development does not seek consent for earthworks on the site the proposal is considered acceptable with regards to the provisions of clause 6.1.

The following is a detailed discussion of the issues identified in the compliance table above in relation to the Waverley LEP 2012.

Clause 4.6 Exceptions to Development Standards – Height of Building

The application seeks to vary the height of buildings development standard in clause 4.3 under Waverley LEP 2012.

The site is subject to a maximum height development standard of 8.5m. The proposed development has a building height of 9.1m, exceeding the standard by 0.6m, equating to a 7% variation.

A written request has been submitted to Council in accordance with clause 4.6(3)(a) and (b) of Waverley LEP 2012 seeking to justify the contravention of the development standard by demonstrating:

- (a) That compliance with the development standard is unreasonable or unnecessary in the circumstances of the case; and
- (b) That there are sufficient environmental planning grounds to justify contravening the standard.

A copy of the applicant's written request has been provided to the Waverley Local Planning Panel for consideration.

Applicant's Written Request - Clause 4.6(3)(a) and (b)

The applicant seeks to justify the contravention of the HOB development standard on the following basis:

- (a) That compliance with the development standard is unreasonable or unnecessary in the circumstances of the case:
 - (i) The height breach falls below the ridge line of the existing building.
 - (ii) The proposed awning tapers down.
 - (iii) The area of the roof breach is less than 10% of the whole area.
 - (iv) Consistent with the overall development and no significant increase in bulk or impact on the streetscape.
 - (v) No overshadowing or view impacts.
- (b) That there are sufficient environmental planning grounds to justify contravening the standard:
 - (i) The height breach falls below the ridge line of the existing building.
 - (ii) The proposed awning tapers down.
 - (iii) The area of the roof breach is less than 10% of the whole area.
 - (iv) Consistent with the overall development and no significant increase in bulk or impact on the streetscape.
 - (v) No overshadowing or view impacts.

Consideration of Applicant's Written Request - Clause 4.6(4) (a) (i) and (ii)

Development consent must not be granted unless the consent authority is satisfied that:

- (a) The applicant's written request has adequately addressed the matters required to be demonstrated by subclause 3 of clause 4.6 being that compliance with the development standard is unreasonable or unnecessary in the circumstances of the case, and that there are sufficient environmental planning grounds to justify contravening the standard; and
- (b) The proposed development will be in the public interest because it is consistent with the objectives of the particular development standard and the objectives for development within the zone in which the development is proposed to be carried out.

Does the written request adequately address those issues at clause 4.6(3)(a)?

Although, the written request has referenced one or more of the justifications as set out in *Wehbe v Pittwater Council* (2007) 156 LGERA 446 (listed below) it is considered that the applicant has not adequately addressed that compliance with the standard is unreasonable or unnecessary in the circumstances of the case.

- (a) the objectives of the development standard are achieved notwithstanding non-compliance with the standard;
- (b) to establish that the underlying objective or purpose is not relevant to the development with the consequence that compliance is unnecessary;
- (c) to establish that the underlying objective or purpose would be defeated or thwarted if compliance was required with the consequence that compliance is unreasonable;
- (d) to establish that the development standard has been virtually abandoned or destroyed by the Council's own actions in granting consents departing from the standard and hence compliance with the standard is unnecessary and unreasonable; and
- (e) to establish that "the zoning of particular land" was "unreasonable or inappropriate" so that "a development standard appropriate for that zoning was also unreasonable or unnecessary as it applied to that land" and that "compliance with the standard in that case would also be unreasonable or unnecessary.

The applicant specifically relies upon justification (a) outlined above to address clause 4.6(3)(a) of Waverley LEP 2012.

Council accepts that the proposal is below the existing roof ridge line with no overshadowing impacts on surrounding adjoining properties however, the proposal results in a building of unacceptable bulk that is inconsistent with the streetscape. In this case, the applicant has not appropriately demonstrated that compliance with the development standard is unreasonable and unnecessary and that sufficient environmental planning grounds have been established.

Does the written request adequately address those issues at clause 4.6(3)(b)?

The applicant has not adequately addressed that there are sufficient environmental planning grounds to justify contravening the development standard. The applicant notes that the proposal is below the existing ridge line which exists above the maximum height of the building line and is minor in nature. However, Council is of the opinion that the proposal would further increase an already bulky building when compared to the streetscape.

Is the development in the public interest?

The proposed development not will be in the public interest because it is inconsistent with both the objectives of the particular development standard and the objectives for development within the zone in which the development is proposed to be carried out.

The objectives of the height development standard are as follows:

- (a) to establish limits on the overall height of development to preserve the environmental amenity of neighbouring properties and public spaces and, if appropriate, the sharing of views,
- (b) to increase development capacity within the Bondi Junction Centre to accommodate future retail and commercial floor space growth,
- (c) to accommodate taller buildings on land in Zone B3 Commercial Core of the Bondi Junction Centre and provide an appropriate transition in building heights surrounding that land,
- (d) to ensure that buildings are compatible with the height, bulk and scale of the desired future character of the locality and positively complement and contribute to the physical definition of the street network and public space.

As mentioned above, the proposed loft extension is below the existing roof ridge line. The addition would lead to an increase in bulk which is not compatible with the bulk and scale of the desired future character of the locality inconsistent with objective (d).

The objectives of the R2 low density residential zone are as follows:

- To provide for the housing needs of the community within a low density residential environment.
- To enable other land uses that provide facilities or services to meet the day to day needs of residents.
- To maximise public transport patronage and encourage walking and cycling.

The proposed variation of is consistent with the objectives of the zone.

Conclusion

For the reasons provided above, the requested variation to the height development standard is not supported as the applicant's written request has not adequately addressed the matters required to be

addressed by clause 4.6(3) of the Waverley LEP 2012. In addition, the proposed development is not in the public interest because it is inconsistent with the objectives of the height development standard

Clause 4.6 Exceptions to Development Standards – Floor Space Ratio

The application seeks to vary the floor space ratio (FSR) development standard in clause 4.4 under Waverley LEP 2012.

The site is subject to a maximum FSR development standard of 0.63:1. The proposed development has an FSR of 0.95:1, exceeding the standard by 139m² equating to a 51% variation. The proposed development increases an already non-compliant FSR by a further 9.5m² or 6.8%.

A written request has been submitted to Council in accordance with clause 4.6(3)(a) and (b) of Waverley LEP 2012 seeking to justify the contravention of the development standard by demonstrating:

- (a) That compliance with the development standard is unreasonable or unnecessary in the circumstances of the case; and
- (b) That there are sufficient environmental planning grounds to justify contravening the standard.

A copy of the applicant's written request has been provided to the Waverley Local Planning Panel for consideration.

Applicant's Written Request - Clause 4.6(3)(a) and (b)

The applicant seeks to justify the contravention of the FSR development standard on the following basis:

- (a) That compliance with the development standard is unreasonable or unnecessary in the circumstances of the case:
 - (i) The proposal is below the existing ridgeline.
 - (ii) Unit 1 of the strata plan has a site area of 232m², meaning a prescribed area of 197m². The exiting approved floor area of 195m² means an exceedance of 7.5m² or less than 4%.
 - (iii) Improves the amenity of the subject site.
 - (iv) No privacy or shadow impacts to adjoining properties.
 - (v) No significant increase in bulk.
- (b) That there are sufficient environmental planning grounds to justify contravening the standard:
 - (i) No impact on either the public domain, street or adjacent neighbours.
 - (ii) No shadow or view loss to adjacent properties.

Consideration of Applicant's Written Request - Clause 4.6(4) (a) (i) and (ii)

Development consent must not be granted unless the consent authority is satisfied that:

- (a) The applicant's written request has adequately addressed the matters required to be demonstrated by subclause 3 of clause 4.6 being that compliance with the development standard is unreasonable or unnecessary in the circumstances of the case, and that there are sufficient environmental planning grounds to justify contravening the standard; and
- (b) The proposed development will be in the public interest because it is consistent with the objectives of the particular development standard and the objectives for development within the zone in which the development is proposed to be carried out.

Does the written request adequately address those issues at clause 4.6(3)(a)?

Although, the written request has referenced one or more of the justifications as set out in *Wehbe v Pittwater Council* (2007) 156 LGERA 446 (listed below) it is considered that the applicant has not adequately addressed that compliance with the standard is unreasonable or unnecessary in the circumstances of the case.

- (a) the objectives of the development standard are achieved notwithstanding non-compliance with the standard;
- (b) to establish that the underlying objective or purpose is not relevant to the development with the consequence that compliance is unnecessary;
- (c) to establish that the underlying objective or purpose would be defeated or thwarted if compliance was required with the consequence that compliance is unreasonable;
- (d) to establish that the development standard has been virtually abandoned or destroyed by the Council's own actions in granting consents departing from the standard and hence compliance with the standard is unnecessary and unreasonable; and
- (e) to establish that "the zoning of particular land" was "unreasonable or inappropriate" so that "a development standard appropriate for that zoning was also unreasonable or unnecessary as it applied to that land" and that "compliance with the standard in that case would also be unreasonable or unnecessary.

The applicant specifically relies upon justification (a) outlined above to address clause 4.6(3)(a) of Waverley LEP 2012.

The proposal has not adequately addressed that compliance with the standard is unreasonable or unnecessary as the objectives of the development standard are not met. Principally the proposed extension not only causes a further breach of FSR but also a further building height breach contrary to the development standard. The addition would also unjustifiably increase the building bulk to be inconsistent with the desired character of the locality and streetscape.

Also noted, the written objection under clause 4.6 is incorrect in that the FSR has been calculated using only the strata lot boundaries of Unit 1. As this is a strata allotment, the GFA of the entire building and site must be used to calculate the FSR and not just the subject strata lot. In this regard, the written request is incorrect and the proposal cannot be approved.

Does the written request adequately address those issues at clause 4.6(3)(b)?

The applicant has not adequately addressed that there are sufficient environmental planning grounds to justify contravening the development standard. The proposed extension is contrary to the future desired character of the locality through the addition of bulk.

Is the development in the public interest?

The proposed development will not be in the public interest because it is inconsistent with the objectives of the particular development standard and the objectives for development within the zone in which the development is proposed to be carried out.

The objectives of the FSR development standard are as follows:

- (a) to ensure sufficient floor space can be accommodated within the Bondi Junction Centre to meet foreseeable future needs,
- (b) to provide an appropriate correlation between maximum building heights and density controls,
- (c) to ensure that buildings are compatible with the bulk and scale of the desired future character of the locality,
- (d) to establish limitations on the overall scale of development to preserve the environmental amenity of neighbouring properties and the locality.

The proposed addition is inconsistent with FSR objectives (b), (c) and (d). The extension will lead to a further breach of both height and floor space controls increasing the bulk and scale of the development in comparison with the desired future character of the locality. The locality in question is composed of single to double-storey residential developments, the proposed extension of the attic would turn the development into a three-storey development.

The objectives of the R2 low density residential zone have been discussed previously in this report.

Conclusion

For the reasons provided above the requested variation to the FSR is not supported as the applicant's written request has not adequately addressed the matters required to be addressed by clause 4.6(3) of the Waverley LEP 2012. In addition, the proposed development is not in the public interest because it is inconsistent with the objectives of floor space ratio.

2.1.3. Waverley Development Control Plan 2012 (Waverley DCP 2012) – Amendment No.9

The relevant matters to be considered under the Waverley DCP 2012 for the proposed development are outlined below:

Table 2: Waverley DCP 2012 – Part B General Provisions Compliance Table

Development Control	Compliance	Comment
1. Waste	Yes	Satisfactory.
Ecologically Sustainable Development	Yes	Satisfactory.
12. Design Excellence	No	The proposed extension unjustifiably increases the bulk of the building in relation to other developments on adjoining neighbouring sites.

Table 3: Waverley DCP 2012 – Part C2 Low Density Residential Development Compliance Table

Development Control	Compliance	Comment
2.0 General Objectives		
	No	The proposed addition is unsympathetic in bulk and character to the desired future character of the area.
2.2 Setbacks		
 2.2.1 Front and rear building lines Predominant front building line Predominant rear building line at each floor level 2.2.2 Side setbacks 	N/A Yes	The proposal will not alter the front and rear setbacks. Remains unchanged on the ground and first floor.
Minimum of 1.5m	103	The attic or third-floor side setback complies with the side boundary setback of 6.9m.
2.3 Streetscape and visual imp	pact	
 New development to be compatible with streetscape context 	No	The proposed addition will further increase the bulk of the development currently on the site. This increase will be incongruous with the
 Replacement windows to complement the style and proportions of existing dwelling 	N/A	streetscape and as such, is not supported.
 Significant landscaping to be maintained. 	N/A	

2.5	Visual and acoustic privacy	1	
•	Habitable windows are not to directly face habitable windows or open space of neighbouring dwellings unless direct views are screened or other appropriate measures are incorporated into the design	Yes	The proposed windows of the proposed loft extension do not directly face the habitable windows of neighbouring dwellings and as such will not result in additional unreasonable privacy impacts to adjoining properties.
2.6	Solar access		
•	Minimum of three hours of sunlight to living areas and principal open space areas on 21 June Minimum of three hours of sunlight maintained to at least 50% I of principal open space areas of adjoining properties on	N/A Yes	A minimum of 3 hours of sunlight is expected for the living areas and principal open space. The proposal is not expected to reduce solar access to either open space or windows of the adjacent properties to less than 3 hours.
•	21 June. Avoid unreasonably overshadowing of solar collectors (including habitable windows).	Yes	
2.7	' Views		
•	Views from the public domain are to be maintained Development to be designed and sited so as to enable a sharing of views with surrounding dwellings particularly from habitable rooms and decks.	Yes	No impacts on views have been identified, and no submissions have been received that raise an issue with view loss. As such, the proposal is not expected to result in impacts on any known views enjoyed by surrounding properties.
2.1	1 Dormer windows		
•	If < 2.5m from gutter to ridge, flush to the roof and maximum of one per single fronted dwelling or one pair on a double fronted dwelling	Yes	The proposed dormer window is proposed to extend from the existing ridge and does not comply with the 300mm setdown. However, the skillion dormer meets in a similar location as other existing dormer windows.
•	Minimum 0.3m below main roof ridge Skillion dormer permitted at the rear of the roof, provided ridge line is maintained	Yes No	The proposed skillion dormer window is located on the northern roof of the dwelling and will be visible from Pembroke Street. The proposed large dormer differs in size and design from the existing dormers on the pair of semi-detached dwellings and will appear as an ad hoc addition to the building. The proposed dormer will increase

2.13 Semi-detached dwellings and terrace style development 2.13.1 - Built form Additions to match the style of the original semi-detached dwelling Existing roof form maintained forward of principal ridgeline Use of roof as an attic permitted provided Front verandahs to be maintained. 2.13.2 - First floor additions to semi-detached dwellings First floor addition to be sethald from the principal street frontage and the existing front roof slope.	the Il Ittic.
 Additions to match the style of the original semidetached dwelling Existing roof form maintained forward of principal ridgeline Use of roof as an attic permitted provided Front verandahs to be maintained. 2.13.2 - First floor additions to semi-detached dwellings First floor addition to be No above, does not match the style or form of building and its adjacent pair. The extension is located behind the principal ridgeline. The proposal is an extension of an existing an extension occurs be the principal street frontage and the existing and the exist	the Il Ittic.
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 Front verandahs to be maintained. 2.13.2 - First floor additions to semi-detached dwellings First floor addition to be N/A The proposed attic/loft extension occurs be the principal street frontage and the existing front roof slope. 	
to semi-detached dwellings • First floor addition to be Yes the principal street frontage and the existing front roof slope.	
COTROCK TROM THO	
setback from the principal street frontage and maintain the existing front roof slope The interface rise of the proposed dormer a the strata subdivision plan is in excess of 60	_
Additions to be located a minimum of 1m behind the front main gable N/A	
Flat roofs should be only used when not seen in a Heritage Conservation Area	
Limit the rise of the interface with adjoining semi-detached dwelling to 600mm	
First floor additions should match the style of the additions on the adjoining semi (if relevant). N/A	
2.13.3 - Material finishes and detail for semi-detached dwellings The proposed addition matches the finishes detailing of the existing development and wellings	ill posed
 Finishes and detailing are to be cohesive with the existing dwelling Yes dormer roof form does not match the style those of the original dwelling. This is unsatisfactory and will impact upon the 	of
 Historic features of the roofscape are to be incorporated into the addition N/A streetscape appearance of the dwelling appearing as an ad hoc addition with no relevance to the style of dormers on the ser pair. 	ni-
No	

2.2. Other Impacts of the Development

The proposal is considered to have a significant detrimental effect relating to environmental, social or economic impacts on the locality and is recommended for refusal.

2.3. Suitability of the Site for the Development

The site is not considered suitable for the proposal.

2.4. Any Submissions

The application was notified for 14 days, from 6 October 2022 to 24 October 2022, in accordance with the *Waverley Community Development Participation and Consultation Plan*. No submissions were received.

2.5. Public Interest

The proposal is considered to have a detrimental effect on the public interest and is recommended for refusal.

3. REFERRALS

The following internal and external referral comments were sought:

3.1. Fire Safety Officer

Council's Fire Safety Engineer reviewed the application and advised that they have no objections to the proposal and provided conditions of approval.

3.2. Strategic Planning

Council's Strategic planers raised no issues with the proposed development.

4. CONCLUSION

The application has been assessed against the relevant matters for consideration under section 4.15(1) of the Act. It is recommended for refusal.

5. RECOMMENDATION TO WAVERLEY LOCAL PLANNING PANEL

That the development application be REFUSED by the Waverley Local Planning Panel for the reasons contained in Appendix A.

Report prepared by:	Application reviewed by:
D. Wilmoth	dence
Damien Daniel Wilmotte	Kylie Lucas
Development Assessment Planner	Acting Manager, Development Assessment
Date: 17/01/2023	Date: 09/02/2023

Reason for WLPP referral:

1. Departure from any development standard in an EPI by more than 10%

APPENDIX A – REASONS FOR REFUSAL

Having regard to section 4.15 (1) of the *Environmental Planning and Assessment Act 1979 (the Act)* the development application (the application) is refused for the following reasons:

- 1. The application does not satisfy section 4.15 (1)(a)(i) of the Act as it contrary to the following provisions of Waverley Local Environmental Plan (WLEP) 2012:
 - a. Clause 4.3 Height of Buildings

The application exceeds the maximum allowable height of 8.5m and the applicant's written request under clause 4.6 of WLEP has failed to adequately address the required matters under subclauses 4.6 (3)(a) and (b) of WLEP.

Details: The proposed height is not considered compatible with the height, bulk and scale of the desired future character of the locality contrary to clause 4.3 (1) (a) and (d) of WLEP.

b. Clause 4.4 Floor Space Ratio

The application exceeds the maximum allowable Floor Space Ratio (FSR) of 0.63:1 and the applicant's written request under clause 4.6 of WLEP has failed to adequately address the required matters under subclauses 4.6 (3)(a) and (b) of Waverley LEP

Details: The proposal is considered an overdevelopment of the site and does not preserve the surrounding locality as required under clause 4.4 (1) (d) of WLEP. Furthermore, the applicant's FSR calculations contained within the written request to vary the development standard under Clause 4.6 are incorrect.

2. The application does not satisfy section 4.15 (1)(a)(iii) of the Act as it is contrary to Waverley Development Control Plan (WDCP) 2012, in respect to the following provisions:

Part B12 Design Excellence


a. Controls (e) (iv) and (v) under this Part, as the proposal increases the bulk of the building in relation to other developments on adjoining neighbouring sites. Further increasing the overdeveloped nature of the site compared to adjacent sites.

Part C2 Low Density Residential Development

- a. Section 2.0 General Objectives, specifically objectives (a), (d) and (e) as the proposed development increases the scale and bulk of the already overly developed site beyond other dwellings in the vicinity and is inconsistent with the desired future character of the area.
- b. Section 2.3 Streetscape and Visual Impacts, specifically objective (a) and (b) and control

 (a) as the increase in bulk is incompatible with the streetscape. At the same time, it
 introduces a new and incompatible dormer style to the existing development.

- c. Section 2.11 Dormer Windows, specifically objective (a) and (b) and control (c) and (d) as the proposed dormer window roof abutment is within 300mm of the existing roof ridge and the style of the proposed dormer window does not match the existing development and is greater than 25% of the width of the roof.
- d. Section 2.13 Semi-detached dwellings & Terrace Style Dwellings, specifically objective (a) and (c) as the proposed dormer extension does not match the style of the existing development.
- e. *Section 2.13.1 Built Form,* specifically control (d) as the style of the existing dormer window is not maintained across the proposed development.
- f. Section 2.13.1 First Floor Additions to Semi-detached Dwellings, specifically control (j) as the proposed development does not limit the rise of the wall along the adjoining semi-detached dwelling to be within 600mm.
- g. Section 2.13.3 Material Finishes and Detail for Semi-Detached Dwellings, specifically control (a) and (d) as the proposed addition style does not cohesively integrate with the existing building as the proposed dormer window does not match the characteristic of the original style of the subject dwelling.
- 3. The application does not satisfy section 4.15 (1)(a)(iv) of the Act with respect to the *Environmental Planning and Assessment Regulation 2000* (the Regulations), as insufficient documentation has been provided to properly assess the application with respect to Part 1 of Schedule 1, including but not limited to:
 - a. The written request to vary the FSR development standard includes incorrect calculations and as such the document is inaccurate. The applicant has incorrectly excluded the gross floor area of lot 2 of the approved Strata scheme for the subject site in FSR calculations.
- 4. The application does not satisfy section 4.15 (1)(b) of the Act as the proposed development is excessive in terms of its building massing, bulk and scale relative to the site area and dimensions, and consequently results in unacceptable amenity and streetscape impacts upon the locality and surrounding built environment.
- 5. The application is contrary to section 4.15 (1)(c) of the Act due to the site being unsuitable to accommodate the proposed development.
- 6. The application is contrary to section 4.15 (1)(e) of the Act in relation to the public interest as it is not compatible with the existing and desired future character of the locality and the broader Waverley local government area.

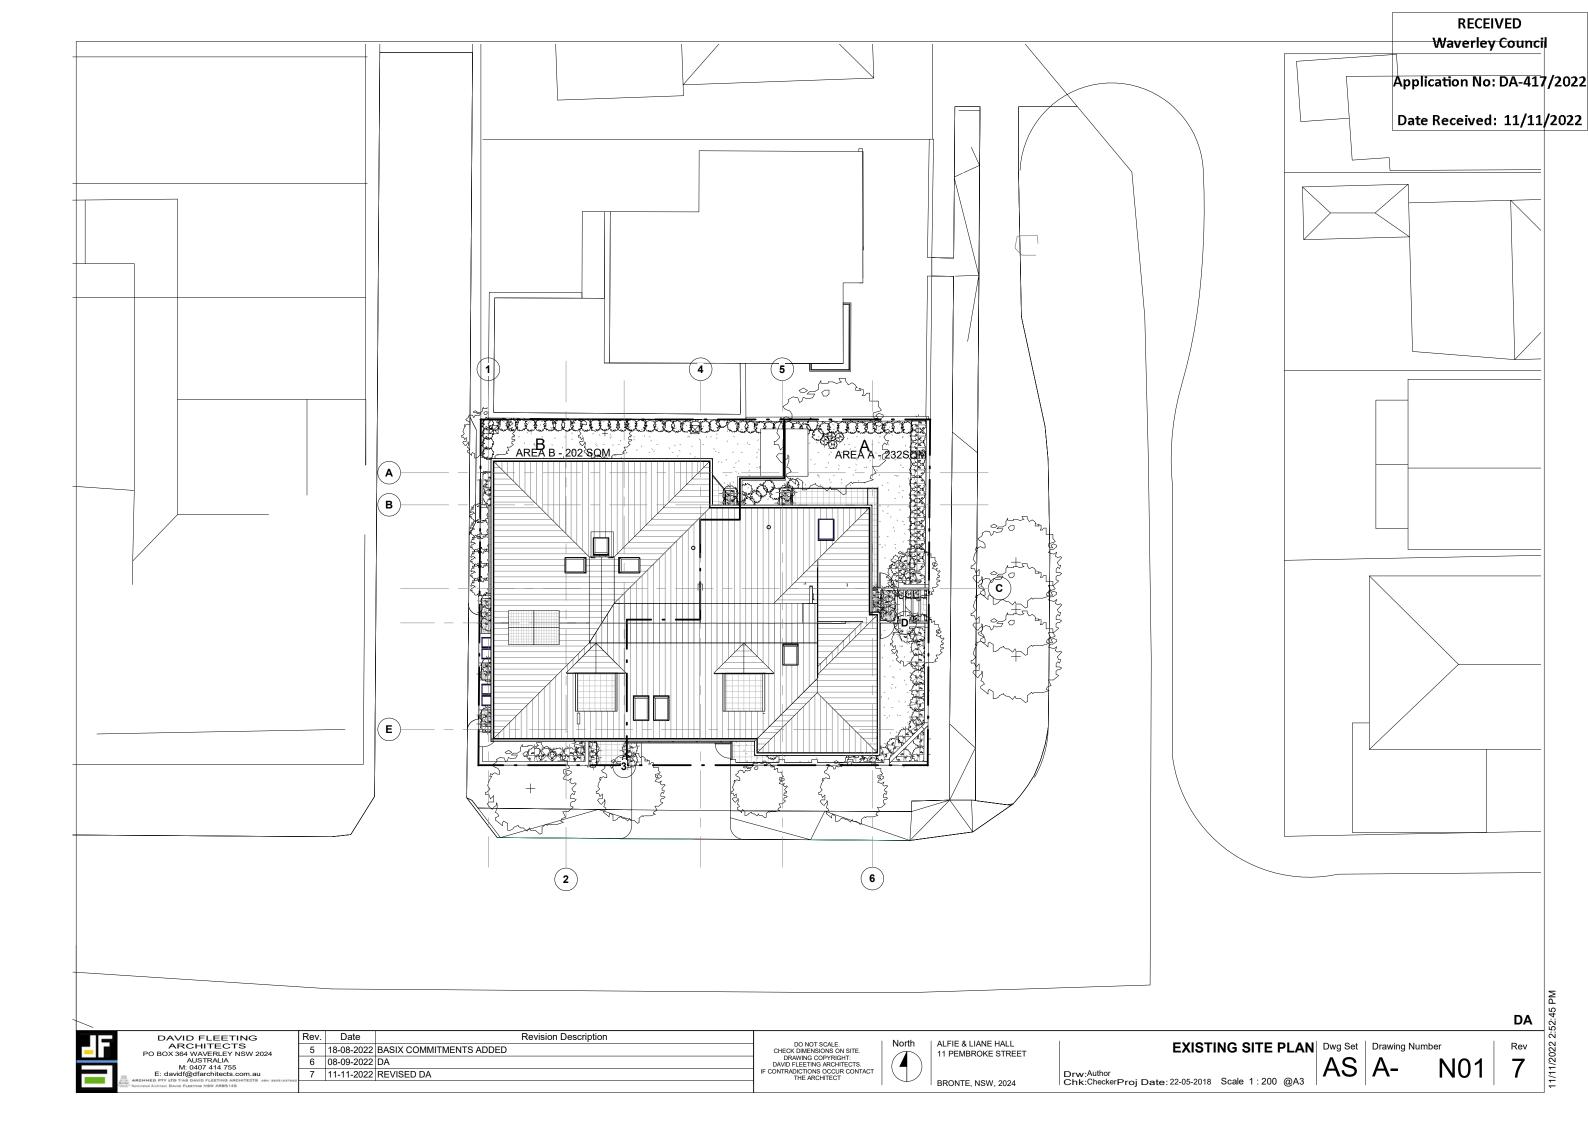

Application No: DA-417/2022

Date Received: 11/11/2022









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BRONTE, NSW, 2024

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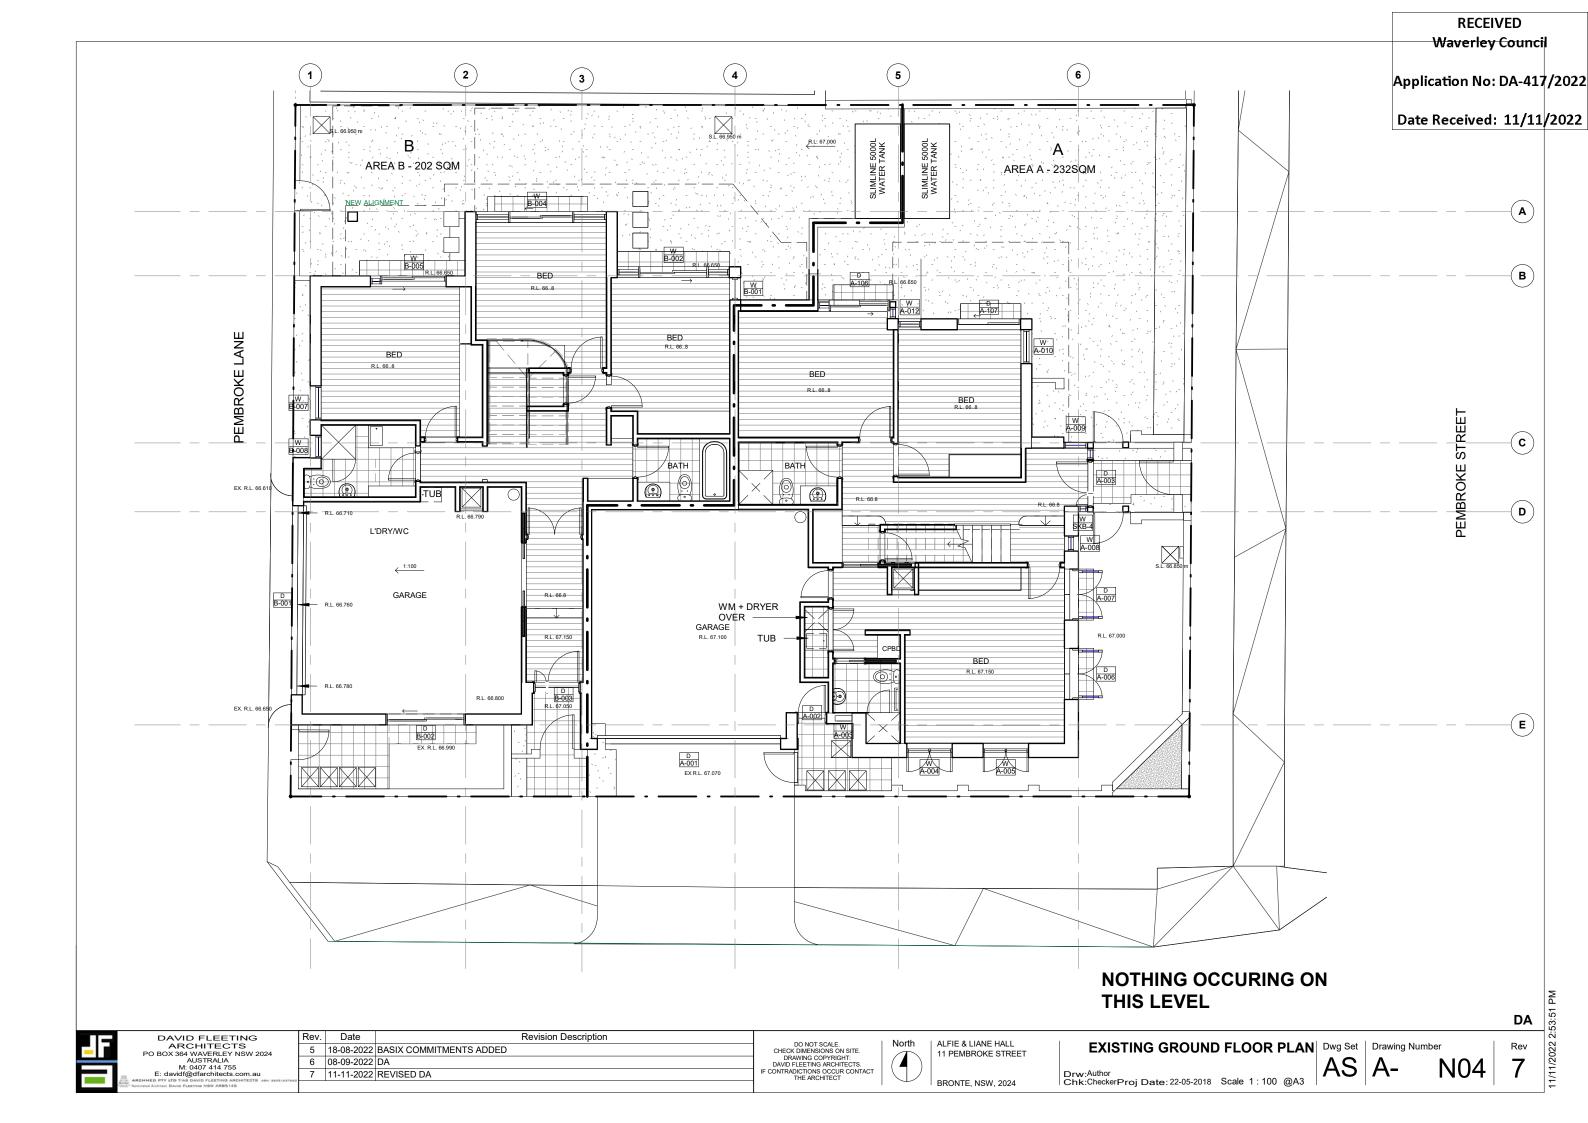
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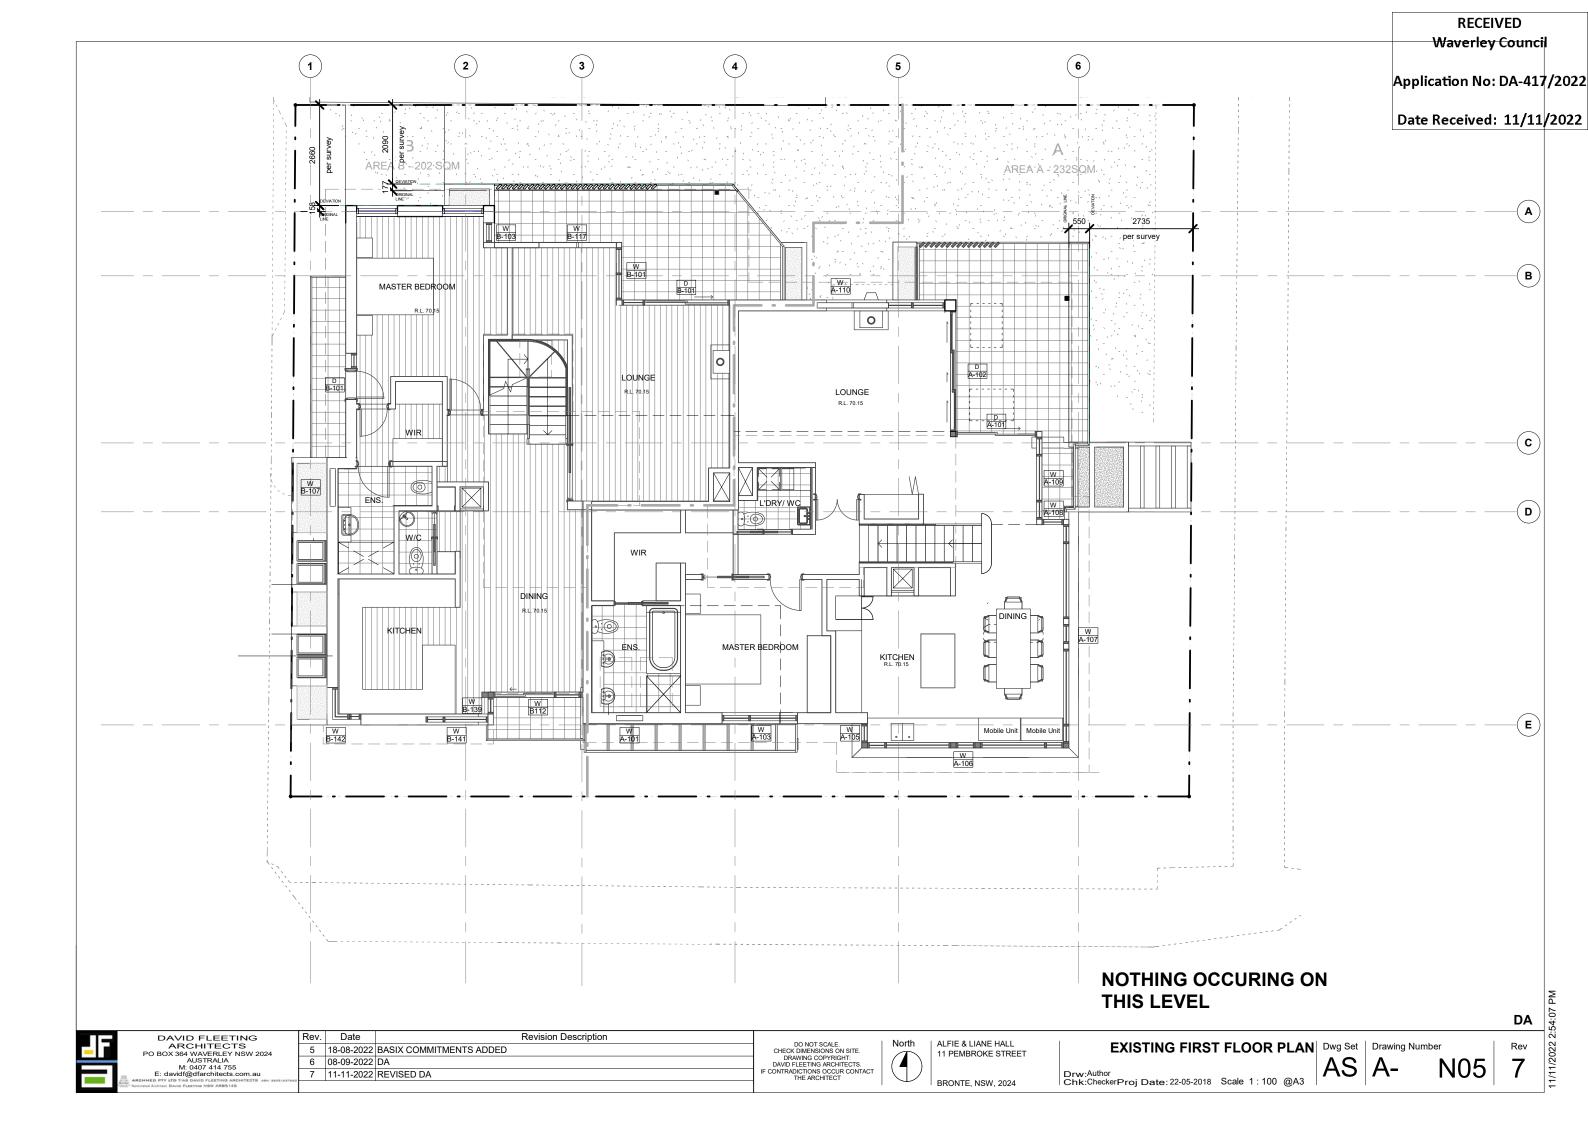
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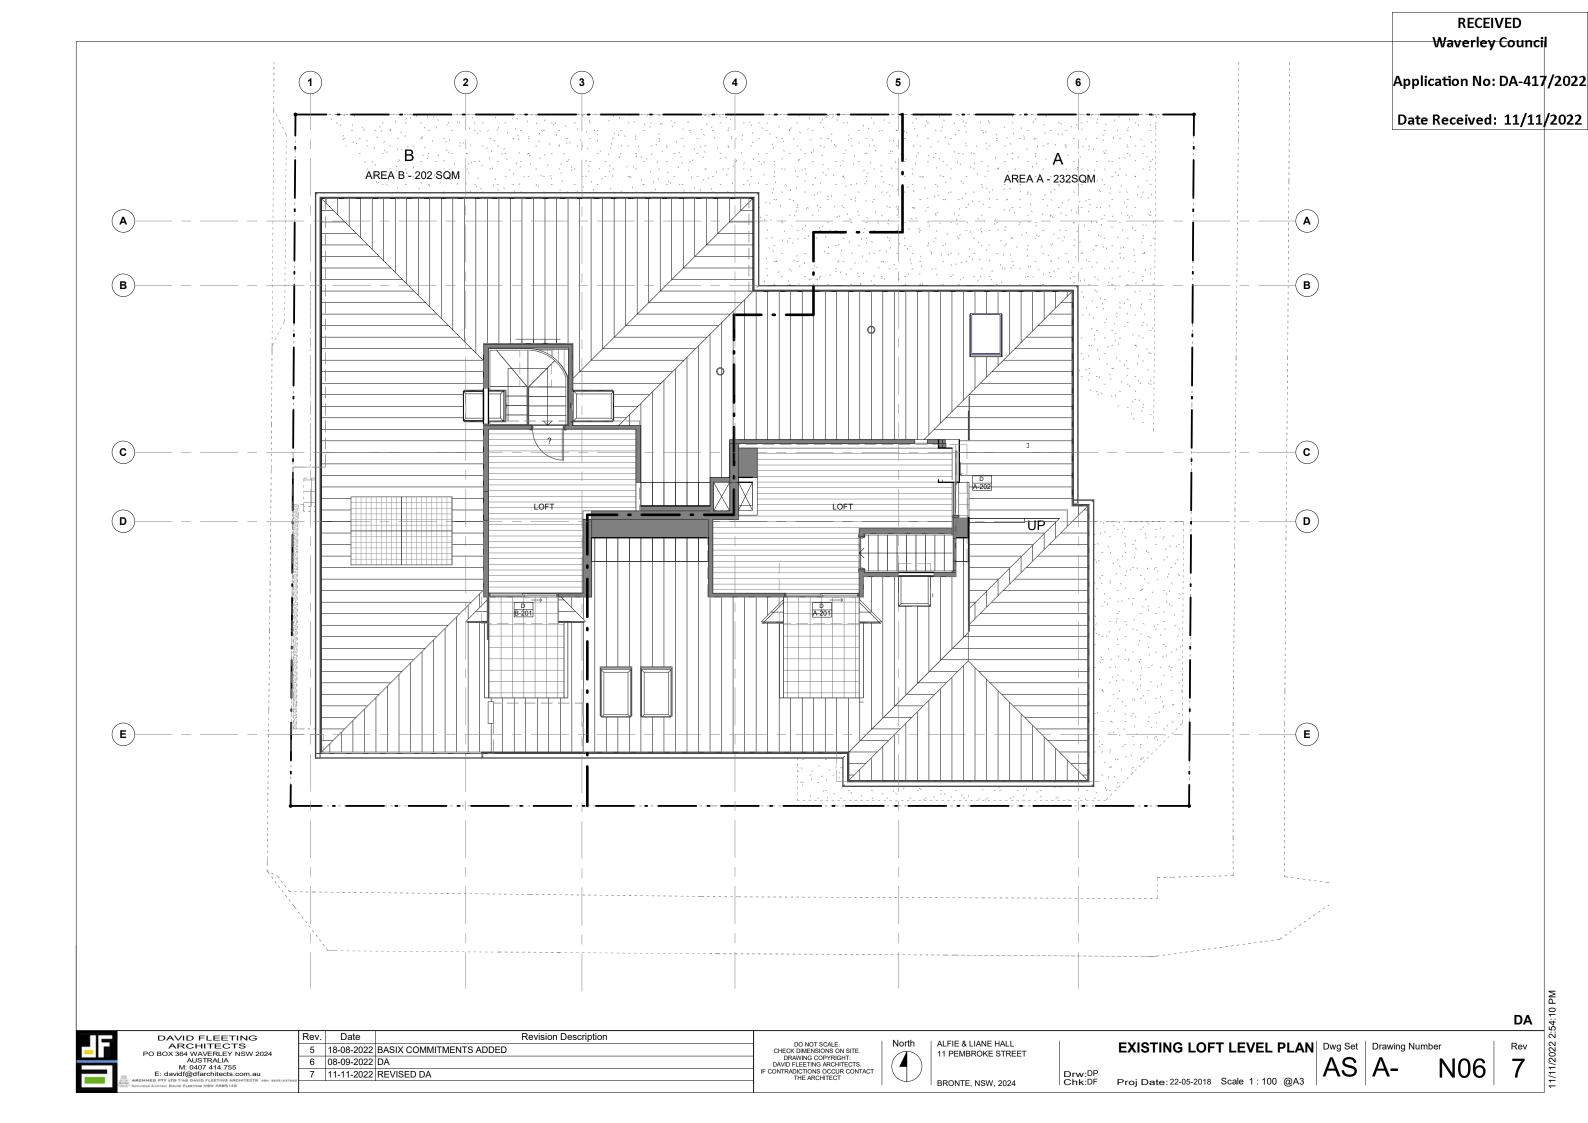
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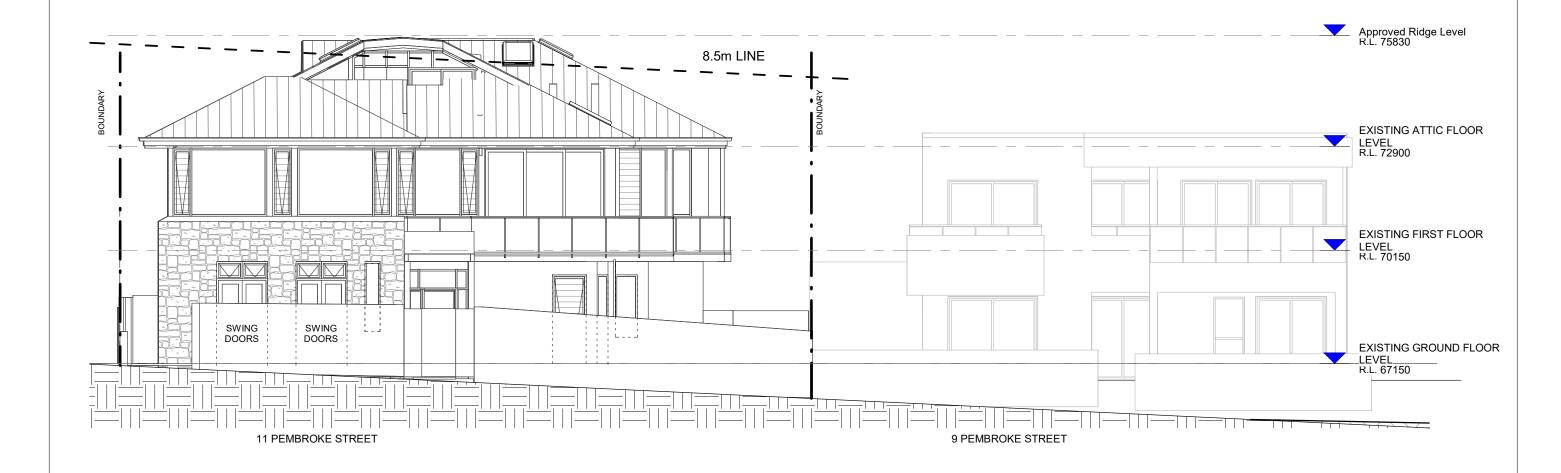
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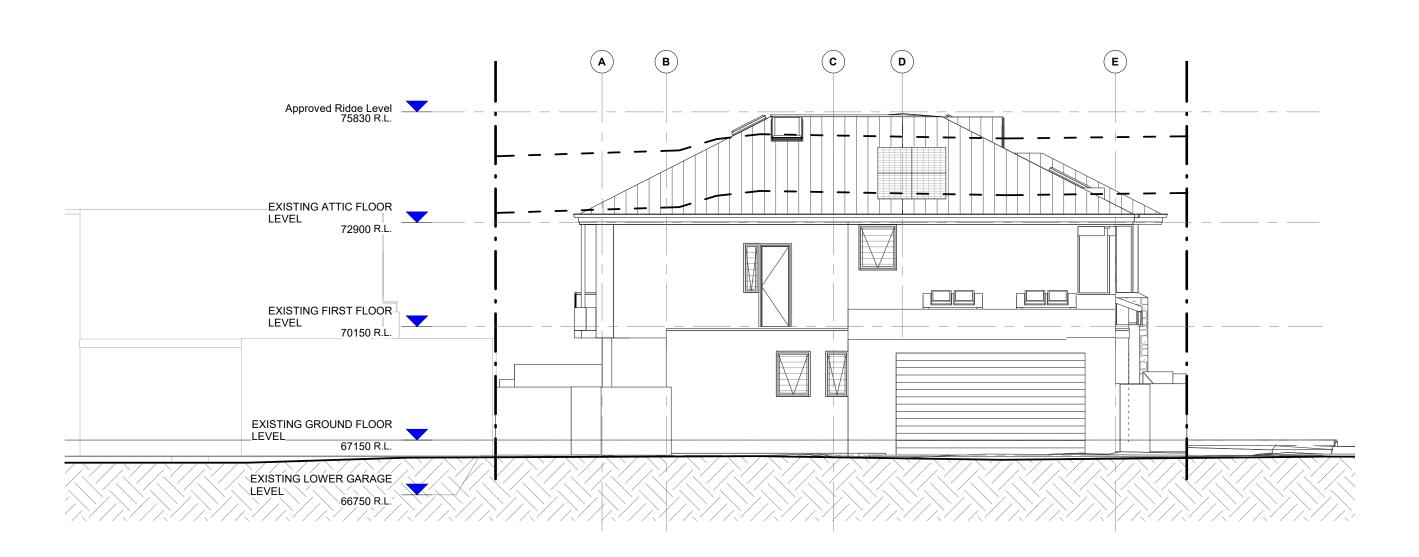


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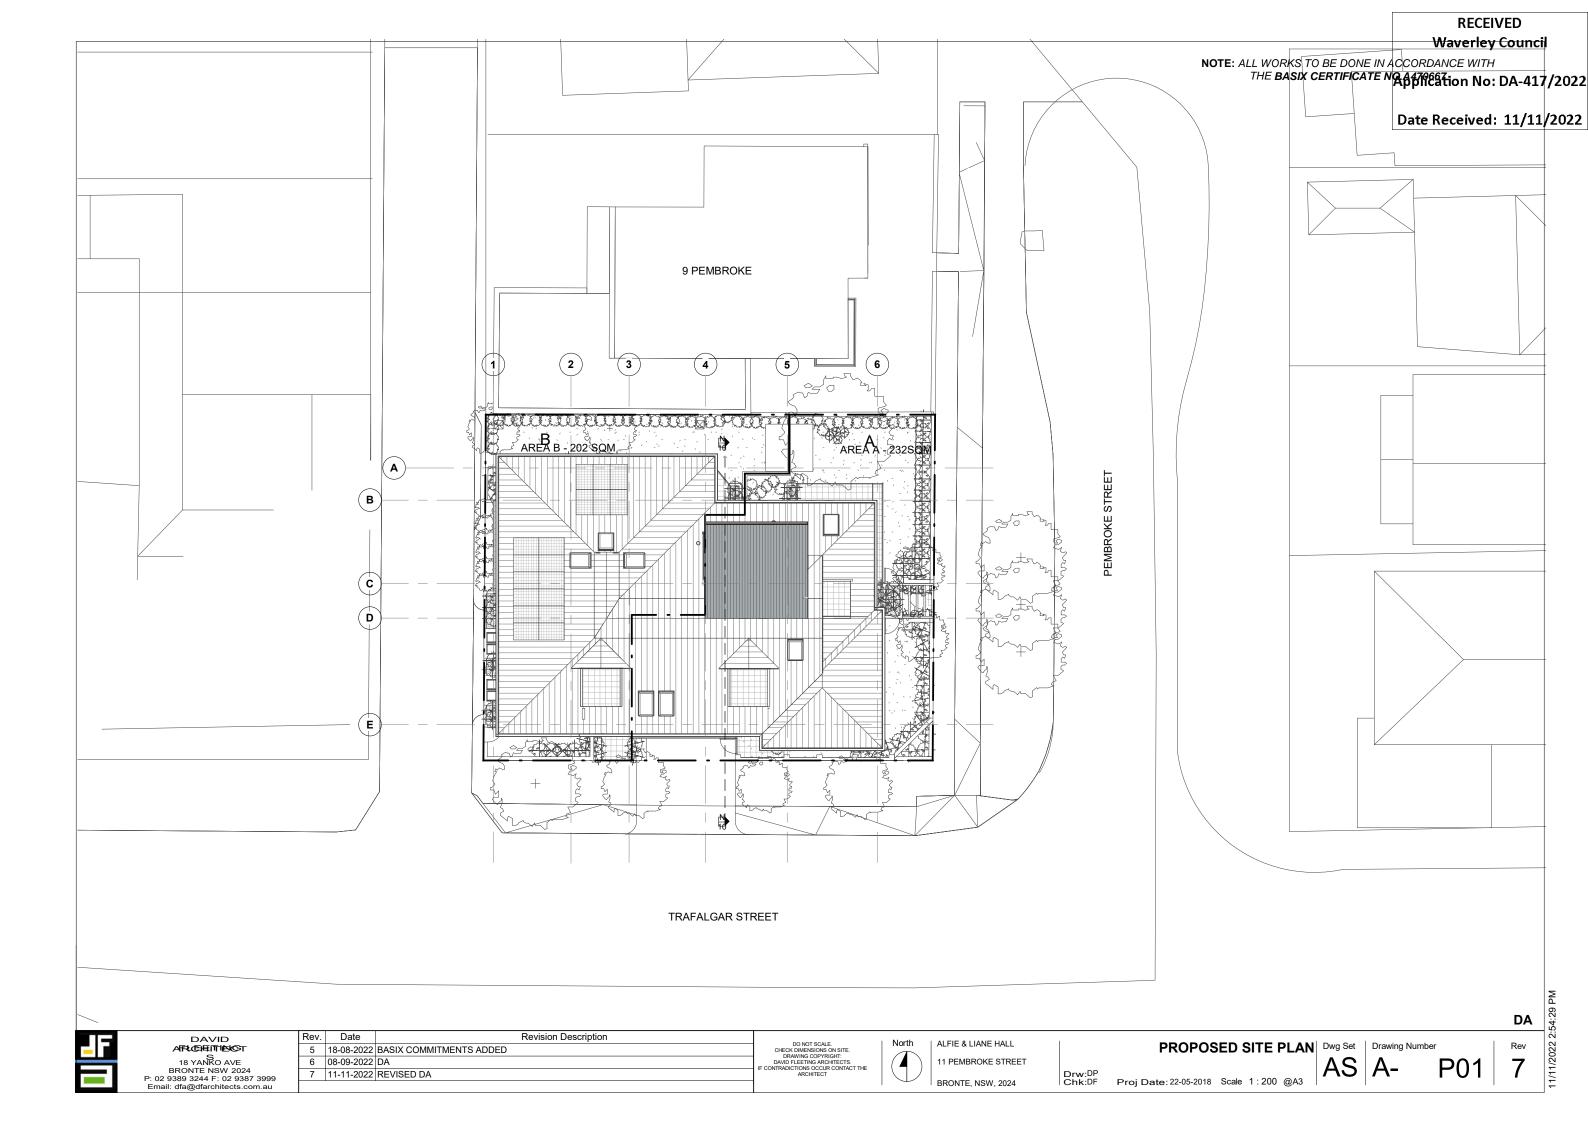
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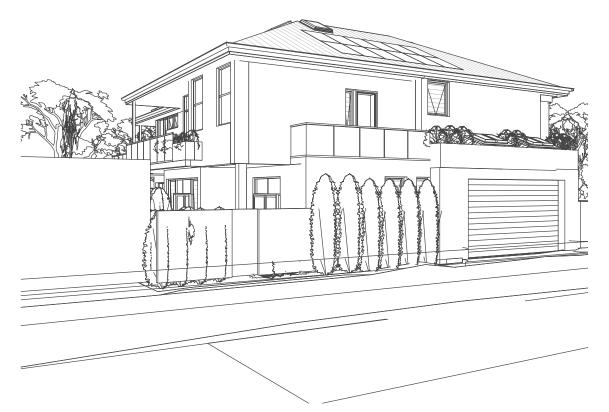
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PROPOSED EYE LEVEL EAST



PROPOSED EYE LEVEL WEST

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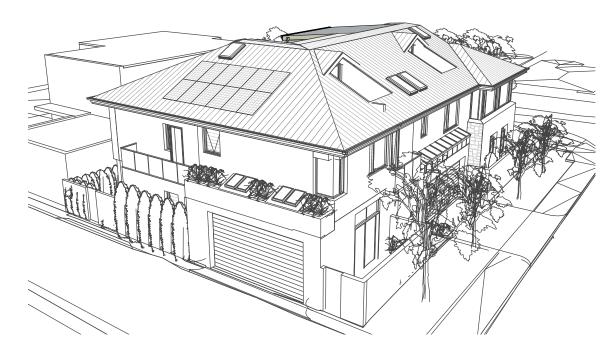
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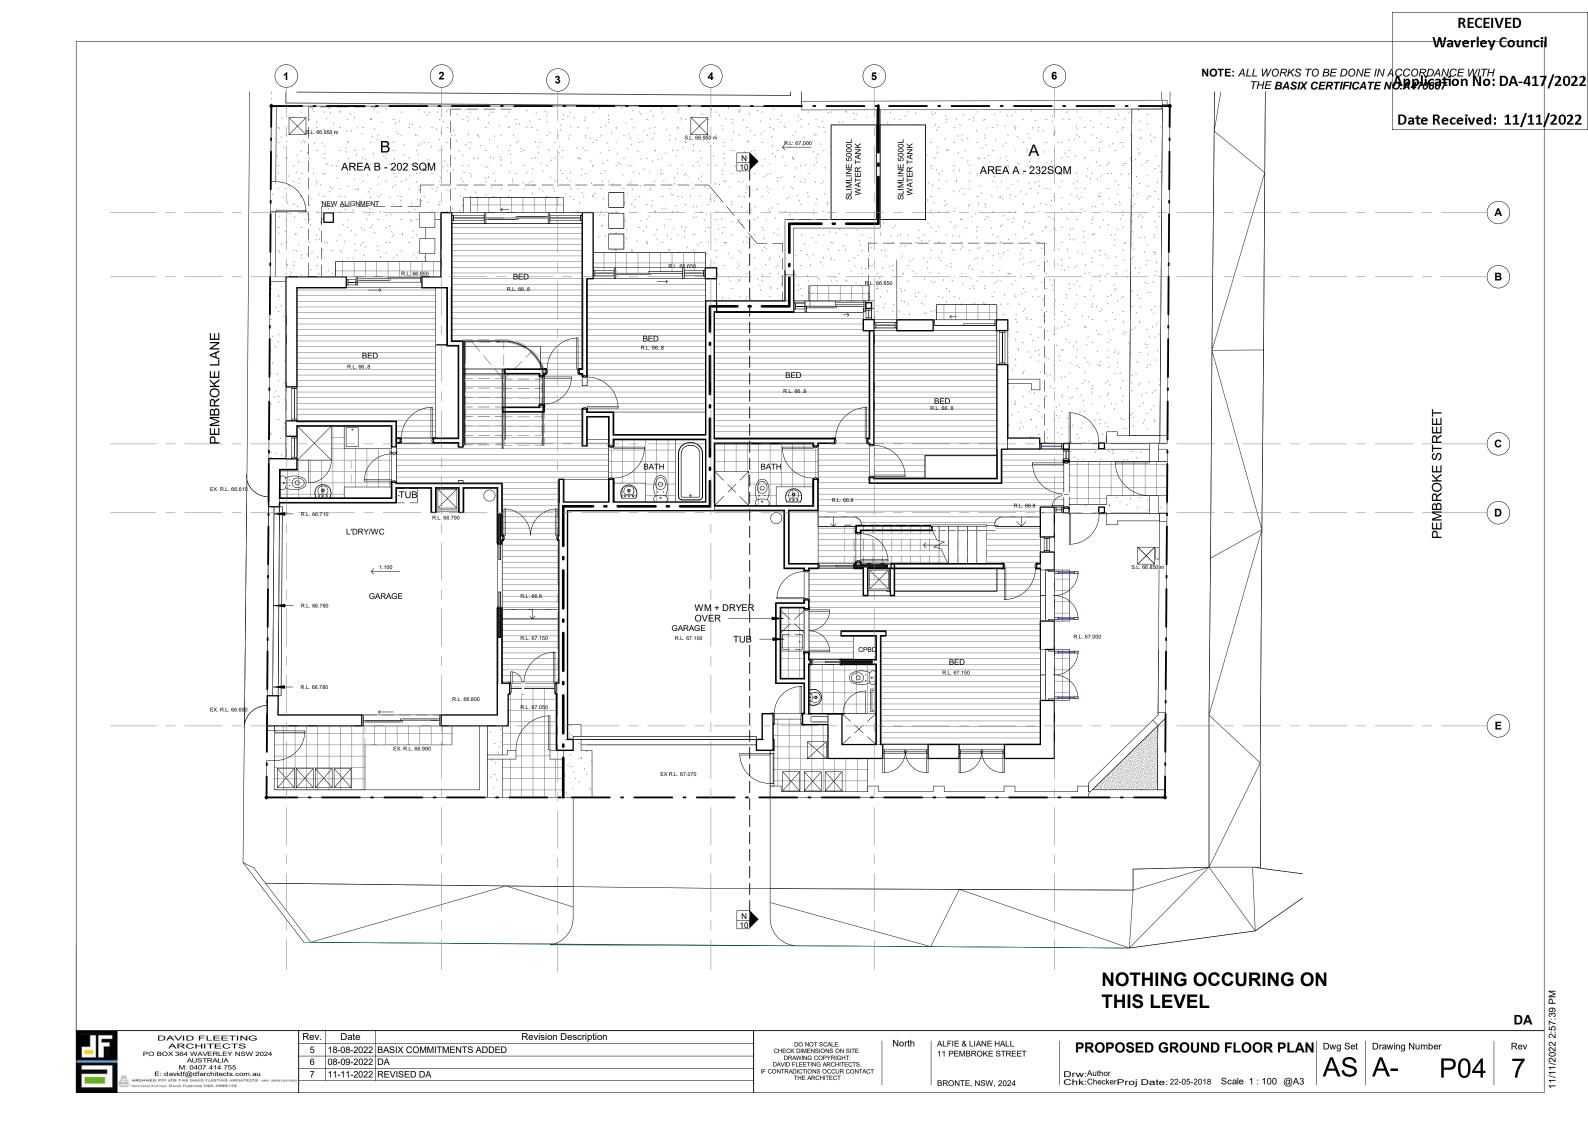
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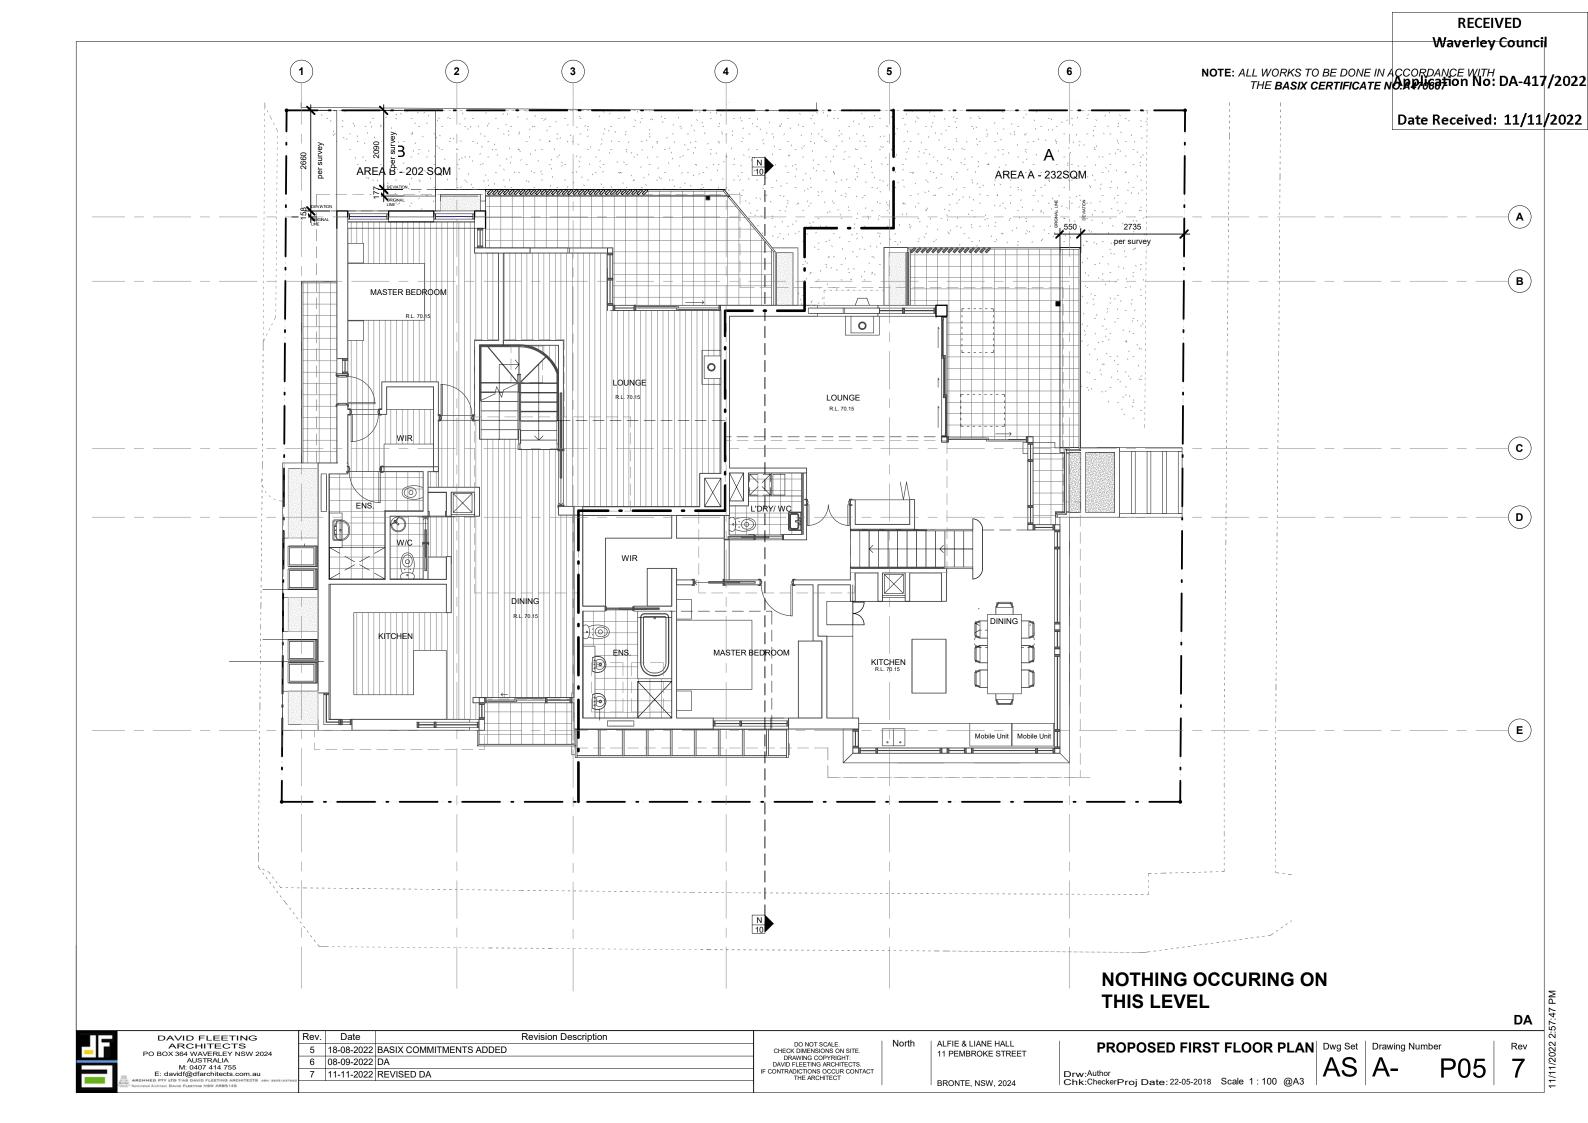
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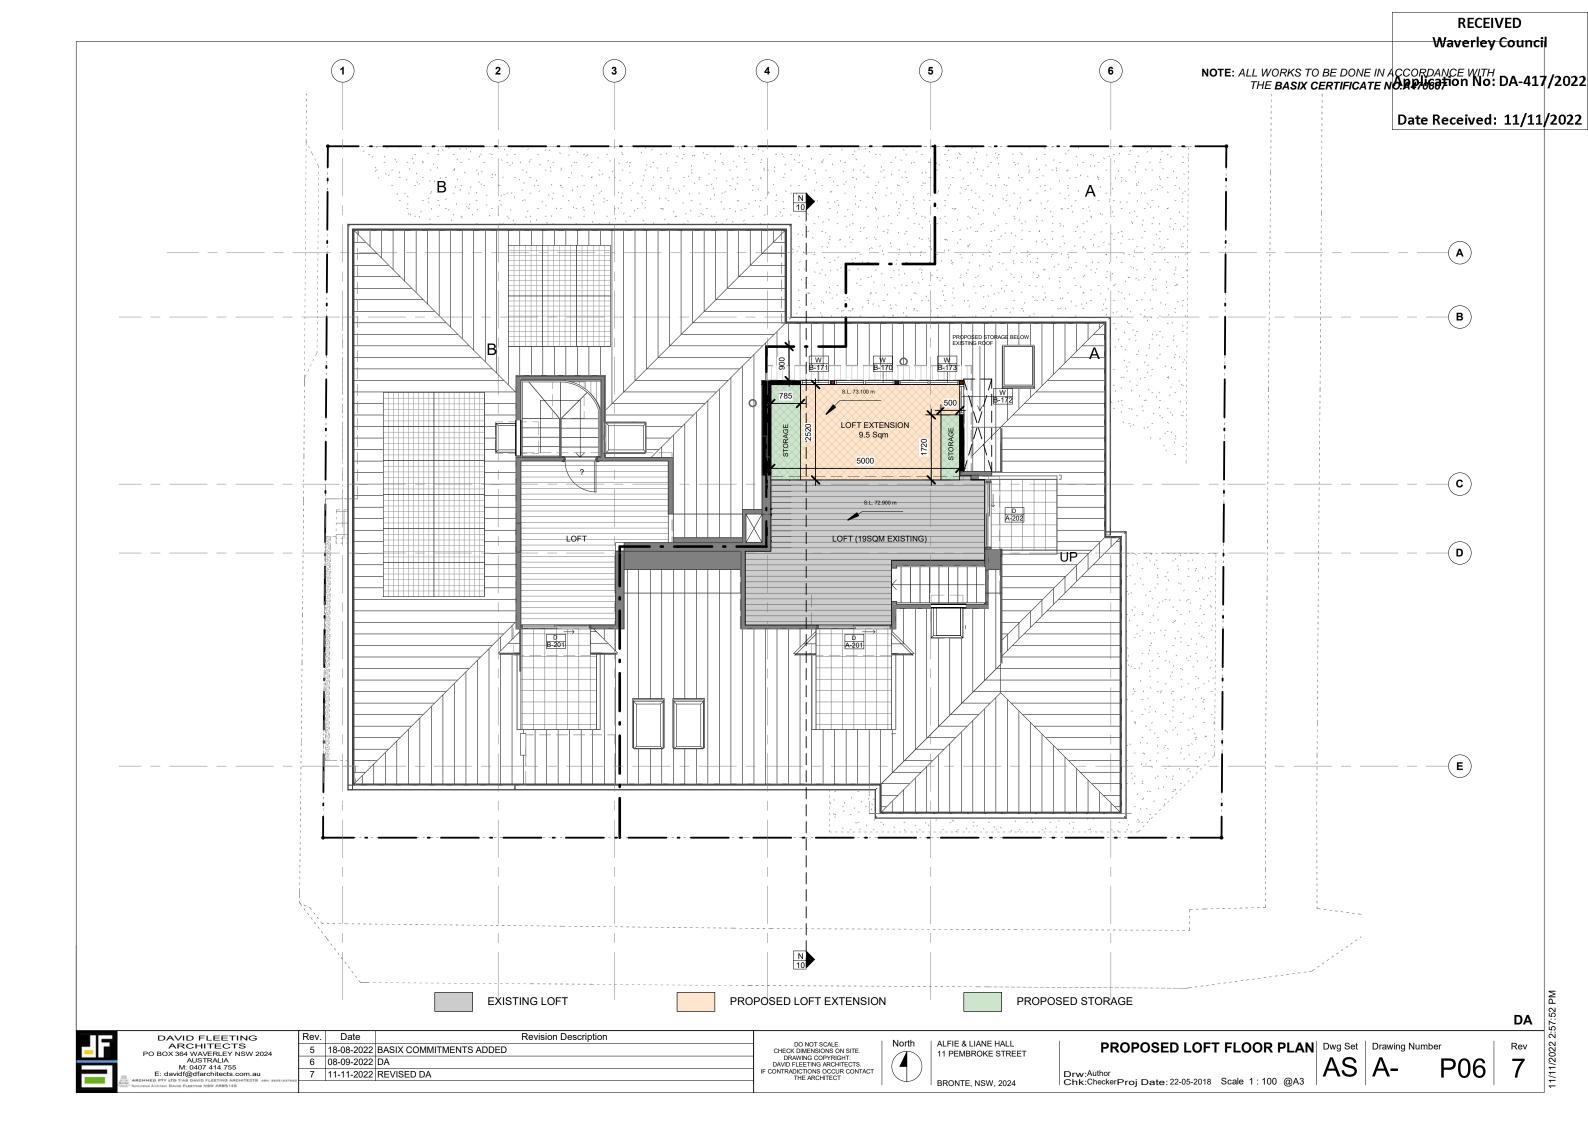
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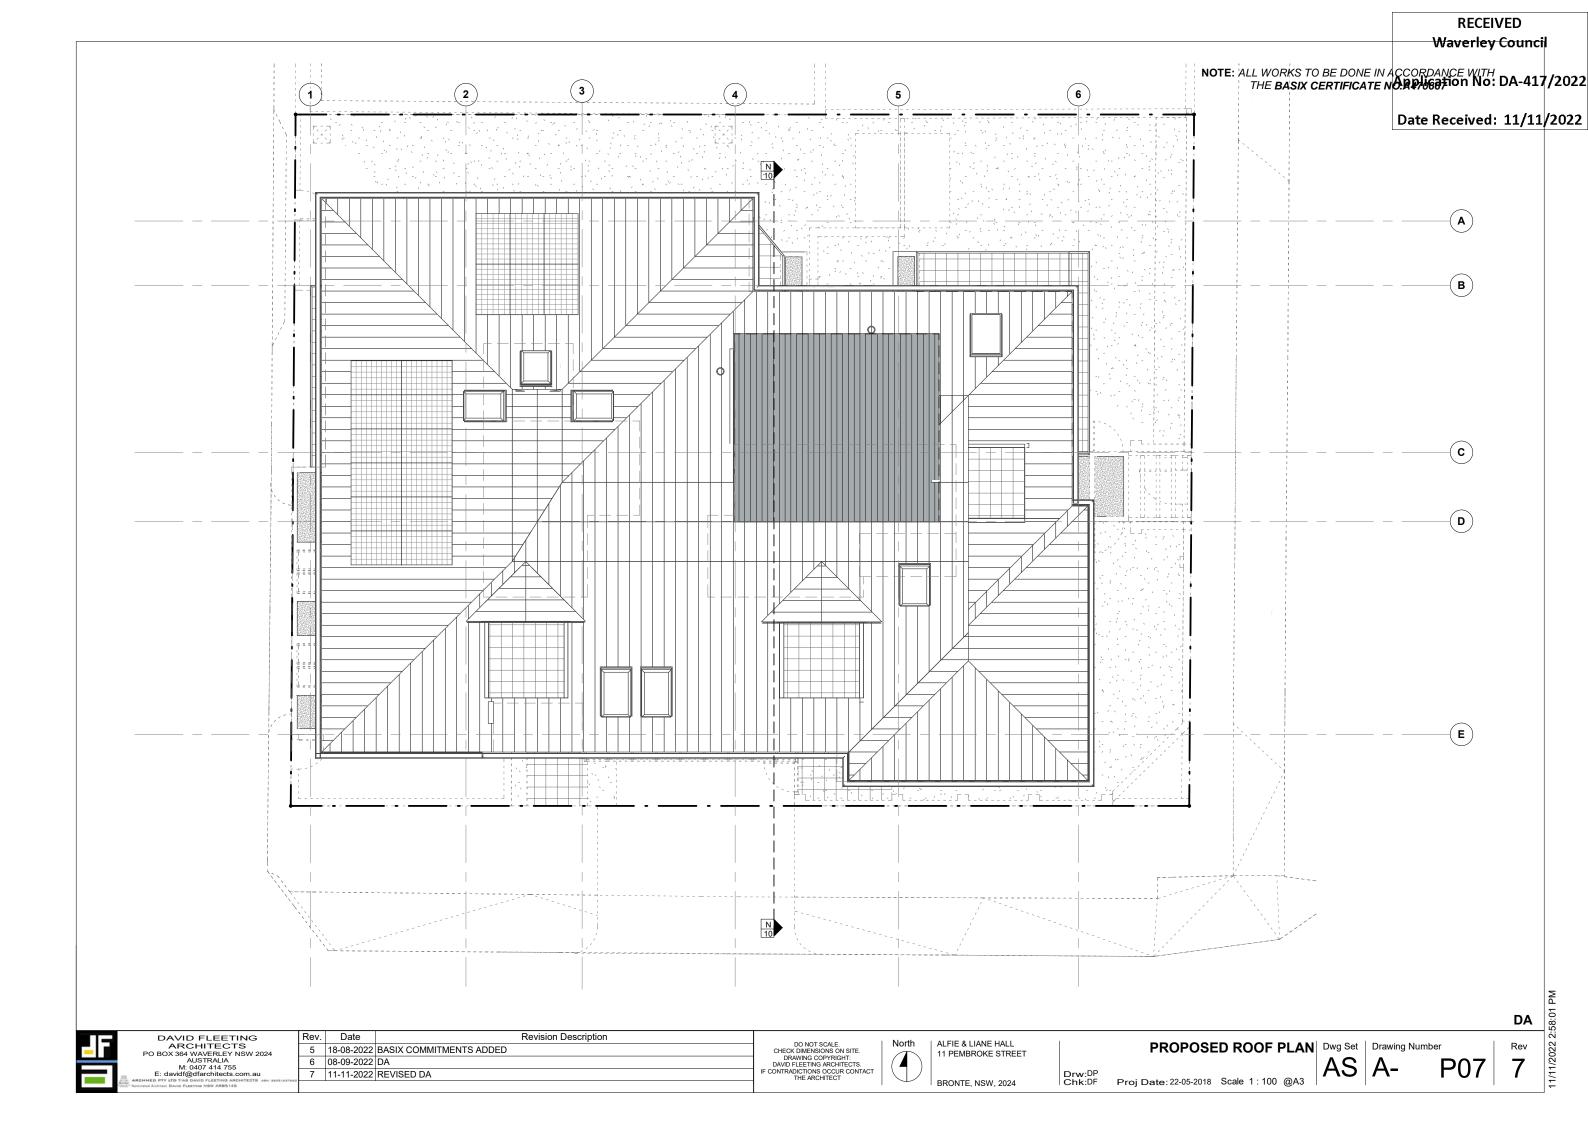
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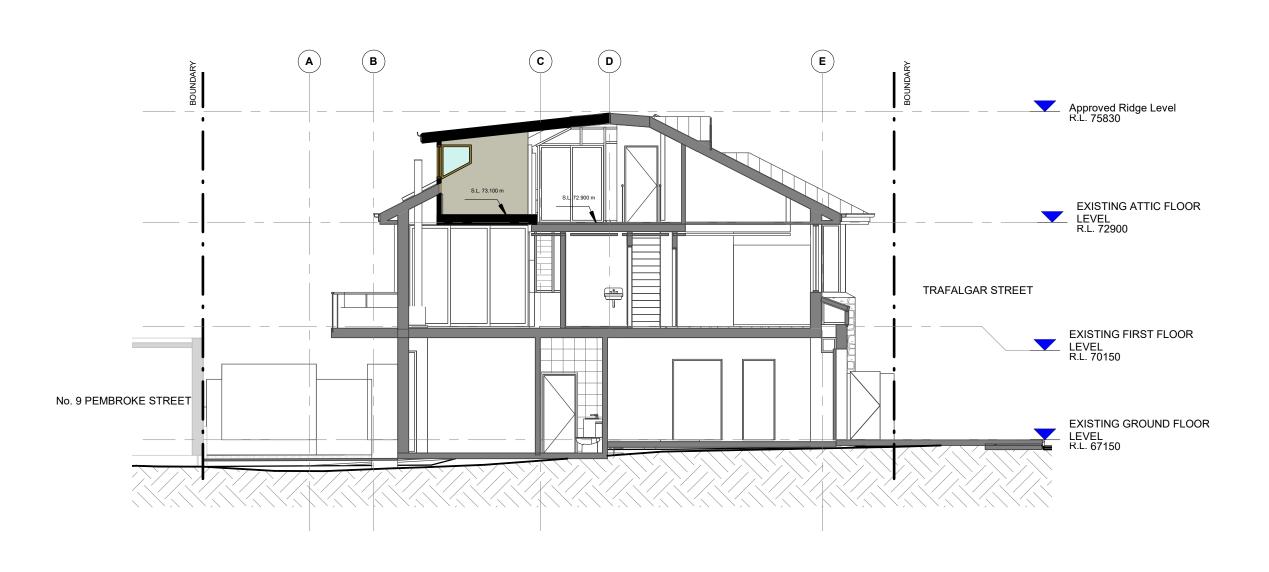






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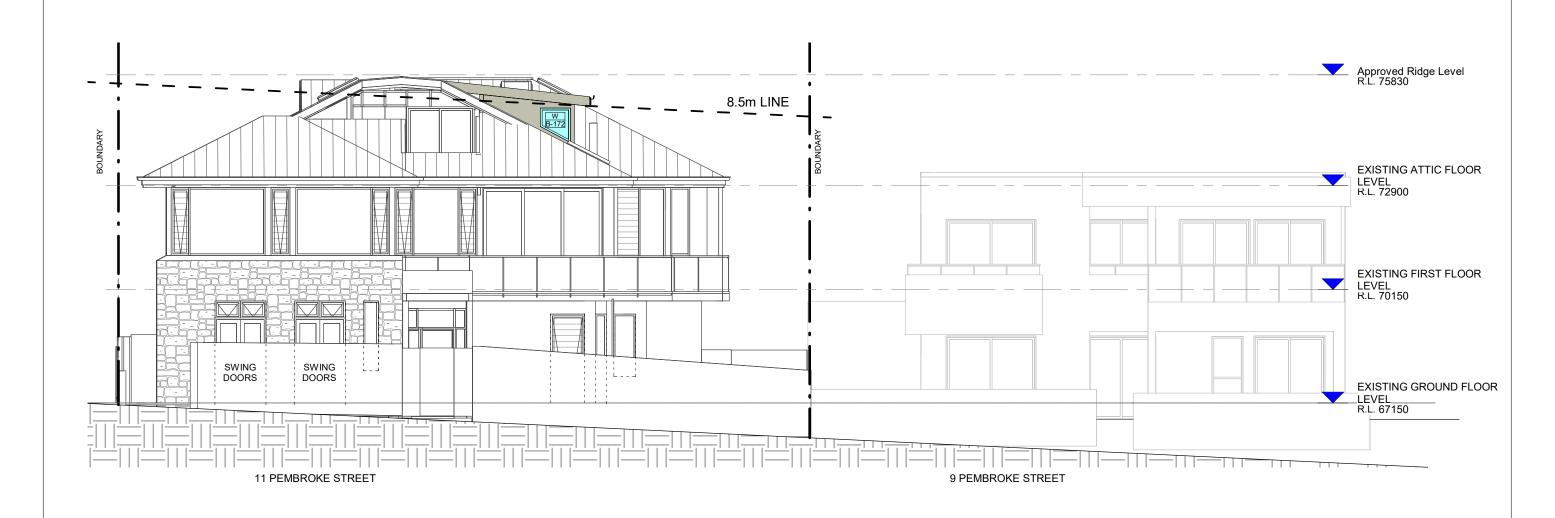
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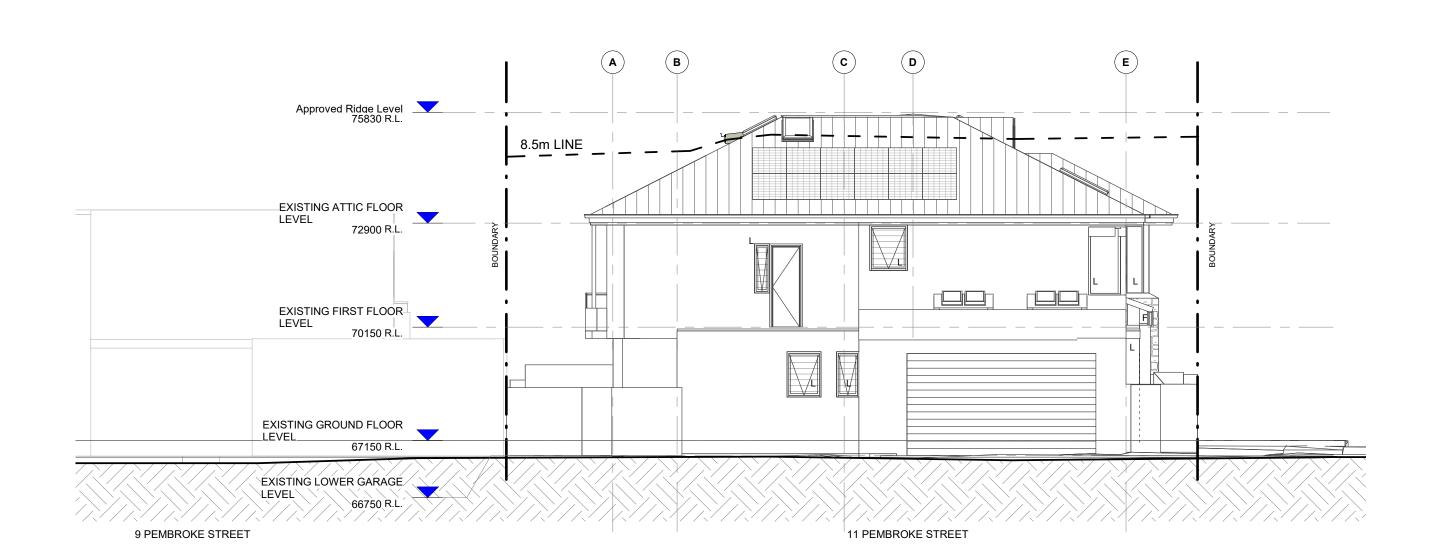
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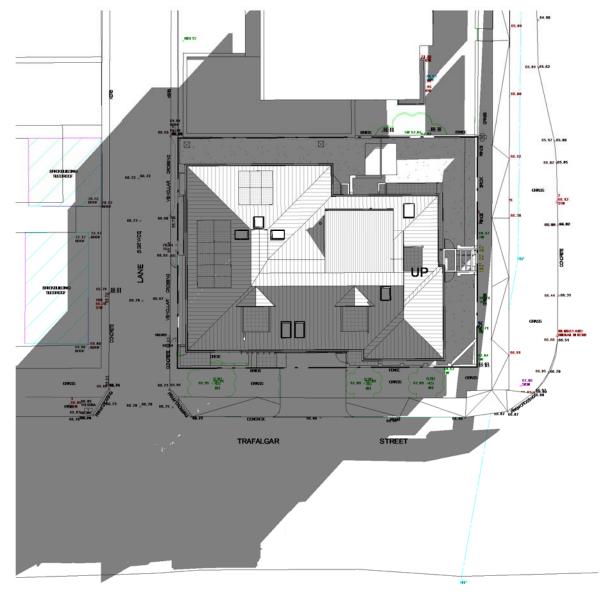
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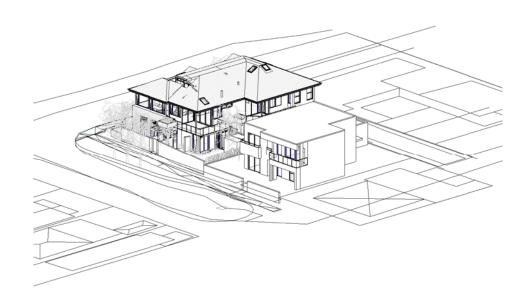
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EXISTING SHADOW - JUNE 22 - 9AM

PROPOSED SHADOW - JUNE 22 - 9AM



Waverley Council Receipt No: DA-417/2022

EXISTING VIEW FROM THE SUN

PROPOSED VIEW FROM THE SUN

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SUN STUDY - June 22 9am | Dwg Set | Drawing Number

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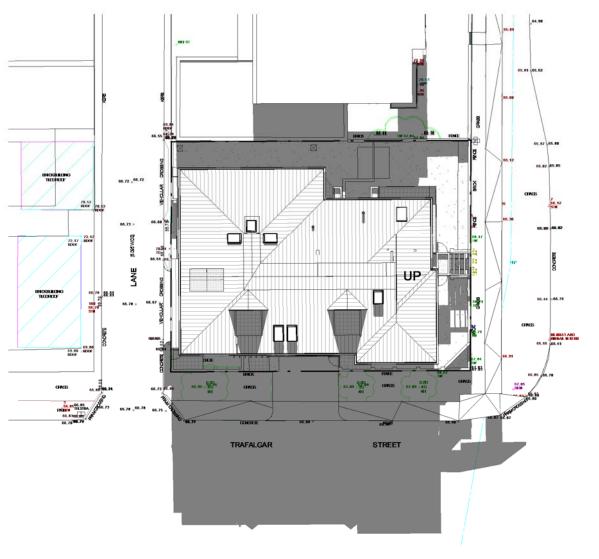
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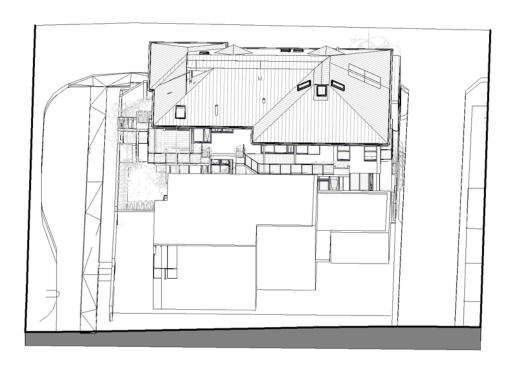
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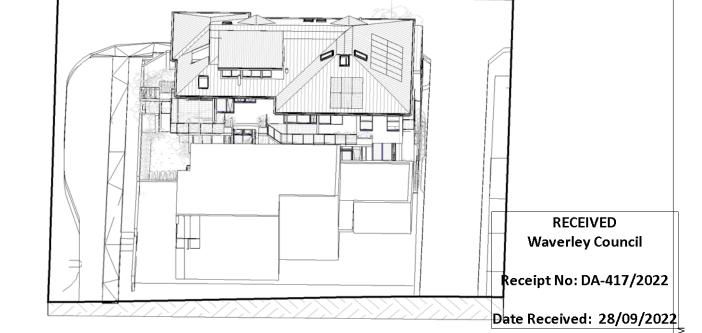




EXISTING SHADOW - JUNE 22 - 12PM

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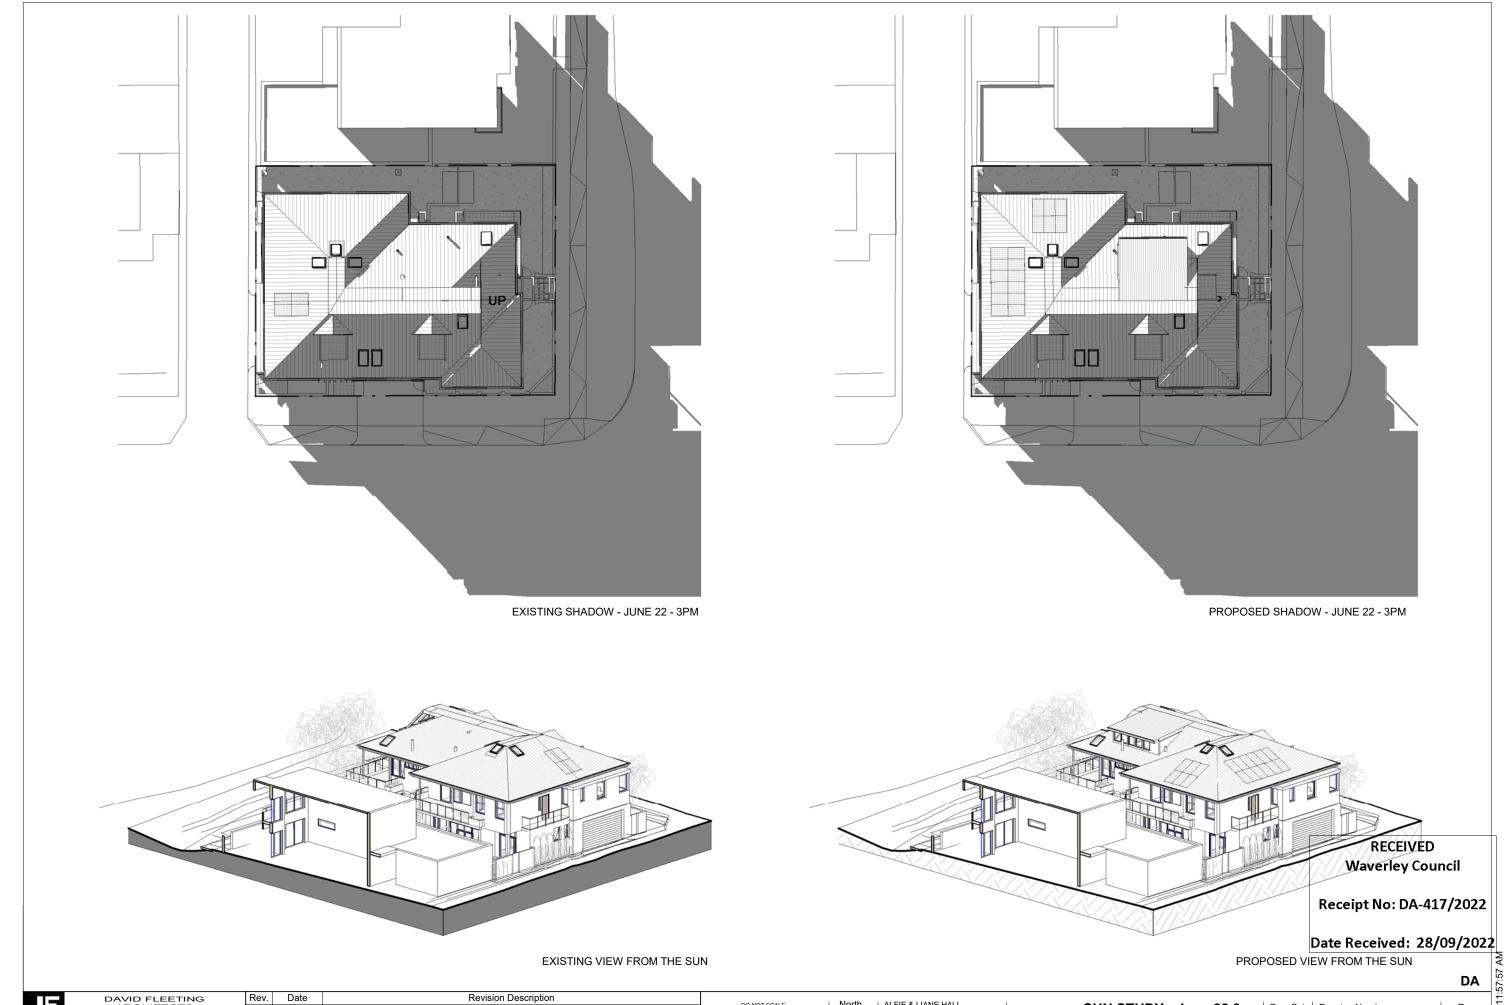
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BRONTE, NSW, 2024

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ALFIE & LIANE HALL 11 PEMBROKE STREET

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Report to the Waverley Local Planning Panel

Application number	D-288/2022	
Site address	446 Bronte Road, BRONTE	
Proposal	Alterations and additions to a dwelling house, including an extension to the carport	
Date of lodgement	07 July 2022	
Owner	Ms A C Melhuish	
Applicant	Studio Redux Pty Ltd	
Submissions	Nil	
Cost of works	\$ 80,300	
Principal Issues	FSR exceedance	
Recommendation	That the application be APPROVED in accordance with the conditions contained in the report.	

SITE MAP



1. PREAMBLE

1.1. Executive Summary

The development application seeks consent for alterations and additions to a dwelling house, including an extension to the carport at the site known as 446 Bronte Road, BRONTE.

The principal issue arising from the assessment of the application is a variation to the floor space ratio (FSR).

The assessment finds this issue acceptable as the proposal does not result in unreasonable amenity impact upon surrounding properties and maintains the consistency of the streetscape.

No submissions were received.

The application has been assessed against the relevant matters for consideration under section 4.15(1) of the *Environmental Planning and Assessment Act 1979*. It is recommended for approval subject to conditions of consent.

1.2. Site and Surrounding Locality

A site visit was carried out on 16 August 2022.

The site is identified as Lot 7 in DP 11382, known as 446 Bronte Road, Bronte.

The site is rectangular in shape with a frontage to Bronte Road, measuring 8.705m. It has an area of 575.1m² and it falls from the street frontage towards the rear by approximately 9.46m.

The site is occupied by a three-storey detached dwelling house with vehicular access provided from Bronte Road to a single carport.

The site is adjoined by two and three-storey detached dwelling houses on either side. The locality is characterised by a variety of low density residential development.

Figures 1 to 8 are photos of the site and its context.



Figure 1: Streetscape view of the subject site



Figure 2: Streetscape view opposite the subject site



Figure 3: Side passage access to the subject site



Figure 4: Front office view of the subject site



Figure 5: Front view of the subject site



Figure 6: View down side passage of the subject site



Figure 7: View of the proposed bedroom area of the subject site



Figure 8: View of the proposed bedroom area of the subject site

1.3. Relevant Development History

A search of Council's records revealed the following recent and relevant development history of the site:

DA-806/2004

- Approved 03/05/2005
- Demolition of existing two storey cottage and construction of new two/part three-storey dwelling with garage.

DA-806/2004/A

- Approved 26/08/2005
- Section 96 for an extension to the basement.

DA-806/2004/B

- Approved 07/02/2007
- Amended plans to alter the approved new dwelling.

1.4. Proposal

The development application seeks consent for alterations and additions to a dwelling house, specifically the following:

- Extension at the lower ground floor level to provide a bedroom within an existing undercroft area.
- Extension of the existing single carport to provide a double carport.
- Extension of the existing storage area (studio/gym) beneath the carport.
- New external stairs to the street.

1.5. Background

The development application was lodged on 7 July 2022 and deferred on 17 October 2002 for the reasons listed following. A comment is included after each issue to summarise the response from the Applicant in regard to each matter:

1. FLOOR SPACE RATIO

Please amend your floor space ratio to include the following:

- a. Storage area underneath the carport and all associated internal walls.
- b. Exclude staircase 5 on the ground floor (Bedroom level) and include staircase 5 on the Lower ground floor (Basement level) with all internal walls.

Planner comment: The gross floor area (GFA) plans and calculations were amended as requested.

2. BIODIVERSITY

The property lies within the identified coastal biodiversity corridor, so under the DCP Section 3.2.2 (a). A minimum of 50% of the proposed trees, 50% of the shrubs and 50% of the grasses and groundcovers (not including turfed areas) are to be indigenous or local native plants listed in Annexure B2-1.

a. Please submit a landscape plan addressing the above-stated control.

Planner comment: The applicant has clarified that no landscaping is proposed as part of this application and as such no landscape plan has been submitted.

3. CAR PARKING

The proposed garage door does not comply with Part C2Section 2.8.1 control (b) and Section 2.8.4 control (a and b) of the Waverley DCP 2012. No other carport within the visual catchment includes a garage door. As such, it is recommended that the Architectural Drawings be amended to show a gate or retain an open carport design. However, if a garage door is still proposed, greater justification for the necessity and/or requirement of a garage door is required.

Planner comment: The garage door has been retained in the amended plans and the Applicant has provided greater justification in support. This is discussed within the report.

After consulting with Council's Traffic Engineers, amend the architectural drawings to show the following:

- a. Minimum internal width of 5.4 metres for the carport to accommodate 2 car parking spaces.
- b. A maximum grade of 1:20 (5%) for the parking spaces
- c. Maximum grade transitions of 12.5% for summit grade changes and 15% for sag grade changes.
- d. Driveway design in accordance with Council's standard drawing for a double garage (R5 Double Driveway Crossing and Layback).

Planner comment: The amended plans have addressed this matter as requested.

4. FRONT FENCE

The proposed front fence does not comply with Part C2Section 2.4 control (a, b and c). The front fence exceeds the maximum average of 1.2m. Please amend the Architectural Drawings showing a front fence with maximum average of 1.2m in height (tapering with the slope).

Planner comment: The amended plans have retained the existing front fence.

5. ARCHITECTURAL DRAWING AMENDMENTS

Please amend or provide the following:

- a. Architectural drawings show multiple drawing scales, please remove incorrect drawing scales from drawing set.
- b. Architectural drawings are missing RL's to AHD on all sections and elevations.
- c. A side setback drawing discrepancy is evident regarding the storage/gym extension underneath the carport. The setback of the side extension to the storage/gym is to match the carport side setback shown above.
- d. Please removal bubbles exempt for those showing the amendments made for this deferral.

Planner comment: The amended plans have addressed this matter as requested.

6. FURTHER INFORMATION

Please provide the following additional information:

a. Survey Plan

Planner comment: Survey plan provided as requested.

2. ASSESSMENT

The following matters are to be considered in the assessment of this development application under section 4.15 of the *Environmental Planning and Assessment Act 1979* (the Act).

2.1. Planning Instruments and Development Control Plans

The following is an assessment against relevant legislation, environmental planning instruments, including State environmental planning policies (SEPPs), and development control plans.

2.1.1. State Environmental Planning Policies (SEPPs)

The following SEPPs apply from the 01 March 2022 and have been considered acceptable in the assessment of this development application:

- SEPP (Building Sustainability Index BASIX) 2004
- SEPP (Biodiversity and Conservation) 2021
- SEPP (Resilience and Hazards) 2021

2.1.2. Waverley Local Environmental Plan 2012 (Waverley LEP 2012)

The relevant matters to be considered under the Waverley LEP 2012 for the proposed development are outlined below:

Table 1: Waverley LEP 2012 Compliance Table

Provision	Compliance	Comment				
Part 1 Preliminary	Part 1 Preliminary					
1.2 Aims of plan	Yes	The proposal is considered consistent with the aims of the plan.				
Part 2 Permitted or prohibited de	velopment					
Land Use Table R2 Low Density Residential Zone	Yes	The land use is defined as a dwelling house, which is permitted with consent in the R2 low density residential zone.				
Part 4 Principal development star	ndards					
4.4 Floor space ratio and4.4A Exceptions to floor space ratio0.58:1	No	The proposal has a gross floor area (GFA) of 336m ² or an FSR of 0.71:1 exceeding the development standard by 59.3m ² or 22%.				
4.6 Exceptions to development standards	See discussion	The application is accompanied by a written request pursuant to clause 4.6 of Waverley LEP 2012 to vary the Floor Space Ratio (FSR) development standard. A detailed discussion of the variation to the development standard/s is presented below this table.				
Part 6 Additional local provisions						
6.1 Acid sulfate soils	Yes	The proposed works are not likely to lower the water table.				
6.2 Earthworks	Yes	The excavation required for the lower ground floor room extension and studio/storage room under the garage is not expected to have a detrimental impact on environmental functions and neighbouring uses. Standard conditions of consent are recommended concerning earthworks.				

The following is a detailed discussion of the issues identified in the compliance table above in relation to the Waverley LEP 2012.

Clause 4.6 Exceptions to Development Standards

The application seeks to vary the minimum floor space ratio (FSR) development standard in clause 4.4 under Waverley LEP 2012.

The site is subject to a maximum floor space ratio (FSR) development standard of 0.58:1. The proposed development has a FSR of 0.71:1, exceeding the standard by 59.3m² equating to a 22% variation.

A written request has been submitted to Council in accordance with clause 4.6(3)(a) and (b) of Waverley LEP 2012 seeking to justify the contravention of the development standard by demonstrating:

- (a) That compliance with the development standard is unreasonable or unnecessary in the circumstances of the case; and
- (b) That there are sufficient environmental planning grounds to justify contravening the standard.

A copy of the applicant's written request has been provided to the Waverley Local Planning Panel for consideration.

Applicant's Written Request - Clause 4.6(3)(a) and (b)

The applicant seeks to justify the contravention of the FSR development standard on the following basis:

- (a) That compliance with the development standard is unreasonable or unnecessary in the circumstances of the case:
 - (i) minor extent of the FSR variation
 - (ii) nil streetscape impacts to Bronte Road
 - (iii) no traffic and parking impact
 - (iv) no adverse amenity impact on the neighbouring dwellings and the streetscape.
- (b) That there are sufficient environmental planning grounds to justify contravening the standard:
 - (i) minor addition
 - (ii) the proposed FSR will not result in unreasonable overshadowing impacts beyond that currently existing
 - (iii) no visual privacy concerns to adjoining neighbouring dwellings
 - (iv) the proposed FSR variation is concealed by topography and will not generate any adverse visual bulk impacts.
 - (v) FSR variation is well integrated with the built form of the dwelling.

Consideration of Applicant's Written Request - Clause 4.6(4) (a) (i) and (ii)

Development consent must not be granted unless the consent authority is satisfied that:

- (a) The applicant's written request has adequately addressed the matters required to be demonstrated by subclause 3 of clause 4.6 being that compliance with the development standard is unreasonable or unnecessary in the circumstances of the case, and that there are sufficient environmental planning grounds to justify contravening the standard; and
- (b) The proposed development will be in the public interest because it is consistent with the objectives of the particular development standard and the objectives for development within the zone in which the development is proposed to be carried out.

Does the written request adequately address those issues at clause 4.6(3)(a)?

It is considered that the applicant has adequately addressed that compliance with the standard is unreasonable or unnecessary in the circumstances of the case and has referenced one or more of the following justifications as set out in *Wehbe v Pittwater Council* (2007) 156 LGERA 446:

- (a) the objectives of the development standard are achieved notwithstanding non-compliance with the standard;
- (b) to establish that the underlying objective or purpose is not relevant to the development with the consequence that compliance is unnecessary;
- (c) to establish that the underlying objective or purpose would be defeated or thwarted if compliance was required with the consequence that compliance is unreasonable;
- (d) to establish that the development standard has been virtually abandoned or destroyed by the Council's own actions in granting consents departing from the standard and hence compliance with the standard is unnecessary and unreasonable; and
- (e) to establish that "the zoning of particular land" was "unreasonable or inappropriate" so that "a development standard appropriate for that zoning was also unreasonable or unnecessary as it applied to that land" and that "compliance with the standard in that case would also be unreasonable or unnecessary.

The applicant specifically relies upon justification (a) outlined above to address clause 4.6(3)(a) of Waverley LEP 2012. Council accepts that the proposal is consistent with the desired low density character of the area given that the topography of the site conceals the proposed works and the potential amenity impacts are minimal.

Does the written request adequately address those issues at clause 4.6(3)(b)?

The applicant has adequately addressed that there are sufficient environmental planning grounds to justify contravening the development standard. The applicant notes that due to the location of the proposed additions they are concealed from the street with no impact upon the streetscape. Combined

with no adverse or unreasonable impact on the neighbouring dwellings, Council is satisfied that the proposed exceedance is acceptable.

Is the development in the public interest?

The proposed development will be in the public interest because it is consistent with both the objectives of the particular development standard and the objectives for development within the zone in which the development is proposed to be carried out.

The objectives of the FSR development standard are as follows:

- (a) to ensure sufficient floor space can be accommodated within the Bondi Junction Centre to meet foreseeable future needs,
- (b) to provide an appropriate correlation between maximum building heights and density controls,
- (c) to ensure that buildings are compatible with the bulk and scale of the desired future character of the locality,
- (d) to establish limitations on the overall scale of development to preserve the environmental amenity of neighbouring properties and the locality

The proposed development does not affect privacy or cause any additional overshadowing or view loss to the adjacent properties nor does it propose a variation to the building height. The location of the additional space does not visually change the streetscape and maintains the existing and future character of the locality.

The objectives of the R2 Low Density Residential zone are as follows:

- To provide for the housing needs of the community within a low density residential environment.
- To enable other land uses that provide facilities or services to meet the day to day needs of residents.
- To maximise public transport patronage and encourage walking and cycling.

The proposal maintains the low density nature of the site and the parking provided does not exceed the maximum under the provisions of the DCP ensuring that public transport, walking and cycling is encouraged. The proposal is consistent of the objectives of the zone.

Conclusion

For the reasons provided above the requested variation to the FSR development standard is supported as the applicant's written request has adequately addressed the matters required to be addressed by clause 4.6 of the Waverley LEP 2012 and the proposed development would be in the public interest because it is consistent with the objectives of floor space ratio (FSR) and the R2 Low Density Residential.

2.1.3. Waverley Development Control Plan 2012 (Waverley DCP 2012) – Amendment No.9

The relevant matters to be considered under the Waverley DCP 2012 for the proposed development are outlined below:

Table 2: Waverley DCP 2012 – Part B General Provisions Compliance Table

Development Control	Compliance	Comment
1. Waste	Yes	Satisfactory
Ecologically Sustainable Development	Yes	Satisfactory
3. Landscaping and Biodiversity	Yes	The proposal was reviewed by Council's Environmental Sustainability Officer. Refer to section 3 of this report on referral commentary in relation to Biodiversity.
5. Vegetation Preservation	Yes	The Council's Tree Management Officer has reviewed the proposal and raised no objection.
6. Stormwater	Yes	Council's Stormwater Design Engineers raise no objection to the proposal, subject to conditions. Refer to section 3 of this report on referral commentary and recommended conditions.
8. Transport Minimum parking rate: Nil Maximum parking rate: 1 space for 2 or less bedrooms 2 spaces for 3 or more bedrooms.	Yes	Council's Traffic Engineers have reviewed the proposal to provide for 2 car spaces. The design and location are satisfactory. Refer to Table 3 of this report on referral commentary and conditions.
12. Design Excellence	Yes	The proposal will result in a more integrated and well-designed building.
14. Excavation	Yes	The proposal results in excavation to construct the lower ground floor room extension and studio/storage room. The excavation is limited to under the carport and the front undercroft area and is not expected to negatively impact surrounding properties.

Table 3: Waverley DCP 2012 – Part C2 Low Density Residential Development Compliance Table

Development Control	Compliance	Comment
2.0 General Objectives		
	Yes	The proposal does not contravene the general objectives of this part of the DCP.
2.2 Setbacks		
 2.2.1 Front and rear building lines Predominant front building line Predominant rear building line at each floor level 	Yes	The front and rear building setbacks remain unchanged by the proposed lower ground floor extension.
2.2.2 Side setbacks Minimum of 0.9m (for height up to 8.5m)	No	The lower ground floor bedroom extension continues the existing side setback along both side boundaries. The proposed gym/storage extension under the carport is to have a side setback of 0.6m. Due to its location and recessed nature within the topography, this is deemed acceptable.
2.3 Streetscape and visual imp	pact	
 New development to be compatible with streetscape context Replacement windows to complement the style and proportions of existing dwelling Significant landscaping to be maintained. Porticos only permitted where a character of the streetscape 	Yes N/A N/A N/A	The lower ground floor bedroom extension will have no visual impact on the streetscape being contained within an existing undercroft area. The proposed carport was deferred to remove the proposed roller door to the carport to provide a more open design. As discussed below in Section 2.8 of this table, the applicant has provided sufficient evidence that the roller door is consistent with the streetscape and is acceptable.
2.4 Fences		
 Front: Maximum height of 1.2m Solid section no more than 0.6m high Side and Rear: Maximum height of 1.8m 	Yes	The application was deferred to reduce the proposed front fence height. The amended drawing shows the retention of the existing front fence and is acceptable.
2.5 Visual and acoustic privacy		
Habitable windows are not to directly face habitable windows or open space of neighbouring dwellings	Yes	The proposed lower ground floor windows will not result in unreasonable privacy impacts upon adjoining dwellings.

Development Control	Compliance	Comment
unless direct views are screened or other appropriate measures are incorporated into the design External stairs are not acceptable.		
2.7 Views		
 Views from the public domain are to be maintained Development to be designed and sited so as to enable a sharing of views with surrounding dwellings particularly from habitable rooms and decks. 	Yes	No impacts on views have been identified, and no submissions have been received that raise an issue with view loss. As such, the proposal is not expected to result in impacts on any known views enjoyed by surrounding properties.
2.8 Car parking		
 2.8.1 Design Approach Parking only allowed where site conditions permit 	Yes	The existing carport is located fronting Bronte Road and due to the sloped nature of the site, this is the only viable location for on-site parking.
Designed to complement the building and streetscape	Yes	The application was deferred to address the carport door design and overall width of the structure. During the deferral process, the width
Car parking structures to be behind the front building line	No	of the carport was amended to address Council's Traffic Engineer's requirement. Additionally, evidence that a roller door for a carport is an
 Driveways are to be located to minimise the loss of on street parking 	Yes	acceptable outcome based on other carports within the visual catchment of the site was also provided.
Parking to be provided from secondary streets or lanes where possible.	N/A	Due to the sloping nature of the site, positioning the car parking structure behind the front building line is impossible, coupled with the precedent already established in the streetscape. Additionally, the proposal seeks consent to extend the existing carport which is already forward of the building line. This outcome is acceptable. No loss of on street parking is expected
2.8.2 Parking rates	Yes	The proposal includes two car parking spaces. This is compliant with the parking rates set by Part B8 of Waverley DCP 2012.

Development Control	Compliance	Comment
 2.8.3 Location Behind front building line for new dwellings Existing development to be in accordance with the hierarchy of preferred car parking locations 	No No	The proposed carport sits forward of the building line due to the nature of the sloping site. This is deemed acceptable. The proposed carport is not in accordance with council's hierarchy for preferred parking locations. Notwithstanding, the carport is existing and the proposal is simply for an extension of the existing structure. Due to the predominance of carports already existing within the streetscape and the already existing carport, this is deemed acceptable.
 2.8.4 Design Complement the style, massing and detail of the dwelling Secondary in area and appearance to the design of the residences No part of the façade is to be demolished to accommodate car parking Gates to have an open design 2.8.5 Dimensions 	Yes No Yes Yes	The carport is complementary in the style and detailing of the dwelling. Due to its location and the sloped site, the carport will have a primary appearance from the streetscape. However, as previously discussed, this is an acceptable outcome. No parts of the existing dwelling are being demolished or altered to accommodate car parking. Gates are shown to open inwards. The proposal was reviewed by Council's Traffic
• 5.4m x 2.4m per vehicle	ies	Engineer, who found the proposal satisfactory. Refer to section 3 of this report on referral commentary in relation to Traffic.
 2.8.6 Driveways Maximum of one per property Maximum width of 3m at the gutter (excluding splay) Crossings not permitted where 2 on street spaces are lost 	Yes	The proposal seeks to replace the existing driveway, deemed satisfactory by Council's Traffic Engineers, with conditions.
2.9 Landscaping and open spa		
Overall open space: 40% of site areaOverall landscaped area:	Yes Yes	The proposal includes approximately 70% of open space. The proposal includes approximately 46% of
15% of site area	Yes	landscaped area.

Development Control	Compliance	Comment
Minimum area of 25m² for private open space	Yes	The site retains the existing private open space in excess of 25m ² .
Front open space: 50% of front building setback		The front open space is approximately 61% of the front building setback.
areaFront landscaped area:50% of front open space	Yes	The front landscaped area is approximately 68%.
provided Outdoor clothes drying	Yes	There is ample outdoor space for a clothesline.
area to be provided		

2.2. Other Impacts of the Development

The proposal is considered to have no significant detrimental effect relating to environmental, social or economic impacts on the locality, subject to appropriate conditions being imposed.

2.3. Suitability of the Site for the Development

The site is considered suitable for the proposal.

2.4. Any Submissions

The application was notified for 14 days from 25 July to 8 August 2022 in accordance with the *Waverley Community Development Participation and Consultation Plan*.

Following receipt of amended plans and additional information, the application was not notified as the amended form of the proposal represents a lesser impact than that of the original form that was publicly notified, for the following reasons:

• The amended proposal is of a lesser or similar impact to the original proposal.

No submissions were received.

2.5. Public Interest

The proposal is considered to have no detrimental effect on the public interest, subject to appropriate conditions being imposed.

3. REFERRALS

The following internal and external referral comments were sought:

3.1. Traffic and Development

Council's Traffic Engineers advised that they raised no objections to the proposal and provided conditions of approval.

3.2. Stormwater

Council's Stormwater Engineers advised that they raised no objections to the proposal and provided conditions of approval.

3.3. Tree Management

Council's Tree Management Officer has reviewed the proposal and advised:

- On inspection, it was noted that on site there were no trees of any significance, the trees possess no outstanding attributes worthy of retention due to being weed species and their removal is supported.
- Architectural plan prepared by Studio Redux, DWG:001. Issue. D. Date received 07/07/2022 is satisfactory.

3.4. Environmental Health

Council's Biodiversity Officer has reviewed the proposal and advised:

The property lies within the identified coastal biodiversity corridor, so under the DCP Section 3.2.2 (a). A minimum of 50% of the proposed trees, 50% of the shrubs and 50% of the grasses and groundcovers (not including turfed areas) are to be indigenous or local native plants listed in Annexure B2-1.

The proposed development does not appear to include any landscaping.

Should the proposed development include any landscaping, landscape plans that comply with the abovementioned control must be prepared and submitted for assessment.

As detailed previously in this report, the proposal does not include new landscaping.

4. CONCLUSION

The application has been assessed against the relevant matters for consideration under section 4.15(1) of the Act. It is recommended for approval, subject to conditions of consent.

5. RECOMMENDATION TO WAVERLEY LOCAL PLANNING PANEL

That the development application be APPROVED by the Waverley Local Planning Panel subject to the conditions in Appendix A.

Report prepared by:	Application and agreed by:
D. Wilmoth	Olive
Damien Wilmotte	Kylie Lucas
Development Assessment Planner	Acting Manager, Development Assessment
Date:	Date:

Reason for WLPP referral:

1. Departure from any development standard in an EPI by more than 10%

APPENDIX A – CONDITIONS OF CONSENT

A. APPROVED DEVELOPMENT

1. APPROVED PLANS AND DOCUMENTATION

The development must be in accordance with:

(a) Architectural Plans prepared by studio redux including the following:

Plan Number	Plan description	Plan Date	Date received by
and Revision			Council
001 Revision A	Site Plan	6/11/2022	25/11/2022
002 Revision A	Floor Plans	6/11/2022	25/11/2022
003 Revision A	Floor Plans	6/11/2022	25/11/2022
004 Revision A	Elevations	6/11/2022	25/11/2022
005 Revision A	Elevations	6/11/2022	25/11/2022
006 Revision A	Sections	6/11/2022	25/11/2022

- (b) BASIX Certificate
- (c) The Site Waste and Recycling Management Plan (SWRMP) Part 1.

Except where amended by the following conditions of consent.

B. PRIOR TO THE ISSUE OF A CONSTRUCTION CERTIFICATE

The requirements outlined in this section are to be provided to the satisfaction of the Principal Certifying Authority in all instances, except where a condition explicitly specifies that the approval of Council or a Council Officer is required.

GENERAL REQUIREMENTS

2. NO BUILDING OR DEMOLITION WORKS PRIOR TO RELEASE OF CONSTRUCTION CERTIFICATE

The building work, or demolition work, must not be commenced until:

- (a) a Construction Certificate has been obtained from Council or an Accredited Certifier in accordance with the *Environmental Planning and Assessment Act 1979*;
- (b) a Principal Certifying Authority has been appointed and Council has been notified of the appointment in accordance with the *Environmental Planning and Assessment Act 1979* and *Environmental Planning and Assessment Regulation 2000*; and
- (c) Council is given at least two days' notice in writing of the intention to commence the building works.

3. HOME BUILDING ACT

The builder or person who does the residential building work shall comply with the applicable requirements of Part 6 of the *Home and Building Act 1989*. In this regard a person must not contract to do any residential building work unless a contract of insurance that complies with this Act is in force in relation to the proposed work. It is the responsibility of the builder or person who is to do the work to

satisfy the Principal Certifying Authority that they have complied with the applicable requirements of Part 6, before any work commences.

CONTRIBUTIONS, FEES & BONDS

4. SECURITY DEPOSIT

A deposit (cash or cheque) for the amount of \$ 2,830.00 must be provided to Council for any damage caused to any property of the consent authority (ie. public land) as a consequence of the works and completing any public work (such as road work, kerbing and guttering, footway construction, stormwater drainage and environmental controls) required in connection with the consent.

This deposit (cash or cheque) must be provided to Council prior to the issue of any Construction Certificate. The full amount of the deposit, minus Council's costs for any repair of damage to Council property or rectification of unauthorised works on Council property, will be refunded after satisfactory completion all of works associated with this consent (including the required public works) to the person who paid the deposit.

5. LONG SERVICE LEVY

A long service levy, as required under section 34 of the *Building and Construction Industry Long Service Payments Act, 1986*, is to be paid in respect of this building work. Evidence that the levy has been paid is to be submitted to the Principal Certifying Authority prior to the issue of any Construction Certificate.

Note: Council acts as an agent for the Long Service Payment Corporation and the levy may be paid at Council's office. The levy rate is 0.25% of building work costing \$250,000 or more.

CONSTRUCTION & SITE MATTERS

6. HOARDING

To ensure the site is contained during construction, a hoarding is required for the approved works, which is to be designed and constructed in accordance with the requirements of Safe Work NSW. Where the hoarding is to be erected over the footpath or any public place, the approval of Council's Compliance Unit must be obtained and the applicable fees paid, prior to the erection of the hoarding.

7. EROSION & SEDIMENT CONTROL

A Soil and Water Management Plan (SWMP), also known as an Erosion and Sediment Control Plan must be prepared in accordance with Waverley Council's Water Management Technical Manual.

The SWMP must be approved by the Principal Certifying Authority prior to the issue of a Construction Certificate. A copy of the SWMP must be kept on site at all times and made available to Council officers upon request.

The recommendations of the SWMP must be implemented and maintained during all construction activities and until the site is fully stabilised following construction.

8. DETAILS OF EXCAVATION, SHORING OR PILE CONSTRUCTION

A report shall be prepared by a suitably qualified and practising Structural Engineer/Geotechnical Engineer detailing the proposed methods of bulk excavation, shoring or pile construction, including details of vibration emissions and any possible damage which may occur to adjoining or nearby properties as a result of the proposed building and excavation works.

Any practices or procedures specified in the Structural Engineer's report in relation to the avoidance or minimisation of structural damage to adjoining properties are to be fully complied with and incorporated into the plans and specifications together with the Construction Certificate.

9. ENGINEERING DETAILS

Structural details are to be prepared and certified by a practicing Structural Engineer in connection with all structural components of the approved works, prior to the issue of the relevant Construction Certificate.

TRAFFIC MANAGEMENT

10. CONSTRUCTION TRAFFIC MANAGEMENT PLAN (CTMP)

The applicant is to submit a Construction Traffic Management Plan (CTMP) for the approval of Council's Executive Manager, Infrastructure Services, or delegate, prior to the issue of any Construction Certificate. For further information on what is required in the CTMP, please refer to Council's website at:

https://www.waverley.nsw.gov.au/building/development_applications/post_determination/development_applications - conditions of consent_

STORMWATER & FLOODING

11. STORMWATER MANAGEMENT

To ensure the management of stormwater runoff from the development is undertaken without impact to the subject site, neighbouring properties or receiving drainage system, stormwater runoff from the development shall be collected and piped by gravity flow in accordance with Councils Stormwater Management Technical Manual.

Any affected Council's infrastructure as the result of construction activities within the public domain area, inclusive of stormwater, stormwater outlet/s, kerb and gutter, pavement, grass verges and vehicle crossovers within the extent works shall be replaced as per Waverley Council Public Domain Technical Manual.

ENERGY EFFICIENCY & SUSTAINABILITY

12. BASIX

All requirements of the BASIX Certificate and NatHERS documentation are to be shown on the Construction Certificate plans and documentation.

WASTE

13. SITE WASTE AND RECYCLING MANAGEMENT PLAN

A Site Waste and Recycling Management Plan (SWRMP) - Part 2 is to be submitted to the Principal Certifying Authority prior to the issue of the relevant Construction Certificate, which outlines materials to be reused and/or recycled as a result of demolition and construction works. At least one copy of the SWRMP Part 2 is to be available on site at all times during construction. Copies of demolition and construction waste dockets that verify the facility that received the material for recycling or disposal and the quantity of waste received, must be retained on site at all times during construction.

C. COMPLIANCE PRIOR TO WORK COMMENCING AND DURING CONSTRUCTION

The requirements outlined in this section are to be provided to the satisfaction of the Principal Certifying Authority in all instances, except where a condition explicitly specifies that the approval of Council or a Council Officer is required.

PRIOR TO ANY WORKS

14. CONSTRUCTION SIGNS

Prior to commencement of any works on the site and during construction a sign shall be erected on the main frontage of the site detailing the name, address and contact details (including a telephone number) of the Principal Certifying Authority and principal contractor (the coordinator of the building works). The sign shall be clearly legible from the adjoining street/public areas and maintained throughout the building works.

15. DILAPIDATION REPORT

A Dilapidation report is to be prepared for any adjoining or nearby property that may be subject to potential damage as a result of any works being undertaken. The dilapidation report is be made available to affected property owners.

The report is to be dated, submitted to, and accepted by the Principal Certifying Authority, prior to any work commencing on the site.

Note: Any damage that may be caused is a civil matter. This consent does not allow or authorise any party to cause damage, trespass, or any other unlawful act and Council will not be held responsible for any damage that may be caused to adjoining buildings as a consequence of the development being carried out. Council will not become directly involved in disputes between the builder, owner, developer, its contractors and the owners of neighbouring buildings.

DEMOLITION & EXCAVATION

16. DEMOLITION – ASBESTOS AND HAZARDOUS MATERIALS

The demolition, removal, storage, handling and disposal of products and materials containing asbestos must be carried out in accordance with the relevant requirements of SafeWork NSW and the NSW Environment Protection Authority (EPA), including:

- Work Health and Safety Act 2011;
- Work Health and Safety Regulation 2017;
- SafeWork NSW Code of Practice for the Safe Removal of Asbestos;
- Australian Standard 2601 (2001) Demolition of Structures;
- Protection of the Environment Operations Act 1997.

At least 5 days prior to the demolition, renovation work or alterations and additions to any building, the person acting on the consent shall submit a Work Plan to the Principal Certifying Authority in accordance with *Australian Standard AS 2601-2001*, Demolition of Structure and a Hazardous Materials Assessment prepared by a person with suitable expertise and experience. The Work Plan and Hazardous Materials Assessment shall:

- (a) Outline the identification of any hazardous materials, including surfaces coated with lead paint;
- (b) Confirm that no asbestos products are present on the subject land, or

- (c) particularise a method of safely disposing of the asbestos in accordance with the Code of Practice on how to safely remove asbestos published by SafeWork NSW (catalogue WC03561);
- (d) Describe the method of demolition;
- (e) Describe the precautions to be employed to minimise any dust nuisance; and
- (f) Describe the disposal methods for hazardous materials.

17. CONTROL OF DUST ON CONSTRUCTION SITES

The following requirements apply to demolition and construction works on site:

- (a) Hazardous dust is not to be allowed to escape from the site. The use of fine mesh dust proof screens or other measures are recommended. Any existing accumulations of dust (e.g. ceiling voids and wall cavities) must be removed by the use of an industrial vacuum fitted with a high efficiency particle air (HEPA) filter. All dusty surfaces and dust created from work are to be suppressed by a fine water spray. Water must not be allowed to enter the street and stormwater systems. Demolition is not to be performed during adverse winds, which may cause dust to spread beyond the site boundaries.
- (b) All contractors and employees directly involved in the removal of hazardous dusts and substances are to wear protective equipment conforming to Australian Standard AS1716 Respiratory Protective Devices.

18. CLASSIFICATION OF WASTE/ DISPOSAL OF EXCAVATED SOILS

Prior to the exportation of waste (including fill or soil) from the site the material must be classified in accordance with the provisions of the *Protection of the Environment Operations Act, 1997* and the NSW EPA Waste Classification Guidelines 2014.

19. EXCAVATION AND BACKFILLING

All excavations and backfilling associated with the erection or demolition of a building must be executed safely and in accordance with the appropriate professional standards and must be properly guarded and protected to prevent them from being dangerous to life or property.

If an excavation associated with the erection or demolition or a building extends below the level of the footings of a building on an adjoining allotment of land, the excavation is to be managed by a practising structural engineer.

CONSTRUCTION MATTERS

20. CONSTRUCTION HOURS

Demolition and building work must only be undertaken between the hours of 7am and 5pm on Mondays to Fridays and 8am to 3pm on Saturdays, with no work to be carried out on Sundays and public holidays.

Excavation works involving the use of heavy earth movement equipment, including rock breakers and the like, must only be undertaken between the hours of 7am and 5pm on Mondays to Fridays, with no such work to be carried out on Saturday, Sunday or a public holiday.

Noise from construction activities shall comply with the *Protection of the Environmental Operations* (Noise Control) Regulation 2017.

21. STOCKPILES, STORAGE OF MATERIALS AND LOCATION OF BUILDING OPERATIONS

All building materials and any other items associated with the development are to be stored within the property. No materials are to be stored on Council's footpath, nature strip, or road reserve without prior Council approval.

22. CONSTRUCTION INSPECTIONS

The building works are to be inspected during construction by the Principal Certifying Authority (PCA) in accordance with the *Building Legislation Amendment* (Quality of Construction) Act 2002, clause 162A of the *Environmental Planning and Assessment Regulation 2000* and the requirements of any other applicable legislation or instruments.

23. CERTIFICATE OF SURVEY - LEVELS

All construction works are to be in accordance with the Reduced Levels (RLs) as shown on the approved plans. Certification from a Registered Surveyor certifying ground, upper floor/s and finished ridge levels is to be submitted to the Principal Certifying Authority during construction and prior to continuing to the construction of a higher level of the building.

24. CERTIFICATE OF SURVEY - BOUNDARIES AND LOCATION OF BUILDING

A Certificate of Survey prepared by a Registered Surveyor setting out the boundaries of the site and the location of the building on the site is to be submitted to the Principal Certifying Authority to certify the building is located in accordance with the development consent plans. The Certificate is to be submitted prior to the construction of the external walls above the ground floor level of the building.

25. WORK OUTSIDE PROPERTY BOUNDARY

This consent does not authorise any work outside the property boundary.

VEHICLE ACCESS & PUBLIC DOMAIN WORKS

26. RECONSTRUCT VEHICLE CROSSING

The existing vehicle crossing is to be demolished and a new crossing constructed to provide access to the proposed garage. A separate application is required for the vehicle crossing, with all work to be carried out with the approval of and in accordance with the requirements of Council.

The crossing is to be 5.0 metres wide at the property boundary. The width at the street is to be 3.0 metres plus 0.45 metre splays.

Prior to the submission of the vehicle crossing application, works as executed drawings shall be submitted to Council for the approval of the Executive Manager Creating Waverley, confirming the finished levels of the internal driveway between the property boundary and the garage floor comply with the approved driveway long sections.

27. VEHICULAR ACCESS - FINISHED LEVEL TO FOOTPATH

The finished level at the property boundary on both sides of the vehicle crossing is to be 50mm above the level of the existing concrete footpath.

28. HEADROOM CLEARANCE

The headroom clearance on the entry and within the garage is to be a minimum of 2.2 metres.

29. VEHICLE GROUND CLEARANCE

The levels and gradients within the garage are to be sufficient to provide adequate ground clearance to a B99 car as defined in AS2890.1.

D. PRIOR TO THE ISSUE OF AN OCCUPATION CERTIFICATE OR SUBDIVISION CERTIFICATE

The requirements outlined in this section are to be provided to the satisfaction of the Principal Certifying Authority in all instances, except where a condition explicitly specifies that the approval of Council or a Council Officer is required, prior to the issue of an Occupation Certificate or Subdivision Certificate, whichever applies.

CERTIFICATES, LICENCES, EASEMENTS AND RESTRICTIONS

30. FINAL OCCUPATION CERTIFICATE

The requirements outlined in this section are to be provided to the satisfaction of the Principal Certifying Authority in all instances, except where a condition explicitly specifies that the approval of Council or a Council Officer is required, prior to the issue of an Occupation Certificate or Subdivision Certificate, whichever applies.

31. CERTIFICATION OF BASIX COMMITMENTS

The Principal Certifying Authority shall certify that the all the undertakings in the approved BASIX certificate have been completed.

32. CERTIFICATION OF NEWLY CONSTRUCTED AND RETAINED STORMWATER DRAINAGE SYSTEM

Prior to issue of any Occupation Certificate, certification is to be provided from a suitably qualified and practising Engineer or Plumber, that any new stormwater drainage system has been constructed in accordance with the Development Consent, Water Management Technical Manual, all applicable Codes, Policies, Plans, Standards and good engineering practice. Similarly, any retained stormwater drainage system is unblocked, in good working order and to be repaired/replaced to best practice. A copy of the certification must be submitted to Council.

ADVISORY MATTERS

The following advisory matters are provided as additional information to ensure compliance with the relevant legislation and requirements. You must also check other Commonwealth and NSW Acts and Regulations which may apply to the works or use approved in this application.

AD1 POST CONSENT CONDITIONS REQUIRING COUNCIL INPUT

Various conditions require further input, review or approval by Council in order to be satisfied following the determination of the application (that is, post consent). In those instances, please adhere to the following process to avoid delays:

Please read your conditions carefully.

- Information to be submitted to Council should be either via email to info@waverley.nsw.gov.au or via the NSW Planning Portal (if required).
- Attention the documentation to the relevant officer/position of Council (where known/specified in condition).
- Include DA reference number.
- Include condition number/s seeking to be addressed.
- Where multiple conditions need Council input, please try to group the documentation / email/s into relevant subjects (multiple emails for various officers may be necessary, for example).
- Information to be submitted in digital format refer to 'Electronic lodgement guidelines' on Council's website. Failure to adhere to Council's naming convention may result in documentation being rejected.
- Where files are too large for email, the digital files should be sent to Council via CD/USB. Council does not support third party online platforms (data in the cloud) for receipt of information.
- Please note, in some circumstances, additional fees and/or additional documents (hard copy) may be required.
- Council's standard for review (from date the relevant officer receives documentation) is 14 days. Times may vary or be delayed if information is not received in this required manner.

AD2 SYDNEY WATER REQUIREMENTS

You may be required to submit your plans to the appropriate Sydney Water office to determine whether the development will affect Sydney Water's sewer and water mains, stormwater drains and/or easements.

Contact Sydney Water for more information.

AD3 DIAL BEFORE YOU DIG

Underground assets may exist in the area that is subject to your application. In the interests of health and safety and in order to protect damage to third party assets please contact Dial Before You Dig at www.1100.com.au or telephone on 1100 before excavating or erecting structures (this is the law in NSW). If alterations are required to the configuration, size, form or design of the development upon contacting the Dial Before You Dig service, an amendment to the development consent (or a new development application) may be necessary. Individuals owe asset owners a duty of care that must be observed when working in the vicinity of plant or assets. It is the individual's responsibility to anticipate and request the nominal location of plant or assets on the relevant property via contacting the Dial Before You Dig service in advance of any construction or planning activities.

AD4 TELECOMMUNICATIONS ACT 1997 (COMMONWEALTH)

Telstra (and its authorised contractors) are the only companies that are permitted to conduct works on Telstra's network and assets. Any person interfering with a facility or installation owned by Telstra is committing an offence under the Criminal Code Act 1995 (Cth) and is liable for prosecution. Furthermore, damage to Telstra's infrastructure may result in interruption to the provision of essential services and significant costs. If you are aware of any works or proposed works which may affect or impact on Telstra's assets in any way, you are required to contact: Telstra's Network Integrity Team on 1800 810 443.

AD5 ALTERATIONS AND ADDITIONS ONLY

This consent is for alterations and additions to the existing building only and should during the course of construction a significant amount of the remaining fabric of the building be required to be removed,

works must cease immediately and a new development application will be required to be submitted for assessment.

AD6 EXCAVATION TO BE LIMITED

Excavation shall be limited to that shown in the approved plans. Any further excavation will require Council approval.

AD7 BONDI - ROSE BAY SAND BODY

This site may be located within the Bondi - Rose Bay Sand Body as identified in Council's Aboriginal Cultural Heritage Study 2009. Should an object of potential Aboriginal or archaeological significance be discovered during the demolition, excavation or construction period associated with this development, works are to immediately cease and the NSW National Parks and Wildlife Service must be contacted.


Waverley Council must be notified of any referral to the NSW National Parks and Wildlife Service and be provided with a copy of any subsequent response.

AMENDED

RECEIVED Waverley Council

Application No: DA-288/2022

Date Received: 25/11/2022

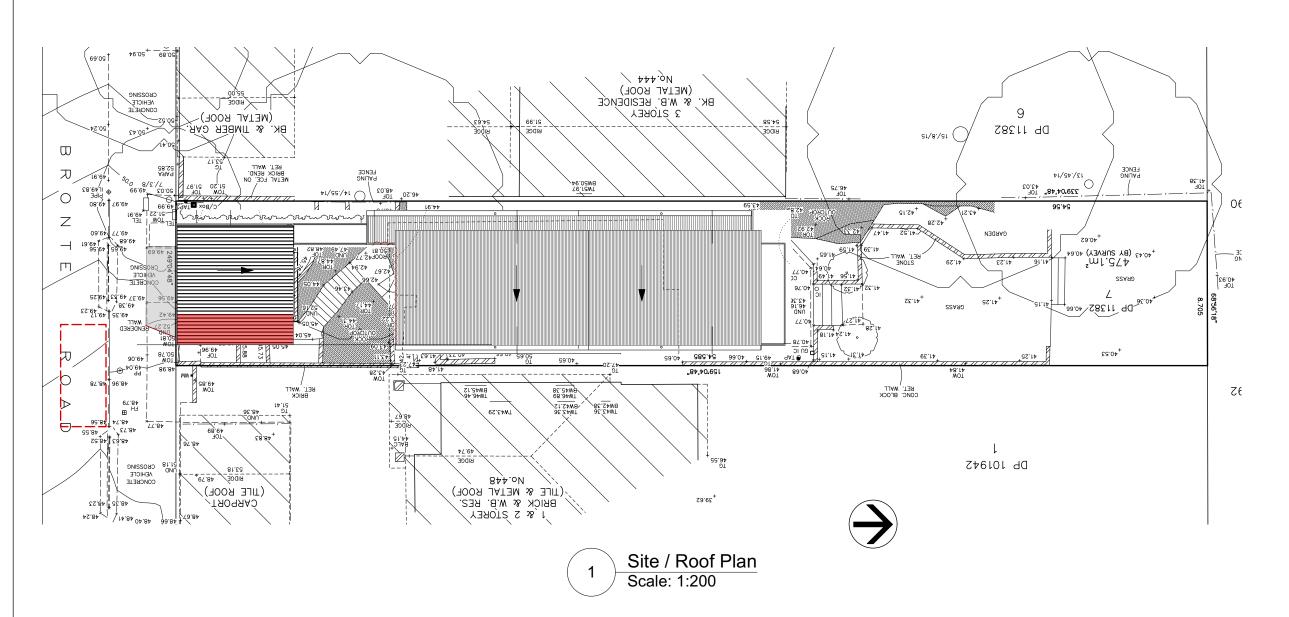

To be read in conjunction with Basix Certificate no. A464467

Construction	Additional insulation required (R-value)	Other specifications
concrete slab on ground floor.	nil	
external wall: framed (weatherboard, fibro, metal clad)	R1.30 (or R1.70 including construction)	

Windows and glazed doors glazing requirements

Window / door no.	Orientation	Area of glass inc. frame (m2)	Overshad Height (m)	dowing Distance (m)	Shading device	Frame and glass type
W1	S	10	6	3	none	standard aluminium, single clear, (or U-value: 7.63, SHGC: 0.75)



Proposed DA Works

All works to be in accordance with Australian Standards, The Building Code of Australia, other relevant codes, and with Manufact recommendations and instructions. Do not scale from drawings. Verify all dimensions on site prior to construction.


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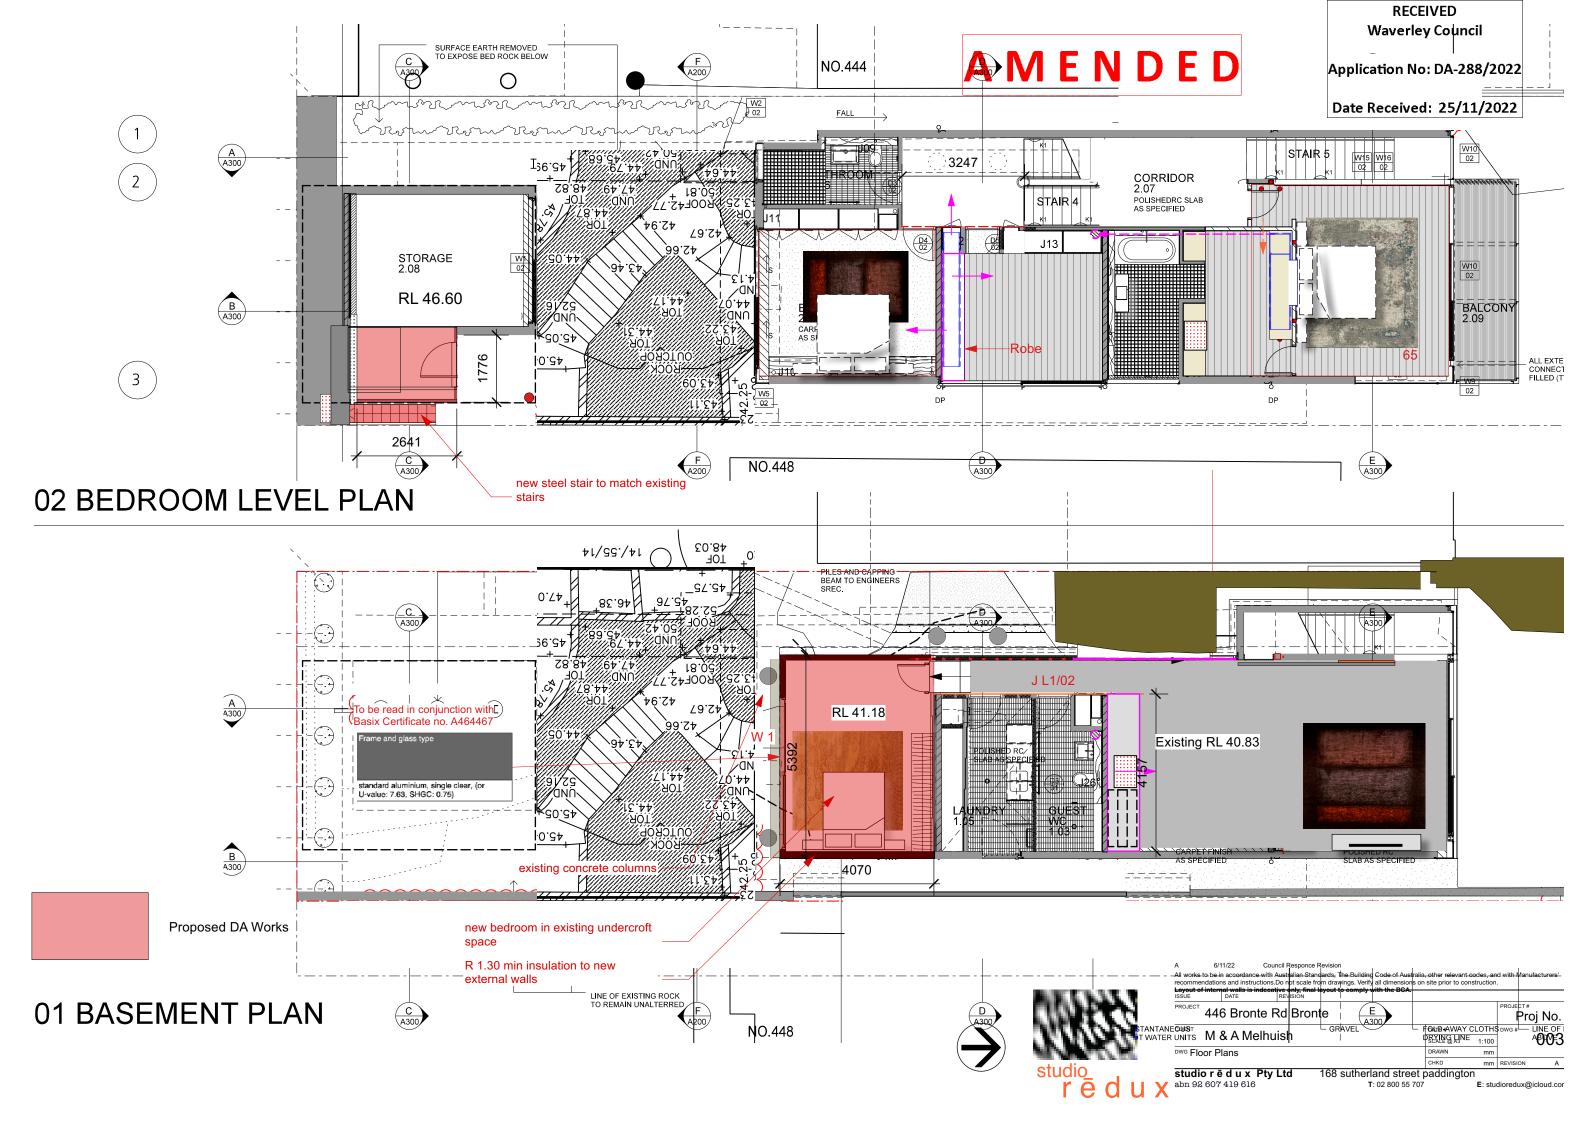
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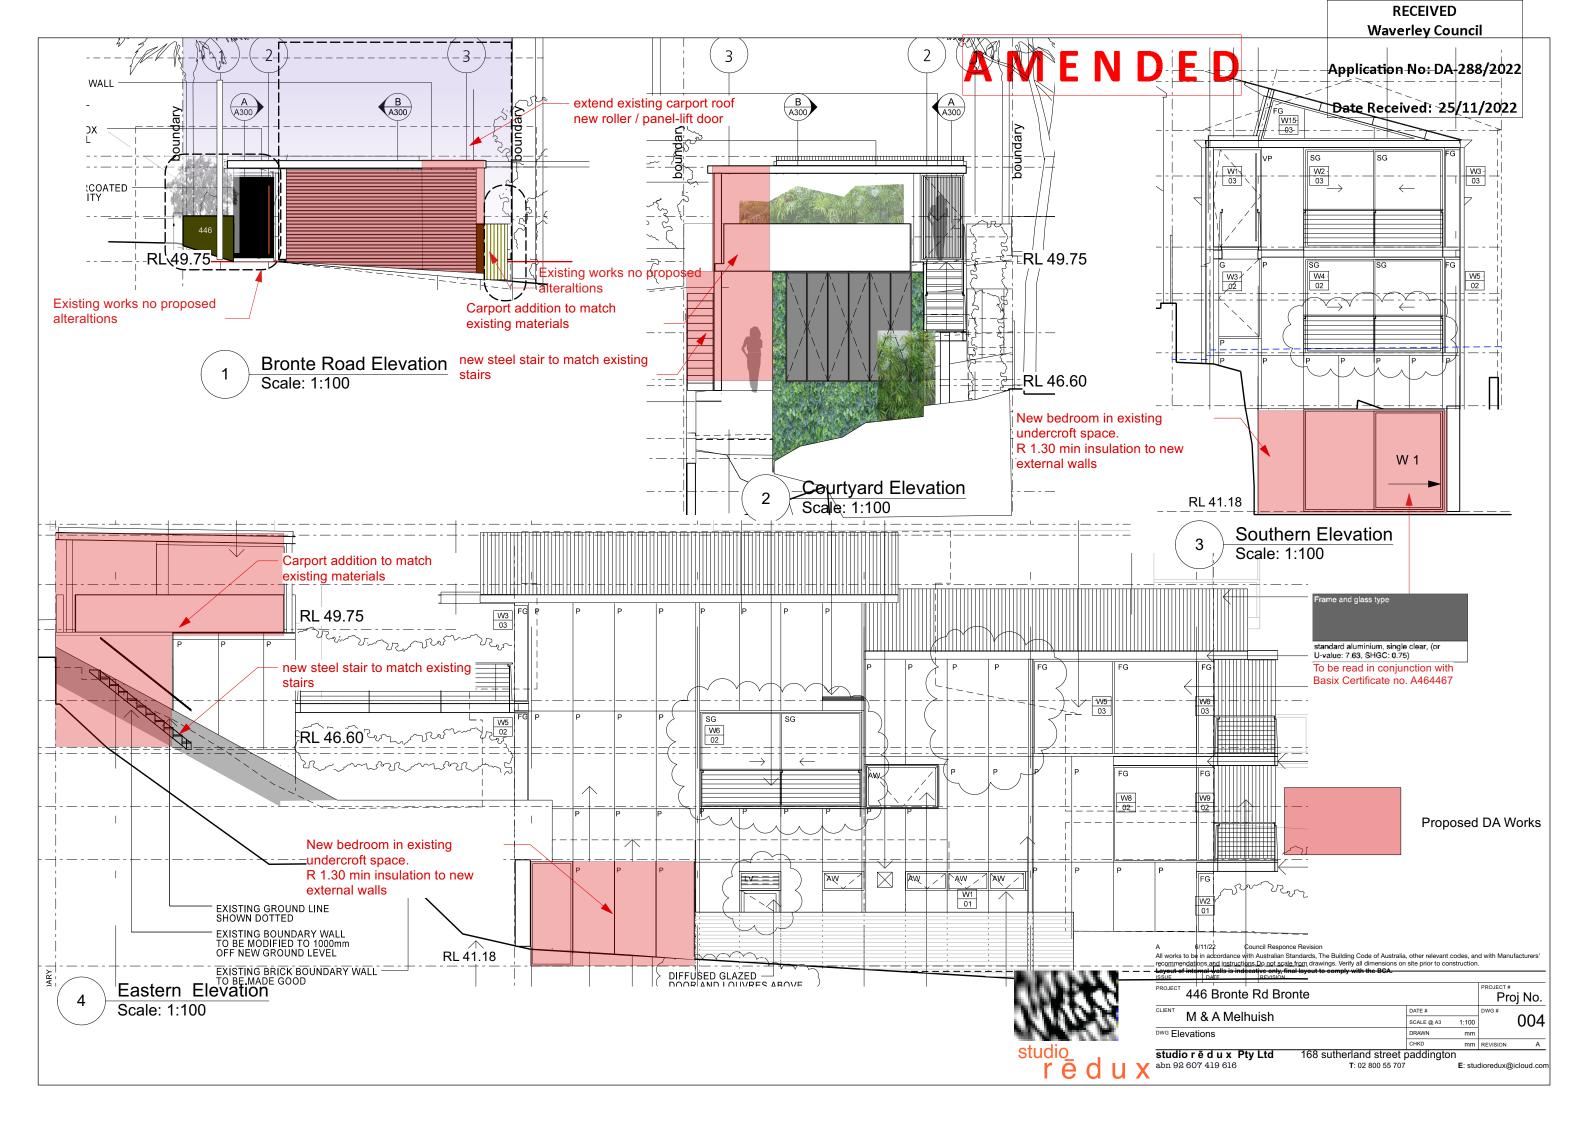
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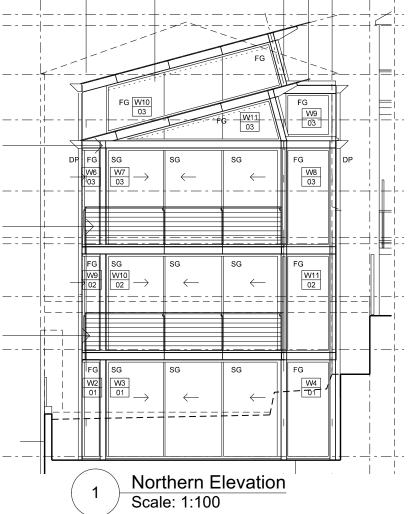




RECEIVED Waverley Council Application No: DA-288/2022 Date Received: 25/11/2022 RL 49.75 RL 46.60 No alteration to existing elevations Proposed DA Works A 6/11/22 Council Responce Revision

All works to be in accordance with Australian Standards, The Building Code of Australia, other relevant codes, and with Manufacturer recommendations and instructions. Do not scale from drawings. Verify all dimensions on site prior to construction.



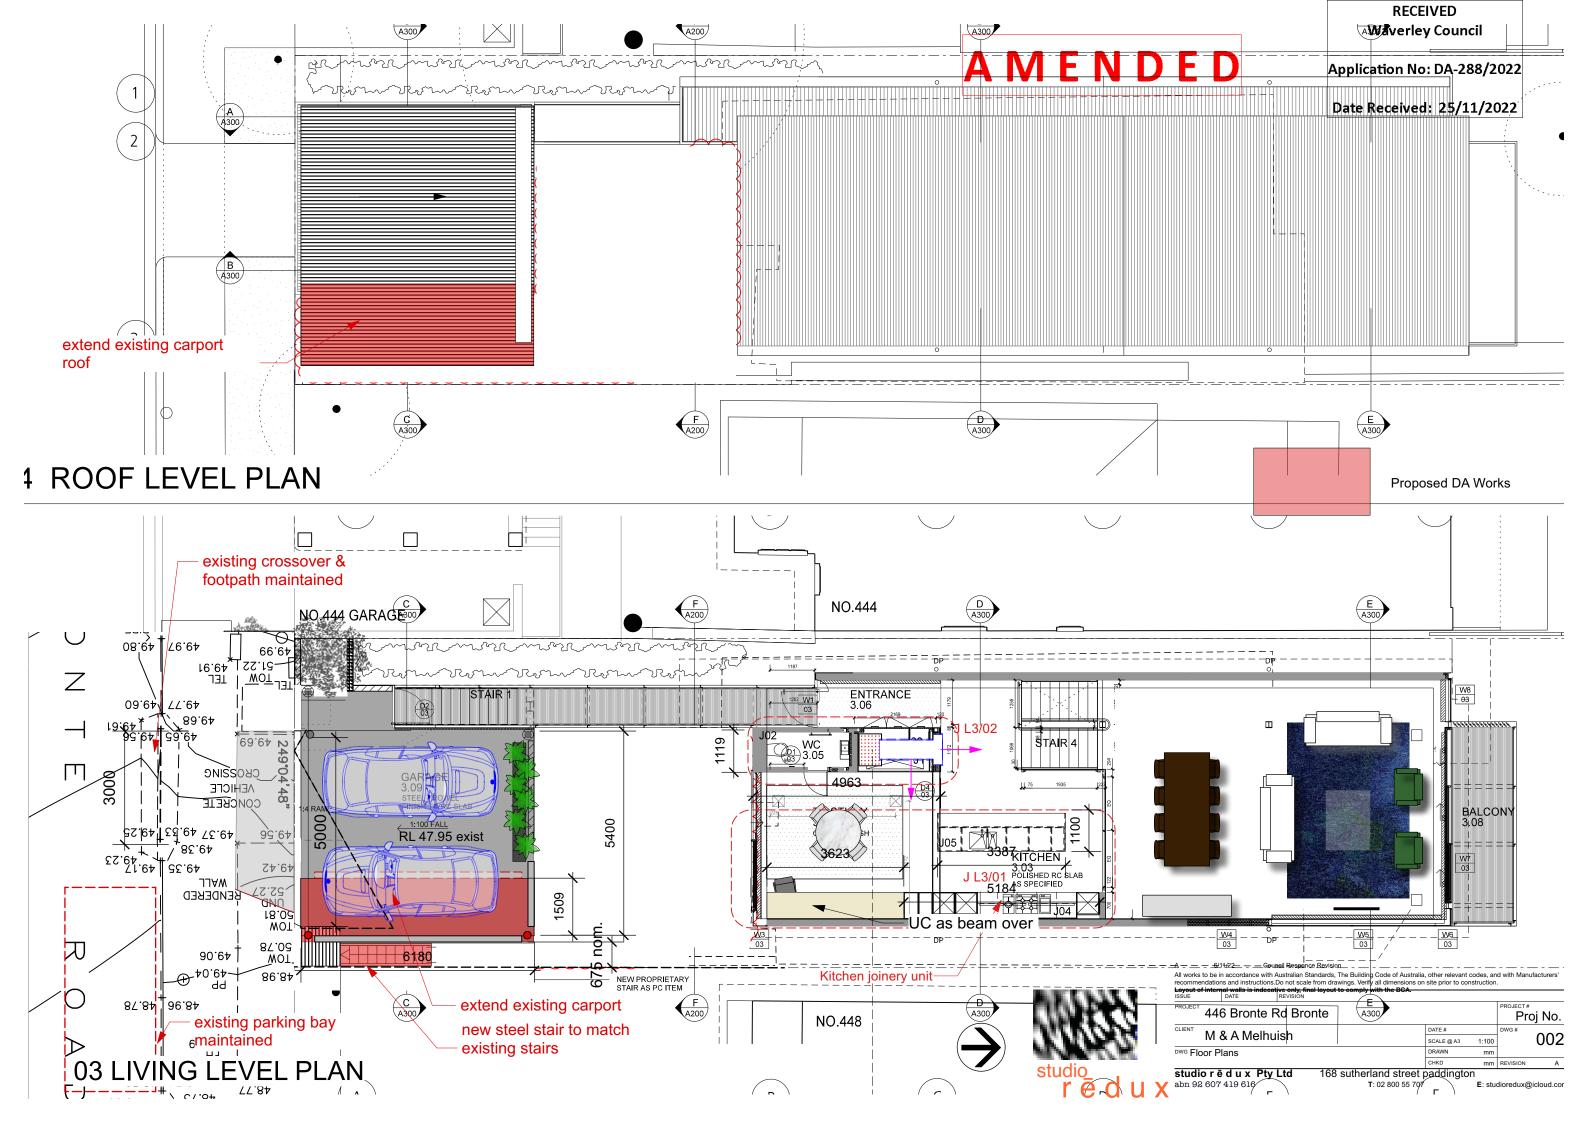

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Western Elevation Scale: 1:100

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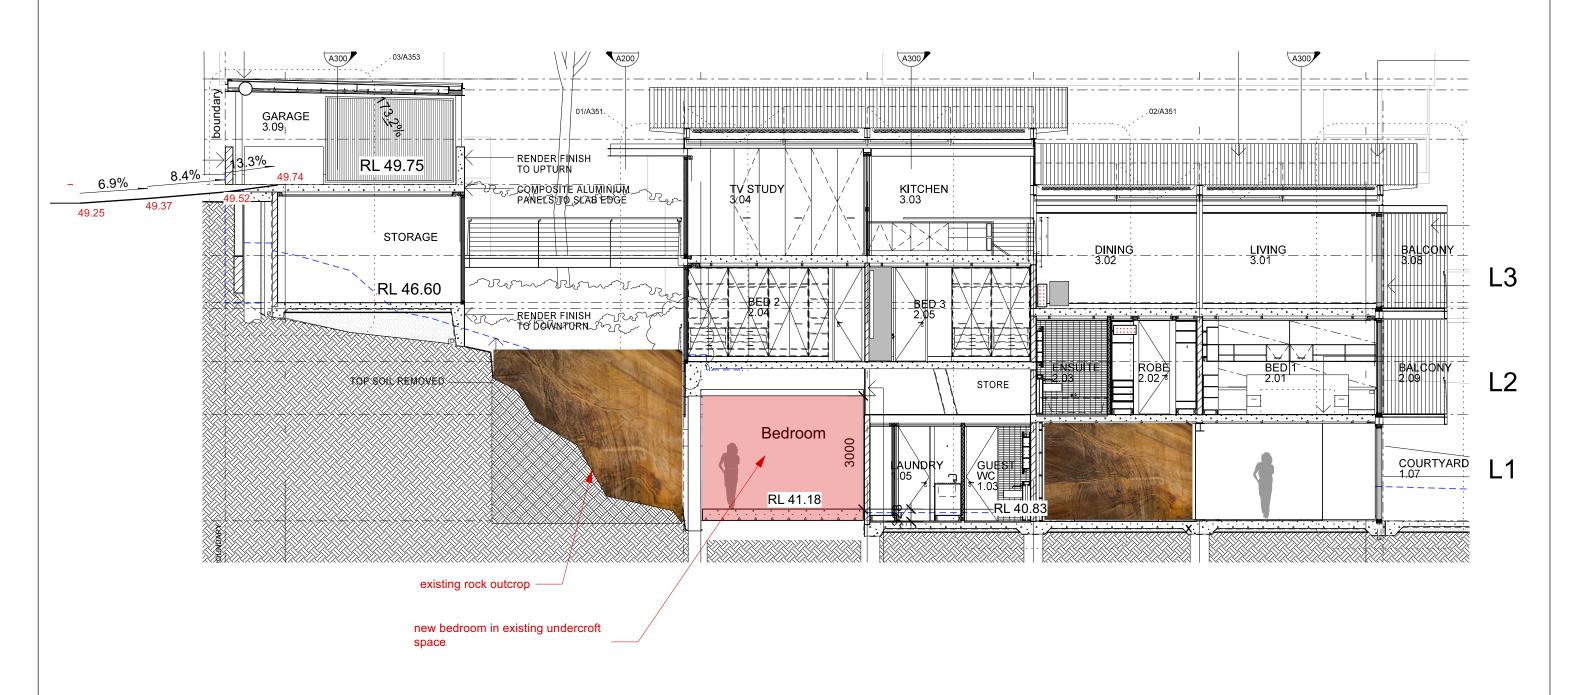
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168 sutherland street paddington E: studioredux@icloud.com T: 02 800 55 707

AMENDED

Application No: DA-288/2022

Date Received: 25/11/2022





Proposed DA Works

A 6/11/22 Council Responce Revision

All works to be in accordance with Australian Standards, The Building Code of Australia, other relevant codes, and with Manufactur recommendations and instructions.Do not scale from drawings. Verify all dimensions on site prior to construction.

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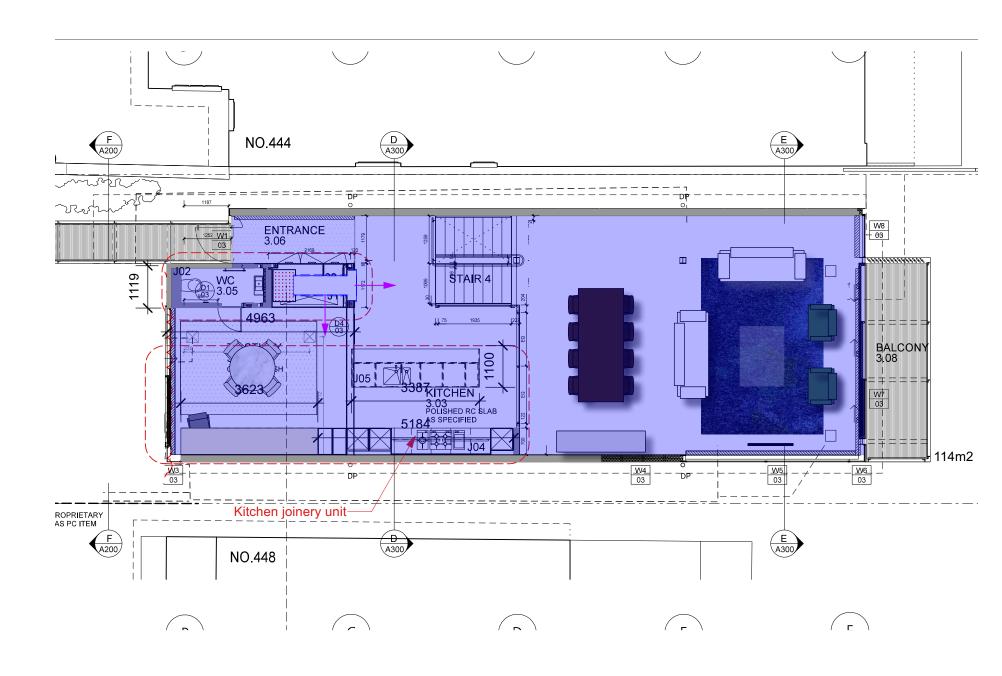
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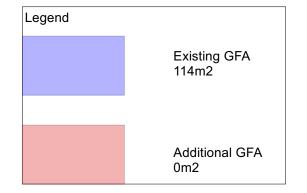
RECEIVED Waverley Council

Application No: DA-288/2022

Date Received: 25/11/2022










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Report to the Waverley Local Planning Panel

Application number	DA-375/2022		
Site address	32 Gardyne Street, Bronte		
Proposal	Alterations and additions to dwelling house including second floor addition and balconies		
Date of lodgement	6 September 2022		
Owner	Mr C W S Wheeler and Mrs D L Wheeler		
Applicant	Mrs D Wheeler		
Submissions	Three submissions received		
Cost of works	\$942,207.20		
Exceedance of floor space ratio development Exceedance of height of buildings development Visual privacy impacts Solar access impact			
Recommendation That the application be REFUSED for the reasons of the report.			

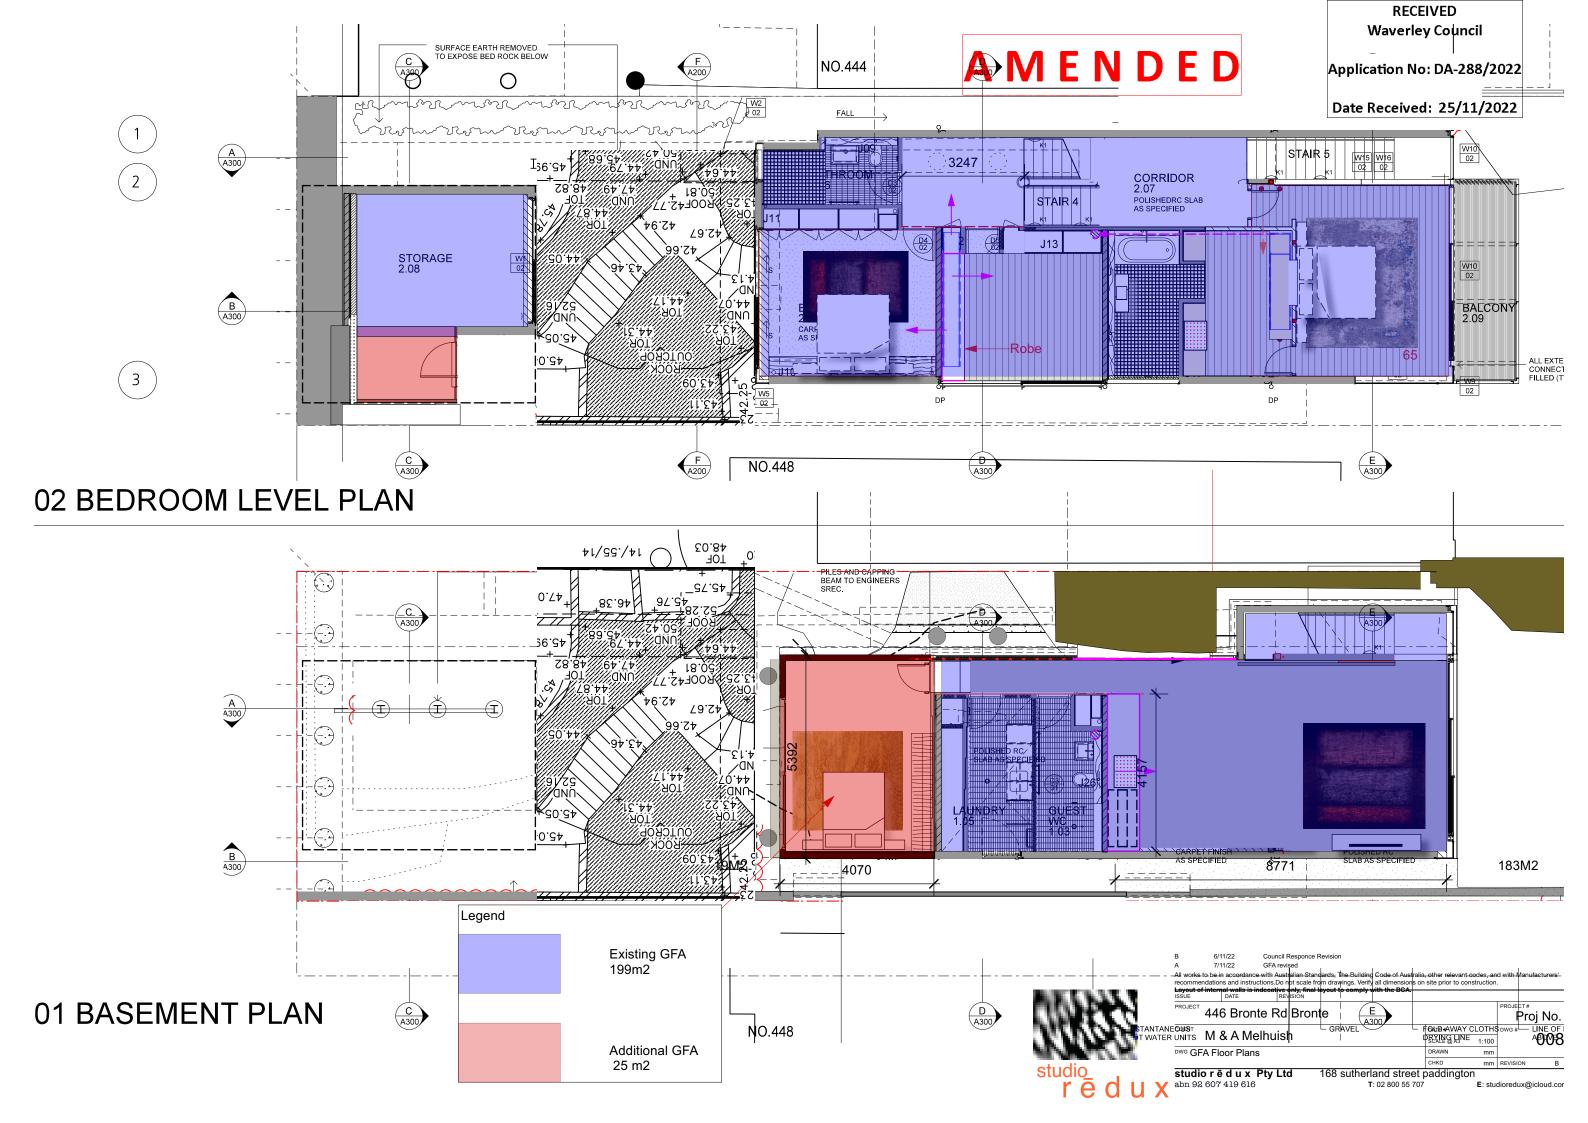SITE MAP



1. PREAMBLE

1.1. Executive Summary

The development application seeks consent for alterations and additions to the existing dwelling house at 32 Gardyne Street, Bronte including a second floor addition and balconies.

The principal issues arising from the assessment of the application are as follows:

- exceedance of floor space ratio development standard
- exceedance of height of buildings development standard
- visual privacy impacts
- solar access impact.

The assessment finds the issues unacceptable. The visual privacy and solar access impacts cannot be supported in the context of the exceedance of the floor space ratio and height of building development standards.

A total of three submissions were received and the issues raised in the submissions have been considered and addressed in this report and in the Recommendation.

The application has been assessed against the relevant matters for consideration under section 4.15(1) of the *Environmental Planning and Assessment Act 1979*. It is recommended for refusal.

1.2. Site and Surrounding Locality

A site visit was carried out on 23 November 2022.

The site is identified as Lot Y2 in DP 411914, known as 32 Gardyne Street, Bronte.

The site is a battle-axe block with a vehicle and pedestrian access handle to Gardyne Street. The site is occupied by a two-storey detached dwelling house with basement garage and storage. The dwelling house is located to the north of the access handle, and there is a swimming pool adjacent to the northern boundary.

The site has an area of 581.7m². The access handle falls from the street (south) to the entrance of the basement garage (north) by approximately 4m. Levels surrounding the dwelling house are relatively flat.

The site is adjoined by two-storey dwellings in each direction. The sites to the north (409 Bronte Road) and east (34B Gardyne Street) are both approximately 2m lower than the subject site.

The locality is characterised by a variety of low density residential development.

Figures 1 to 8 are photos of the site and its context.



Figure 1: Site viewed from Gardyne Street, looking north



Figure 3: Subject dwelling house viewed from eastern terrace, looking north



Figure 5: View from the eastern terrace toward 34B Gardyne Street, looking east



Figure 2: Subject dwelling house viewed from access hand, looking north west



Figure 4: Northern boundary viewed from southern terrace. The visible vegetation is within the rear yard of 409 Bronte Road



Figure 6: View from the first floor eastern balcony toward 34B Gardyne Street, looking east



Figure 7: View toward rear yard of 409 Bronte Road, looking north



Figure 8: View toward rear yard of 409 Bronte Road, looking north east

1.3. Relevant Development History

DA-284/2021 – On 21 October 2021 development application DA-284/2021 was approved for alterations and additions to the existing dwelling house, including:

- Gardyne Street entry:
 - New open style front fence and entry gate to Gardyne Street.
 - New and expanded bin store area within access handle.

Basement:

- Increase in height of eastern side boundary fence adjacent the access handle.

Ground floor:

- New privacy screen along southern boundary adjacent to entry stairs.
- Partial demolition of the north-eastern corner of the external wall and installation of new curved wall and windows.
- Replace existing privacy screen to eastern terrace with new screen.
- Replacement of existing windows and doors.
- Changes to southern fenestration.
- Internal reconfiguration to raise floor to new dining room area to match kitchen/living.

First floor:

- Partial demolition of the north-eastern corner of the external wall and installation of new curved wall and windows.
- Internal reconfiguration to provide new ensuite, walk-in-robe and bathroom.
- Replacement of existing windows and doors.
- Changes to southern fenestration.
- Demolition of the existing balcony and replacement with a new curved balcony with glass balustrade and metal roof over.

Pool area:

Replacement of pool fence.

Roof:

- Removal of existing tile roof and construction of a new metal roof, gutters and downpipes and reconfiguration of a section of the existing timber frame.

- Upgrade existing roof over entry to the dwelling and replace the existing entry canopy.
- Relocate an enlarge existing skylight.

The approved development had not begun construction at the time of the site visit.

1.4. Proposal

The development application seeks consent for alterations and additions to the existing dwelling house.

The proposed alterations and additions are the same as those approved listed above for DA-284/2021, aside from the following additional alterations:

- All levels:
 - New internal lift servicing all floors.
- Ground floor:
 - Internal reconfiguration.
 - Replacement of glazed doors to western terrace.
 - Removal of window from southern elevation.
 - Replacement of two windows to northern elevation with five narrower windows.
 - Minor increase in internal floor levels.
- First floor:
 - Internal reconfiguration.
 - Replacement of two windows to northern elevation with two narrower windows.
- Second floor / roof:
 - Second floor addition 1.078m above existing ridge, containing a study room and floor-toceiling windows to the northern boundary.
 - Balcony to the east of roof addition, accessed from glazed doors.
 - Privacy screen to the southern side of the proposed balcony.
 - Extension of existing chimney to service existing wood-burning fire place.

1.5. Background

The development application was lodged on 6 September 2022.

Council informed the applicant that the proposal is not supported on 18 January 2023 and offered the Applicant the option to withdraw the application. The applicant contacted Council on 25 January 2023 to state that they did not wish to withdraw.

2. ASSESSMENT

The following matters are to be considered in the assessment of this development application under section 4.15 of the *Environmental Planning and Assessment Act 1979* (the Act).

2.1. Planning Instruments and Development Control Plans

The following is an assessment against relevant legislation, environmental planning instruments, including State environmental planning policies (SEPPs), and development control plans.

2.1.1. State Environmental Planning Policies (SEPPs)

The following SEPPs apply from 1 March 2022 and have been considered acceptable in the assessment of this development application:

- SEPP (Building Sustainability Index BASIX) 2004
- SEPP (Biodiversity and Conservation) 2021
- SEPP (Resilience and Hazards) 2021

2.1.2. Waverley Local Environmental Plan 2012 (Waverley LEP 2012)

The relevant matters to be considered under the Waverley LEP 2012 for the proposed development are outlined below:

Table 1: Waverley LEP 2012 Compliance Table

Provision	Compliance	Comment
Part 1 Preliminary		
1.2 Aims of plan	Yes	The proposal is not contrary to the aims of the plan.
Part 2 Permitted or prohibited de	velopment	
Land Use Table R2 Low Density Residential Zone	Yes	The proposal is defined as a dwelling house, which is permitted with consent in the R2 zone.
Part 4 Principal development star	ndards	
4.3 Height of buildings8.5m	No	The proposal (excluding the chimney as per the definition for height within the LEP) has a maximum height of 10.86m, exceeding the development standard by 27.8%.
 4.4 Floor space ratio and 0.5:1 290.85m² gross floor area 	No	The proposal has a floor space ratio (FSR) of 0.53:1, and a gross floor area of 307.13, exceeding the development standard by 5.6%.
4.6 Exceptions to development standards	No	The application is accompanied by a written request pursuant to clause 4.6 of Waverley LEP 2012 for exceptions the height of buildings and floor space ratio development

Provision	Compliance	Comment
		standards. A detailed discussion of the variation to the development standards is presented below this table.
Part 6 Additional local provisions		
6.1 Acid sulfate soils	Yes	The proposal is located on class 5 acid sulfate soil. The proposal does not include any works that require preparation of a management plan.

The following is a detailed discussion of the issues identified in the compliance table above in relation to the Waverley LEP 2012.

Clause 4.6 Exceptions to Development Standards - Height of building

The application seeks an exception to the height of buildings development standard in clause 4.3 under Waverley LEP 2012.

The site is subject to a maximum height of building development standard of 8.5m. The proposed development has a height of 10.86m, exceeding the standard by 2.36m or 27.8%.

The proposed second floor addition, second floor balcony balustrade and privacy screening are the elements of the proposal that exceed the development standard.

A written request has been submitted to Council in accordance with clause 4.6(3)(a) and (b) of Waverley LEP 2012 seeking to justify the contravention of the development standard by demonstrating:

- (a) That compliance with the development standard is unreasonable or unnecessary in the circumstances of the case; and
- (b) That there are sufficient environmental planning grounds to justify contravening the standard.

It is noted that the applicant's written request has not taken the height of building measurement from the highest point of the proposal, and instead states the proposed height to be 10.38m, or a 22.13% exceedance of the control. If the Local Planning Panel were minded to approve the application, then an amended clause 4.6 written request with correct figures would be required.

A copy of the applicant's written request has been provided to the Waverley Local Planning Panel for consideration.

Applicant's Written Request - Clause 4.6(3)(a) and (b)

The applicant seeks to justify the contravention of the height of buildings development standard on the following basis:

- (a) That compliance with the development standard is unreasonable or unnecessary in the circumstances of the case, as the objectives of the development standard are achieved notwithstanding non-compliance with the development standard as follows:
 - (i) Objective (a) is to establish limits on the overall height of development to preserve the environmental amenity of neighbouring properties and public spaces and, if appropriate, the sharing of views. The objective is achieved as amenity is preserved, the screening to the balcony ensures neighbouring privacy, the proposal does not result in any additional overshadowing to neighbours, and there will be no view loss.
 - (ii) Objective (b) is to increase development capacity within the Bondi Junction Centre to accommodate future retail and commercial floor space growth. The objective is not relevant to the proposal.
 - (iii) Objective (c) is to accommodate taller buildings on land in Zone B3 Commercial Core of the Bondi Junction Centre and provide an appropriate transition in building heights surrounding that land. The objective is not relevant to the proposal.
 - (iv) Objective (d) is to ensure that buildings are compatible with the height, bulk and scale of the desired future character of the locality and positively complement and contribute to the physical definition of the street network and public space. The objective is achieved as the proposal is compatible with surrounding two and three storey buildings, ample setbacks are provided, and the additions will not be prominent when viewed from the street or public domain.
- (b) That there are sufficient environmental planning grounds to justify contravening the standard:
 - (i) The exceedance does not result in any detrimental impacts on adjoining properties or on the locality.
 - (ii) The proposal will provide occupants with views toward the coast and the Pacific Ocean.
 - (iii) Non-compliance is largely attributable to the previous excavation at the site within the building footprint and does not result in the building appearing to have an excessive height.

Consideration of Applicant's Written Request - Clause 4.6(4) (a) (i) and (ii)

Development consent must not be granted unless the consent authority is satisfied that:

(a) The applicant's written request has adequately addressed the matters required to be demonstrated by subclause 3 of clause 4.6 being that compliance with the development standard is unreasonable or unnecessary in the circumstances of the case, and that there are sufficient environmental planning grounds to justify contravening the standard; and

(b) The proposed development will be in the public interest because it is consistent with the objectives of the particular development standard and the objectives for development within the zone in which the development is proposed to be carried out.

Does the written request adequately address those issues at clause 4.6(3)(a)?

It is considered that the applicant has not adequately addressed that compliance with the standard is unreasonable or unnecessary in the circumstances of the case.

The applicant has referenced the following justification as set out in *Wehbe v Pittwater Council* (2007) 156 LGERA 446:

(a) the objectives of the development standard are achieved notwithstanding non-compliance with the standard;

The applicant specifically relies upon the above criteria to address clause 4.6(3)(a) of Waverley LEP 2012. However, the proposal does not achieve objectives (a) and (d) of the height of buildings development standard as set out below.

Objective (a) is to establish limits on the overall height of development to preserve the environmental amenity of neighbouring properties and public spaces and, if appropriate, the sharing of views. The objective is not achieved as the proposal does not preserve the environmental amenity of neighbouring properties.

The non-compliant second floor addition and balcony increases overlooking of 409 Bronte Road and may increase overlooking of 34B Gardyne Street. Further discussion regarding overlooking and visual privacy is found under the heading *Visual privacy* below the DCP compliance table in this report.

The non-compliant balcony screen reduces solar access to the rear private open space of 34 Gardyne Street at 2pm and 3pm at midwinter. Insufficient information has been provided to accurately assess the extent of the solar access impact, as the Applicant's plan-form solar access diagrams do not depict the site at 34 Gardyne Street, and as the Applicant's view-from-the-sun diagrams do not depict the boundary fence between number 34 and 34B (figure 9, below). Regardless of the inability to accurately assess the extent of the impact, the loss of any amount of solar access due to a variation to the development standard is unacceptable as this does not result in the preservation of amenity for neighbours.

Due to the privacy and solar access impacts on neighbours, the proposal does not preserve environmental amenity and does not achieve objective (a) of the development standard.



Figure 9: Applicant's view from the sun diagram, 3pm midwinter

Objective (d) is to ensure that buildings are compatible with the height, bulk and scale of the desired future character of the locality and positively complement and contribute to the physical definition of the street network and public space.

The proposed three-storey building, which exceeds the height of buildings and FSR development standards and exceeds the Waverley DCP 2012 battle-axe block single storey control, is not compatible with the height, bulk and scale of the desired future character of the locality.

The proposed three-storey form is not compatible with the predominantly two-storey form of surrounding development and will be visually obtrusive when viewed from neighbouring properties, including from 304 Bronte Road and 28 and 30 Gardyne Street.

Does the written request adequately address those issues at clause 4.6(3)(b)?

The applicant has not adequately addressed that there are sufficient environmental planning grounds to justify contravening the development standard.

Contrary to the applicant's arguments, the proposed exceedance of the development standard will result in amenity impacts in the form of overlooking and overshadowing, as described above. The proposal is also considered incompatible with the predominantly two-storey form of surrounding development. The proposal is for a three-storey building, plus basement level.

The applicant has argued that the non-compliance with the height of building development standard is largely attributable to previous excavation and has annotated "natural ground line" on the architectural plans. However, it is noted that the land in the surrounding area slopes steeply down to the north and east, and that the subject and adjacent sites feature retaining walls, excavation, and altered ground levels, thus making the natural ground level difficult to estimate. Notwithstanding the fact that building height is measured from the existing ground level, the applicant has not provided any evidence to

support their natural ground line annotations, and the extent to which the proposal would exceed the development standard measured from the natural ground level is unknown.

Is the development in the public interest?

The proposed development will not be in the public interest as it is inconsistent with the objectives of the height of buildings development standard as set out above.

The proposal is consistent with the objectives of the R2 Low Density Residential zone, as set out below:

- To provide for the housing needs of the community within a low density residential environment. The development achieves the objective as it provides low density housing.
- To enable other land uses that provide facilities or services to meet the day to day needs of residents. The development achieves the objective as it does not affect the provision of other land uses.
- To maximise public transport patronage and encourage walking and cycling. The proposal does not affect public transport patronage, walking or cycling.

In summary, the proposal is consistent with the objectives of the R2 zone, however not with the objectives of the development standard and as such the development is not in the public interest.

Conclusion

For the reasons provided above, the requested variation to the height of buildings is not supported as the applicant's written request has not adequately addressed the matters required to be addressed by clause 4.6(3) of the Waverley LEP 2012. In addition, the proposed development is not in the public interest because it is inconsistent with the objectives of the height of buildings development standard.

Clause 4.6 Exceptions to Development Standards - Floor space ratio

The application seeks an exception to the floor space ratio (FSR) development standard in clause 4.4 under Waverley LEP 2012.

The site is subject to a (FSR) development standard of 0.5:1, equating to 290.85m² of gross floor area. The proposed development has an FSR of 0.53:1, and a gross floor area (GFA) of 307.13m², exceeding the development standard by 5.6%.

A written request has been submitted to Council in accordance with clause 4.6(3)(a) and (b) of Waverley LEP 2012 seeking to justify the contravention of the development standard by demonstrating:

(a) That compliance with the development standard is unreasonable or unnecessary in the circumstances of the case; and

(b) That there are sufficient environmental planning grounds to justify contravening the standard.

It is noted that the applicant's written request measures the proposed GFA as 310.45m², and the proposed exceedance as 7%. A copy of the applicant's written request has been provided to the Waverley Local Planning Panel for consideration.

Applicant's Written Request - Clause 4.6(3)(a) and (b)

The applicant seeks to justify the contravention of the floor space ratio development standard on the following basis:

- (a) That compliance with the development standard is unreasonable or unnecessary in the circumstances of the case, as the objectives of the development standard are achieved notwithstanding non-compliance with the development standard as follows:
 - (i) Objective (a) is to ensure sufficient floor space can be accommodated within the Bondi Junction Centre to meet foreseeable future needs. The objective is not relevant to the proposal.
 - (ii) Objective (b) is to provide an appropriate correlation between maximum building heights and density controls. The objective is achieved as the proposed FSR and building height appropriately correlate, as the proposed built form is compatible with the height and locality.
 - (iii) Objective (c) is to ensure that buildings are compatible with the bulk and scale of the desired future character of the locality. The objective is achieved as the proposal is compatible with surrounding two and three-storey buildings, ample setbacks are provided, and the additions will not be prominent when viewed from the street or public domain.
 - (iv) Objective (d) is to establish limitations on the overall scale of development to preserve the environmental amenity of neighbouring properties and the locality. The objective is achieved as amenity is preserved, the screening to the balcony ensures neighbouring privacy, the proposal does not result in any additional overshadowing to neighbours, and there will be no view loss.
- (b) That there are sufficient environmental planning grounds to justify contravening the standard:
 - (i) The exceedance does not result in any detrimental impacts on adjoining properties or on the locality.
 - (ii) The proposal will provide occupants with views toward the coast and the Pacific Ocean and will provide a more functional internal layout.

Consideration of Applicant's Written Request - Clause 4.6(4) (a) (i) and (ii)

Development consent must not be granted unless the consent authority is satisfied that:

(a) The applicant's written request has adequately addressed the matters required to be demonstrated by subclause 3 of clause 4.6 being that compliance with the development standard is unreasonable or unnecessary in the circumstances of the case, and that there are sufficient environmental planning grounds to justify contravening the standard; and

(b) The proposed development will be in the public interest because it is consistent with the objectives of the particular development standard and the objectives for development within the zone in which the development is proposed to be carried out.

Does the written request adequately address those issues at clause 4.6(3)(a)?

It is considered that the applicant has not adequately addressed that compliance with the standard is unreasonable or unnecessary in the circumstances of the case.

The applicant has referenced the following justification as set out in *Wehbe v Pittwater Council* (2007) 156 LGERA 446:

(b) the objectives of the development standard are achieved notwithstanding non-compliance with the standard.

The applicant specifically relies upon the above to address clause 4.6(3)(a) of Waverley LEP 2012. However, the proposal does not achieve objectives (b), (c) and (d) of the height of buildings development standard as set out below.

Objective (b) is to provide an appropriate correlation between maximum building heights and density controls. The proposed exceedance of the FSR development standard also results in an exceedance of the height of buildings development standard. Therefore, the proposed FSR does not appropriately correlate with the 8.5m height of building development standard.

Objective (c) is to ensure that buildings are compatible with the bulk and scale of the desired future character of the locality. The proposed three-storey building, which exceeds the height of buildings and FSR development standards and exceeds the Waverley DCP 2012 battle-axe block single storey control, is not compatible with the height, bulk and scale of the desired future character of the locality.

The proposal will result in a three-storey form that is not compatible with the predominantly two-storey form of surrounding development and will be visually obtrusive when viewed from neighbouring properties, including from 304 Bronte Road and 28 and 30 Gardyne Street.

Objective (d) is to establish limitations on the overall scale of development to preserve the environmental amenity of neighbouring properties and the locality. The objective is not achieved as the proposal does not preserve the environmental amenity of neighbouring properties. The non-compliant second floor addition increases overlooking of 409 Bronte Road. Further discussion regarding overlooking and visual privacy is found under the heading *Visual privacy* below the DCP compliance table in this report.

Due to the privacy impacts on neighbours, the proposal does not preserve environmental amenity, and does not achieve objective (d) of the development standard.

Does the written request adequately address those issues at clause 4.6(3)(b)?

The applicant has not adequately addressed that there are sufficient environmental planning grounds to justify contravening the development standard.

Contrary to the applicant's arguments, the proposed exceedance of the development standard will result in amenity impacts in the form of overlooking, as set out above. The proposal is also considered incompatible with the predominantly two-storey form of surrounding development. The proposal will result in a three-storey building, plus basement level.

The applicant has argued that there are sufficient environmental planning grounds to justify contravening the development standard as the proposal will provide occupants with better views and with a more functional internal layout. However, the benefits to the occupants do not override the disbenefits to neighbours, and it is not accepted that there are sufficient grounds.

Is the development in the public interest?

As discussed in the previous section of this report, the proposal is consistent with the objectives of the R2 zone.

In summary, the proposal is consistent with the objectives of the R2 zone, however not with the objectives of the development standard. Therefore, the development is not in the public interest.

Conclusion

For the reasons provided above the requested variation to the FSR development standard is not supported as the applicant's written request has not adequately addressed the matters required to be addressed by clause 4.6(3) of the Waverley LEP 2012. In addition, the proposed development is not in the public interest because it is inconsistent with the objectives of the development standard.

2.1.3. Waverley Development Control Plan 2012 (Waverley DCP 2012) - Amendment No.9

The relevant matters to be considered under the Waverley DCP 2012 for the proposed development are outlined below:

Table 2: Waverley DCP 2012 - Part B General Provisions Compliance Table

Development Control	Compliance	Comment
1. Waste	Yes	Satisfactory.
Ecologically Sustainable Development	Yes	Satisfactory.
3. Landscaping and Biodiversity	Yes	Satisfactory.

Development Control	Compliance	Comment
5. Vegetation Preservation	Yes	No tree removal is proposed.
6. Stormwater	Yes	Satisfactory. The proposal does not increase the non-permeable area of the site.
10. Safety	Yes	Satisfactory.
12. Design Excellence	No	The proposal does not achieve design excellence as the height and scale of the proposal is not appropriate to the location, and the proposal does not adequately consider the bulk and massing of the building, the relationship with neighbouring sites in terms of amenity and form, and the environmental impacts in terms of overshadowing and overlooking.
16. Public Domain	Yes	Satisfactory.

Table 3: Waverley DCP 2012 – Part C2 Low Density Residential Development Compliance Table

Development Control	Compliance	Comment
2.0 General Objectives		
 Scale of development for be appropriate for allotment sizes and other dwellings in the vicinity Development to not significantly detract from amenity of other dwellings Development to be sympathetic in bulk, scale and character with the desired future character of the area Development to have high design standards and be built in accordance with the objectives and controls of Part C2 	No	The proposal does not achieve the general objectives as the scale of development is not appropriate for the site and desired character of the area, as it detracts from neighbouring amenity, and as the proposal contravenes controls within section C2 as set out in this table below.
2.1 Height		
Pitched roof dwelling houseMaximum external wall height of 7m	Yes	The proposal does not alter the existing wall heights.
2.2 Setbacks		
2.2.1 Front and rear building linesPredominant front building line	Yes	The subject site is a battle-axe block. There is only one other battle-axe block in the vicinity, and therefore there is no predominant building lines for the site.

Development Control	Compliance	Comment
Predominant rear building line at each floor level	compliance	The proposed roof additions are located above the building footprint and are set back further from the site boundaries than the lower levels. In these circumstances the proposed setbacks are acceptable.
2.2.2 Side setbacksMinimum 1.5m (up to 12.5m)	Yes	The proposal is set back 3.2m from the northern side boundary.
2.3 Streetscape and visual imp	pact	
New development to be compatible with streetscape context	Yes	The site's battle-axe configuration results in the dwelling being almost entirely concealed from the street. Therefore, the proposed alterations and additions do not have a material streetscape impact.
2.4 Fences		
Front:		
 Maximum height of 1.2m Solid section no more than 0.6m high Side and Rear: Maximum height of 1.8m 	Acceptable on merit Acceptable on merit	The proposed new front fence has a maximum height of 1.8m at its highest point where the site falls to the east and 1.4m at its lowest. The proposed fence matches the height of the existing fence and is acceptable in this instance. The proposed additions to the eastern side boundary fence adjacent to the driveway will have a maximum height of approximately 2.75m. The proposed fence height is acceptable in the circumstances of the site, as it matches the
		height of existing fences and walls to the south and north, and as it will not have any solar access impacts on neighbouring sites.
2.5 Visual and acoustic privacy	1	
Habitable windows are not to directly face habitable windows or open space of neighbouring dwellings unless direct views are screened or other appropriate measures are incorporated into the design	No	The proposed northern side windows to the roof addition, and the proposed balcony to the roof addition, directly face neighbouring open spaces.
 Maximum size of balconies: 10m² in area 1.5m deep 	No	The proposed balcony to the roof addition has a minimum dimension of 4m, and has an area of 20m², contrary to the controls.

Development Control	Compliance	Comment
		The proposed second floor balcony will result in additional visual and acoustic privacy impacts on neighbours and is not supported. See under the heading <i>Visual privacy</i> below for further discussion regarding visual privacy impacts.
2.6 Solar access		
 Minimum of three hours of sunlight to living areas and principal open space areas on 21 June Minimum of three hours of sunlight maintained to at least 50% of principal open space areas of adjoining properties on 21 June. Avoid unreasonably overshadowing of solar collectors (including habitable windows). 	Yes	The shadow diagrams submitted with the application demonstrate that the proposal would give rise to minor additional shadowing, with a minor increase in shadowing to the rear private open space of 34 Gardyne Street and to the roof of 34B Gardyne Street on 21 June. Although the proposal complies with DCP solar access requirements, the solar access impact is not supported in the context of the exceedance of the height of buildings and FSR development standards as previously discussed in this report.
2.7 Views		
 Views from the public domain are to be maintained Development to be designed and sited so as to enable a sharing of views with surrounding dwellings particularly from habitable rooms and decks. 	Yes	The proposal does not have any known view impacts.
2.9 Landscaping and open space	ce	
 Overall open space: 40% of site area Overall landscaped area: 15% of site area Minimum area of 25m² for private open space Front open space: 50% of front building setback area Front landscaped area: 50% of front open space provided 	Not applicable	The proposal does not reduce landscaping or open space at the site.

2.12 Battle axe blocks				
Maximum of one storey in height	No	The proposed development is three storeys in height, contrary to the control. The additional storey and associated balcony result in additional amenity impacts to neighbours and are not supported. See the Waverley LEP clause 4.6 section of this report above, and the heading <i>Visual privacy</i> , for further discussion.		

The following is a detailed discussion of the issues identified in the compliance tables above in relation to the Waverley DCP 2012.

Visual privacy

The proposal includes several elements which have the potential to affect the visual privacy of neighbours, including replacement of the first floor balcony, alterations to the northern fenestration at ground and first floor levels, and the second floor addition and associated balcony. The amenity impacts of each of these elements are considered below.

Replacement of first floor balcony

The application proposes to demolish the existing first floor east-facing balcony, which has a total area of 7.3m² and replace it with a larger asymmetrical curved terrace with a total area of 11.3m² and a maximum depth of 2.4m. The proposed terrace exceeds the 10m² DCP area control by 1.3m² and exceeds the 1.5m DCP balcony depth control by 900mm.

An almost identical balcony has previously been approved under application DA-284/2021 however has not yet been constructed.

The proposed exceedance is acceptable on merit. The balcony's asymmetrical design reduces the useability of its southern part thus reducing the likely intensity of use. Additionally, the balcony does not provide a materially different outlook from the existing balcony to be replaced in terms of height and angles of view, complies with the height of buildings development standard and is not contrary to setback controls.

Alterations to ground floor northern elevation windows

The replacement of two ground floor northern elevation windows with five narrower windows will not increase overlooking of neighbouring properties. The narrower windows will generally provide a reduced field of vision and outlook toward the rear yard of 409 Bronte Road will be obscured by the northern boundary fence.

Alterations to first floor northern elevation windows

The replacement of two first floor northern elevation windows with two narrower windows will reduce overlooking of neighbouring properties and is supported.

Second floor additions

The application proposes an additional storey at second floor level containing a study room and featuring five north-facing floor-to-ceiling windows. The study room provides access to a new second floor balcony with an area of $20m^2$ and a minimum depth of 4m.

The proposed windows and balcony are not supported due to visual privacy impacts on 409 Bronte Road to the north and 34B Gardyne Street to the east.

The proposed north windows and second floor balcony result in a material increase in overlooking opportunities. The proposal increases the number of vantage points from which the rear yard and rear of the dwelling at 409 Bronte Road can be observed. The proposal provides vantage points from a different, higher, angle than the existing first floor windows and balcony.

It is acknowledged that the outlook north from the site is significantly obscured by vegetation, however vegetation is not a permanent feature and therefore cannot be relied on as a privacy measure. It is also acknowledged that the land at 409 Bronte Road is approximately 2m lower than the subject site therefore reducing overlooking impacts, however the impacts are not fully mitigated by the difference in levels.

The proposed second floor balcony may also result in additional overlooking of 34B Bronte Road. However, this is difficult to determine. The applicant has provided a diagram showing that there is no overlooking form the western part of the proposed balcony, however the applicant has not demonstrated that there will be no overlooking from the eastern part of the balcony.

The increase in overlooking cannot be supported in the context of the non-compliances with Waverley LEP 2012 development standards and Waverley DCP 2012 controls as set out below.

The second floor addition exceeds the LEP height of buildings and FSR development standard, results in a three-storey building contrary to the DCP single-storey battle-axe block control, and includes windows facing adjacent private open space contrary to the DCP visual privacy controls.

The second floor balcony is accessed from the LEP non-compliant additional storey, the balcony balustrade exceeds the LEP height of building development standard, the balcony exceeds the DCP balcony size controls, and the DCP single-storey battle-axe block control. The balcony is located higher than neighbouring balconies and does not feature mitigation measures to sufficiently protect neighbouring amenity. In these circumstances the additional overlooking is unreasonable, and the application should be refused.

2.2. Other Impacts of the Development

The proposal is considered to have detrimental environmental and social impacts on the locality and is recommended for refusal.

2.3. Suitability of the Site for the Development

The site is not considered suitable for the proposal.

2.4. Any Submissions

The application was notified for 14 days in accordance with the *Waverley Community Development Participation and Consultation Plan*.

A total of three unique submissions were received from the following properties:

- 34B Gardyne Street
- 409 Bronte Road
- Bronte Beach Precinct committee

The following issues raised in the submissions have already been discussed and addressed in the body of this report and/or the Recommendation:

- Visual and acoustic privacy impacts, including impacts to 34B Gardyne Street and 409 Bronte Road.
- Visual impact viewed from 409 Bronte Road.
- Excessive size of second floor balcony.
- Excessive height and floor space ratio.

All other issues raised in the submissions are summarised and discussed below.

Issue: A solid balustrade should be provided to the proposed first floor balcony to reduce overlooking.

Response: Privacy issues relating to the proposed first floor balcony are discussed under the heading *Visual privacy* above. The proposed balcony is supportable on merit, however the application is recommended for refusal due to other issues.

Issue: The solid fuel fireplace may result in amenity issues for neighbours.

Response: The plans indicate that the fireplace is an existing feature of the dwelling.

2.5. Public Interest

The proposal is considered to have a detrimental effect on the public interest and is recommended for refusal.

3. REFERRALS

The following internal and external referral comments were sought:

3.1. Stormwater

Council's Stormwater Engineer raised no objection to the proposal subject to conditions of consent.

3.2. Tree Management

Council's Tree Management Officer raised no objection to the application.

4. CONCLUSION

The application has been assessed against the relevant matters for consideration under section 4.15(1) of the *Environmental Planning and Assessment Act 1979*. It is recommended for refusal.

5. RECOMMENDATION TO WAVERLEY LOCAL PLANNING PANEL

That the development application be REFUSED by the Waverley Local Planning Panel for the reasons contained in Appendix A.

Report prepared by:	Application reviewed and agreed by:
Mand My	Oblice
David Knight	Kylie Lucas
Senior Development Assessment Planner	Acting Manager, Development Assessment
Date: 2 February 2023	Date: 9 February 2023

Reason for WLPP referral:

1. Departure from any development standard in an EPI by more than 10% $\,$

APPENDIX A – REASONS FOR REFUSAL

1. The application does not satisfy section 4.15 (1)(a)(i) of the Act as it contrary to the following provisions of *Waverley Local Environmental Plan* (WLEP) 2012:

a. Clause 4.3 Height of Buildings

The application exceeds the maximum allowable height of 8.5m and the applicant's written request under clause 4.6 of WLEP has failed to adequately address the required matters under subclauses 4.6 (3)(a) and (d) of WLEP.

Details: The proposed height is not compatible with the height, bulk and scale of the desired future character of the locality and does not preserve the environmental amenity of neighbouring properties contrary to clause 4.3 (1)(a) and (d) of WLEP.

b. Clause 4.4 Floor Space Ratio

The application exceeds the maximum allowable Floor Space Ratio (FSR) of 0.5:1 and the applicant's written request under clause 4.6 of WLEP has failed to adequately address the required matters under subclauses 4.6 (3)(b), (c) and (d) of Waverley LEP

Details: The proposal is an overdevelopment of the site, is not compatible with the bulk and scale of the desired future character of the locality, does not preserve the environmental amenity of neighbouring properties and the proposed density does not appropriately correlate with the height of buildings 8.5m development standard, contrary to subclauses 4.4 (1) (c) and (d) of WLEP.

2. The application does not satisfy section 4.15 (1)(a)(iii) of the Act as it is contrary to Waverley Development Control Plan (WDCP) 2012, in respect to the following provisions:

Part B12 Design excellence

a. Objective (a) and controls (a) and (e) (iv), (v), and (vii), as the proposal does not achieve a high standard of architectural design appropriate to the building type and location and does not sufficiently consider the bulk and massing of the building, the relationship with neighbouring sites in terms of amenity, overshadowing and overlooking.

Part C2 Low Density Residential Development

- a. General Objectives (a), (b), (d) and (e) as the scale of development is not appropriate for the site and desired character of the area, as it detracts from neighbouring amenity, and as the proposal contravenes controls within section C2 as set out below.
- b. Section 2.5 *Visual and acoustic privacy* objectives (a) and controls (b) and (e) as the proposal unreasonably impacts on neighbouring residential properties due to an unacceptable loss of privacy, as the proposal includes windows which directly face neighbouring private open

- space, and as the proposed second floor balcony exceeds the maximum area and dimensions.
- c. Section 2.12 Battle axe blocks objective (b) and control (a) as the proposal is not of a size and scale which minimises adverse amenity impacts, and as the proposal further increases the height, bulk and scale of a building which already exceeds the single storey height control.
- 3. The application does not satisfy section 4.15 (1)(a)(iv) of the Act with respect to the *Environmental Planning and Assessment Regulation 2021* (the Regulations), as insufficient documentation has been provided to properly assess the application with respect to clause 24 of the Regulations, including but not limited to:
 - a. The Statement of Environmental Effects is insufficient, as it does not adequately document the environmental impacts of the development concerning overlooking from the second floor balcony and does not adequately document solar access impacts on 34 Gardyne Street.
- 4. The application does not satisfy section 4.15 (1)(b) of the Act as the proposed development is excessive in terms of its building massing, bulk and scale relative to the site area and dimensions, and consequently results in unacceptable amenity and visual impacts upon the locality and surrounding built environment.
- 5. The application is contrary to section 4.15 (1)(c) of the Act due to the site being unsuitable to accommodate the proposed development.
- 6. The application is contrary to section 4.15 (1)(e) of the Act in relation to the public interest as it is not compatible with the existing and desired future character of the locality and the broader Waverley local government area.

list of abbreviations

HWU

hot water unit

list of	abbreviations		
A/C	airconditioning	HDY	hydraulic
ALUM	aluminium	INT	internal
AP	access panel	KIT	kitchen
AS	adjustable shelf	LAM	laminate
BAL	balustrade	LDRY	laundry
BALC	balcony	LIN	linen
BDY	boundary	LV	louvre
BLWK	blockwork	LS	louver shutter
BS	bath spout	LVB	louvre blind
BSN	basin	MAT	floor mat
BWBP	brickwork bagged & painted	MB	metal balustrade
BWF	brickwork faced	MDF	medium density fibreboard
С	concrete	ME	mechanical exhaust
CBF	concrete- broom finish	MI	mirror
COF	concrete- off form	MPBR	membrane pebble ballast roof
CPS	concrete- polished & sealed	MR	metal roof
CST	concrete- steel trowel finish	MSB	main switch board
COS	check on site	MS	metal sheeting
CFC	compressed fibre cement	MT	mosaic tile
CJ	control joint	MW	microwave
COL	column	MX	mixer
CP	chrome plated	Ø	diameter
CPD	cupboard	OF	overflow
CPT	carpet	Р	pantry
CR CRW	cement render	PAV	paving
CHW	cement render waterproof	PB	plasterboard
CTP	ceramic tile	PB/ FR	plasterboard- fire resistant 90/90/90
DCH	cooktop drencher	PBM	plasterboard- moisture resistant
DGPO		PDWR	powder room
DGFO	double general purpose outlet double hung	PLY	plywood
DIN	dining	PNT	paint
DP	downpipe	PU PV	polyurethane
DPC	damp proof course	PV R	photo voltaic
DRY	Dryer	R RH	robe
DR	Drawer	RHS	rangehood rectangular hollow section
DW	dishwasher	RL	reduced level
EDB	electrical switch board	RWH	rainwater head
EGL	existing ground line	RWO	rainwater outlet
EQ	equal	SD	smoke detector
EX	existing	SH	shutters
EXT	external	SHA	shutters automated
F	fridge	SHR	shower rose
FC	fibrous cement sheet	SK	skirting
FCL	finished ceiling level	SLD	sliding door
FFL	finished floor level	SP	set plaster
FGL	finished ground level	SPM	set plaster moisture resistant
FHR	fire hose reel	SS	stainless steel
FP 	fixed panel	ST	stone
FR	freezer	STL	steel
FRL	fire resistance level	SWP	sewer pipe
FSL	finish structural level	Т	timber
FS	Fixed shelf	TB	timber- battens
FW	floor waste	TF	timber- frame
G GBL	glass/ glazing	TFB	timber- floorboards
GL	glass balustrade glass- louvre	THR	timber- handrail
GO	glass- obscure	TOF	top of fence
GALV	galvanised	TOW	top of wall
GALV	grated drain	TRH	toilet roll holder
GPO	general purpose outlet	TR	tiled roof
GU	gutter	TRZO TS	terrazo timber screen
HR	hanging rail	U/S	underside
HT	hose tap	VN	timber veneer
HTR	heated towel rail	VN VP	vent pipe
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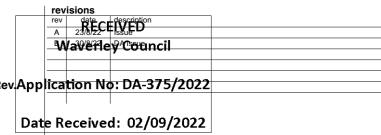
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drawing list

No.	Drawing Name	Re
DA01	Cover Sheet	В
DA02	Site Analysis	В
DA03	Site Plan	В
DA04	Existing Plan - Level 1	В
DA05	Existing Plan - Level 2	В
DA06	Existing Plan - Level 3	В
DA07	Existing Plan - Roof Plan	В
DA08	Proposed Plan - Level 1	В
DA09	Proposed Plan - Level 2	В
DA10	Proposed Plan - Level 3	В
DA11	Proposed Plan - Roof	В
DA12	Proposed Plan - Dormer Roof	В
DA13	North Elevation	В
DA14	East & Street Elevation	В
DA15	South Elevation	В
DA16	West Elevation	В
DA17	Section AA	В
DA18	Section BB & CC	В
DA19	Shadow Diagrams - 9am	В
DA20	Shadow Diagrams - 10am	В
DA21	Shadow Diagrams - 11am	В
DA22	Shadow Diagrams - 12pm	В
DA23	Shadow Diagrams - 1pm	В
DA24	Shadow Diagrams - 2pm	В
DA25	Shadow Diagrams - 3pm	В
DA26	Shadow Diagram Elevations	В
DA27	Shadow Diagrams as viewed from the Sun	В
DA28	Shadow Diagrams as viewed from the Sun 2/2	В
DA29	Area Calculations	В
DA30	Landscape Area Calculation	В
DA31	Height Plane Diagram	В
DA32	Perspectives	В
DA33	View Analysis	В

Country 10	equirements						Show on DA Plans	Show on CC/CDC Plans & specs	Certifier Check
Window / d no.	door Orientatio	n Area of glass inc. frame (m2)	Oversha Height (m)	Distance (m)	Shading device	Frame and glass type			
W3.05	N	1.6	2.3	2	none	aluminium: thermally broken, double Lo-Tsol/air gap/clear , (U-value: 3.1, SHGC: 0.27)			
W3.06	N	1.6	2.3	2	none	aluminium: thermally broken, double Lo-Tsol/air gap/clear , (U-value: 3.1, SHGC: 0.27)			
W3.07	N	1.6	2.3	2	none	aluminium: thermally broken, double Lo-Tsol/air gap/clear, (U-value: 3.1, SHGC: 0.27)			
Skylights					ne specifications listed in the	all to be a second			
					to each skylight:	able below.	V	×.	V
	ht may either n					Coefficient (SHGC) no greater than that listed in		~	~
Each skylig the table be		_					.1		
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the table be Skylights	mber Area o	fglazing	Shading no shad		timbe	e and glass type cr, low-E internal/argon fill/clear external, (or lue: 2.5, SHGC: 0.456)			
Skylights Skylight nu	mber Area o inc. fra	fglazing	1		timbe	er, low-E internal/argon fill/clear external, (or			



Development Application

Wheeler House Bronte


at


32 Gardyne Street, Bronte


for


Deborah and Charles Wheeler


I		job no.	WHE	dwg no.
	CORBEN ARCHITECTS	drawn	ABW	DA01
	PO Box 1021 Neutral Bay NSW 2089 Australia 02 9904 1844	checked	ABW	revision
	mail@corben.com.au corben.com.au Nominated Architect: Philip Corben (Reg. No. 4616)	scale	NTS @A3	В

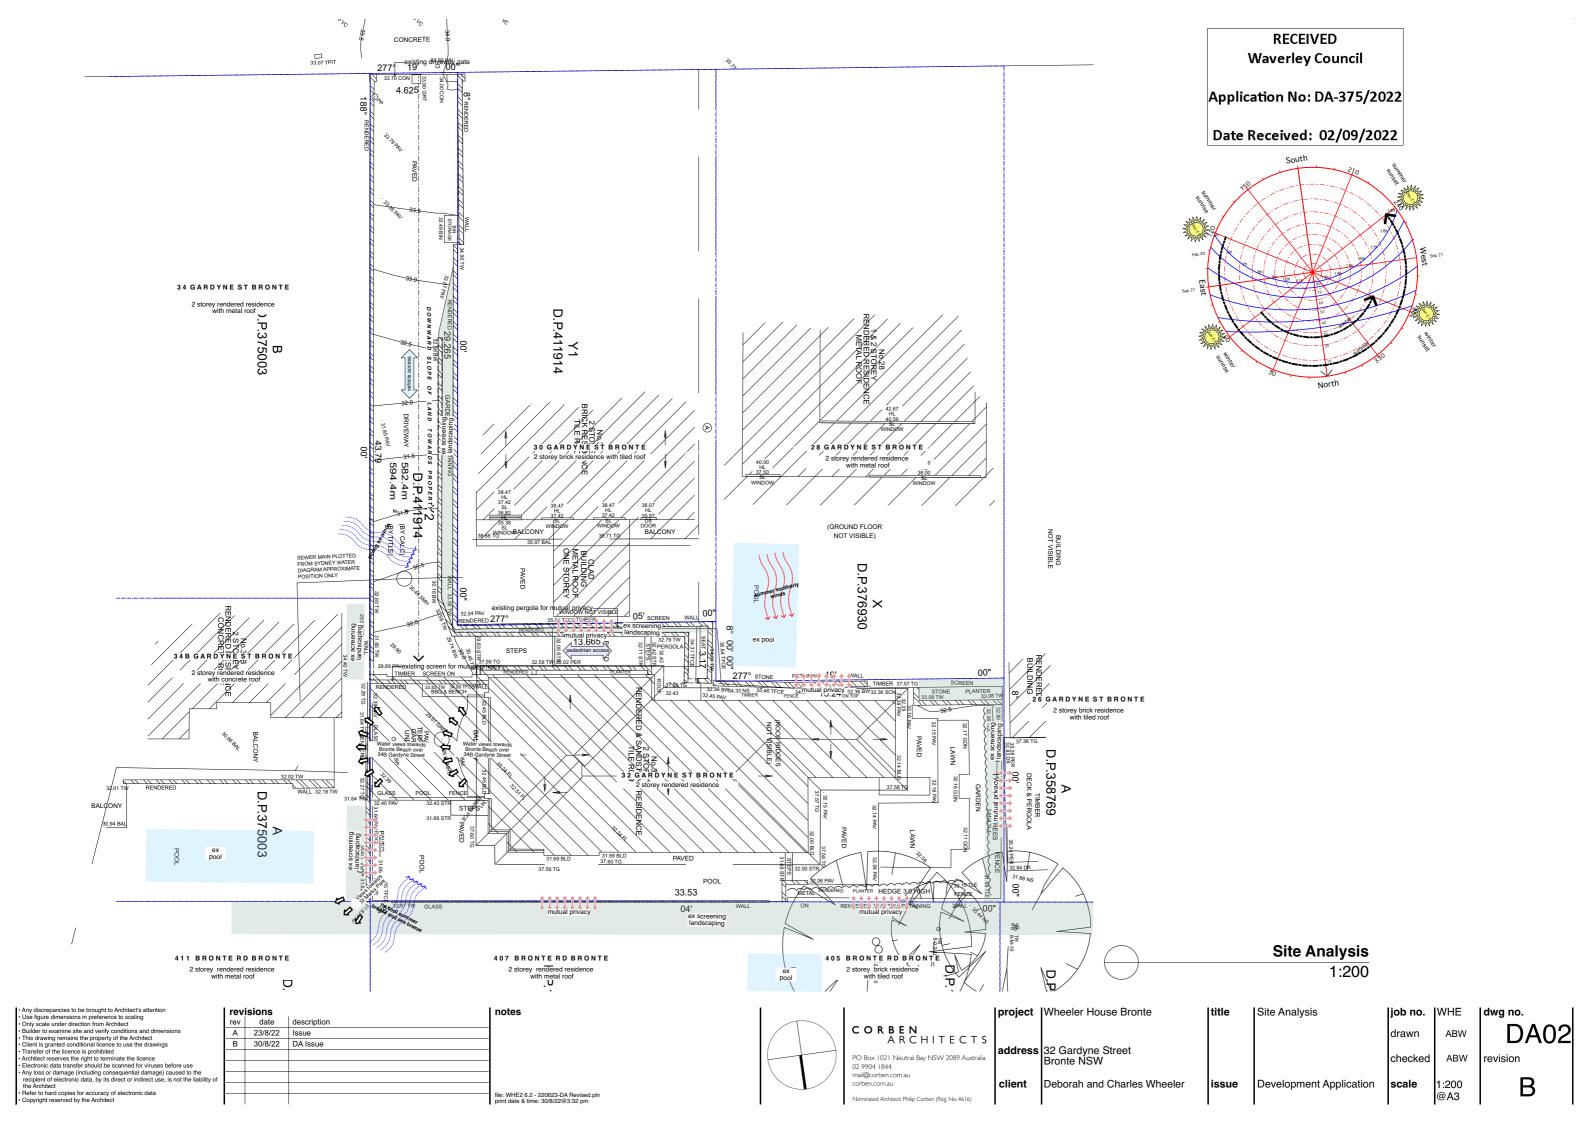


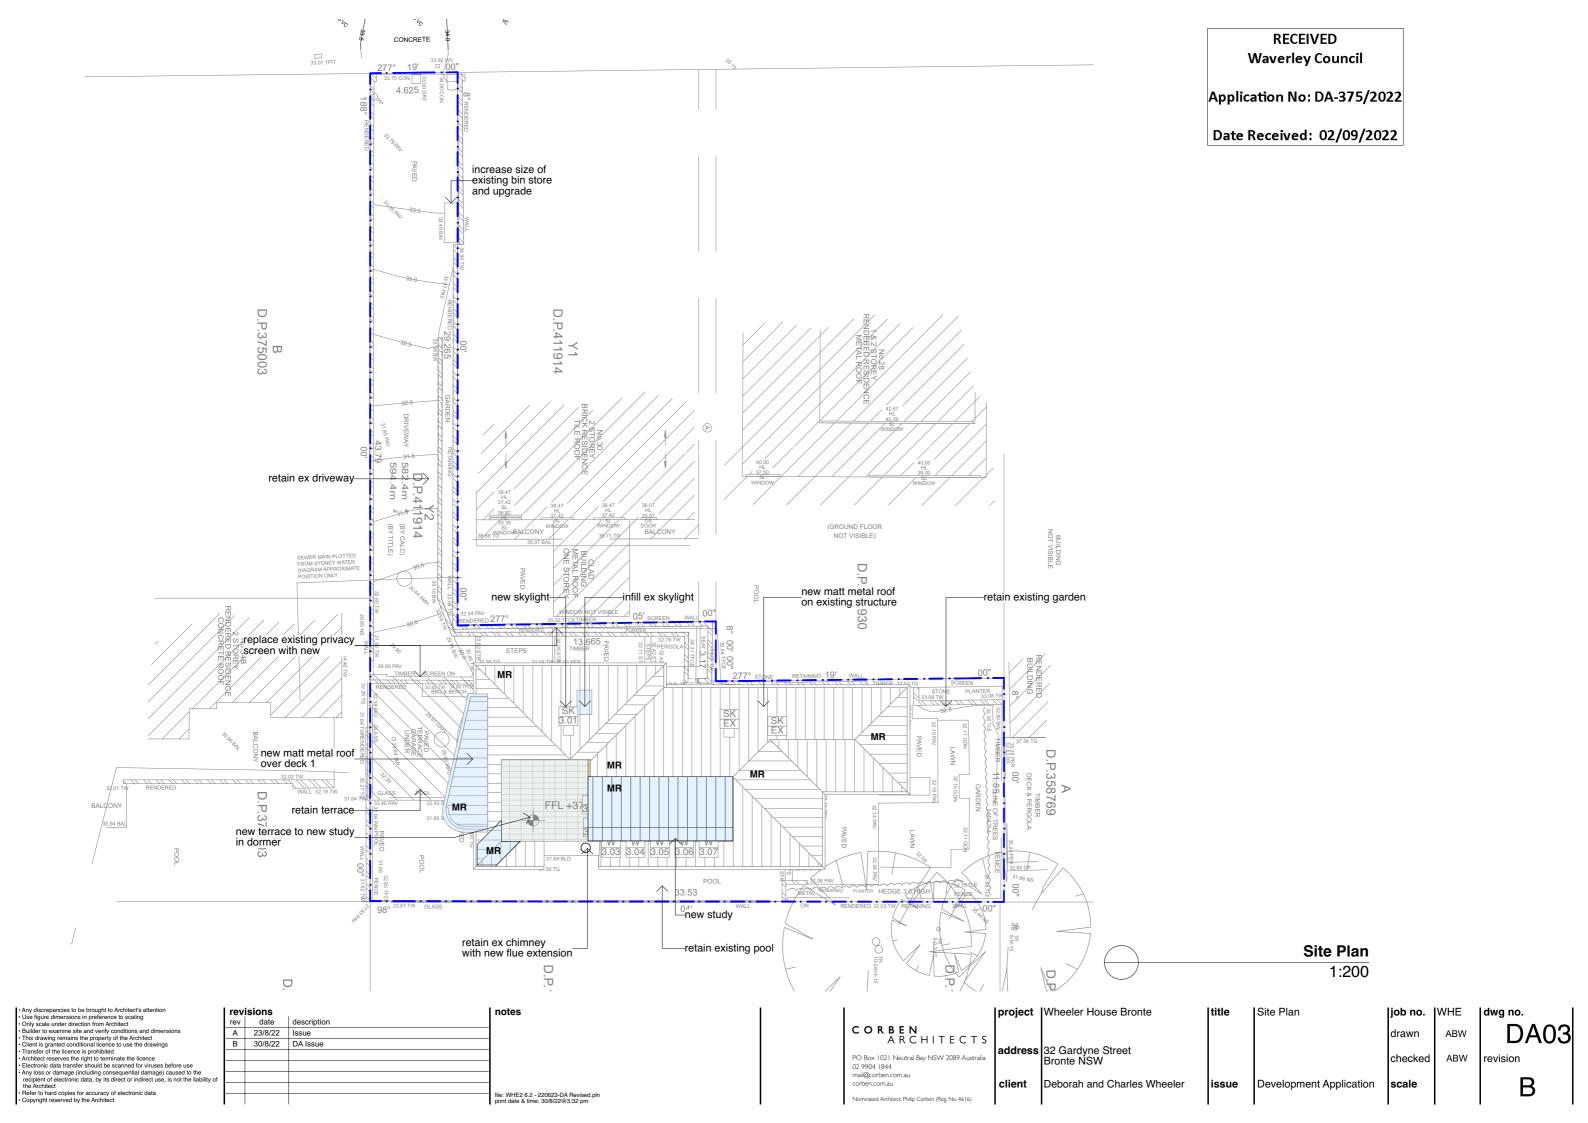


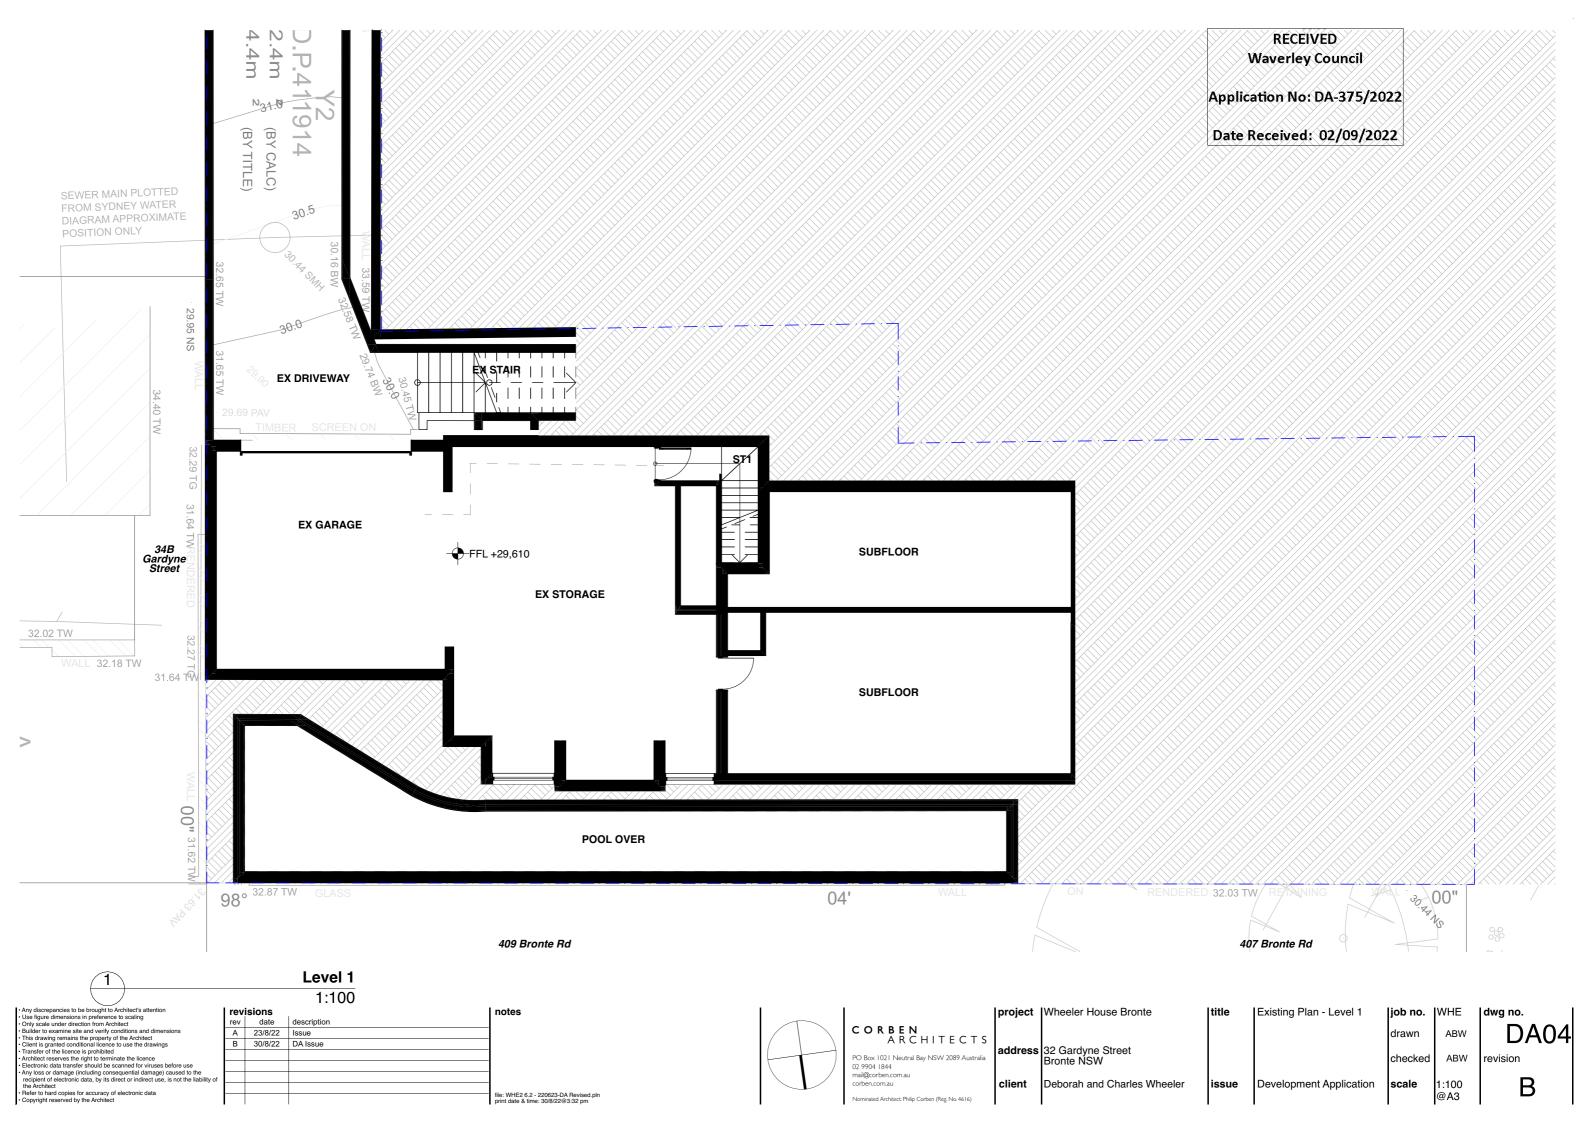


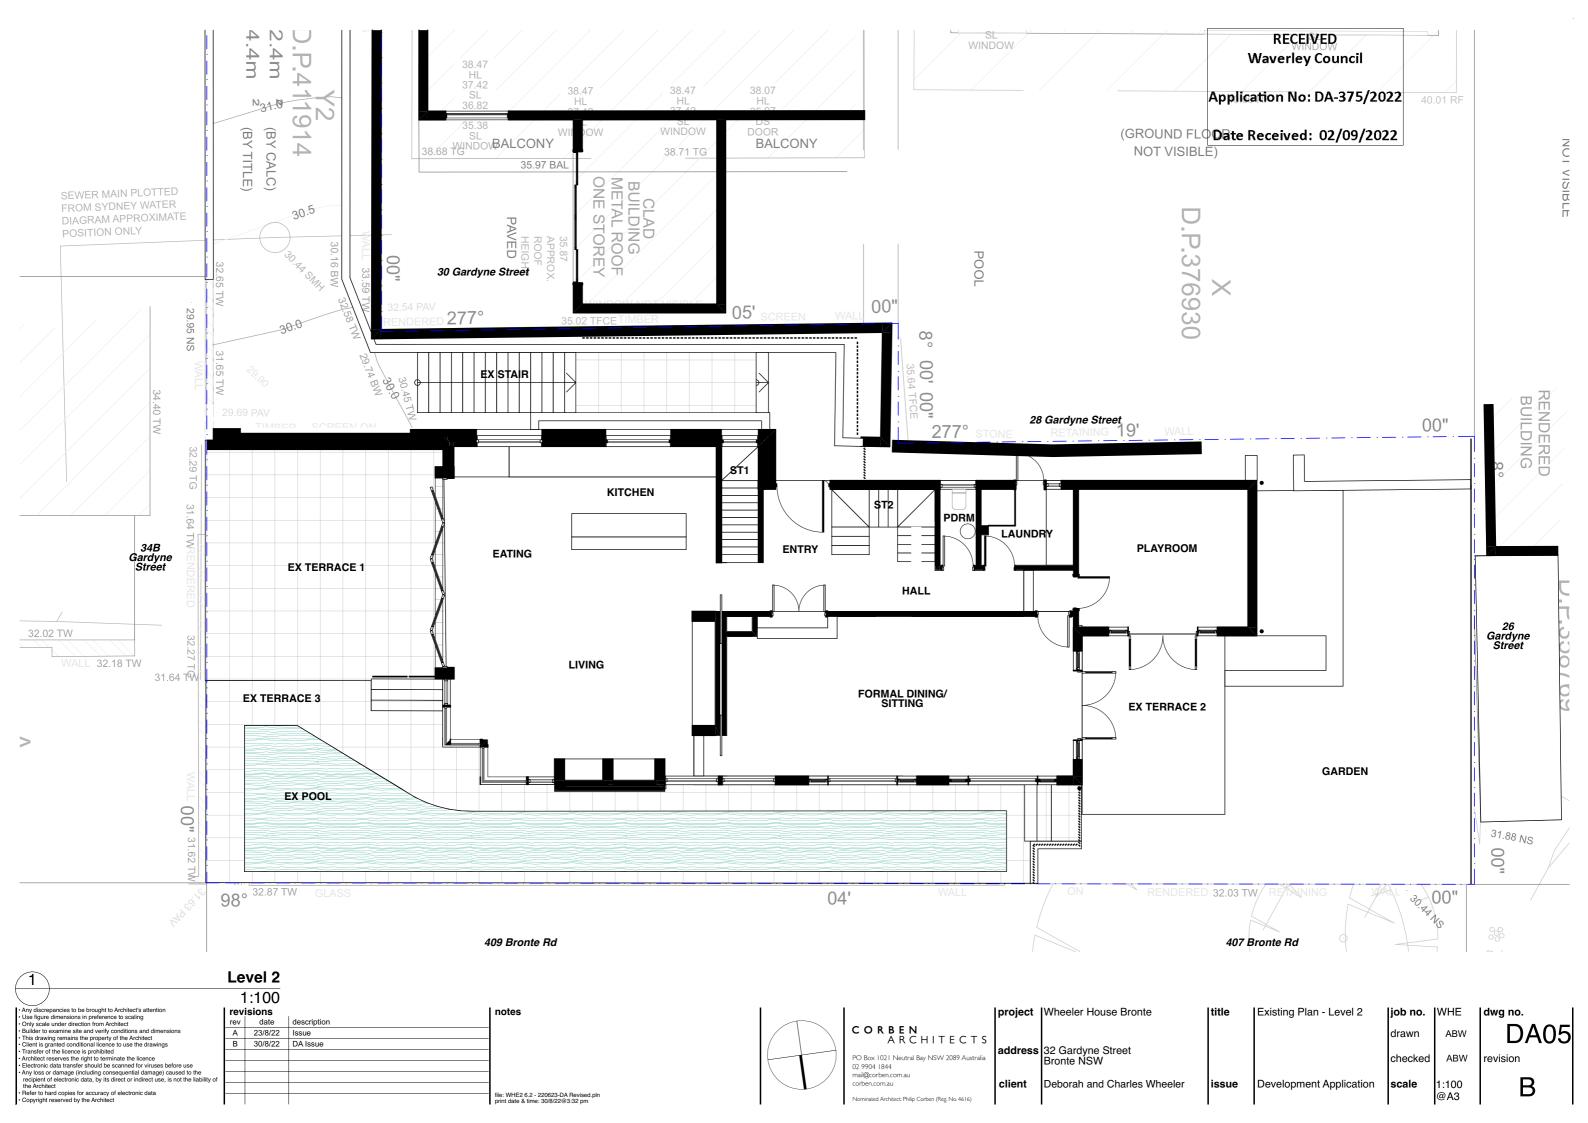


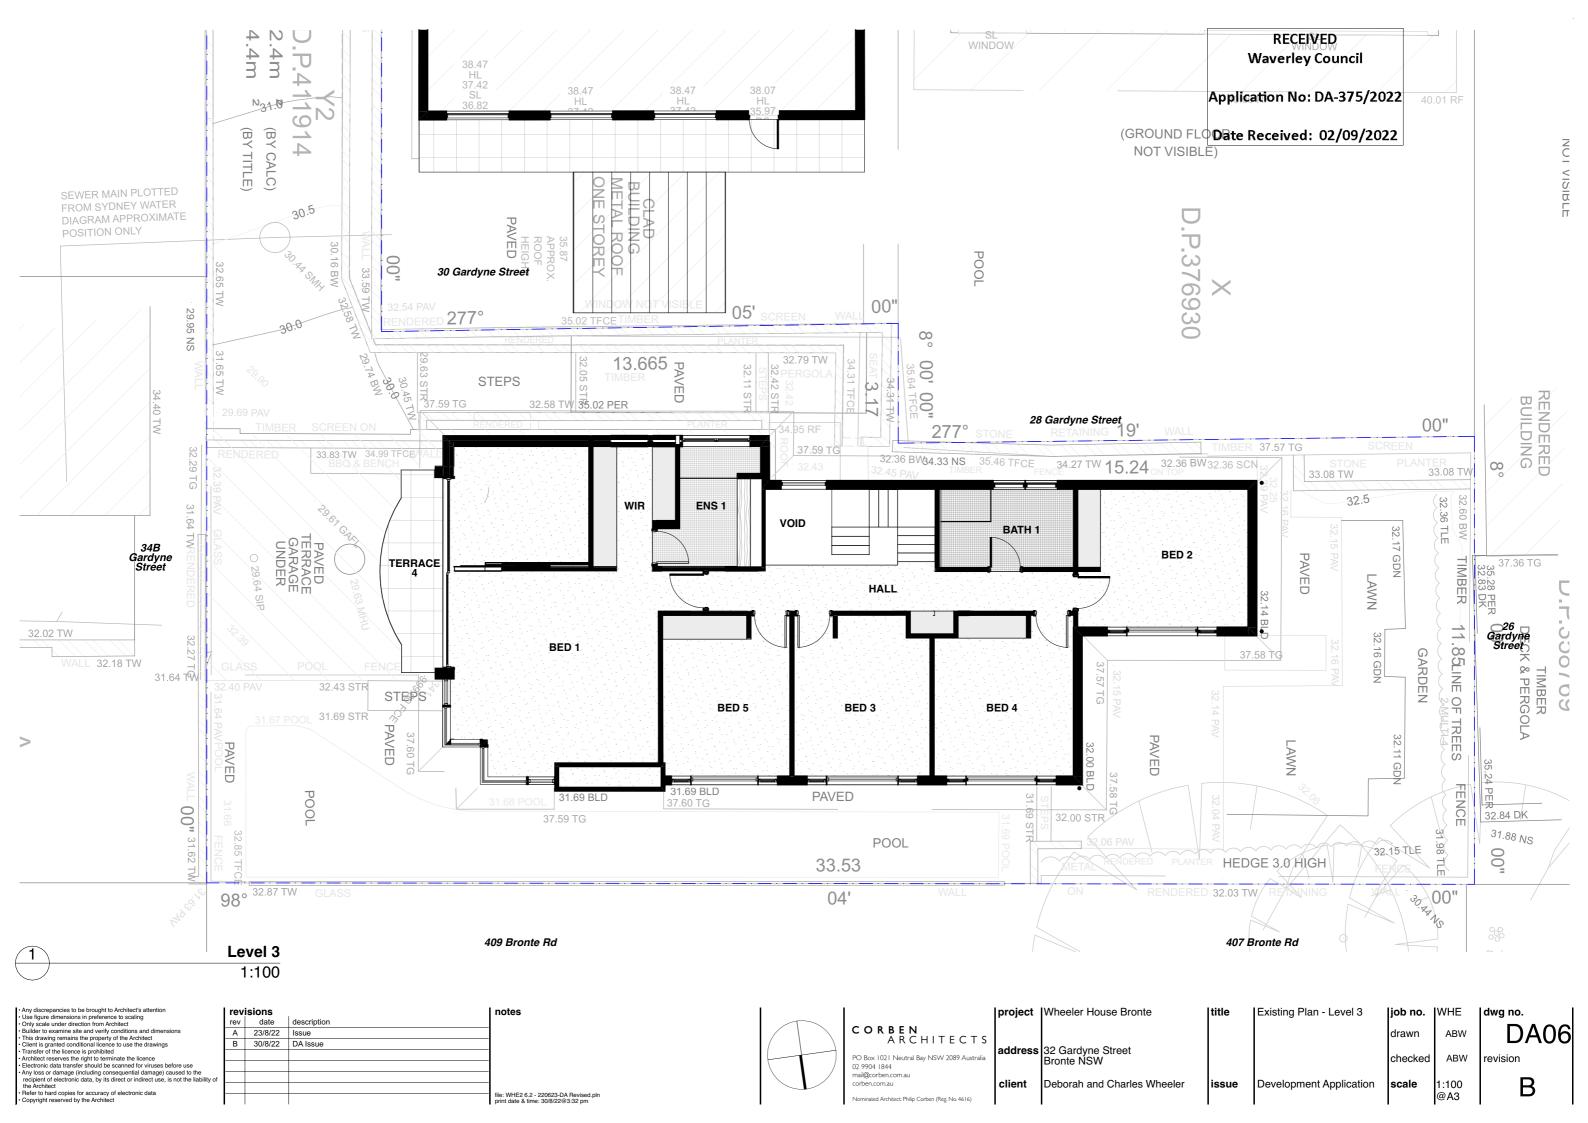


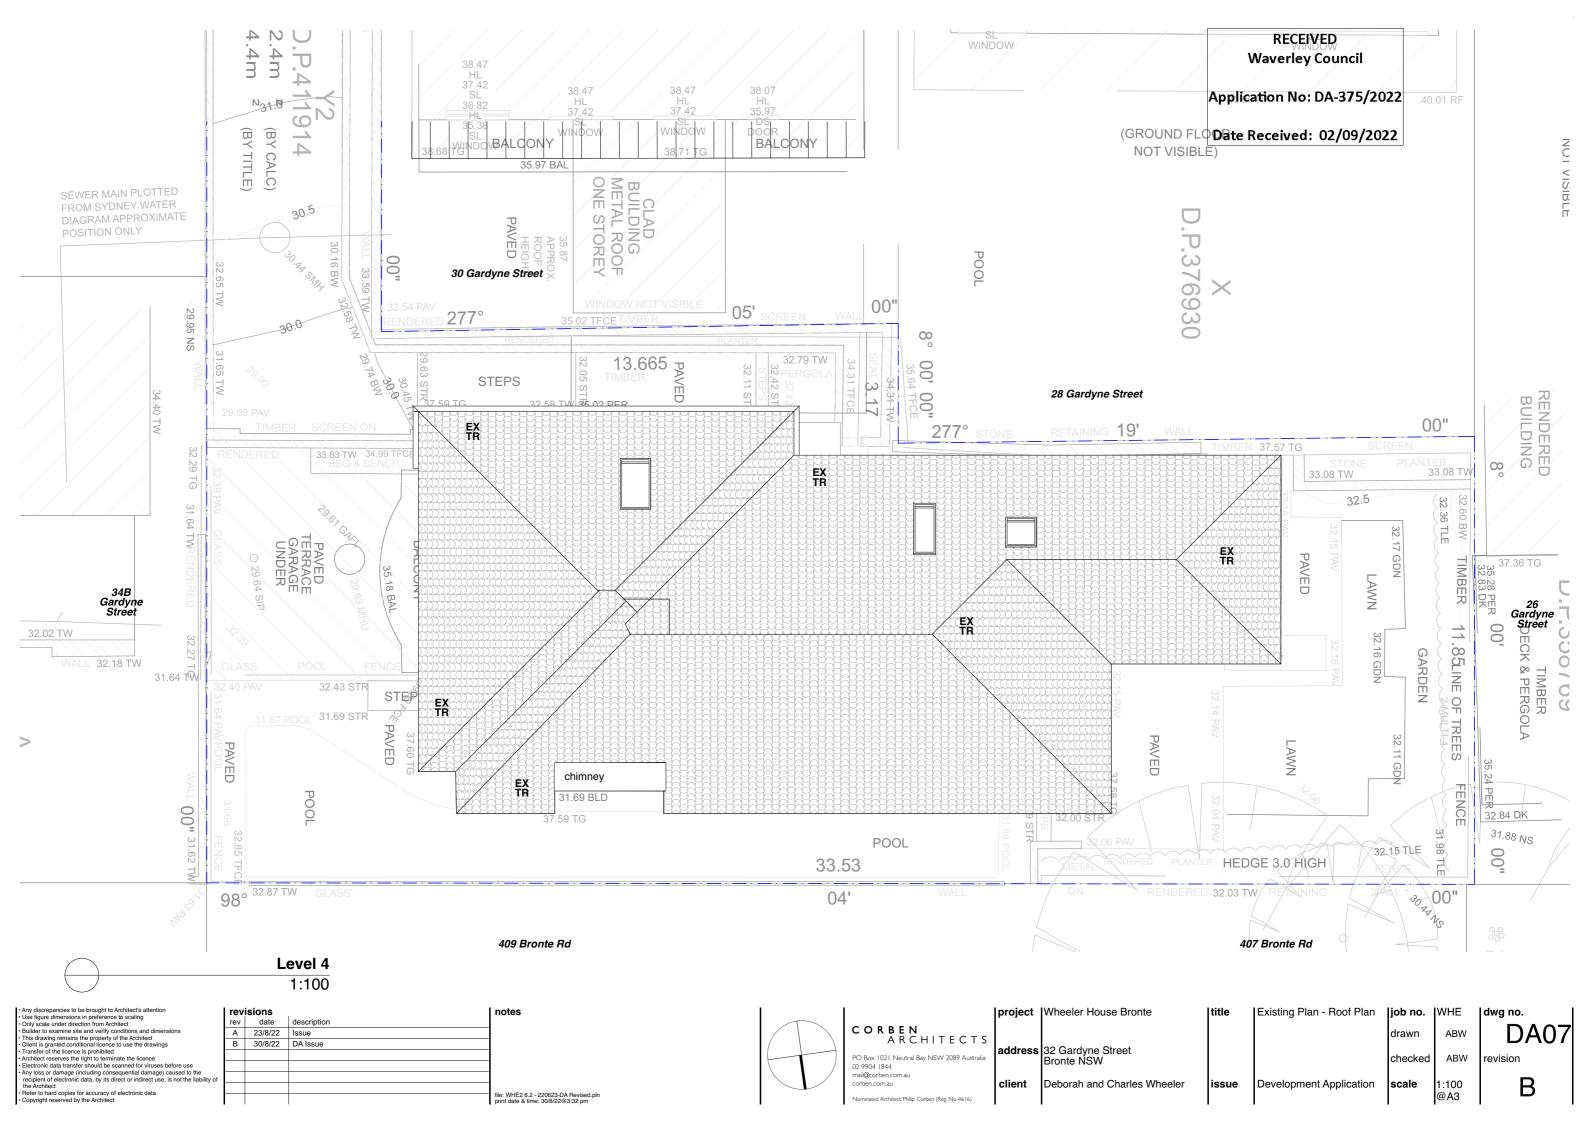


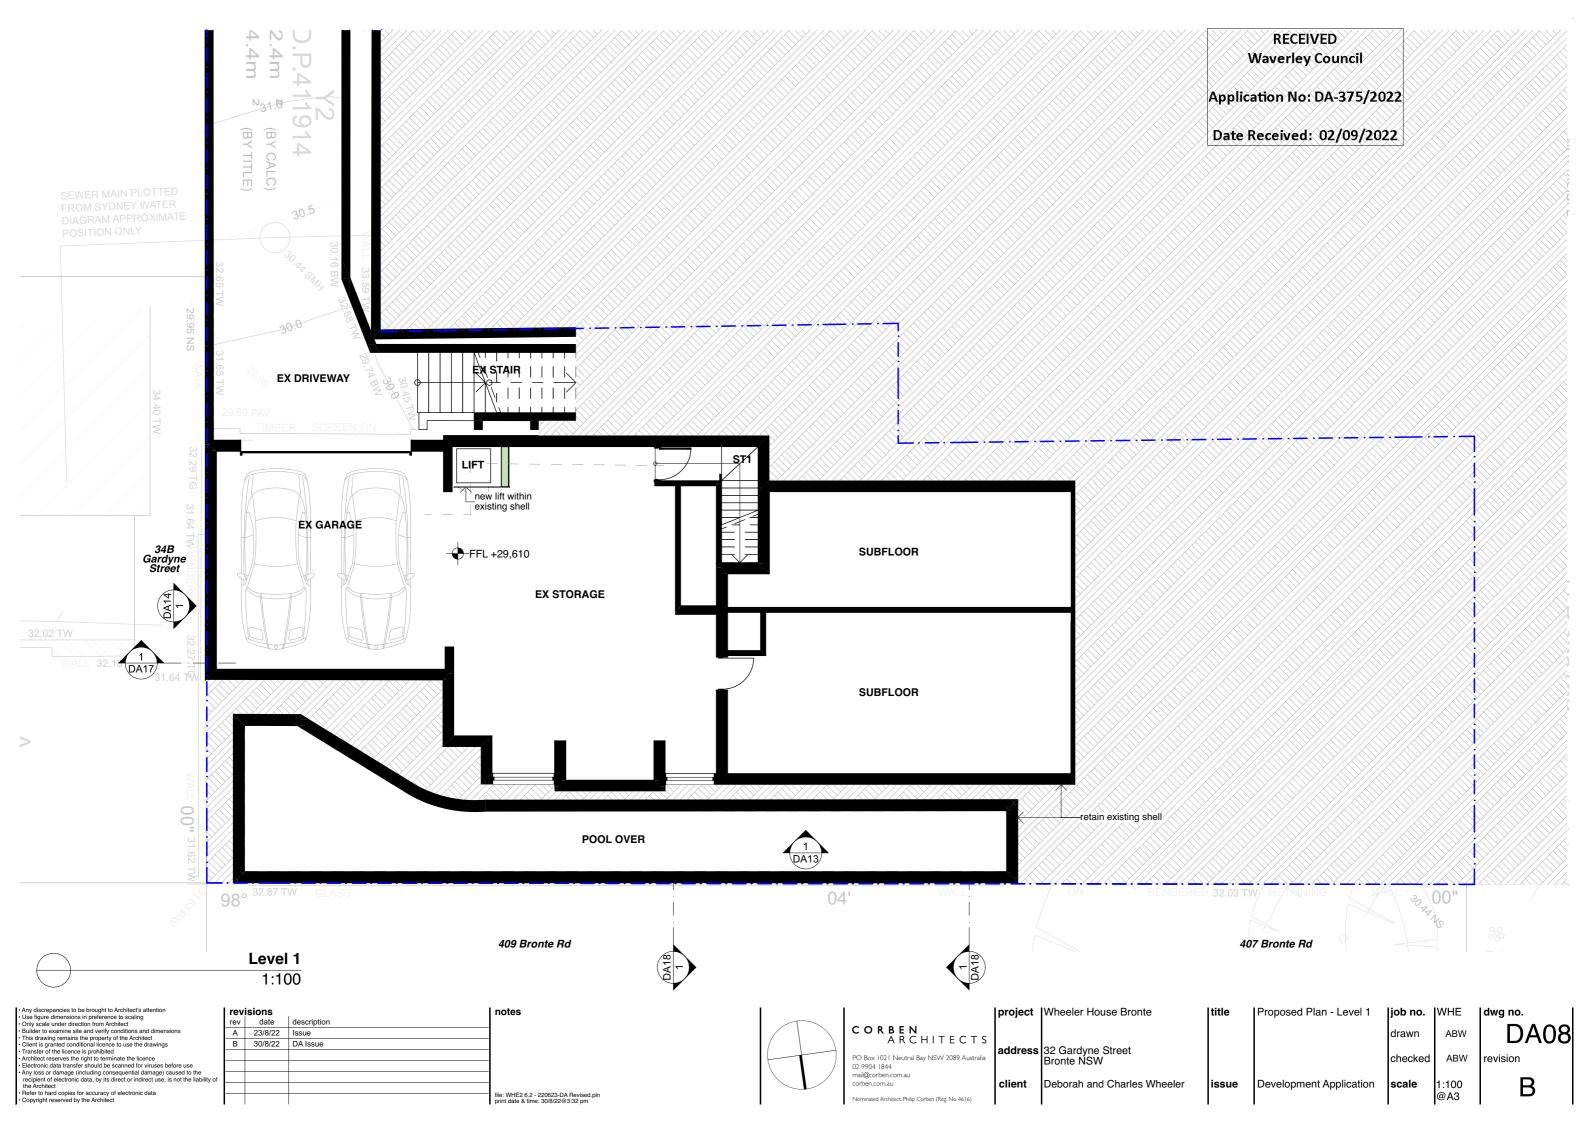

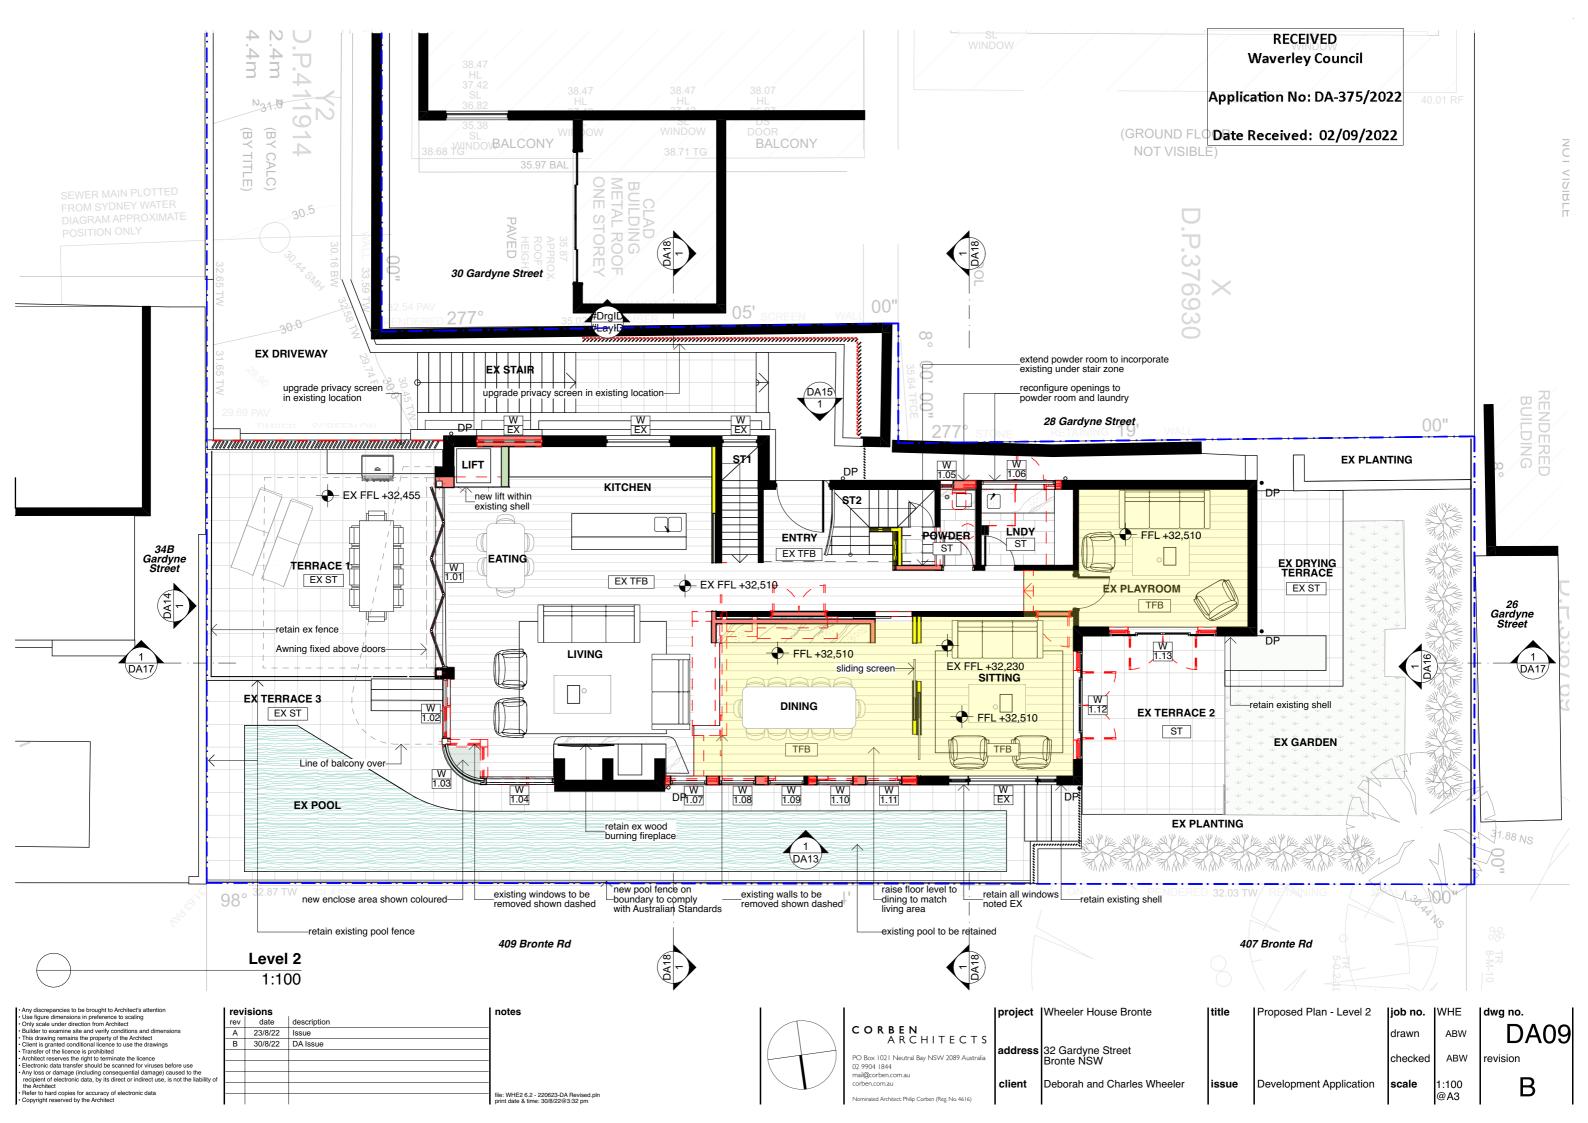

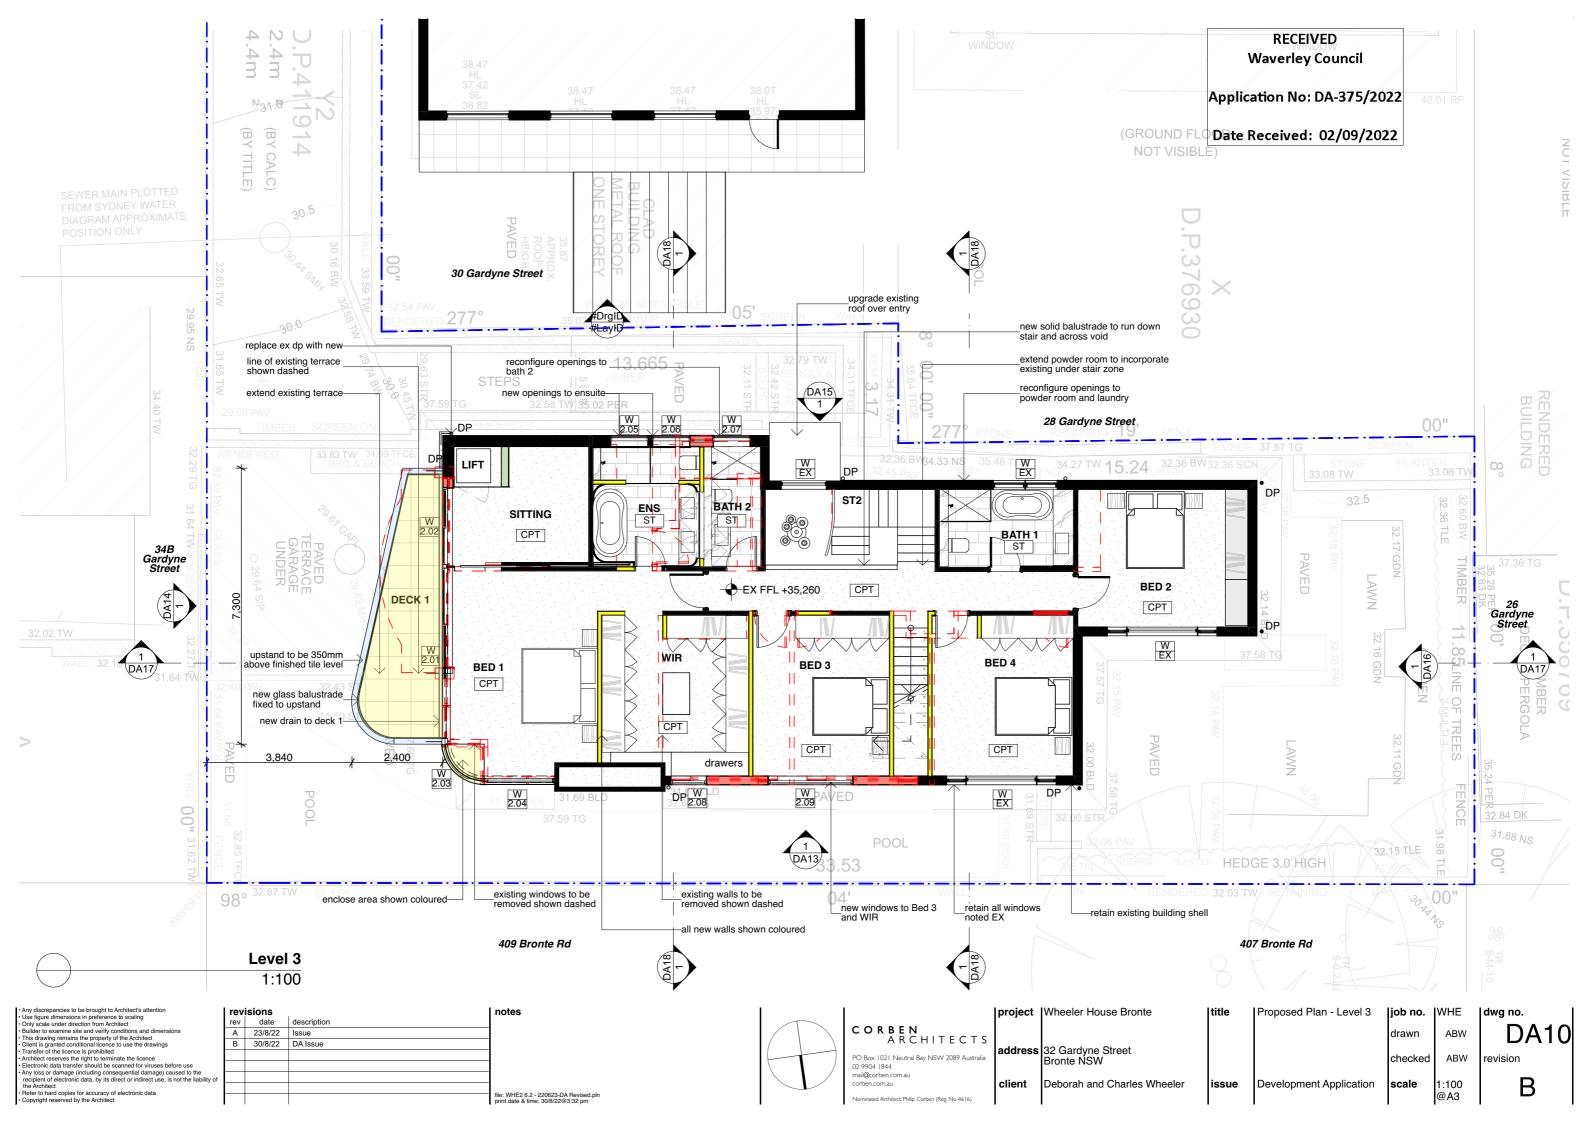


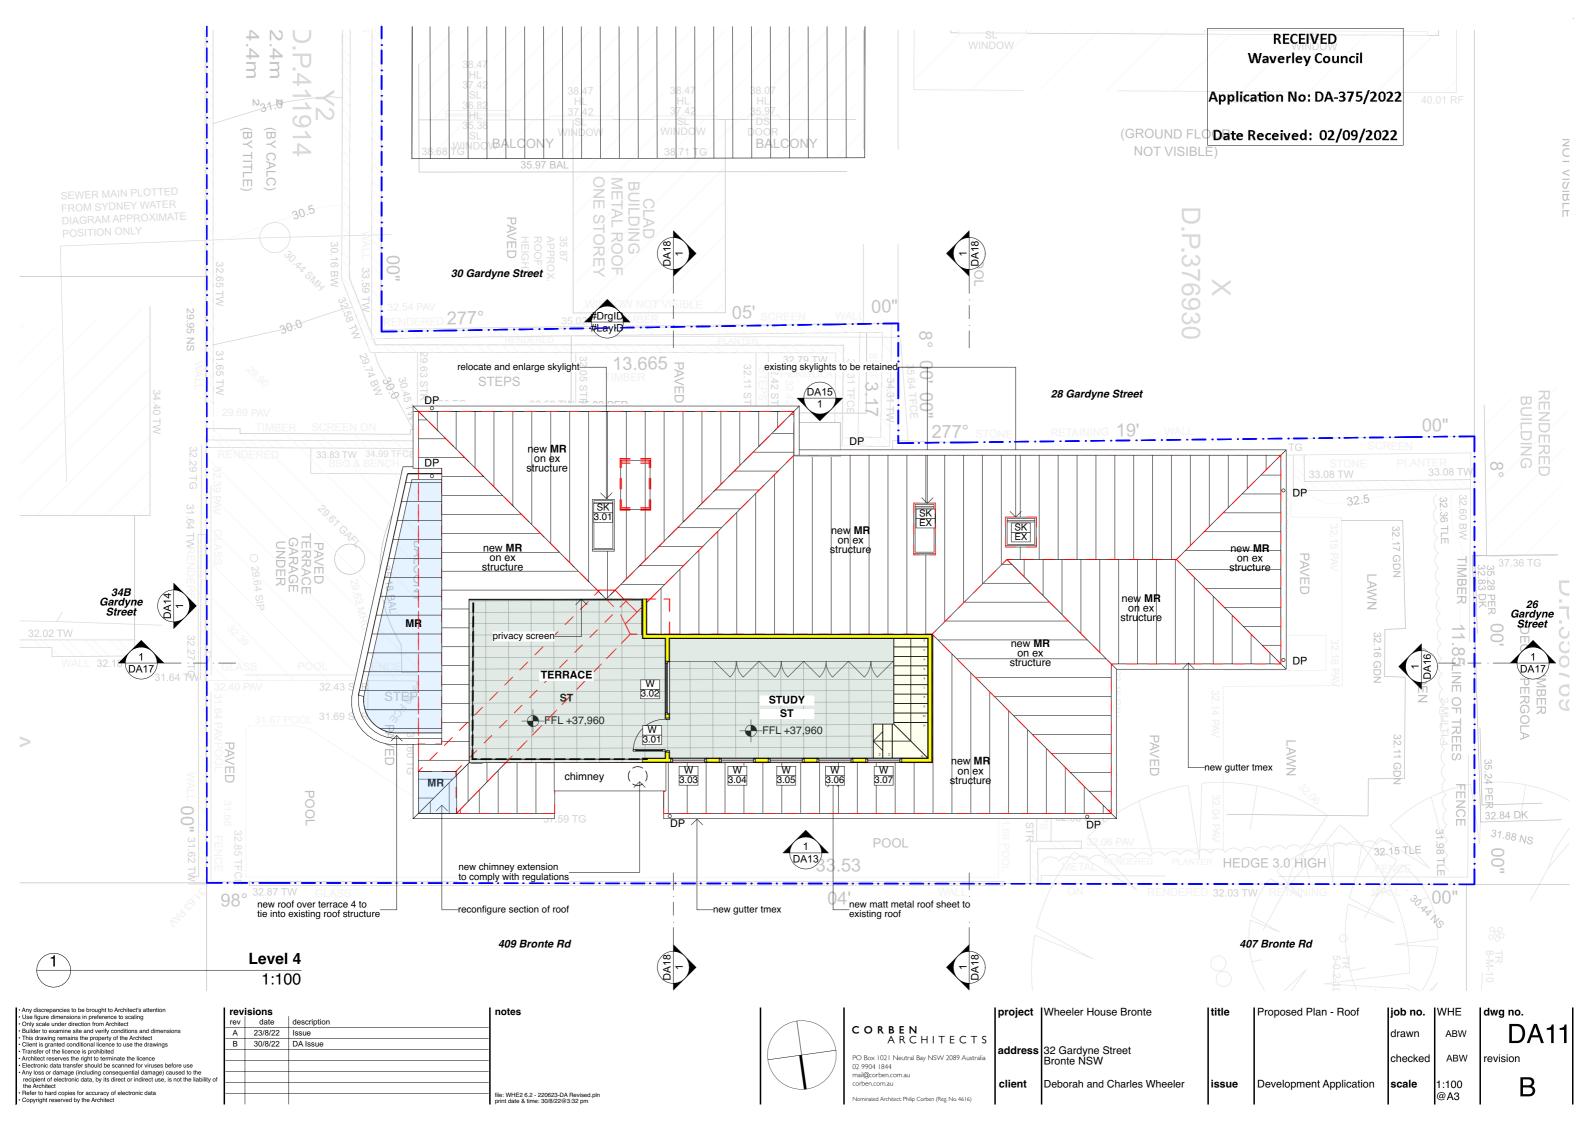

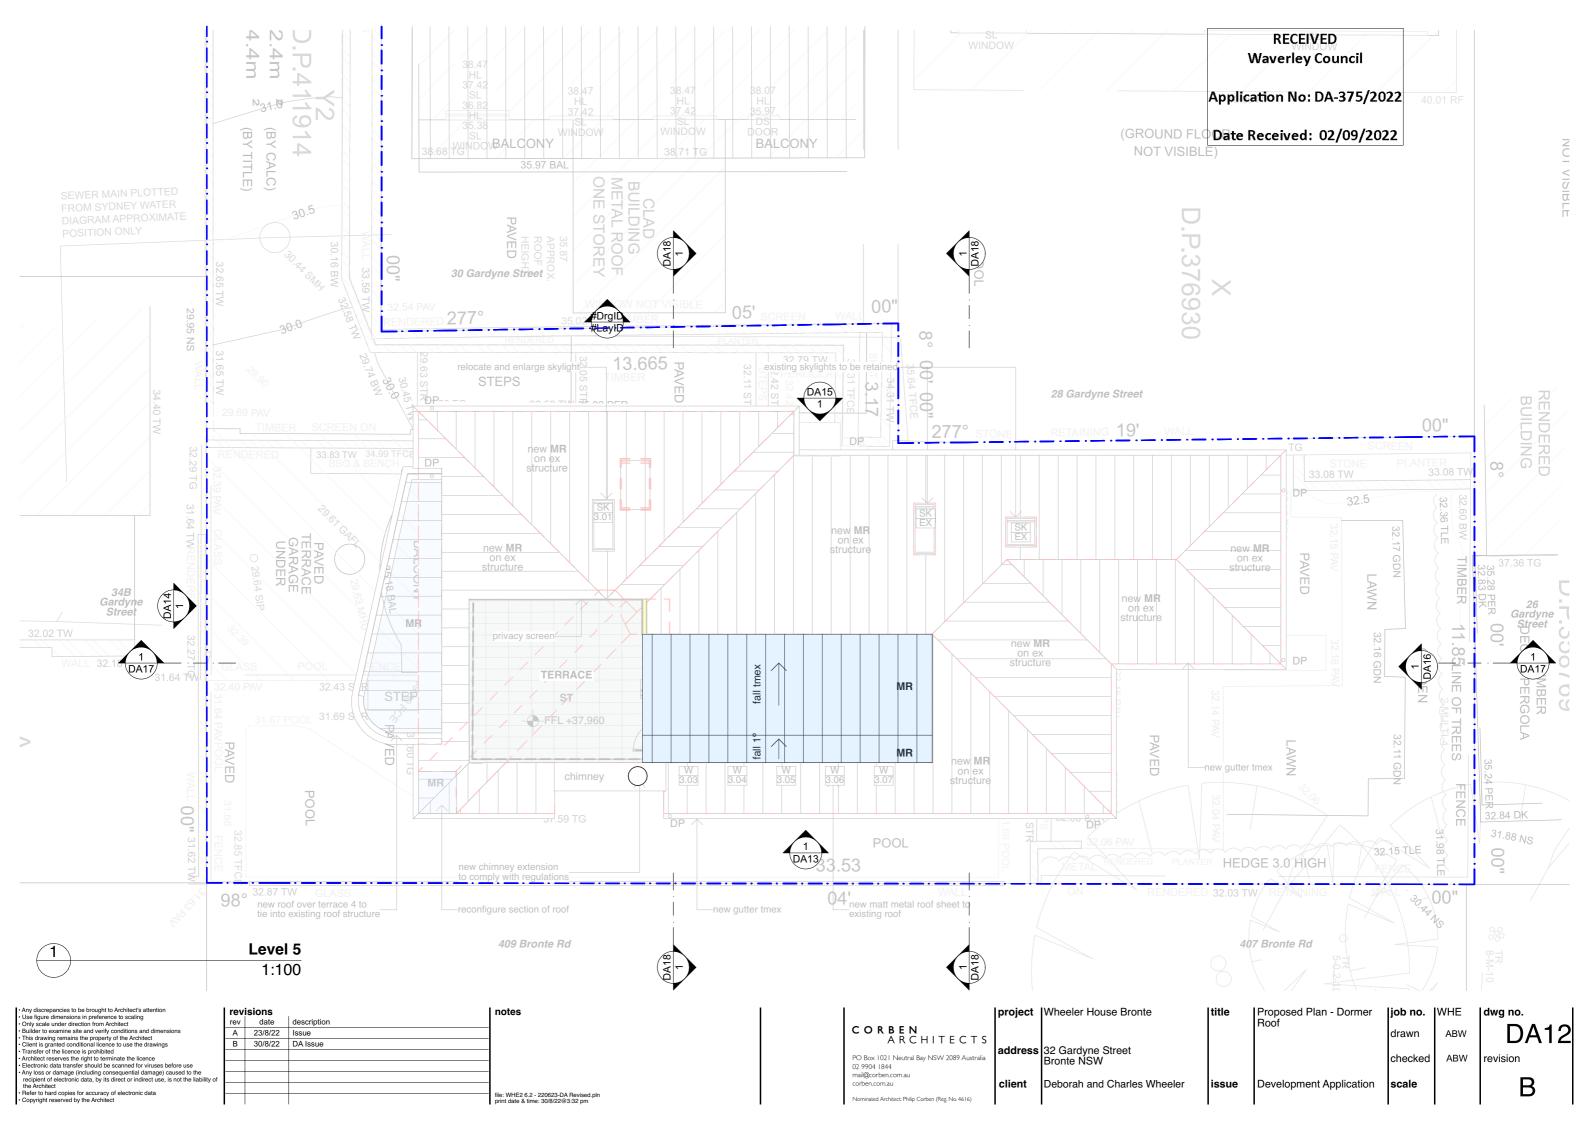

Application No: DA-375/2022

Date Received: 02/09/2022

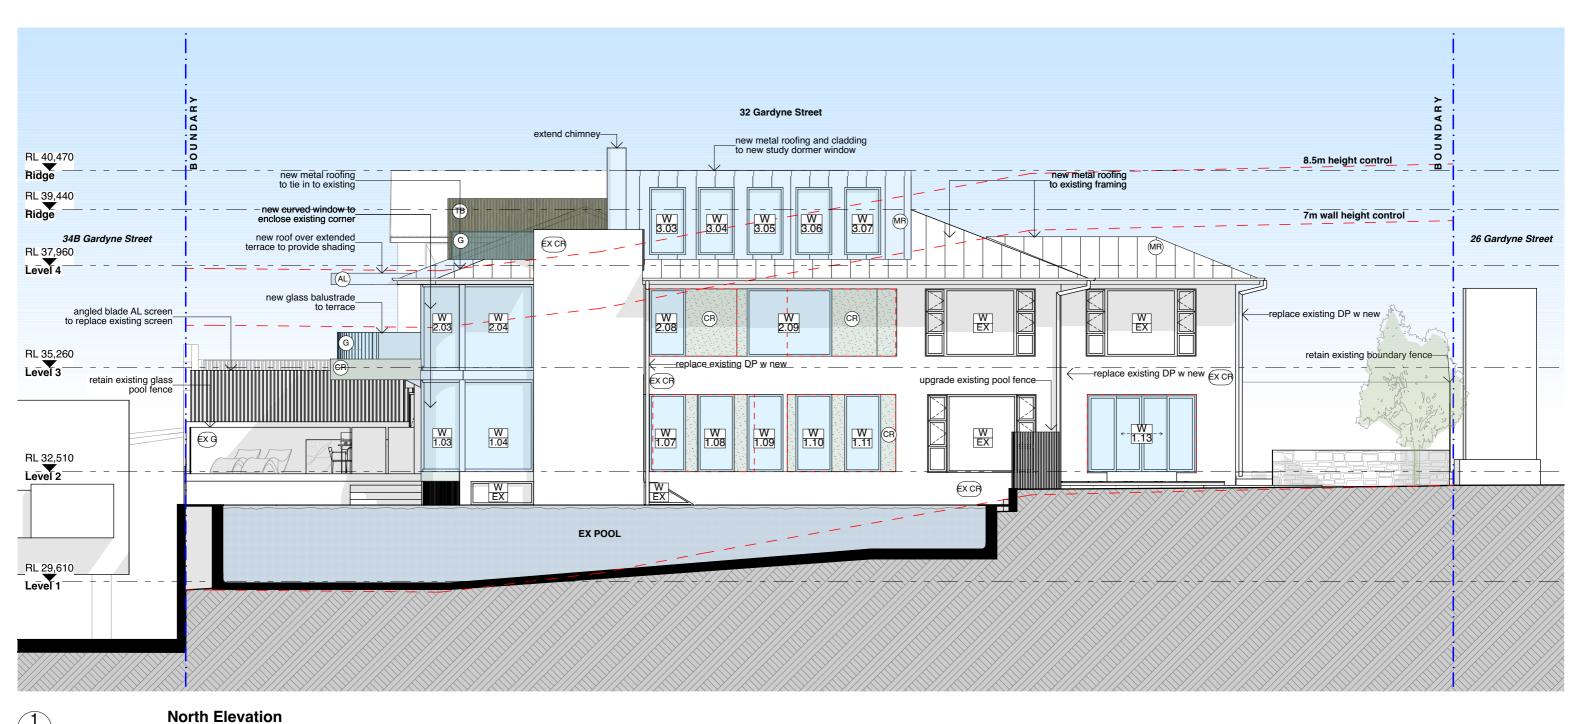


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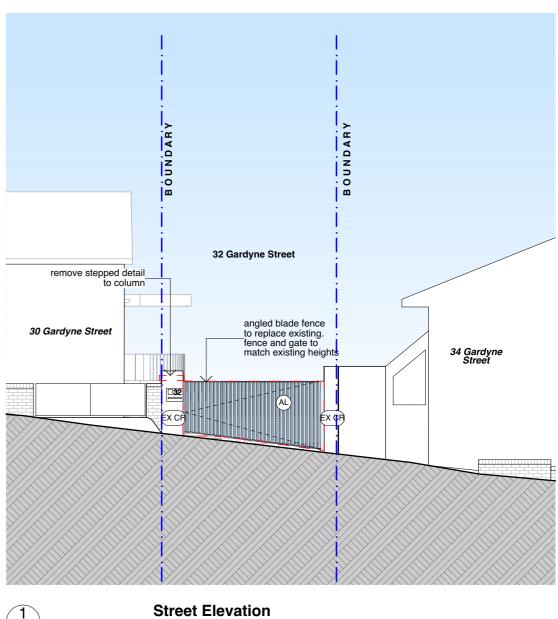
Any discrepancies to be brought to Architect's attention	rev	isions		l notes
Use figure dimensions in preference to scaling Only scale under direction from Architect	rev	date	description	
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the Architect				
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	project	Wheeler House Bronte	title	North Elevation	job no.	WHE	dwg no.	
CORBEN ARCHITECTS					drawn	ABW	DA13	
		32 Gardyne Street Bronte NSW			checked	ABW	revision	
mail@corben.com.au corben.com.au Nominated Architect: Philip Corben (Reg. No. 4616)	client	Deborah and Charles Wheeler	issue	Development Application		1:100 @A3	В	

Application No: DA-375/2022

Date Received: 02/09/2022



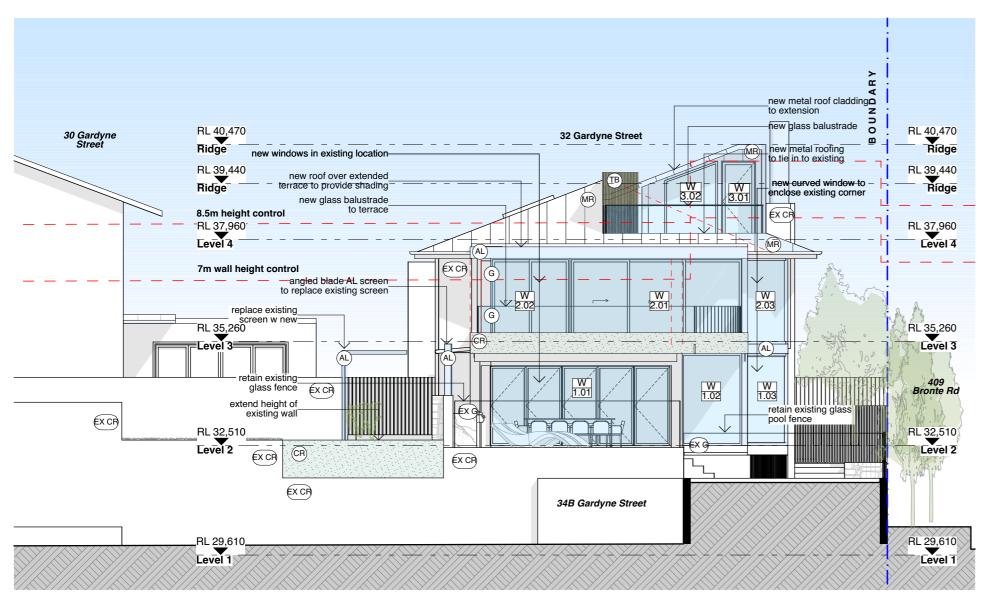

East Elevation 1:100

1 Street Elevation 1:100

of


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proje	
addr	C O R B E N A R C H I T E C T S PO Box 1021 Neutral Bay NSW 2089 Australia 02 9904 1844
clien	mail@corben.com.au corben.com.au
I	Nominated Architect: Philip Corben (Reg. No. 4616)

oject	Wheeler House Bronte	title	East & Street Elevation	job no.	WHE	dwg no.
				drawn	ABW	DA14
	32 Gardyne Street Bronte NSW			checked	ABW	revision
ient	Deborah and Charles Wheeler	issue	Development Application		1:100 @A3	В

Application No: DA-375/2022

Date Received: 02/09/2022

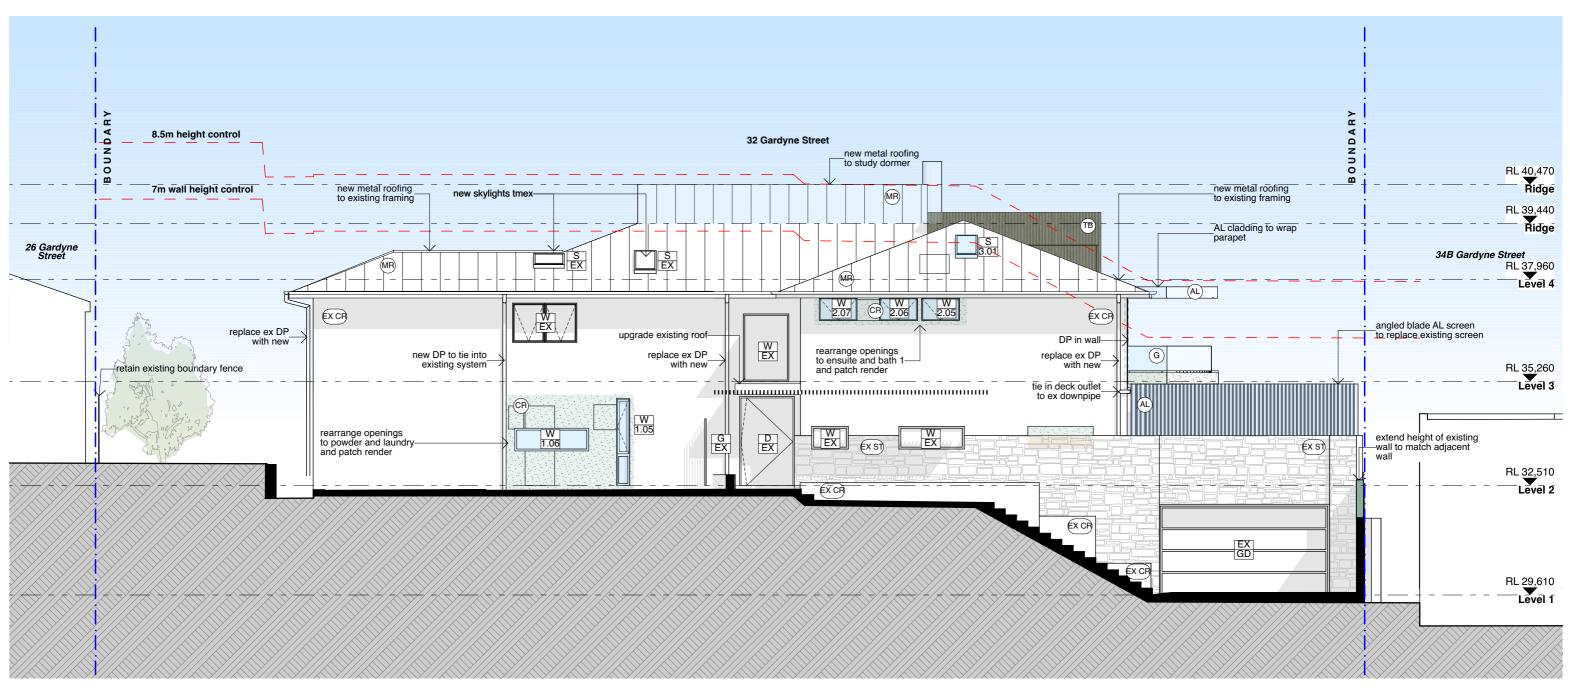


South Elevation 1:100

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Only scale under direction from Architect	rev	date	description	
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 Client is granted conditional licence to use the drawings 	В	30/8/22	DA Issue	
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the Architect				
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	project	Wheeler House Bronte	title	South Elevation	job no.	WHE	dwg no.
CORBEN ARCHITECTS					drawn	ABW	DA15
PO Box 1021 Neutral Bay NSW 2089 Australia 02 9904 1844	address	32 Gardyne Street Bronte NSW			checked	ABW	revision
mail@corben.com.au corben.com.au Newsigsted Austriant Philip Corben (Box No. 4616)	client	Deborah and Charles Wheeler	issue	Development Application	scale	1:100 @A3	В

Application No: DA-375/2022

Date Received: 02/09/2022

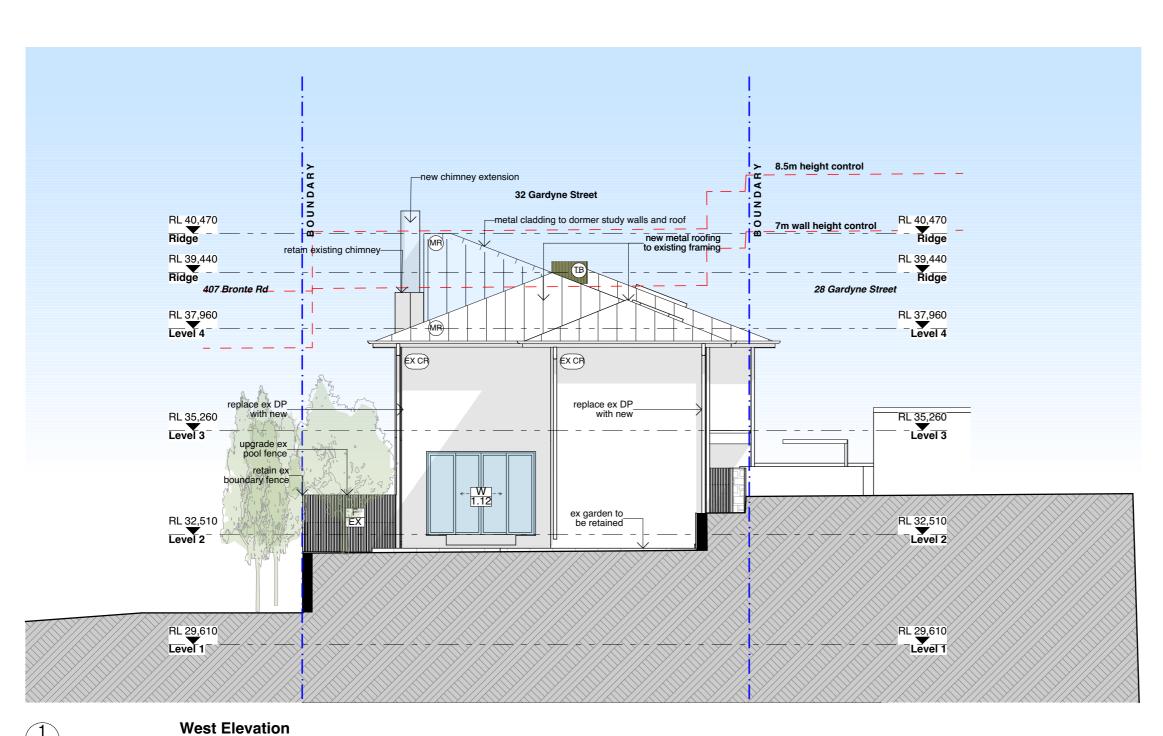


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Client is granted conditional licence to use the drawings	В	30/8/22	DA Issue	
Transfer of the licence is prohibited Architect reserves the right to terminate the licence				
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the Architect				
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1:100

I	!	project	Wheeler House Bronte	title	West Elevation	job no.	WHE	dwg no.
l	CORBEN ARCHITECTS					drawn	ABW	DA16
l	PO Box 1021 Neutral Bay NSW 2089 Australia 02 9904 1844	address	32 Gardyne Street Bronte NSW			checked	ABW	revision
l	mail@corben.com.au corben.com.au	client	Deborah and Charles Wheeler	issue	Development Application	scale	1:100	В
ı	Nominated Architect: Philip Corben (Reg. No. 4616)	1					@A3	1 – 1


Application No: DA-375/2022

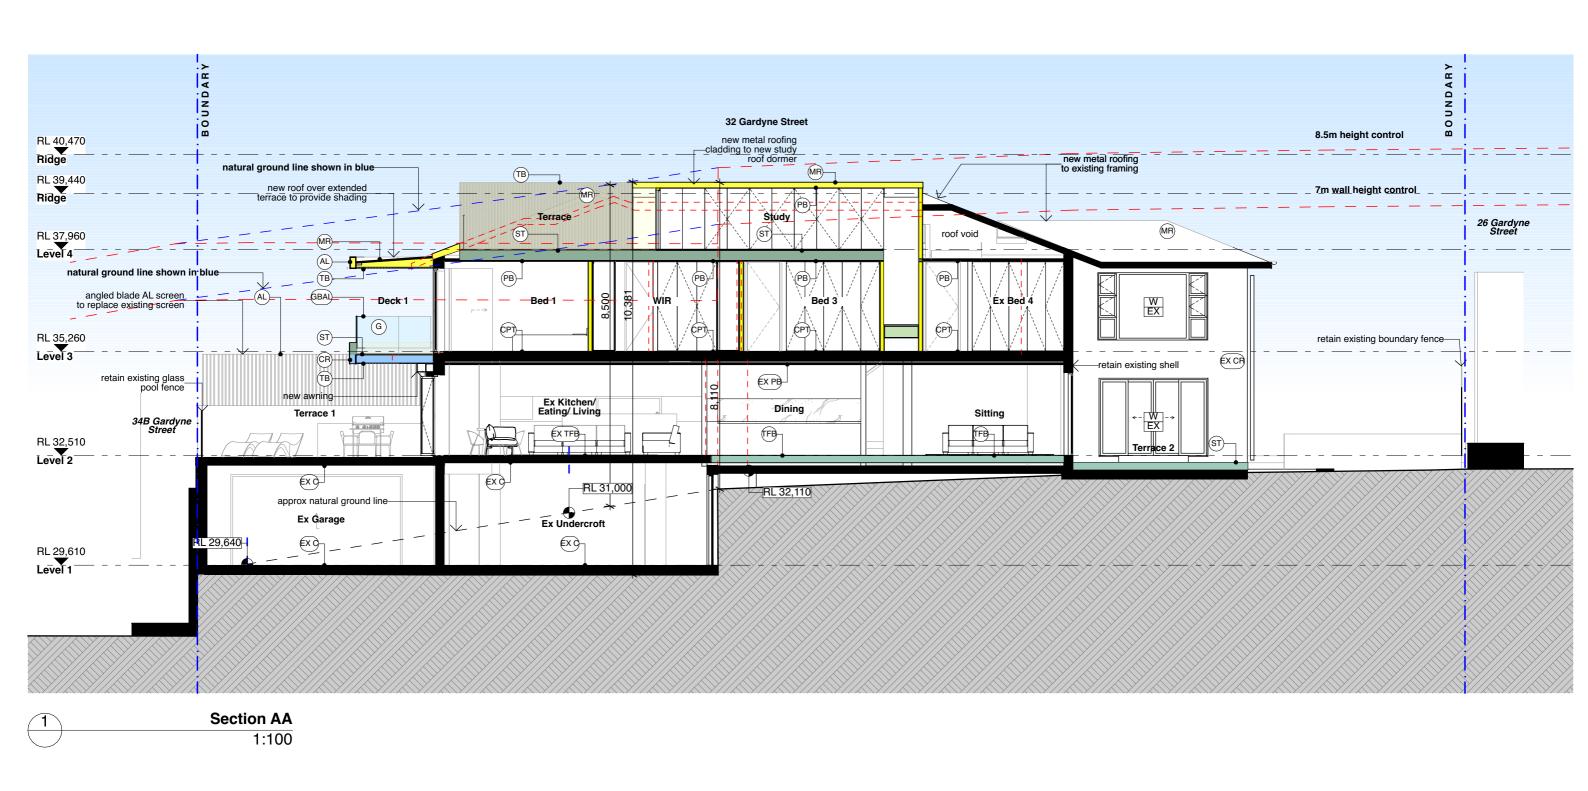

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 Client is granted conditional licence to use the drawings 	В	30/8/22	DA Issue	
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the Architect Refer to hard copies for accuracy of electronic data				
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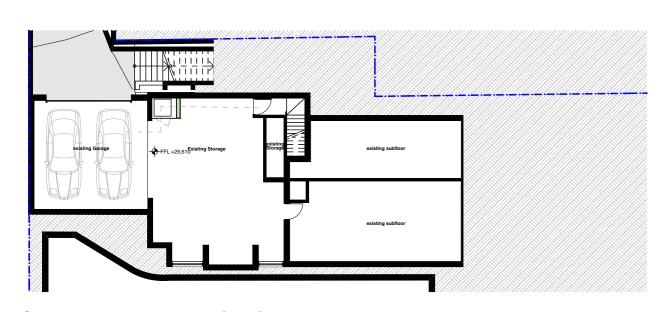
project Wheeler House Bronte	title	Section AA	job no.	WHE	dwg no.
C O R B E N A R C H I T E C T S			drawn	ABW	DA17
PO Box 1021 Neutral Bay NSW 2089 Australia 02 9904 1844 address 32 Gardyne Street Bronte NSW			checked	ABW	revision
mail@corben.com.au corben.com.au Nominated Architect: Philip Corben (Reg. No. 4616) Client Deborah and Charles Wh	heeler issue	Development Application		1:100 @A3	В


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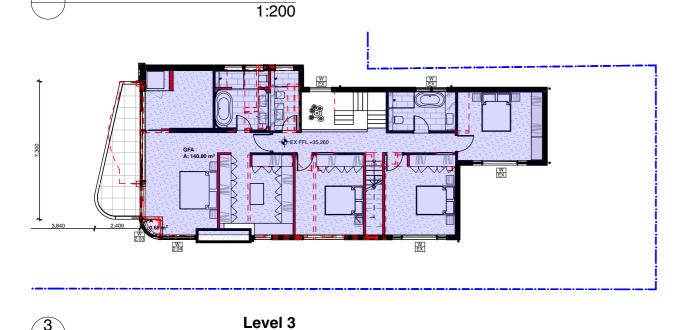


Any discrepancies to be brought to Architect's attention Use figure dimensions in preference to scaling	rev	isions		notes
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Builder to examine site and verify conditions and dimensions This drawing remains the property of the Architect	Α	23/8/22	Issue	
 Client is granted conditional licence to use the drawings 	В	30/8/22	DA Issue	
Transfer of the licence is prohibited Architect reserves the right to terminate the licence				
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I		project	Wheeler House Bronte	title	Section BB & CC	job no.	WHE	dwg no.
l	CORBEN ARCHITECTS					drawn	ABW	DA18
	PO Box 1021 Neutral Bay NSW 2089 Australia 02 9904 1844		32 Gardyne Street Bronte NSW			checked	ABW	revision
	mail@corben.com.au corben.com.au Nominated Architect: Philip Corben (Reg. No. 4616)	client	Deborah and Charles Wheeler	issue	Development Application	scale	1:100 @A3	В

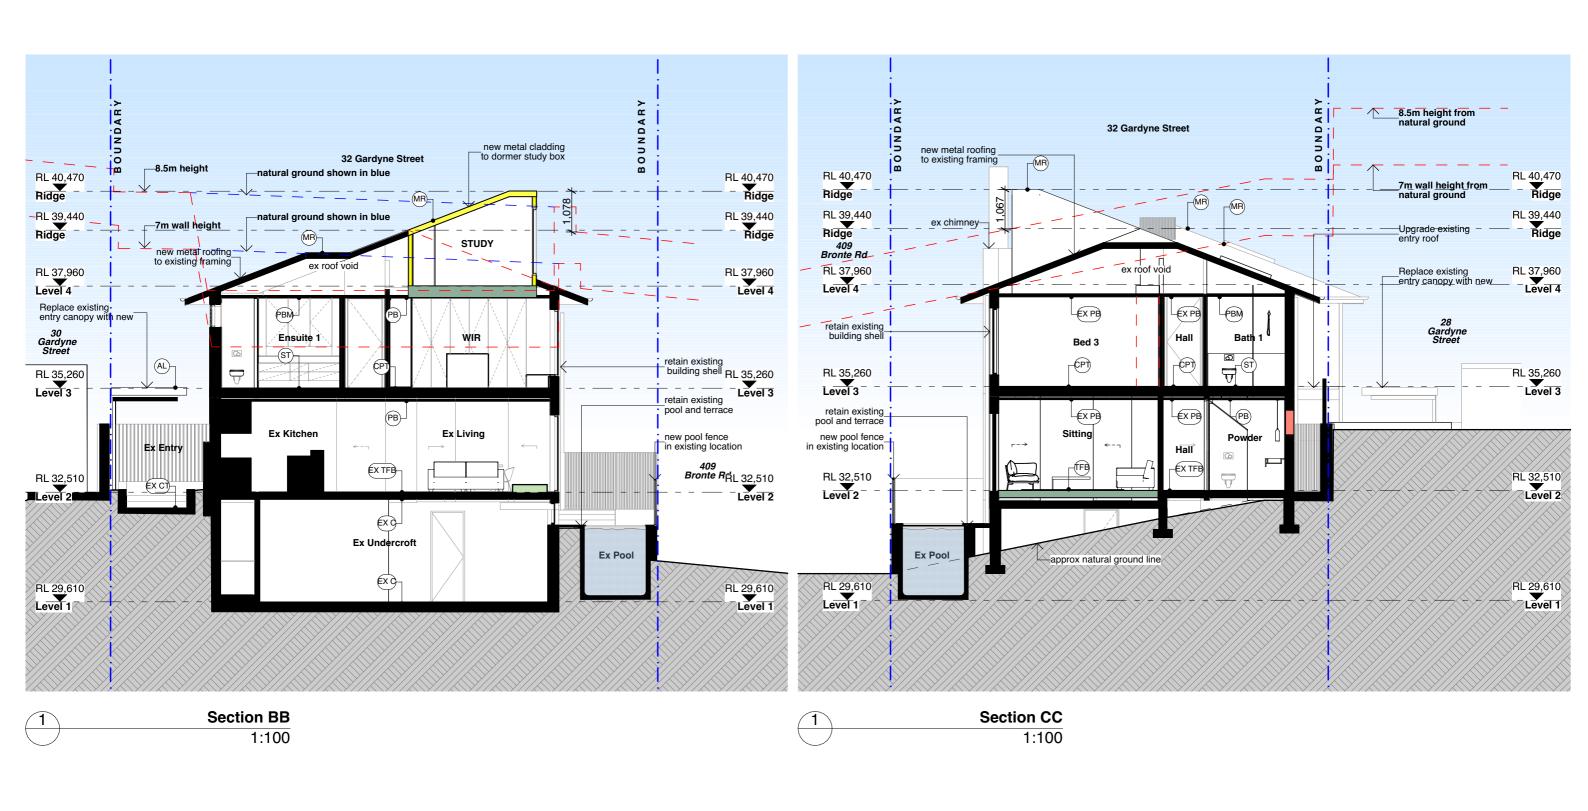



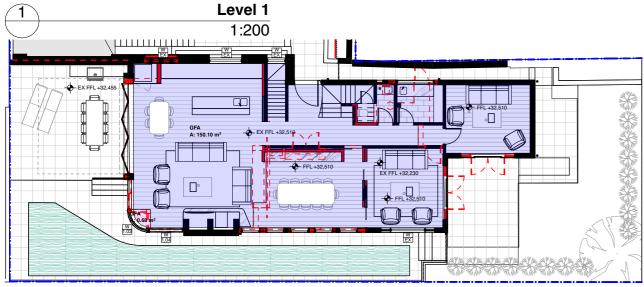

- Any discrepancies to be brought to Architect's attention


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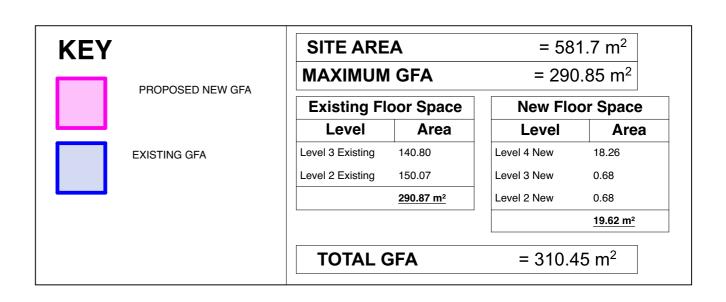
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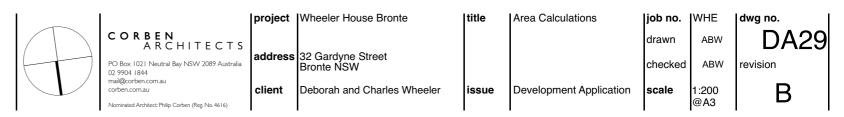
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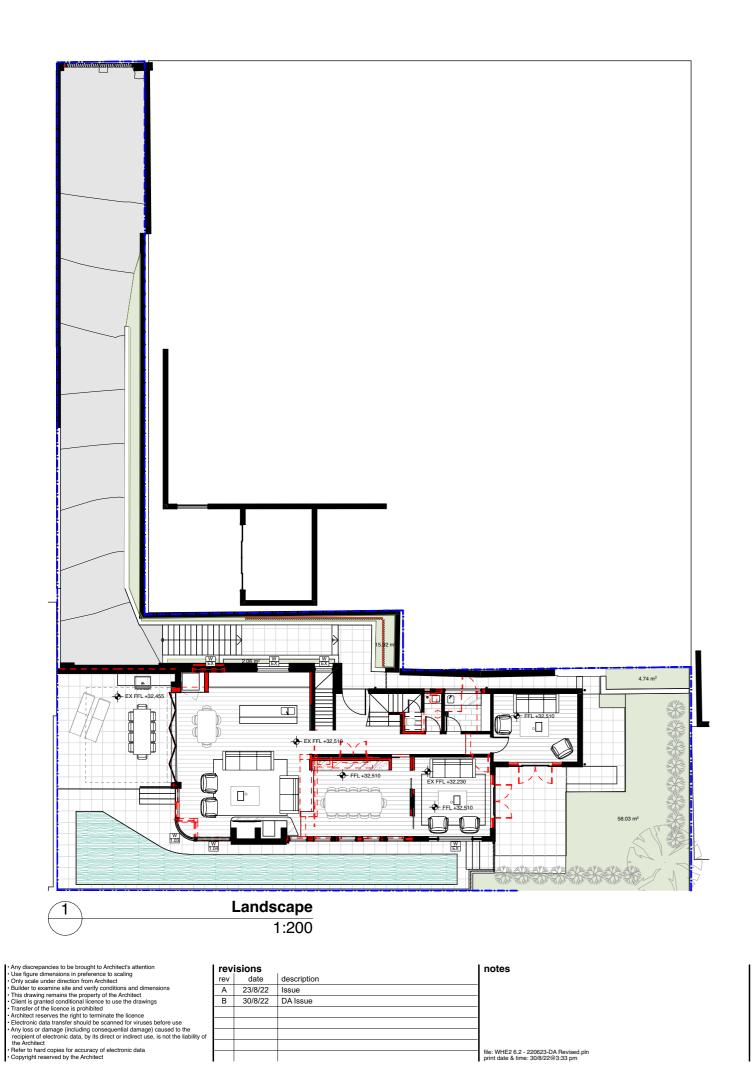
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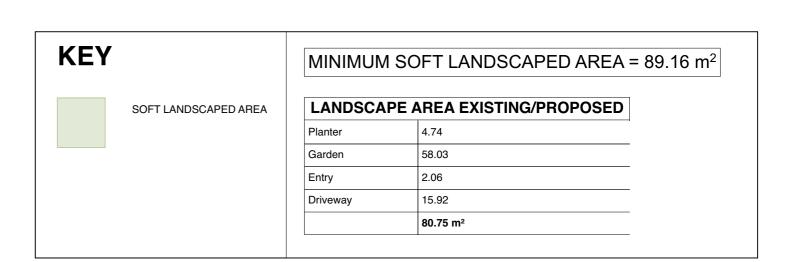




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mail@corben.com.au corben.com.au Nominated Architect: Philip Corben (Reg. No. 4616)	client	Deborah and Charles Wheeler	issue	Development Application	scale		В



8.5m height plane Diagram

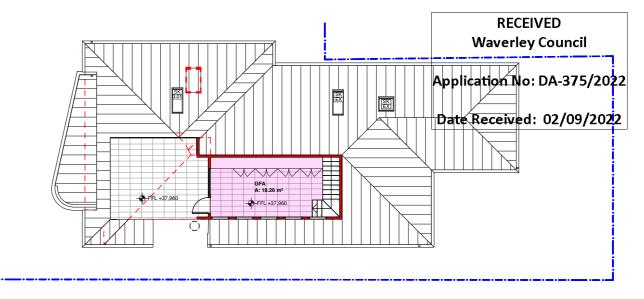

7m Height Plane Diagram

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ΓS ralia	address	32 Gardyne Street Bronte NSW
	client	Deborah and Charles Wheeler

title	Height Plane Diagram	job no.	WHE
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PO Box 1021 Neutral Bay NSW 2089 Australia

Nominated Architect: Philip Corben (Reg. No. 46	,

	project	Wheeler House Bronte
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Existing View from Roof



Proposed View from Roof Terrace

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| project | Wheeler House Bronte address 32 Gardyne Street Bronte NSW Deborah and Charles Wheeler

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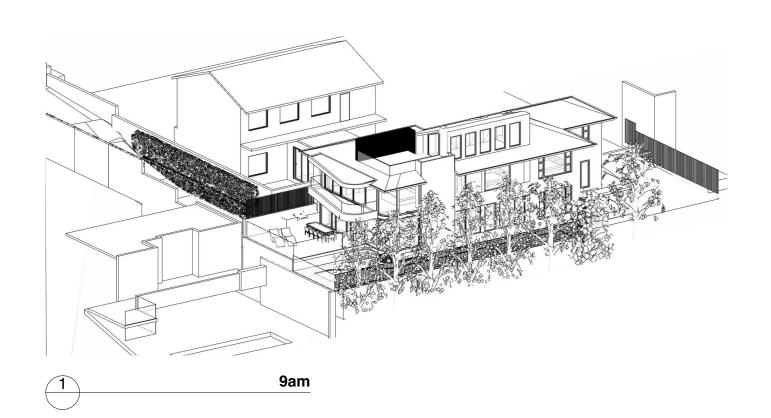
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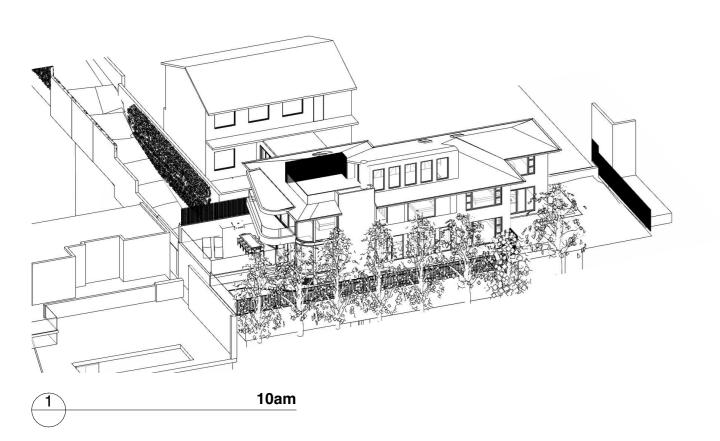
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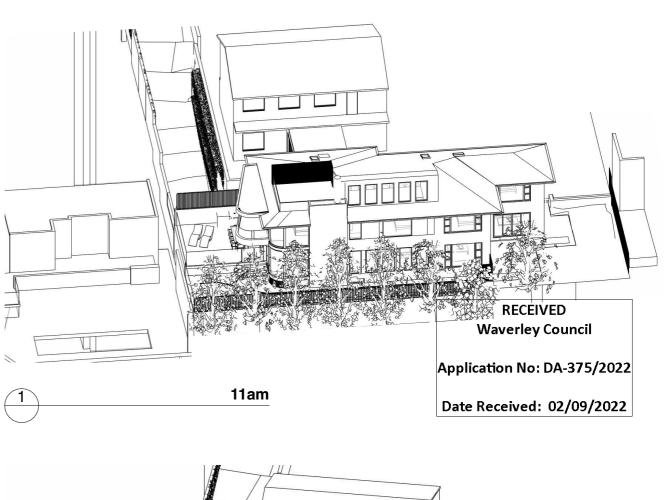
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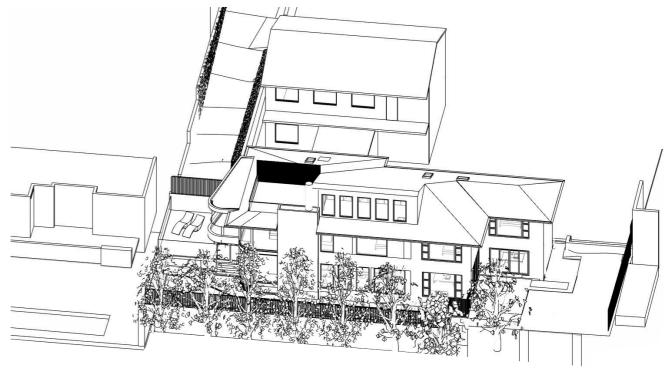
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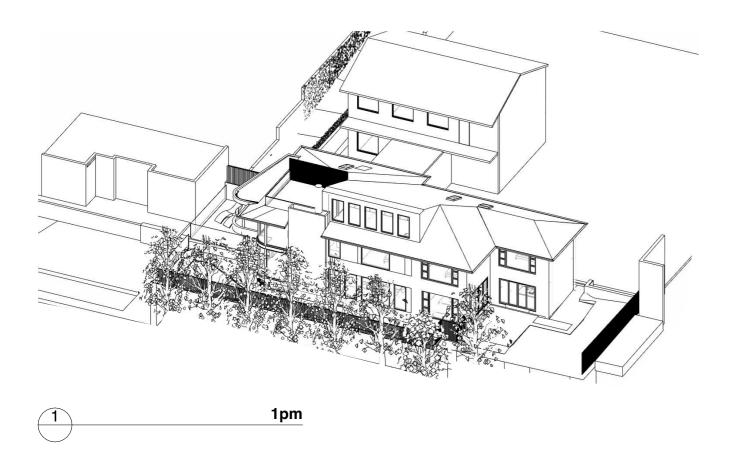
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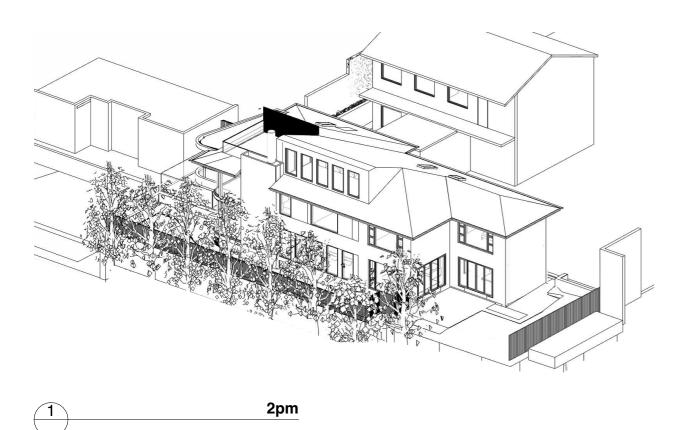
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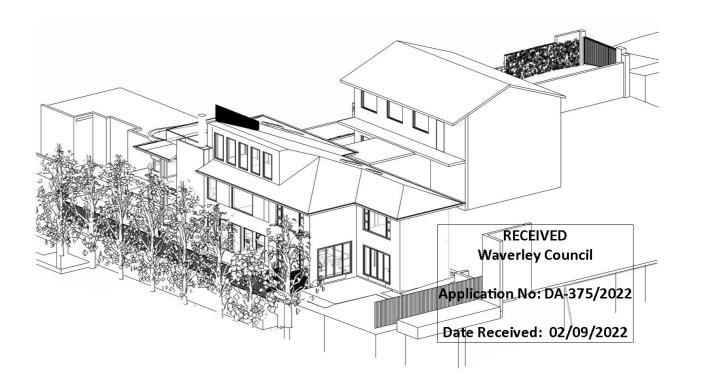
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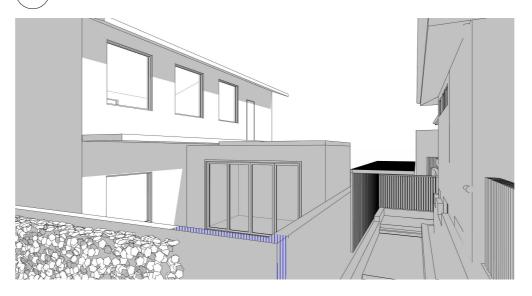


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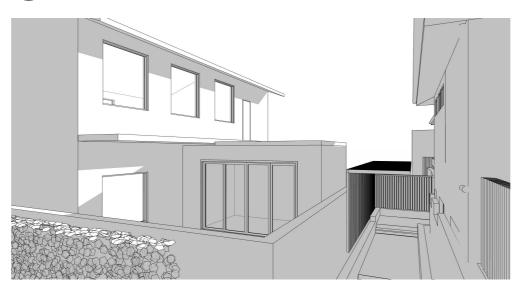
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 23/8/22
 Issue
 notes B 30/8/22 DA Issue

9am Proposed



12pm Proposed



KEY

Existing Overshadowing

Adjusted Overshadowing

no change to elevation shadows from roof terrace and study

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Application No: DA-375/2022

Date Received: 02/09/2022

no change to elevation shadows on neighbouring building at 12pm

no change to elevation shadows at 3pm

3pm Proposed

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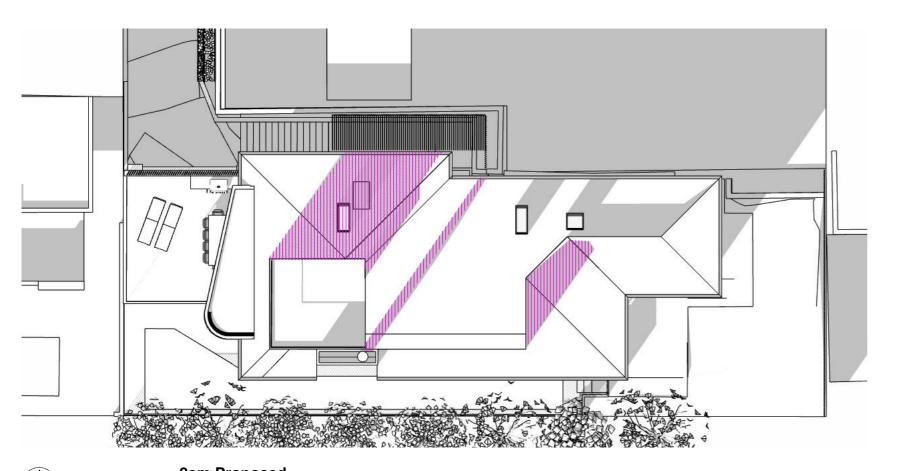
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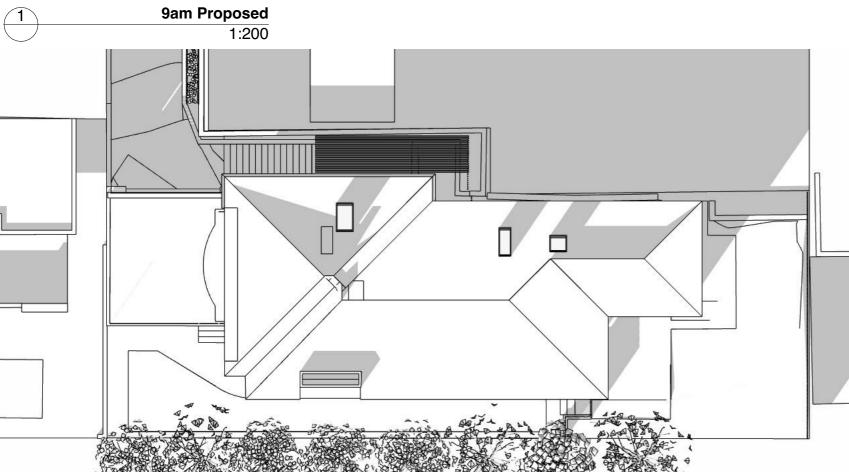
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Shadow Diagram Elevations

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9am Existing 1:200

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KEY

Existing Overshadowing

Adjusted Overshadowing

Adjusted Overshadowing from roof height noncompliance

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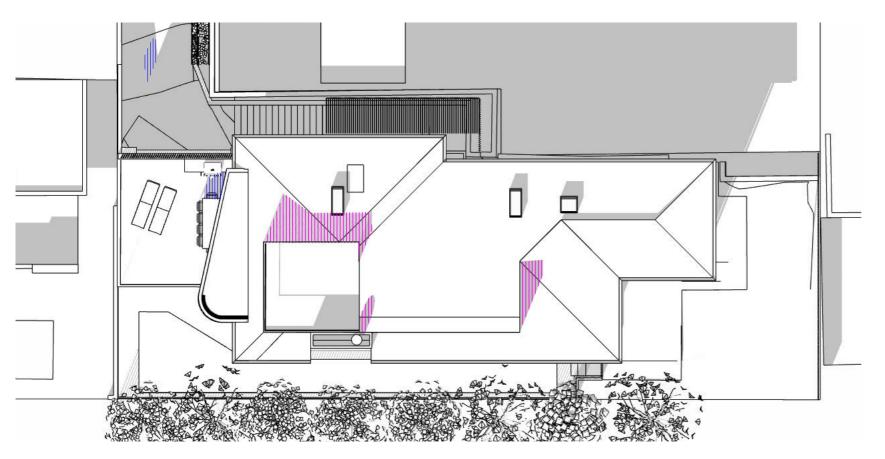
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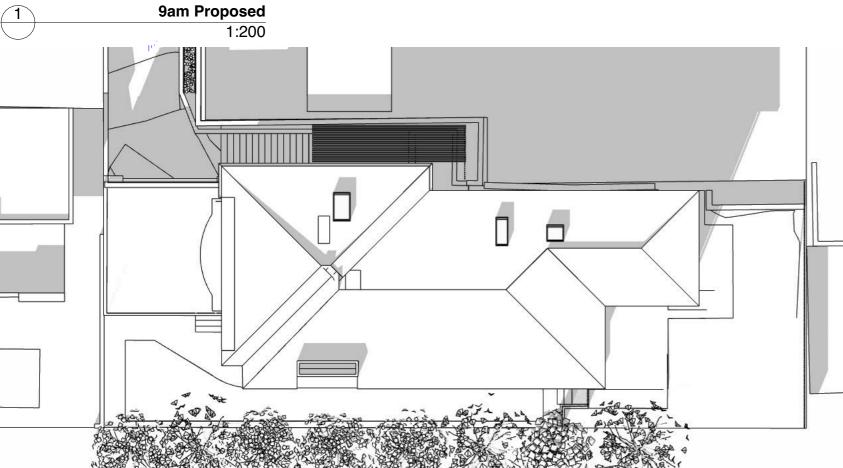
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no new overshadowing on southern or eastern neighbours from roof terrace and study

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client	Deborah and Charles Wheeler	issue	Development Application	scale	1:200 @A3	В





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Existing Overshadowing

Adjusted Overshadowing

Adjusted Overshadowing from roof height noncompliance

no new overshadowing on southern or eastern neighbours from roof terrace and study

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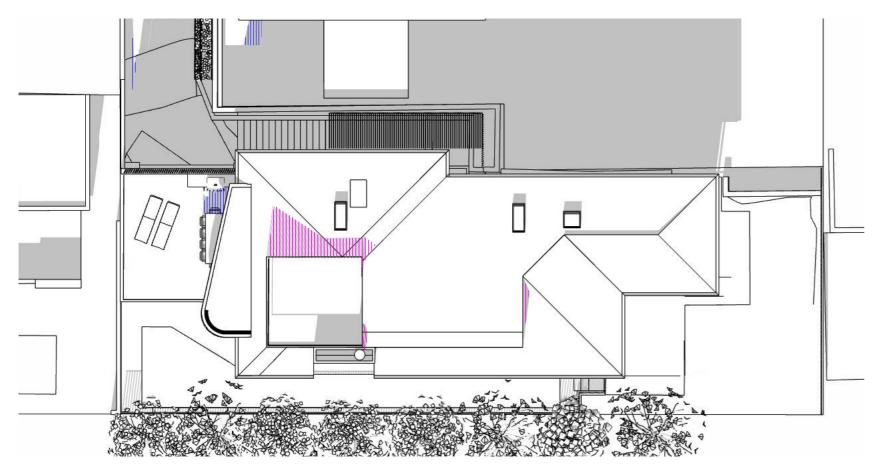
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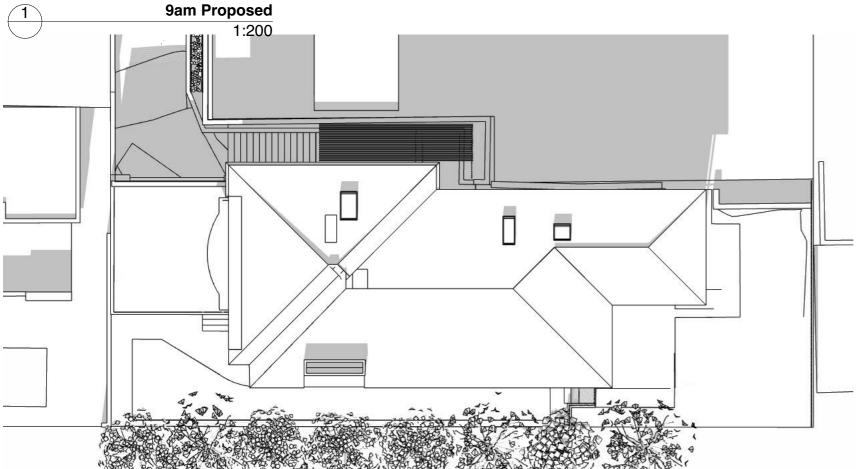
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| project | Wheeler House Bronte

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Existing Shadows - 11am 1:200

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address 32 Gardyne Street Bronte NSW Deborah and Charles Wheeler client

| project | Wheeler House Bronte

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Existing Overshadowing


Adjusted Overshadowing

Adjusted Overshadowing from roof height noncompliance

no new overshadowing on southern or eastern neighbours from roof terrace and study

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Application No: DA-375/2022



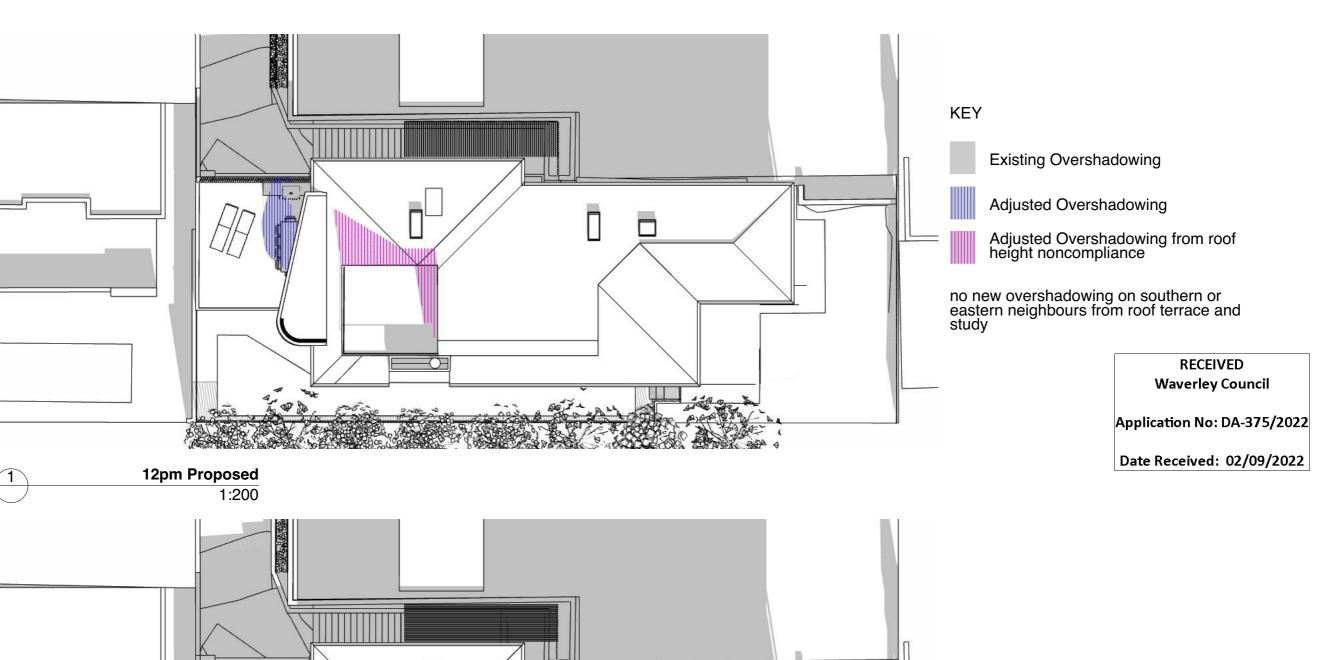

12pm Existing 1:200

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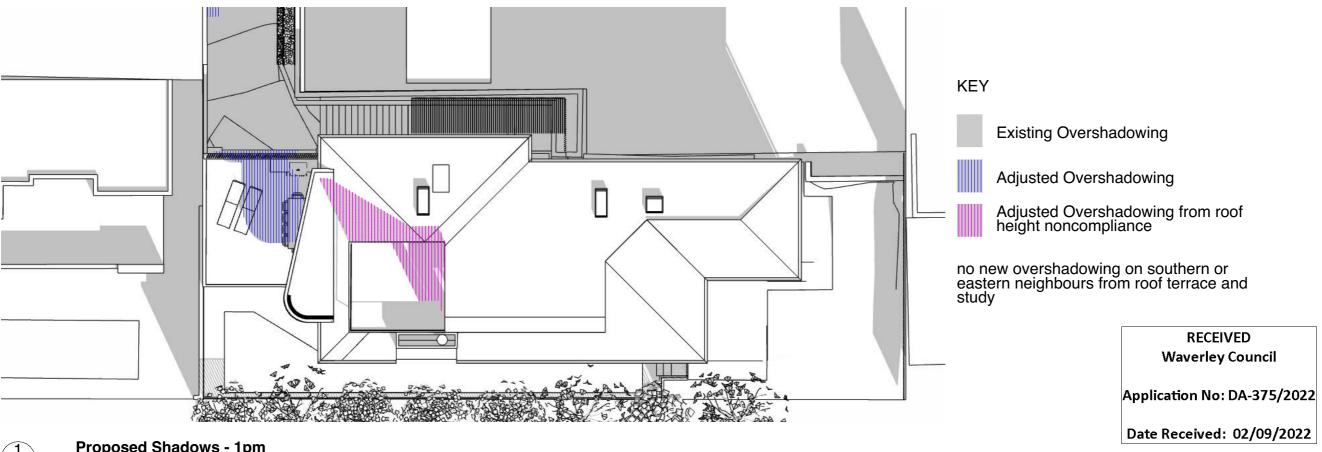
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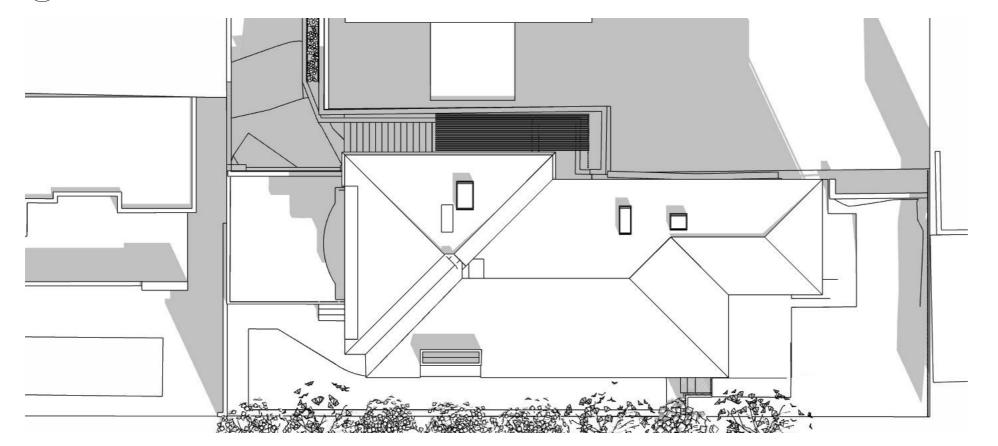
\	CORBEN ARCHITECTS
)	PO Box 1021 Neutral Bay NSW 2089 Australia 02 9904 1844

	project	Wheeler House Bronte
S	address	32 Gardyne Street Bronte NSW
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Proposed Shadows - 1pm 1:200



Existing Shadows - 1pm 1:200

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Proposed Shadows - 2pm 1:200

Existing Shadows - 2pm 1:200

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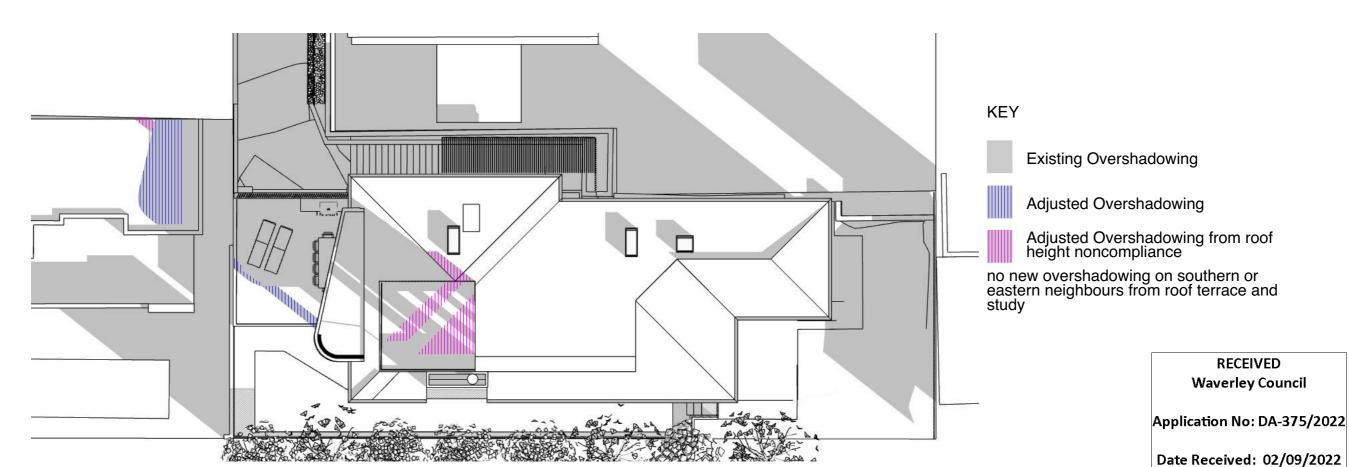



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| project | Wheeler House Bronte address 32 Gardyne Street Bronte NSW Deborah and Charles Wheeler

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client Deborah and Charles Wheeler

| project | Wheeler House Bronte

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Report to the Waverley Local Planning Panel

Application number	DA-392/2022	
Site address	301 Bondi Road, BONDI NSW 2026	
Proposal	Installation of 3 x car stackers to existing residential flat building accessed from Glen Street	
Date of lodgement	20 September 2022	
Owner	The Owners of Strata Plan No 104873	
Applicant	Mr P Hakim	
Submissions	12 unique submissions	
Cost of works	\$80,000	
Principal Issues	 Amenity to adjoining sites Enforcement of proposed hours Incorrect information Neighbour Submissions 	
Recommendation	That the application be REFUSED for the reasons contained in the report.	

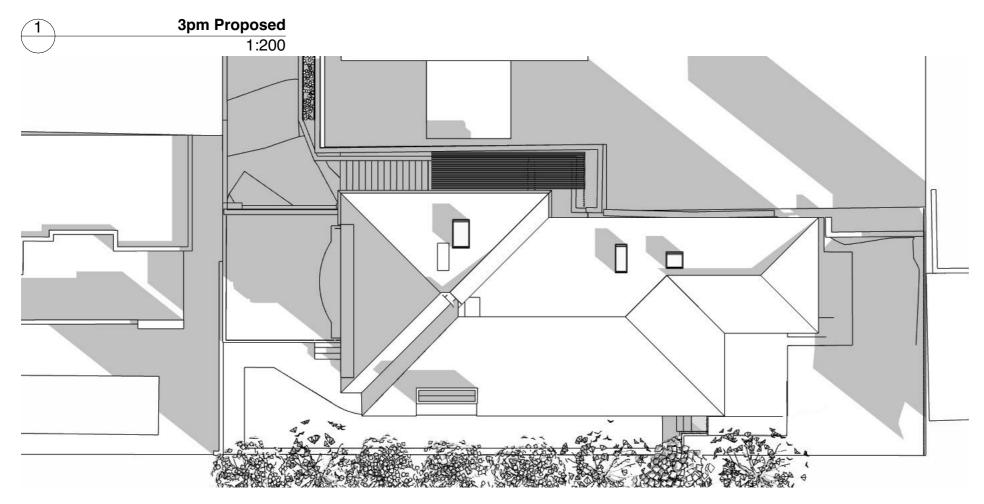SITE MAP



1. PREAMBLE

1.1. Executive Summary

The development application seeks consent for the installation of 3 x car stackers to the existing residential flat building at the site known as 301 Bondi Road, Bondi.

The principal issues arising from the assessment of the application are as follows:

- Car parking provisions
- Design not integrated with the design of the development
- Inadequate landscaping
- Inadequate Management plan and enforcement of hours of operation
- Noise
- Incorrect information within the Statement of Environmental Effects (SEE)
- No Site Waste and Recycling Plan was submitted

The assessment finds these issues unacceptable.

A total number of 12 unique submissions were received and the issues raised in the submissions have been considered and addressed in this report and in the Recommendation.

The application has been assessed against the relevant matters for consideration under section 4.15(1) of the *Environmental Planning and Assessment Act 1979*. It is recommended for refusal.

1.2. Site and Surrounding Locality

A site visit was carried out on 9 December 2022.

The site is identified as Lot 1 in DP 1262932, known as 301 Bondi Road, Bondi.

The site is rectangular in shape with a primary northern frontage to Bondi Road, measuring 16.36 m and a secondary eastern frontage to Glen Street, measuring 39.015m. It has an area of 638.1 m² and it falls from the northwest towards the northeast by approximately 2.1 m.

The site is occupied by an older style three storey residential flat building containing eight dwellings (5 x two-bedroom and 3 x one-bedroom – based on DA-139/2020 for strata subdivision of the building). The applicant indicates that the building contains 2 x one-bedroom dwellings and 6 x two-bedroom dwellings. A recent addition is located at the rear of the building and contains the two-bedroom dwellings. In the rear of the site, accessed off Glen Street, is a hardstand parking area for five vehicles.

The building is identified as a heritage item (Item I22) and is described as a Late Federation style residential flat building.

The site is adjoined at the rear (south) by a single storey semi-detached dwelling above a garage fronting Glen Street. Adjoining to the west, is a three storey residential flat building over parking that fronts Bondi Road. Opposite in Glen Street, is a two storey dwelling house fronting Bondi Road and a single storey dwelling house fronting Glen Street. The locality is characterised by a variety of low and medium density residential developments.

Figures 1 to 4 are photos of the site and its context.



Figure 1: Subject Site



Figure 3: Existing carpark showing semi and adjoining residential flat building



Figure 2: Carpark fronting Glen Street



Figure 4: Existing carpark and semi to rear

1.3. Relevant Development History

A search of Council's records revealed the following recent and relevant development history of the site:

DA-970/2002; Refused 6 February 2004

o Construct an additional Residential Flat Building consisting of three (3) x one (1) bedroom units plus basement carparking at the rear of a Heritage Item identified in LEP 1996.

• DA-67/2010; Approval 13 March 2013

 Alterations and additions to residential flat building including construction of 2 additional units at rear of building, demolition of existing garages and provision of 5 carspaces - Amended Plans.

• DA-67/2010/A; approved 5 June 2013

Modification to remove conditions regarding external finishes.

DA-67/2010/B; approved 8 December 2016

 Section 96 Modification new window to bedroom on western elevation of ground level one-bedroom unit 7.

• DA-139/2020; approved 19 August 2020

Strata Subdivision of Residential Flat Building.

• DA-51/2021; withdrawn 18 June 2021

 Alterations and additions to residential flat building, including new car stackers in the rear hard stand parking area.

DA-286/2021; refused 17 March 2022

 Additional 10 carparking spaces (via five car stackers) to an existing Residential Flat Building.

1.4. Proposal

The development application seeks consent for the construction of three car stackers providing six car spaces in the approximate location of the existing hardstand; and two hardstand car spaces in the approximate location of the existing hardstands.

The Plan of Management submitted with the application states that the car stackers must not be used between 10pm and 7am on weekdays and 12 midnight and 8am on weekends.

A visual comparison of the floor planning of the car parking level between the refused development (i.e. DA-286/2021) and the proposal (DA-392/2022) is provided in extracts from respective floor plans and sections shown in **Figures 5** to **8** in this report.

The proposal differs from DA-286/2021 by removing the two car stackers closest to Glen Street.



Figure 5: DA-286/2021 Refused Ground Floor Plan

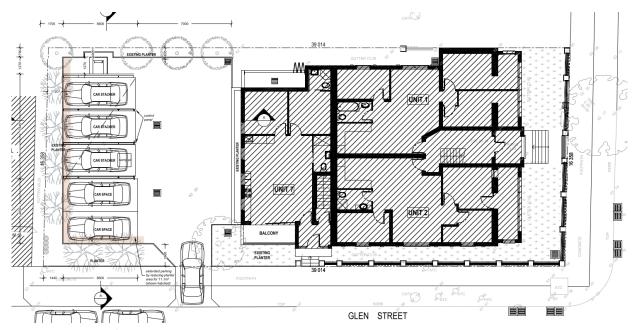


Figure 6: DA-392/2022 Proposed Ground Floor Plan

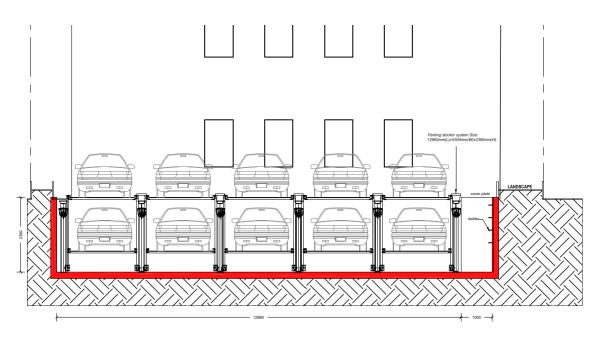


Figure 7: DA-286/2021 Refused Section BB

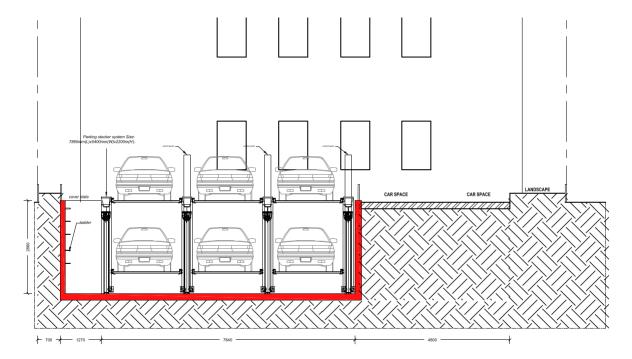


Figure 8: DA-392/2022 Proposed Section BB

Note: There are ambiguities with the information submitted of the existing unit configuration in the building:

- The SEE and rental analysis submitted for the strata subdivision of the building (DA-139/2020) indicated that the building contains 3 x one-bedroom and 5 x two-bedroom units. It is on this basis that the strata subdivision of the building was approved. This unit configuration is therefore used as the basis for this report and associated parking calculations.
- The SEE submitted indicates the building as containing 2 xone1-bedroom and 6 xtwo2-bedroom dwellings.

This issue was identified during the previous development application.

2. ASSESSMENT

The following matters are to be considered in the assessment of this development application under section 4.15 of the *Environmental Planning and Assessment Act 1979* (the Act).

2.1. Planning Instruments and Development Control Plans

The following is an assessment against relevant legislation, environmental planning instruments, including State environmental planning policies (SEPPs), and development control plans.

2.1.1. State Environmental Planning Policies (SEPPs)

The following SEPPs apply from the 1 March 2022 and have been considered acceptable in the assessment of this development application:

SEPP (Building Sustainability Index – BASIX) 2004

- SEPP 65 (Design Quality of Residential Apartment Development) 2002
- SEPP (Biodiversity and Conservation) 2021
- SEPP (Resilience and Hazards) 2021

An assessment under SEPP 65 (Design Quality of Residential Apartment Development) was not required given the scope and nature of the proposed works.

2.1.2. Waverley Local Environmental Plan 2012 (Waverley LEP 2012)

The relevant matters to be considered under the Waverley LEP 2012 for the proposed development are outlined below:

Table 1: Waverley LEP 2012 Compliance Table

Provision	Compliance	Comment	
Part 1 Preliminary			
1.2 Aims of plan	Yes	The proposal is consistent with the aims of the plan.	
Part 2 Permitted or prohibited de	velopment		
Land Use Table R3 – Medium Density Zone	Yes	The proposal is defined as ancillary to a residential flat building, which is permitted with consent in the R3 Medium Density zone.	
Part 4 Principal development star	ıdards		
4.3 Height of buildings12.5m	Yes	When raised the car stacker will be a maximum of 2.2m in height.	
4.4 Floor space ratio • 0.9:1	Yes	The proposal does not increase floor space ratio on the site.	
Part 5 Miscellaneous provisions			
5.10 Heritage conservation	Acceptable	The building is a heritage item (Item I22) and is described as a late federation style residential flat building. See comments from Council's Heritage Advisor.	
Part 6 Additional local provisions			
6.1 Acid sulfate soils	Yes	The site is in a class 5 acid sulfate soil zone.	
6.2 Earthworks	Yes	Restricted to the area associated with the car stacker excavation.	

2.1.3. Waverley Development Control Plan 2012 (Waverley DCP 2012) - Amendment No.9

The relevant matters to be considered under the Waverley DCP 2012 for the proposed development are outlined below:

Table 2: Waverley DCP 2012 – Part B General Provisions Compliance Table

Development Control	Compliance	Comment
1. Waste	No	Unsatisfactory, no Site Waste and Recycling Plan was submitted.
6. Stormwater	Yes	Council's Stormwater Design Engineers raise no objection to the proposal, subject to conditions. Refer to section 3 of this report on referral commentary.
7. Accessibility and Adaptability	No	Unsatisfactory, the proposed car parking does not provide accessible car parking.
8. Transport Zone 2 Minimum parking rate: • 0 Maximum parking rate: • 1 per 1 bedroom • 1.2 per 2 bedroom • 1.5 per 3 bedroom + Visitor parking: • 1 per 5 units Motorcycle parking: • Resident: 1 parking bay per 3 car spaces Bicycle parking: • 1 per 10 dwelling	Yes No No	The proposal provides an additional three car spaces resulting in a total of eight car spaces. Based on the DA-139/2020, the subdivision plan shows 2 x one-bedroom units and 6 x two-bedroom units, meaning a maximum of nine car spaces are permitted. No visitor parking is being provided. The minimum required is one based on the eight units. Based on the proposed eight car spaces, a total of three motorcycle parking are required and have not been provided. No bicycle parking is being proposed. A minimum of one bicycle parking space is required. An accessible car space has not been provided.
9. Heritage	Yes	Council's Heritage Advisor has reviewed the proposal and raises no objection to the proposal. Refer to Table 3 of this report on referral commentary.
12. Design Excellence	No	No information has been provided on the materiality or design of the car stacker. A finishes schedule or product information is required to accurately determine the impact of the design. The proposed external car stackers will negatively impact the acoustic amenity of neighbouring properties during the nighttime. This, combined with the proposed unrealistic and unenforceable hours of operation, will result in an unsatisfactory outcome.
14. Excavation	Yes	Satisfactory. Excavation is associated with the proposed stacker and is confined to that area. A Geotechnical Report has been provided outlining soil conditions and methodology.

Table 3: Waverley DCP 2012 – Part C3 Other Residential Development Compliance Table

Dovolonment Central	Compliance	Comment
Development Control	Compnance	Comment
Maximum external wall height:R3 - 12.5m	Yes	There are no above-ground external walls proposed. The residential flat building is not being altered. The structure, when operating, has a maximum height of 2.2m.
3.7 Fences and walls		
	N/A	No additional fencing is proposed. It is noted that the stackers would need to always be left in a "closed" position, or some form of safety railing/fencing would be required. Details have not been provided regarding the enforcement of this.
3.9 Landscaping		
 Minimum of 30% of site area landscaped: 191.4m² 	No	The proposal will result in a reduction in the landscaped area. The building is an old residential flat building built before the current standards.
 Existing: 158.2m² 24.8% 50% of the above is to be deep soil: 95.7m² 		The 2010 assessment report (DA-67/2010) indicated non-compliance with thecontrols when assessing the application for the additional dwellings at the rear.
		A slight reduction was proposed for DA-286/2021 and was not seen as an issue given its small nature as shown on figure 5 .
		However, the proposal for this application proposes a further decrease in landscaping when compared to the existing with a proposed 144.8m ² or 22.7% a net reduction of 13.4m ² or 2.1%. This decrease in landscaping is not supported.
3.10 Communal open space		
 Minimum 15% communal (R3 zone): 95.7m² Minimum dimensions: 6m x 6m Minimum of 30% of communal area must receive three hours of sunlight Accessible 	N/A	No change. The section of a landscaped area affected is the perimeter parking of the existing carpark.
3.12 Vehicular access and park		
Car parking to be integrated into the design of the development	No	The proposal for external car stackers is not integrated with the design of the development. Due to the unrestricted access available to the car stackers, it is noted that due to pedestrian

Development Control	Compliance	Comment
 Max 1 x 2 way vehicle access point Provided from secondary street or lane Pedestrian safety considered Basement parking should not contravene deep soil zone controls 	N/A N/A Yes N/A	safety concerns that the stacker would need to always be left in a "closed" position, or some form of safety railing/ fencing would likely be required. Existing vehicle access point from the secondary street.

The following is a detailed discussion of the issues identified in the compliance tables above in relation to the Waverley DCP 2012.

Transport & Accessibility

The SEE and rental analysis submitted for the strata subdivision of the building (DA-139/2020) indicated that the building contains 3 x one-bedroom and 5 x two-bedroom units. It is on this basis that the strata subdivision of the building was approved. This unit configuration is therefore used as the basis for this report and associated parking calculations. Refer to **Table 4** for a detailed breakdown of site parking requirements and proposed provisions.

Table 4: Parking requirement calculation

	Requirements	Proposed	Compliance
Medium density	3 for 1 bedrooms	8 car parking	yes
residential (3-19 dwellings)	6 for 2 bedrooms	spaces	
1 bedroom = 1.0	Maximum of 9 car parking		
2 bedroom = 1.2	spaces		
Visitor (1 per 5 units)	1.6 – min. 2 required	0	No
Motorcycles (1 per 3 parking bays inc. visitor)	3.33 – min 3 required	0	No
Accessible Car Parking 10% of all car spaces	Based on 8 proposed, a minimum of 1 (0.8) is required	0	No

The proposal has reduced the number of car space from the previous DA-286/2021 to be below the maximum allowed for the site based on the dwelling numbers with a proposed eight spaces. However, the applicant has provided no justification as to why they should not meet the minimum visitor, motorcycle or accessible car parking requirements if increasing the onsite parking.

Landscaped area

The proposal will result in a reduction in the landscaped area. The building is an old residential flat building built before the current standards. The 2010 report (DA-67/2010) indicated noncompliance with the standards when assessing the application for the additional dwellings at the rear, which were approved.

The 2021 report (DA-286/2021) indicated that the minor reduction proposed was not an issue regarding the slight widening of the parking area and stairs to the stacker pit. A review of the architectural drawing showed a minor reduction of landscaping by 1.2m²

The proposal is a further decrease in landscaping area, reducing the landscaped area from an existing 24.8% (158.2m²) to 22.7% (144.8m²), a net reduction of 2.1% (13.4m²). This proposed reduction is not insignificant and further reduction of the landscaping area is not recommended.

2.2. Other Impacts of the Development

The proposal is not considered to have a significant detrimental effect relating to environmental, social or economic impacts on the locality.

2.3. Suitability of the Site for the Development

The site is not considered suitable for the proposal.

2.4. Any Submissions

The application was notified for 14 days from 3 November 2022 in accordance with the *Waverley Community Development Participation and Consultation Plan*.

A total of 12 unique submissions were received from the following properties:

Table 5: Number of and where submissions were received from.

Count	Property Address	Submission Type
1.	303 Bondi Road, Bondi	Objection
2.	7a Glen Street, Bondi	Objection
3.	1 Glen Street, Bondi	Objection
4.	Unit 1/297-299 Bondi Road, Bondi	Objection
5.	Unit 4/297-299 Bondi Road, Bondi	Objection
6.	Unit 26/30-34 Penkivil Street	Objection
7.	65 Roscoe Street, Bondi Beach	Support
8.	17/16 Notts Avenue, Bondi Beach	Complaints of other submissions
9.	4/16 Consett ave, Bondi Beach	Objection
10.	2/2 Simpson St, Bondi	Objection
11.	181 Campbell Parade, Bondi.	Complaints of other submissions
12.	North Bondi	Support

The following issues raised in the submissions have already been discussed and addressed in the body of this report:

- Excavation
- Design of the car stacker
- Car parking
- Amenity Loss

All other issues raised in the submissions are summarised and discussed below.

Issue: Drawing discrepancy regarding the proposed location of car stackers.

Response: The architectural drawing shows car stackers being located at the south corner of the site away from Glen street and is in line with the description described in the SEE and Heritage statement. No discrepancy is noted regarding the location of the car stackers.

Issue: Parking of additional cars present on site.

Response: Parking on unmarked spots within the car parking area can not be enforced by the Council but is an enforcement issue of the strata management.

Issue: Noise.

Response: An acoustic report has been submitted as part of the proposal. The report indicates compliance with the operational noise and sleep disturbance screening noise during the night except for 1 Glen Street, which is noted to exceed the noise criteria by 1 dB during the night. Based on this report, the car stacker will impact the amenity of adjacent properties at night time and is a justified concern.

Issue: Hours of operation practicality.

Response: The stated hours of no operation within the plan of management are between (Weekdays) 10pm and 7am and (Weekends) 12 midnight and 8am. Based on the location and the use of the building as a residential flat building there are serious practicality issues of limiting the hours of operation to those stated. These hours of operation preclude night shift workers or late-night arrivals of the tenants, forcing them to use off-street parking similar to the existing site condition.

However, the operation of the car lift at night will have a noise impact on the amenities of adjacent properties as discussed previously, leading to a requirement to restrict operation and use. This raises the enforcement issue for the hours of operation for the car stackers, as Council will not be able to enforce and restrict the hours of operation of the proposed units, as such Council does not support the external installation of car stackers.

Issue: Building compliance.

Response: Building compliance enforcement regarding things like handrails are up to the registered Building Practitioner. They are based on the Building Code of Australia (BCA) at the time of construction and not up to planning controls.

Issue: History of noise issue with the site.

Response: Council acknowledges that there may be a history of noise issues currently arising from potential operations and management of the subject site. Increasing doubt over the strata enforcement of the hours of operation stated within the plan of management.

Issue: Durability of car stackers.

Response: If a car stacker is to be approved externally, then compliance with all relevant Australian Standards and the BCA regarding corrosion for coastal regions.

2.5. Public Interest

The proposal is considered to have a detrimental effect on the public interest and is recommended for refusal.

3. REFERRALS

The following internal and external referral comments were sought:

3.1. Traffic and Development

Council's Traffic Engineers have reviewed the proposal and recommended that the eastern car stackers be replaced by a single car parking space for a total of nine residential car parking spaces. Conditions of were provided.

3.2. Stormwater

Council's Engineers advised that they raise no objections to the proposal and provided conditions of consent.

3.3. Heritage

Council's Heritage Advisor advised that they raised no objection to the proposal and provided conditions of consent involving repair work to the paint and shingles finishes of the building. The Heritage advisor has noted that previous examples of car stackers near the ocean are not positive due to corrosion. Also of importance is the acoustic impact on neighbours.

3.4. Environmental Health

Council's Environmental Health advised that they raise no objection to the proposal and provided conditions of consent.

4. CONCLUSION

The development application seeks consent for the installation of 3 x car stackers to the existing residential flat building at the site known as 301 Bondi Road, Bondi.

The principal issues arising from the assessment of the application are as follows:

- Car parking provisions
- Design not integrated with the design of the development
- Landscaping
- Management plan hours of operation and enforcement
- Noise
- Incorrect information within the Statement of Environmental Effects
- No Site Waste and Recycling Plan was submitted

The assessment finds these issues unacceptable.

A total number of 12 unique submissions were received and the issues raised in the submissions have been considered and addressed in this report and in the Recommendation.

No Councillor submissions were made.

The application has been assessed against the relevant matters for consideration under section 4.15(1) of the Act. It is recommended for refusal.

5. RECOMMENDATION TO WAVERLEY LOCAL PLANNING PANEL

That the development application be REFUSED by the Waverley Local Planning Panel for the reasons contained in Appendix A.

Report prepared by:	Application reviewed and agreed by:
D. Wilmoth	
Damien Wilmotte	Bridget McNamara
Development Assessment Planner	Manager, Development Assessment
Date: 19 January 2023	Date: 30 January 2023

Reason for WLPP referral:

1. Contentious development (10 or more objections)

APPENDIX A – REASONS FOR REFUSAL

Having regard to section 4.15 (1) of the *Environmental Planning and Assessment Act 1979 (the Act)* the development application (the application) is refused for the following reasons:

1. The application does not satisfy section 4.15 (1)(a)(iii) of the Act as it is contrary to Waverley Development Control Plan (WDCP) 2012, in respect to the following provisions:

Part B8 Transport

- a. Objectives (a), (c), (d), (g), (h), (i), (j) and (k) under this the Part, as per the following:
 - i. Does not prioritise other forms of transport.
 - ii. Adequate modes of public or active transport are available.
 - iii. The proposed car stackers will adversely impact the character of the streetscape and landscape.
 - iv. Installation of the pits for the car stackers will limit the future transition or alternate use of the site in the future.
 - v. The plan of management and hours of operation proposed will likely result in tenants using on street parking and as such is unreasonable.
 - vi. No accessible parking has been provided.
 - vii. Will adversely impact the amenity of the streetscape and adjacent dwellings.
- b. Section 8.2.2 *Car Parking Provision rates*, specifically objectives (a)-(c) and Table 3 Car Parking Rates , as the proposed development provides insufficient off-street for accessible and visitor car parking spaces, bicycle parking and motorbike parking.

Part B12 Design Excellence

c. Objectives (a), (b), (c), (d) and controls (a), (b) and (e), as the proposed development provides insufficient information of the aesthetics of the proposed car stackers and the development will have a detrimental effect upon neighbouring sites in terms of acoustic amenity.

Part C3 Other Residential Development

- d. Section 3.9 Landscaping, as the proposed development further reduces the existing landscaping by 13.4m² from an existing 158.2m² to a proposed 144.8m², which falls short of the minimum landscaping requirement of 191.3m².
- 2. The application does not satisfy section 4.15 (1)(a)(iv) of the Act with respect to the *Environmental Planning and Assessment Regulation 2000* (the Regulations), as insufficient documentation has been provided to properly assess the application with respect to Part 1 of Schedule 1, including but not limited to:

- a. Statement of Environmental Effects is considered insufficient, as it does not accurately identify the correct number of units based on the approved strata of the site.
- b. Insufficient information has been provided on the materiality or model of the proposed car stacker.
- c. Missing Site Waste Recycling Management Plan.
- 3. The application is contrary to section 4.15 (1)(d) of the Act in relation to matters raised in the public submissions received that object to the proposed development.
- 4. The application is contrary to section 4.15 (1)(e) of the Act in relation to the public interest as it is not compatible with the existing and desired future character of the locality and the broader Waverley local government area.

RECEIVED
Waverley Council

Application No: DA-392/2022

Date Received: 08/09/2022

Plan of Management for the operation of a Car Stacking System

301 Bondi Road, Bondi

AP 1818

August 2022



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PURPOSE OF PLAN

This Plan of Management forms part of the development consent for the proposed Car Stackers at 301 Bondi Road, Bondi.

The primary purpose of this Plan of Management is to ensure the car parking is used safely, efficiently and protects the amenity of users, residents and neighbours.

It is a requirement of the Development Consent and Strata By-Laws that this plan be adhered to by all users of the car stacker system.

The Plan shall be issued by the building manager to all new owners/tenants so they understand the procedures and limitations of the use of the parking area.

The Plan should be reviewed by the building manager, as necessary, to adapt to any changes in circumstances. Contact details of the building manager should be displayed throughout the various levels within the building. Prior to the use of the stackers the owner shall have this POM endorsed by a suitably qualified traffic engineer.

The Plan shall be kept on site at all times.

2. THE PREMISES

This Plan of Management relates to 301 Bondi Road, Bondi.

3. PROPOSED DEVELOPMENT

It is proposed to construct additional parking to the residential flat building through installation of 3 x car stackers. This is to be archived by the excavation of 3 of 5 existing hardstand parking spaces to allow for the installation of 3 x car stackers such that there will be 8 car spaces in total.



4. CAR PARKING ACCESS AND ALLOCATION

The car stackers are allocated as follows:

- 1. Lots 1 & 6 (jointly)
- 2. Lots 2 & 5 (jointly)
- 3. Lots 3 & 4 (jointly)

Stackers are allocated by by-law to these specific lots and are never to be used for general or visitor parking.

5. HOURS OF USE

The car stackers **must not be used** between the following hours:

- 22.00 07.00 Weekdays
- 00.00 08.00 Weekends

6. GENERAL PROCEDURES AND REQUIREMENTS

The following procedures are to be adopted for the use of the parking area:

- all vehicles <u>must</u> enter and exit the site in a forward direction at all times.
- all vehicles <u>must</u> parked wholly in the bays only
- all vehicular parking areas must be kept clear of goods and must not be used for storage purposes at any time or for any vehicle other than the vehicles the system has been designed for.
- The owner/building manager shall implement a complaint system utilising an on-site diary to ensure the efficient, coordinated and equitable use of the parking area by all authorised users

Suitable signage is to be installed prior to use of the stacker including, but not limited to:

 an "authorised resident parking only" sign installed at the entrance to the site visible at street level



7. NOISE AND LIGHT SPILL

Upon entering a stacker, the operator of the vehicle must immediately:

- Turn off Headlights
- Turn off Engine

8. ACOUSTIC REQUIREMENTS

In order to comply with the relevant noise criteria all recommendations in the report prepared by Acoustic Assessment by Rodney Stevens Acoustics Pty Ltd, Revision 3, 12 July 2022, namely:

Enclosure around each motor should be installed. The assumed enclosure has the following properties: o The side of the enclosure consist of 1mm steel sheet with 15% perforation. If possible, insulation should be installed inside the enclosure.

- The front and back side of the enclosure is open.
- The dimension of the enclosure is 0.5m high, 0.3m wide and 0.75m long.
- If the parking lift contains chain link, then the chain link in contact with motor should be enclosed as well.
- Resilient mounts should be used where metal adjoins metal in the mounting systems to minimise noise where possible.

9. BREAKDOWNS/SERVICING

The servicing of the car stacker is to occur as per the manufacturers' specifications.

In the event the car stacker breaks down, the building manager/owner will arrange for a technician to repair the system as soon as possible. Provided the stacker is serviced bi-annually and well maintained, much like a motor vehicle, breakdowns are expected to be rare.

It is noted the breakdowns are generally not due mechanical failures but due to the numerous safety systems and sensors being accidentally tripped. The stacker incorporates a computer which in many cases can self-diagnose the problem and inform service personnel who can often fix the problem remotely via the internet. The owner shall adopt the most practical and effective system to ensure break downs can be minimised and when they do occur they are fixed promptly.



10. BY - LAW

The following new by-law relates to the car stackers:

(Note: By-law 21 is intended to enable the owners of lots 1 & 6 (jointly), 2 & 5 (jointly), 3 & 4 (jointly) to separately make any necessary applications to Waverley Council for approval of a car stacker parking system and if approved provide exclusive use and entitlement over common property and common property air space necessary for such use to be used in conjunction with intended easements for lots 4,5 and 6 which are set out in the Schedule of this By-law which is intended to be registered after registration of the Strata Plan.)

(1) Lots to which this by-law applies:

This by-law applies to lots 1,2, 3, 4, 5 and 6.

(2) Definitions

In this by-law:

"car stacker parking system" means the three systems to be constructed in or in the Lots for the stack parking of motor cars and motorcycles, being:

"car stacker parking systems" means:

System 1 for Lots 1 and 6 (System 1)

System 2 for Lots 2 and 5 (System 2)

System 3 for Lots 3 and 4 (System 3)

- (a) the platform holding the motor cars and motorcycles;
- (b) the hydraulic lifting system comprising the vertical uprights attached to the platform, the equipment in the vertical uprights, the hydraulic pump and motor and the hydraulic pipes;
- (c) the power supply box; and
- (d) the key-operated

control box.

"lot" means lots 1,2,3, 4, 5

and 6

"owner" means the registered proprietors or mortgagees in possession for the time being of the lot.



(3) Part of lot

The car stacker parking system in each lot is part of the lot and the responsibility of the owner of the lot.

(4) Special privilege

- (a) The owner has the special privilege to connect the car stacker parking system to an electricity outlet and power supply box installed within the common property as of the date of registration of the strata plan.
- (b) (i) the owners of lots 1,2,3,4, 5 and 6 have the special privilege to use the common property concrete drive slab located on the ground level
 - (A) for the owners (or persons authorised by the owners) to access the car stacker parking system via the concrete drive slab, and
 - (B) for the owners (or persons authorised by the owners) of lots 4,5 and 6 to permanently park a motor car or motorcycle on that part of the car stacker parking system located on ground level (unless the car stacker parking system is used to permit the owners of lots 1,2 and 3 to access the car stacker parking system) in respect of their respective Car stacker parking systems.
 - (ii) the use and operation of the car stacker parking system will be conducted so that
 - (A) part of the car stacker parking system located on the ground level will be used by the owners (or persons authorised by the owners) of lots 4,5 and 6 to permanently park a motor car or motorcycle on the car stacker parking system in respect of their respective Car stacker parking systems, and
 - (B) when the owners (or persons authorised by the owners) of lots 1,2 and 3 use the car stacker parking system for the purpose of entering or leaving the car stacker, the part of the car stacker parking system located on the ground level will be activated to move up one level to permit the owners (or persons authorised by the owners) of lots 1,2 and 3 to park a motor car or motorcycle on the car stacker and the car stacker will then be further activated to permit the car stacker to move down one level so that the motor car or motorcycle parked on the car stacker by the owners (or persons authorised by the owners) of lots 1,2 and 3 will be located on the lower level of the car stacker



parking system in respect of their respective Car stacker parking systems.

(5) Exclusive use


The owner has the exclusive use of those items of cables, wires, pipes and the like connecting the car stacker parking system to the electricity outlet and key-operated control box installed within the common property as at the date of registration of the strata plan.

- (6) The owner acknowledges that for each lot serviced by the car stacker parking system, the car stacker parking system will fit a motor car or motorcycle
 - (a) with a maximum useable width of 190cm
 - (b) with a maximum useable height of 190cm
 - (c) with a maximum useable length of 500cm, and
 - (d) with a maximum useable weight of 2,000kg.
- (7) Maintenance, repair and replacement
 - (a) The owner in respect of their respective Car stacker parking systems is responsible for any council approvals, the costs of purchase, installation, construction proper maintenance of and keeping in a state of good and serviceable repair, and as and when necessary, the replacement of:
 - (i) the car stacker parking system.
 - (ii) the items of cables, wires, pipes and the like connecting it to an electricity outlet; and
 - (iii) that part of the common property to which these items are attached.
 - (b) The owner in respect of their respective Car stacker parking systems is responsible for the insurance of the car stacker parking system against loss and damage as well as injury or death caused by the use or operation of the car stacker parking system.
 - (c) The owner is responsible to ensure that the owner (and anyone authorised by the owner):
 - (i) familiarise themselves with the car stacker parking system, the proper and safe operation of the car stacker parking system and the conditions of use of the car stacker parking system recommended by the manufacturer of the car stacker parking system before they use the car stacker parking system
 - (ii) complete the online training course for the proper and safe use of the car stacker parking system offered by the manufacturer of the car stacker parking system (training course) before they use the car stacker parking system
 - (iii) obtain an acknowledgment from any prospective purchaser or tenant of their lot to ensure that a purchaser or tenant have completed the training course before they use the car stacker parking system.



- (d) the owner in respect of their respective Car stacker parking system must at the owner's cost cause the car stacker parking system to be kept in good, proper and operating working condition including:
 - only using the car stacker parking system to store vehicles which are within the size and weight parameters prescribed by the manufacturer of the car stacker parking system,
 - (ii) having the car stacker parking system regularly inspected and tested at
 - (iii) the intervals recommended by the manufacturer of the car stacker parking system,
 - (iv) causing all necessary maintenance, repairs and replacements to be carried out promptly, and
 - (v) not allowing the car stacker parking system to:
 - (A) fall into a state of disrepair,
 - (B) operate noisily, or
 - (C) leak oil or any other fluid onto a lot or common property; and
- (e) if an owner does not comply with by-law (7), the owners corporation can:
 - (i) enter the part of the lot where the car stacker parking system is situated and carry out any necessary inspection, maintenance, repair or replacement, and
 - (ii) recover from the owner the cost of any action taken under paragraph (i) of this by-law.
- (f) The entitlement to exclusive use and enjoyment provided by this bylaw is subject to and conditional upon
 - the owners of lots 4,5 and 6 registering on title an easement in the terms of the Schedule below;
 - (ii) the headlights of vehicles using the car stackers for units 1.2.3.4.5 and 6 will be off at all times;
 - (iii) vehicle engines using car stackers for units 1,2,3,4,5 and 6 will turn off their engines when parked or stationary and the engines will only be turned on when entering or disembarking the car stacker.




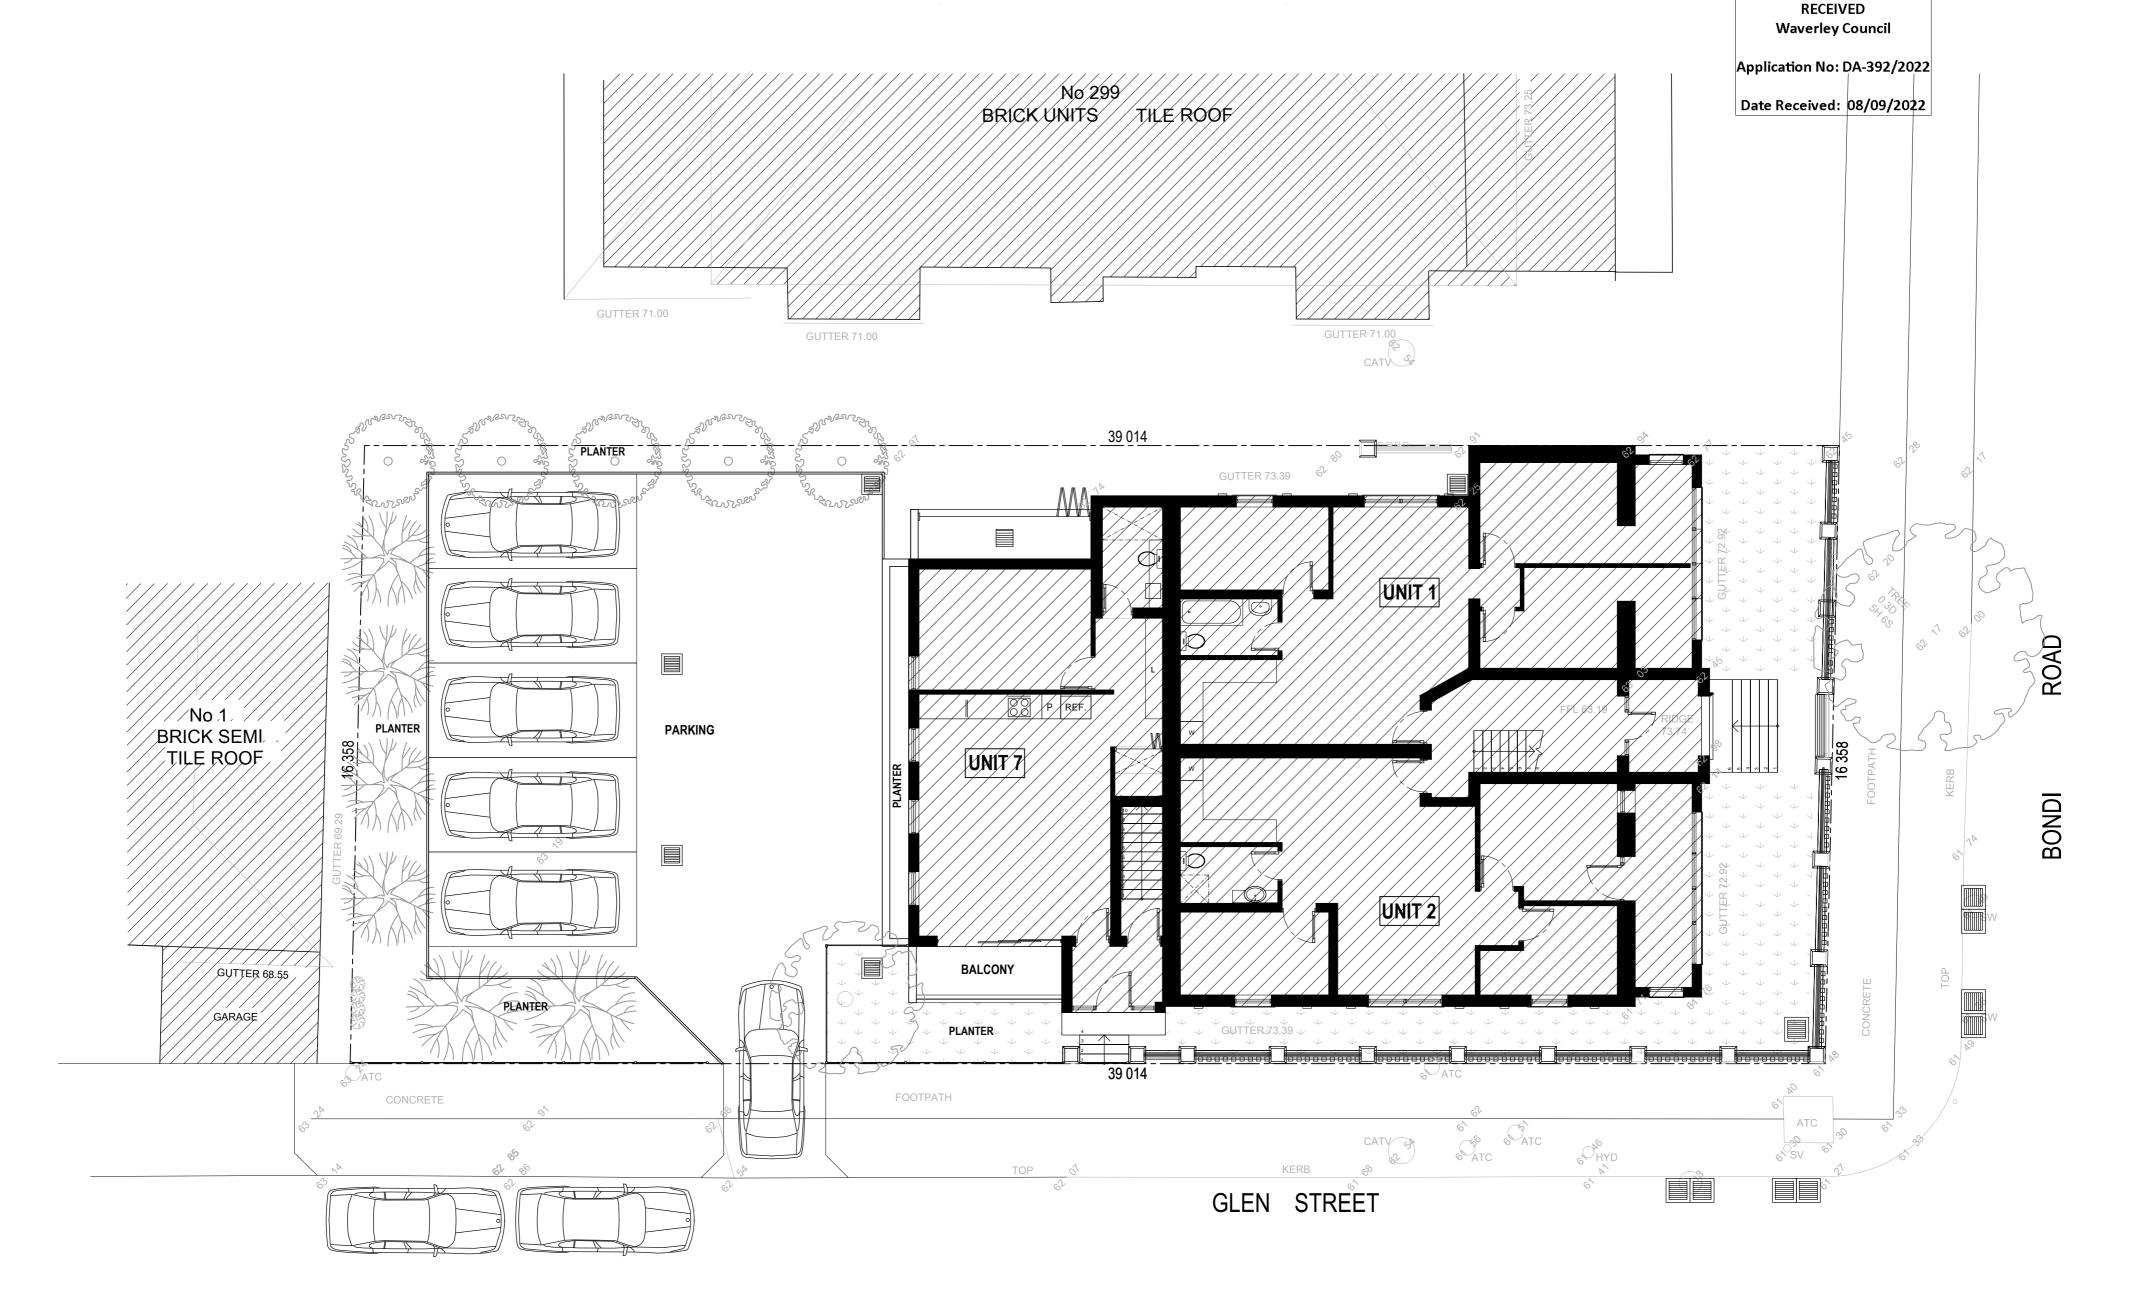

EXISTING GROUND FLOOR PLAN




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IS	SUF	DATE	DESCRIPTION
	A	31.05.2021	DA Issue to Counc
	R		
	В	08.08.2022	DA Issue to Counc

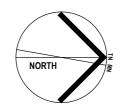PROJECT: Proposed Carparking 301 Bondi Road, Bondi	SHEET TITLE: Existing Gro	Existing Ground Floor Plan			
CLIENT: Phillip Hakim 301 Bondi Road, Bondi	SCALE: 1:100 @ A2 DRAWN: Peter S	SHEET SIZE	DWG NO:	REVISION:	



PROPOSED GROUND FLOOR PLAN

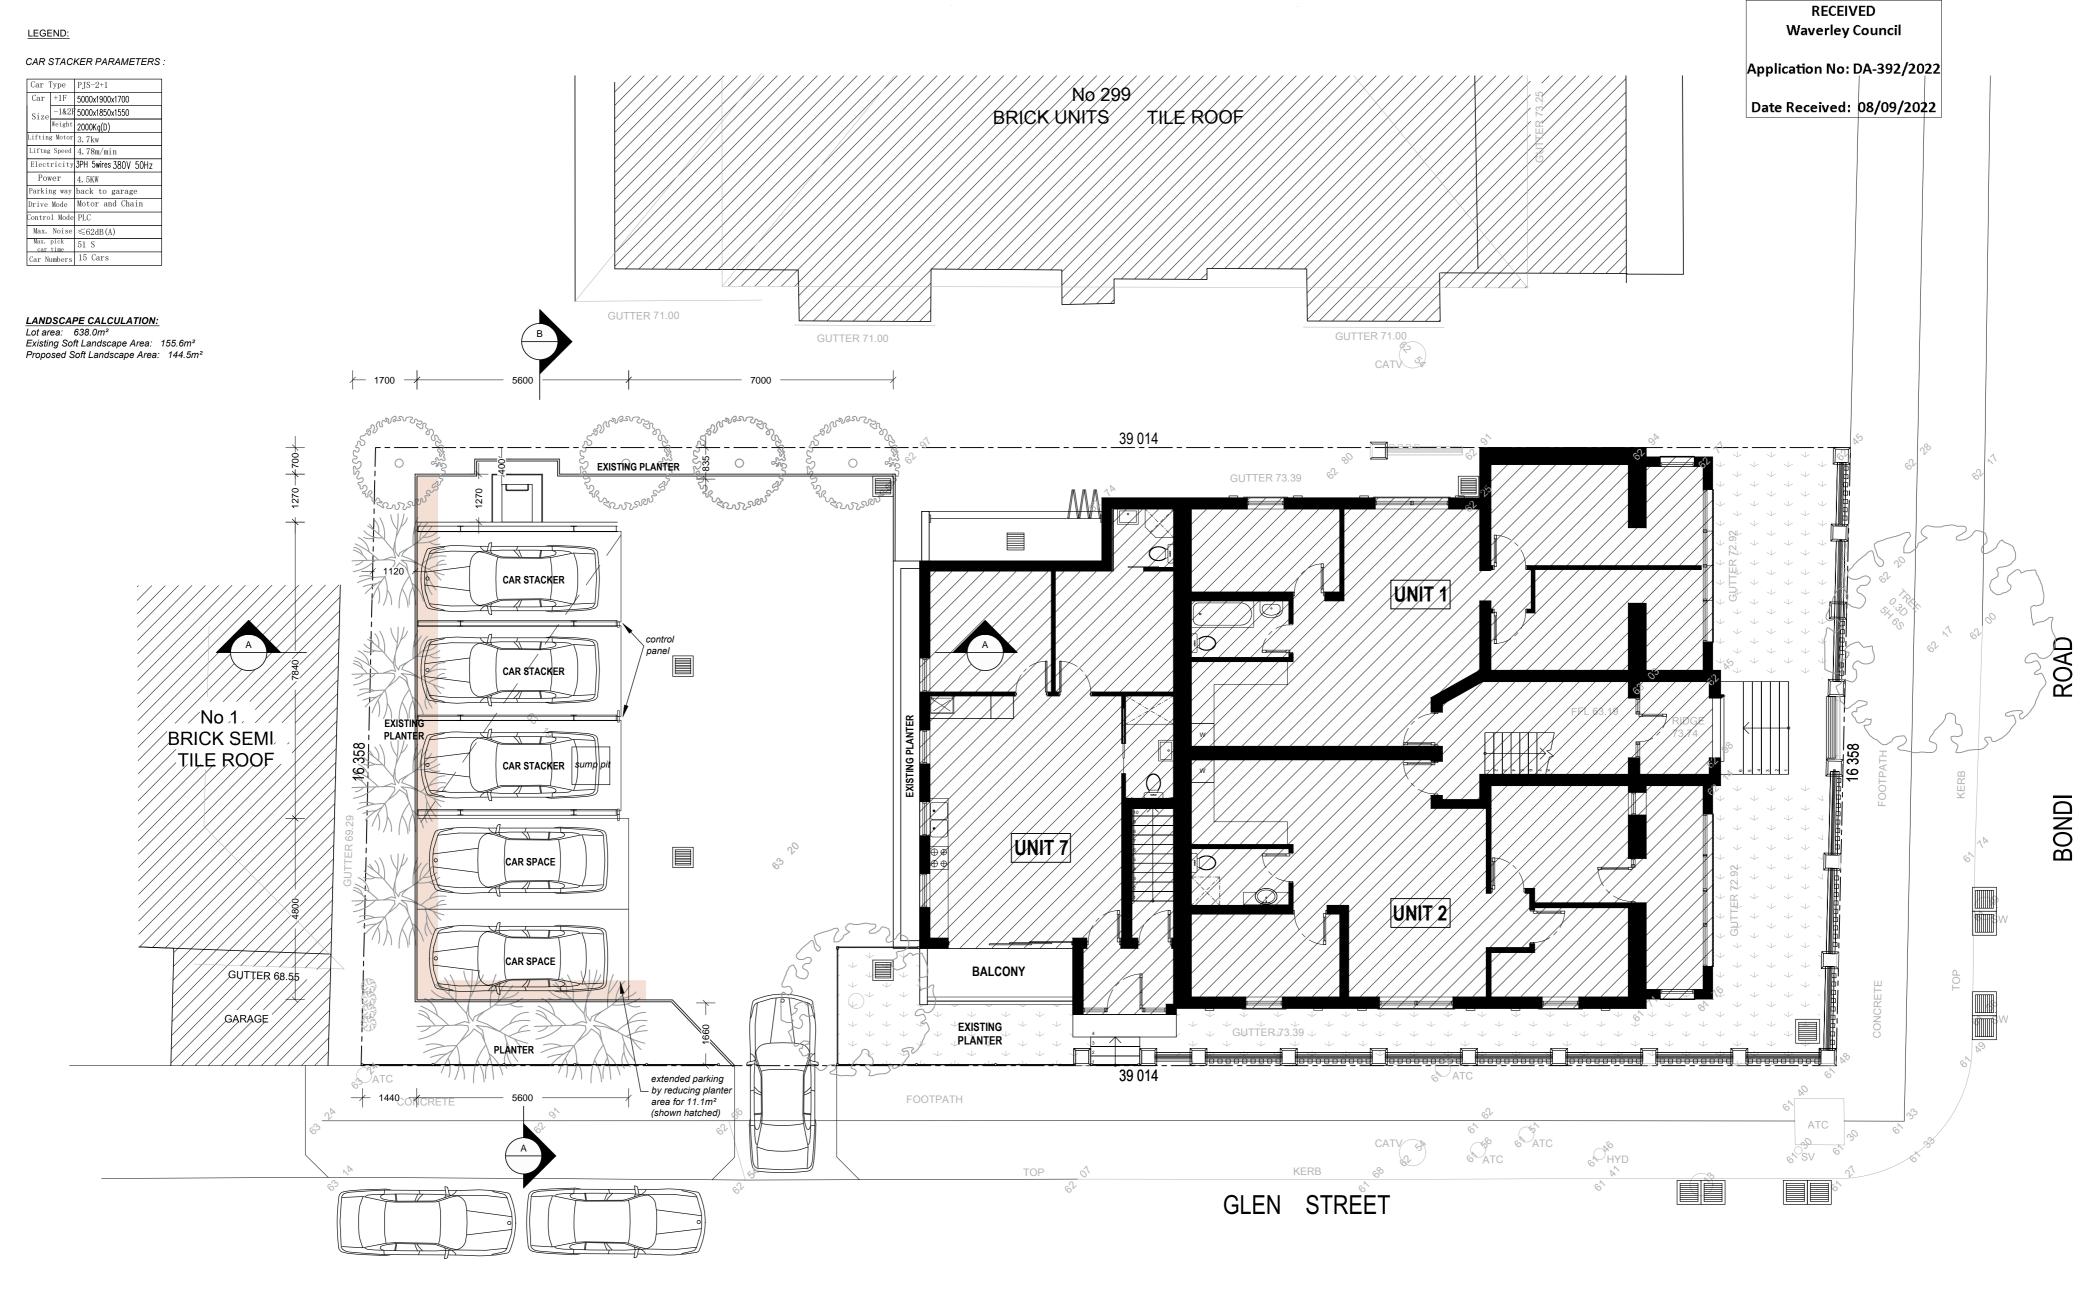


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NORTH	2

A 31.05.2021 B 08.08.2022	31.05.2021	DA Issue to Council DA Issue to Council	PROJECT: Proposed Carparking 301 Bondi Road, Bondi	Proposed Ground Floring	oor Plan
			CLIENT: Phillip Hakim	SCALE: 1:100 @ A2 SHEET SIZE DRAWN: Peter S A 2	DWG NO:

301 Bondi Road, Bondi

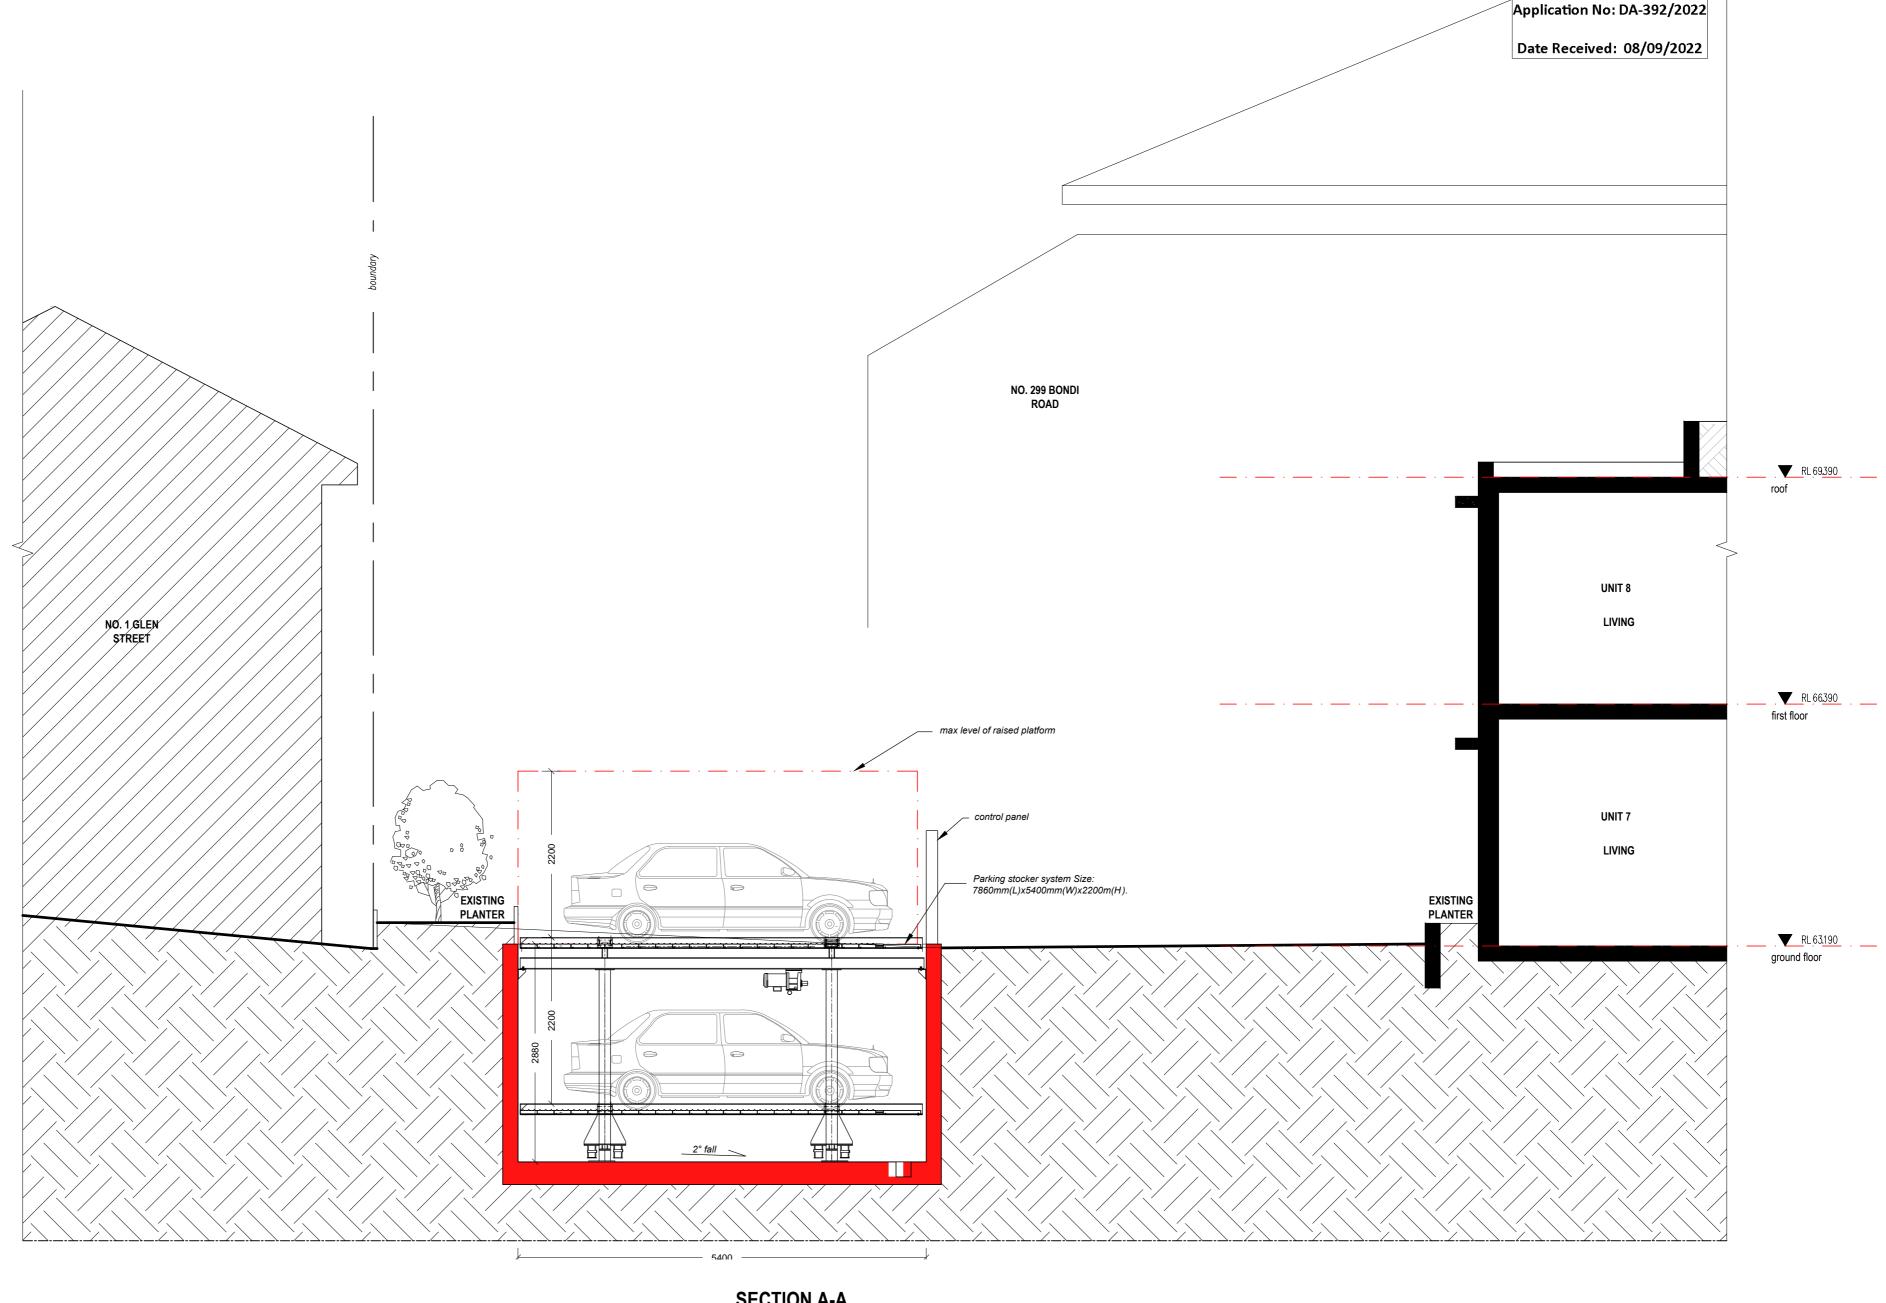

SECTION A-A


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ISSUE	DATE	DESCRIPTION
Α	31.05.2021	DA Issue to Council
В	08.08.2022	DA Issue to Council

PROJECT:	SHEET TITLE:			
Proposed Carparking	Section A-A			
301 Bondi Road, Bondi				
	2015 450 0 40			
CLIENT:	SCALE: 1:50 @ A2	SHEET SIZE		ISION:
Phillip Hakim	DRAWN: Peter S	A2	DA03 b	`
301 Bondi Road, Bondi		\wedge	DAOS L	J
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RECEIVED **Waverley Council**



SECTION B-B SCALE: 1:50

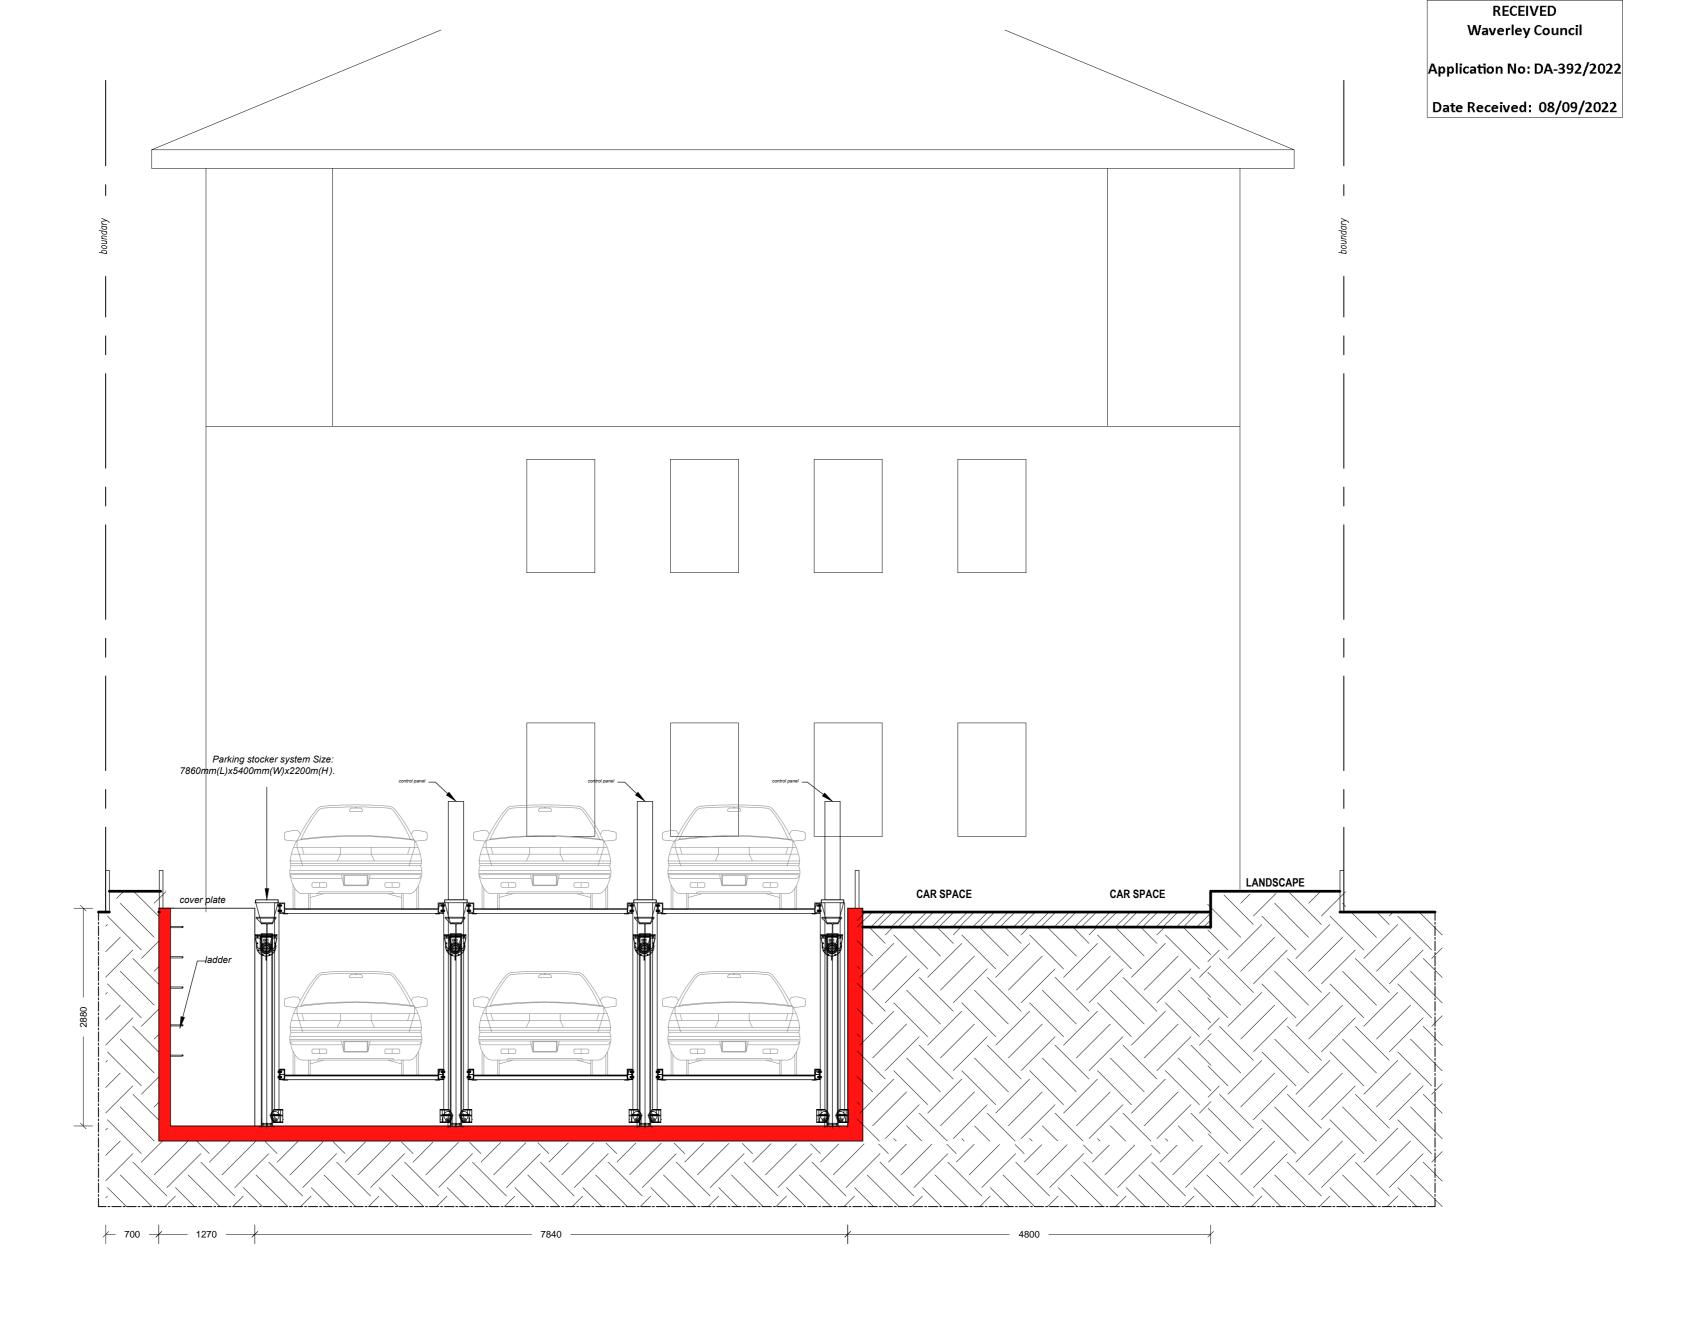

ISSUE	DATE	DESCRIPTION
Α	31.05.2021	DA Issue to Counc
В	08.08.2022	DA Issue to Counc

PROJECT:	
Proposed Carparking	
301 Bondi Road, Bondi	
CHENT	
CLIENT: Dhillin Hakim	
CLIENT: Phillip Hakim	

Section B-B

SCALE: 1:50 @ A2 DRAWN: Peter S

DA04 b

 \bigcirc EXISTING PLANTER 3x parking stocker system
Pit Size:
7860mm(L)x5400mm(W)x2200m(H). CAR STACKER control panel existing PIT CAR STACKER control panel EXISTING PLANTER 358 CAR STACKER 9 Pit sump to drain - water from the stacker pit. control panel **GUTTER** 69.29 existing PIT CAR SPACE CAR SPACE extended parking - by reducing planter area for 15.3 m² PLANTER to Council's stormwater system 1430 PROPOSED PARKING PLAN

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Application No: DA-392/2022

Date Received: 08/09/2022



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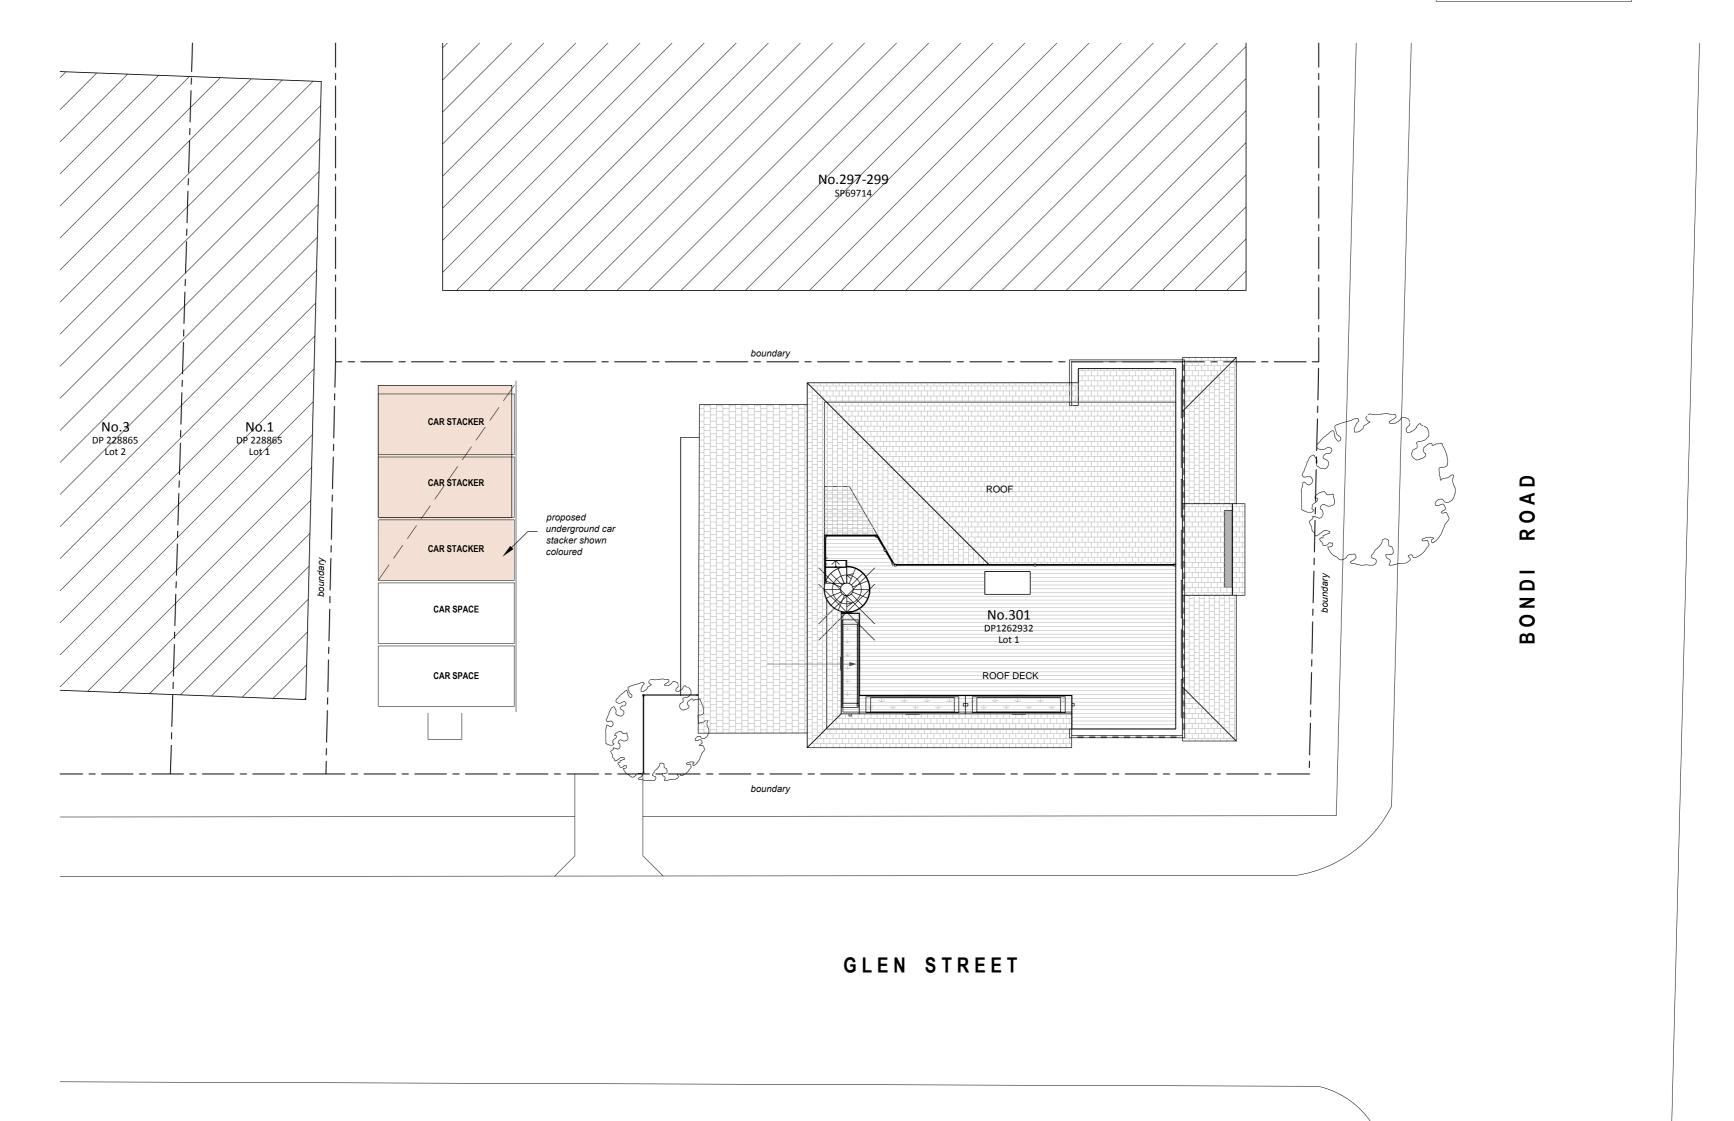
ISSUE	DATE	DESCRIPTION
Α	31.05.2021	DA Issue to Counc
В	08.08.2022	DA Issue to Counc

PROJECT: Proposed Carparking 301 Bondi Road, Bondi	Proposed Pa	arking Plar	1	
CLIENT: Phillip Hakim 301 Bondi Road, Bondi	SCALE: 1:50 @ A2 DRAWN: Peter S	SHEET SIZE A2	DWG NO:	REVISION:

RECEIVED **Waverley Council**


Application No: DA-392/2022

Date Received: 08/09/2022



SITE PLAN SCALE: 1:150



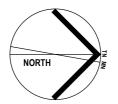


ISSUE	DATE	DESCRIPTION
Α	31.05.2021	DA Issue to Counci
В	08.08.2022	DA Issue to Counci

Site Plan

CLIENT:
Phillip Hakim
301 Bondi Road, Bo

SCALE: 1:150 @ A2 DRAWN: Peter S

DA06 b

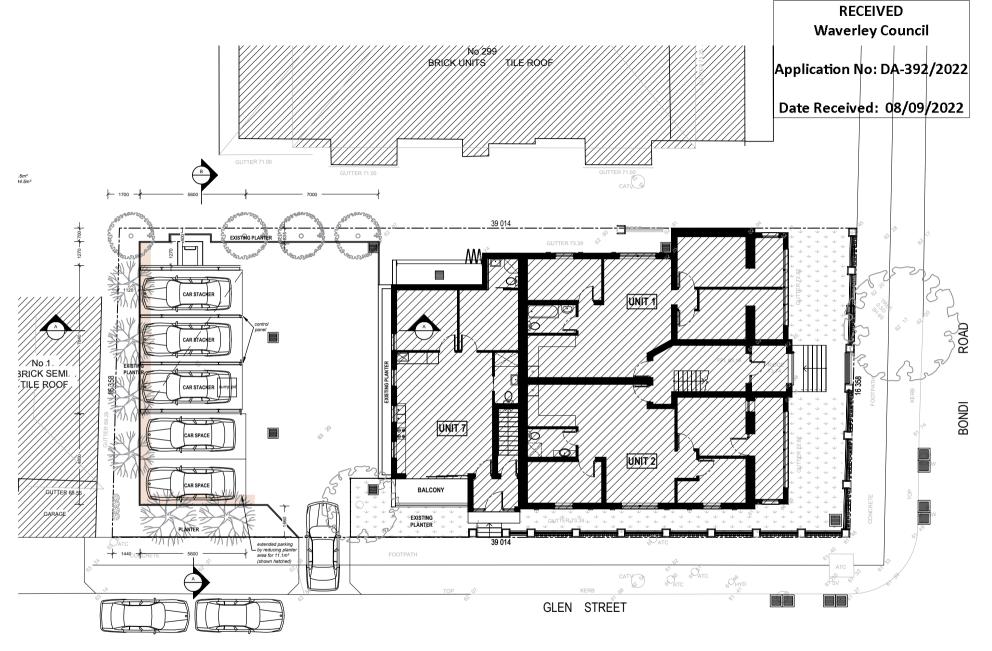

PROPOSED PARKING PLAN

SCALE: 1:200



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ISSUE	DATE	DESCRIPTION
Α	31.05.2021	DA Issue to Counc
В	08.08.2022	DA Issue to Counc

Notification drawings Proposed Carparking 301 Bondi Road, Bondi SCALE: 1:200 @ A4

Phillip Hakim 301 Bondi Road, Bondi

A4 N01 b DRAWN: Peter S






Report to the Waverley Local Planning Panel

Application number	DA-366/2022
Site address	6/88 Beach Road, Bondi Beach
Proposal	Alterations and additions to Unit 6
Date of lodgement	31 August 2022
Owner	Ms S O'Toole and Mr M Kwantes and Owners of Strata Plan SP95100
Applicant	Siobhan O'Toole
Submissions	Three
Cost of works	\$164,956
Principal Issues	 Non-compliant FSR Non-compliant height Overshadowing Visual bulk and scale Rear building line
Recommendation	That the application be REFUSED for the reasons contained in the report.

SITE MAP

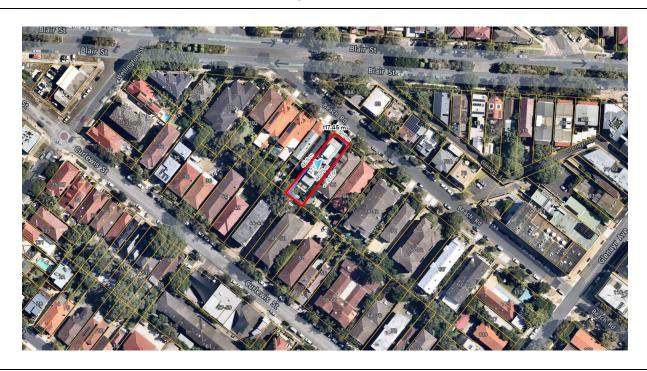

1. PREAMBLE

1.1. Executive Summary

The development application seeks consent for alterations and additions at the site known as Unit 6/88 Beach Road, Bondi Beach.

The principal issues arising from the assessment of the application are as follows:

- Non-compliant floor space ratio (FSR)
- Non-compliant height
- Overshadowing
- Visual bulk and scale
- Rear building line

The assessment finds these issues unacceptable resulting in unreasonable impacts on the amenity of neighbouring properties and the locality.

A total number of three submissions were received and the issues raised in the submissions have been considered and addressed in this report and in the Recommendation.

The application has been assessed against the relevant matters for consideration under section 4.15(1) of the *Environmental Planning and Assessment Act 1979*. It is recommended for refusal.

1.2. Site and Surrounding Locality

A site visit was carried out on 7 December 2022.

The site is identified as Lot 2 in SP95100, known as Unit 6/88 Beach Road, Bondi Beach.

The site is rectangular in shape with a frontage to Bondi Road measuring 12.165m. It has an area of 587.1m² and is generally flat.

The site is occupied by a four-storey residential flat building with vehicular access provided from Beach Road to the basement car park.

The subject site is adjoined by two storey semi-detached dwellings to the north-west and a two storey with attic residential flat building to the south-east. The rear of the site adjoins residential flat buildings of two to four storeys in height.

This section of Beach Road between Blair Street and Glenayr Avenue is characterised by a mix of dwelling houses and residential flat buildings with commercial development at the intersection with Glenayr Avenue, including the Beach Road Hotel at the corner of Beach Road and Glenayr Avenue.

Figures 1 to 4 are photos of the site and its context.



Figure 1: The subject site



Figure 3: Rear of the neighbouring properties to the north-west showing the rear building line



Figure 2: View over the top of the subject building looking south-east (Source: Applicant's submission)



Figure 4: View from the rear bathroom window of the subject unit looking over the area to be built upon

1.3. Relevant Development History

A search of Council's records revealed the following recent and relevant development history of the site:

- DA-618/2014 deferred commencement consent was issued by the Waverley Development
 Assessment Panel (WDAP) on 26 August 2015 for the demolition and construction of a fourstorey residential flat building, basement car parking, landscaping, and strata subdivision.
- DA-618/2014/A modification including extension to the ground floor to the north and south, minor internal changes and deletion of windows was approved on 7 June 2016.
- DA-618/2014/B Modification to change a privacy screen to a masonry wall was approved on 23 June 2017.
- DA-618/2014/C Modification to the approved residential flat building including wall type construction change, lowering of basement level and addition of carpark exhaust ventilation was approved on 8 August 2017.

1.4. Proposal

The development application seeks consent for alterations and additions to Unit 6 within the existing residential flat building, specifically the following:

- Extension to Unit 6 at its upper floor level of the residential flat building.
- The proposed rear extension is to accommodate a new study/ home office and is to comprise a
 total gross floor area of 21.1m² resulting in an overall gross floor area for the building of 541.1m²
 being a floor space ratio of 0.92:1.
- A 500mm wide balcony is proposed at the rear south-west facing elevation of the new addition.

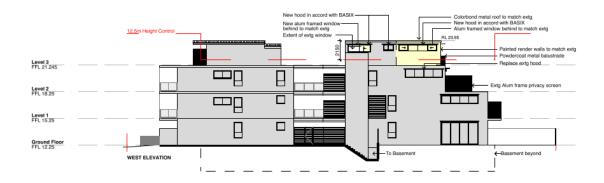


Figure 5: North-west elevation showing the proposed addition in yellow (Source: Ken Powell Architects)

The addition is to follow the existing height alignment to an overall height of 14.65m from the existing ground level (basement).

1.5. Background

The development application was lodged on 31 August 2023 and notified from 19 September 2022 until 5 October 2022. Three (3) submissions were received during notification of the application which are discussed in more detail below.

2. ASSESSMENT

The following matters are to be considered in the assessment of this development application under section 4.15 of the *Environmental Planning and Assessment Act 1979* (the Act).

2.1. Planning Instruments and Development Control Plans

The following is an assessment against relevant legislation, environmental planning instruments, including State environmental planning policies (SEPPs), and development control plans.

2.1.1. State Environmental Planning Policies (SEPPs)

The following SEPPs apply from the 1st March 2022 and have been considered acceptable in the assessment of this development application:

- SEPP (Building Sustainability Index BASIX) 2004
- SEPP (Resilience and Hazards) 2021

2.1.2. Waverley Local Environmental Plan 2012 (Waverley LEP 2012)

The relevant matters to be considered under the Waverley LEP 2012 for the proposed development are outlined below:

Table 1: Waverley LEP 2012 Compliance Table

Provision	Compliance	Comment
Part 1 Preliminary		
1.2 Aims of plan	Yes	The proposed modifications are not inconsistent with the aims of the plan.
Part 2 Permitted or prohibited de	velopment	
Land Use Table R3 Medium Density Residential Zone	Yes	The proposal is defined as a residential flat building, which is permitted with consent in the R3 Medium Density Residential zone.
Part 4 Principal development star	ndards	
4.3 Height of buildings ■ 12.5m		The height proposed is to follow the same building height of 14.65m which is 2.15m or 17.2% above the height development standard applicable to the subject site. It should be noted that the original building
	No	on site was approved as height compliant as the height was measured from the existing ground level at that time where no basement floor level existed.
		The development now incorporates a basement floor level and the height is measured from the existing ground level which is now measured from the bottom of the basement.
 4.4 Floor space ratio 0.9:1 Site area: 587.15m² 		The existing building on site has a FSR of 0.886:1, which is compliant with the FSR development standard.
• 528.43m²	No	The proposal will increase the GFA on site by 21.1m² to an FSR of 0.92:1 (541.1m²) exceeding the development standard by 12.67m² or 2.4%.
4.6 Exceptions to development standards	See discussion	The application is accompanied by a written request pursuant to clause 4.6 of Waverley

Provision	Compliance	Comment
		LEP 2012 to vary the height and FSR development standards. A detailed discussion of the variation to the development standards is presented below this table.

The following is a detailed discussion of the issues identified in the compliance table above in relation to the Waverley LEP 2012.

Clause 4.6 Exceptions to Development Standards - Height

The application seeks to vary the height of buildings development standard in clause 4.3 under Waverley LEP 2012.

The site is subject to a maximum height development standard of 12.5m. The proposed development has a height of 14.65m, exceeding the standard by 2.15m equating to a 17.2% variation.

A written request has been submitted to Council in accordance with clause 4.6(3)(a) and (b) of Waverley LEP 2012 seeking to justify the contravention of the development standard by demonstrating:

- (a) That compliance with the development standard is unreasonable or unnecessary in the circumstances of the case; and
- (b) That there are sufficient environmental planning grounds to justify contravening the standard.

A copy of the applicant's written request has been provided to the Waverley Local Planning Panel for consideration.

Applicant's Written Request - Clause 4.6(3)(a) and (b)

The applicant seeks to justify the contravention of the height development standard on the following basis:

- (a) That compliance with the development standard is unreasonable or unnecessary in the circumstances of the case:
 - The building height development standard does not take into account the site is subject to an existing variation due to the basement garage. The proposal simply follows the existing building height and does not protrude above this height.
 - Despite the variation, the proposal comprises a considered design that is compatible with the established character of the site and surrounding properties and does not cause any significant impacts to the amenity of the site or surrounding area.
 - The broad application of building height does not exclude the possibility of a high quality built form without compromising the amenity of surrounding properties. Despite the variation, the proposal is able to achieve these outcomes.
 - The proposal continues to be consistent with the objectives of the building height standard and R3 Medium Density Residential objectives of the WLEP 2012.

- (b) That there are sufficient environmental planning grounds to justify contravening the standard:
 - The proposed extension is of an appropriate form and scale that is compatible with the existing residential flat building, surrounding development and streetscape.
 - The skilful design maintains appropriate privacy between the existing building and adjoining buildings. The new sliding doors to the rear elevation will be obscure glazing to 1500mm in height to avoid overlooking and only one highlight window is proposed to the north-west side elevation.
 - The proposal is located towards the rear of the building and due to the location of the building, there will not be impacts to any significant views.
 - The extension will be designed to match the existing building in terms of height, roof design, materials and finishes.
 - The proposed variation does not create any unreasonable overshadowing to the site or adjoining properties.

Consideration of Applicant's Written Request - Clause 4.6(4) (a) (i) and (ii)

Development consent must not be granted unless the consent authority is satisfied that:

- (a) The applicant's written request has adequately addressed the matters required to be demonstrated by subclause 3 of clause 4.6 being that compliance with the development standard is unreasonable or unnecessary in the circumstances of the case, and that there are sufficient environmental planning grounds to justify contravening the standard; and
- (b) The proposed development will be in the public interest because it is consistent with the objectives of the particular development standard and the objectives for development within the zone in which the development is proposed to be carried out.

Does the written request adequately address those issues at clause 4.6(3)(a)?

It is considered that the applicant has not adequately addressed that compliance with the standard is unreasonable or unnecessary in the circumstances of the case and has referenced one or more of the following justifications as set out in *Wehbe v Pittwater Council* (2007) 156 LGERA 446:

- (a) the objectives of the development standard are achieved notwithstanding non-compliance with the standard;
- (b) to establish that the underlying objective or purpose is not relevant to the development with the consequence that compliance is unnecessary;
- (c) to establish that the underlying objective or purpose would be defeated or thwarted if compliance was required with the consequence that compliance is unreasonable;
- (d) to establish that the development standard has been virtually abandoned or destroyed by the Council's own actions in granting consents departing from the standard and hence compliance with the standard is unnecessary and unreasonable; and

(e) to establish that "the zoning of particular land" was "unreasonable or inappropriate" so that "a development standard appropriate for that zoning was also unreasonable or unnecessary as it applied to that land" and that "compliance with the standard in that case would also be unreasonable or unnecessary.

The applicant specifically relies upon justification (a) outlined above to address clause 4.6(3)(a) of Waverley LEP 2012.

The applicant states the proposed height is consistent with the objectives of the height development standard and will not result in unreasonable impacts. Council disagrees with the contention that the objectives of the height development standard are achieved.

The height of the existing building on the site is 14.65m, already exceeding the height development standard by 2.15m or 17.2%. The proposal seeks to exacerbate this non-compliance by extending the building to the rear further expanding upon the non-compliance. The proposal will result in additional impacts to adjoining properties in regards to overshadowing and will not 'preserve the environmental amenity of neighbouring properties' thereby being contrary to objective (a) of the height development standard. The extent of these impacts is discussed later in this report. The proposed development is also not compatible with the height, bulk and scale of the desired future character of the locality contrary to objective (d) of the height development standard.

Does the written request adequately address those issues at clause 4.6(3)(b)?

The applicant has not adequately addressed that there are sufficient environmental planning grounds to justify contravening the development standard.

The extent of the variation, being 17.2% over the development standard demonstrates that the building bulk and scale of the development is excessive. Further creeping of the envelope under this current application is considered to be unacceptable resulting in unreasonable impacts on the amenity of neighbouring properties. The variation of the development standard is not in the public interest and the variation is inconsistent with the desired future character of the locality.

Is the development in the public interest?

The proposed development will not be in the public interest because it is not consistent with both the objectives of the particular development standard and the objectives for development within the zone in which the development is proposed to be carried out.

The relevant objectives of the height development standard are as follows:

- (a) to establish limits on the overall height of development to preserve the environmental amenity of neighbouring properties and public spaces and, if appropriate, the sharing of views,
- (d) to ensure that buildings are compatible with the height, bulk and scale of the desired future character of the locality and positively complement and contribute to the physical definition of the street network and public space.

The objectives of the R3 Medium Density Residential zone are as follows:

- To provide for the housing needs of the community within a medium density residential environment.
- To provide a variety of housing types within a medium density residential environment.
- To enable other land uses that provide facilities or services to meet the day to day needs of residents.
- To maximise public transport patronage and encourage walking and cycling.

The departure of the proposal from the relevant planning provisions serves to demonstrate the failure of the development to meet the objectives of the development standard, particularly objective (a) representing an overdevelopment of the site. The submitted Clause 4.6 written request is not well founded as it does not demonstrate the outcomes required by Clause 4.6(3) and (4) of the Waverley LEP 2012.

Whilst it is acknowledged that the proposed development does provide for the housing needs of the community within a medium density environment and would improve the internal amenity for the occupants of the unit, the exceedance of the development standard and the overall planning outcome for the site to achieve this objective as proposed is unacceptable and cannot be supported. There is no reason to vary the height development standard as the current building represents the bulk and scale desired by the Waverley LEP 2012 and varying the development standard is not in the public interest.

Conclusion

For the reasons provided above, the requested variation to the height development standard is not supported as the applicant's written request has not adequately addressed the matters required to be addressed by clause 4.6(3) of the Waverley LEP 2012. In addition, the proposed development is not in the public interest because it is inconsistent with the objectives of the height development standard and the R3 Medium Density Residential zone.

Clause 4.6 Exceptions to Development Standards - FSR

The application seeks to vary the FSR development standard in clause 4.4 under Waverley LEP 2012.

The site is subject to a maximum FSR development standard of 0.9:1. The proposed development has a FSR of 0.92:1, exceeding the standard by 12.67m² equating to a 2.4% variation.

A written request has been submitted to Council in accordance with clause 4.6(3)(a) and (b) of Waverley LEP 2012 seeking to justify the contravention of the development standard by demonstrating:

- (a) That compliance with the development standard is unreasonable or unnecessary in the circumstances of the case; and
- (b) That there are sufficient environmental planning grounds to justify contravening the standard.

A copy of the applicant's written request has been provided to the Waverley Local Planning Panel for consideration.

Applicant's Written Request - Clause 4.6(3)(a) and (b)

The applicant seeks to justify the contravention of the FSR development standard on the following basis:

- (a) That compliance with the development standard is unreasonable or unnecessary in the circumstances of the case:
 - Compliance with the development standard is unreasonable and unnecessary as the proposed extension is of an appropriate form and scale that is compatible with the existing residential flat building, surrounding development and streetscape.
 - The proposed extension is of an appropriate form, design and scale that is compatible with the existing residential flat building, surrounding development and streetscape.
 - Strict compliance with the maximum FSR is considered unreasonable as this additional floor area does not generate unreasonable amenity impacts to the adjoining properties in terms of overshadowing, visual or acoustic privacy impacts, or views.
 - The proposal continues to be consistent with the objectives of the FSR standard and R3 Medium Density Residential objectives of the WLEP 2012.
- (b) That there are sufficient environmental planning grounds to justify contravening the standard:
 - The proposed extension is of an appropriate form and scale that is compatible with the existing residential flat building, surrounding development and streetscape.
 - The skilful design maintains appropriate privacy between the existing building and adjoining buildings. The new sliding doors to the rear elevation will be obscure glazing to 1500mm in height to avoid overlooking and only one highlight window is proposed to the north-west side elevation.
 - The proposal is located towards the rear of the building and due to the location of the building there will not be impacts to any significant views.
 - The extension will be designed to match the existing building in terms of height, roof design, materials and finishes.
 - The proposed variation does not create any unreasonable overshadowing to the site or adjoining properties.

Consideration of Applicant's Written Request - Clause 4.6(4) (a) (i) and (ii)

Development consent must not be granted unless the consent authority is satisfied that:

(a) The applicant's written request has adequately addressed the matters required to be demonstrated by subclause 3 of clause 4.6 being that compliance with the development standard is unreasonable or unnecessary in the circumstances of the case, and that there are sufficient environmental planning grounds to justify contravening the standard; and

(b) The proposed development will be in the public interest because it is consistent with the objectives of the particular development standard and the objectives for development within the zone in which the development is proposed to be carried out.

Does the written request adequately address those issues at clause 4.6(3)(a)?

It is considered that the applicant has not adequately addressed that compliance with the standard is unreasonable or unnecessary in the circumstances of the case and has referenced one or more of the following justifications as set out in *Wehbe v Pittwater Council* (2007) 156 LGERA 446:

- (a) the objectives of the development standard are achieved notwithstanding non-compliance with the standard;
- (b) to establish that the underlying objective or purpose is not relevant to the development with the consequence that compliance is unnecessary;
- (c) to establish that the underlying objective or purpose would be defeated or thwarted if compliance was required with the consequence that compliance is unreasonable;
- (d) to establish that the development standard has been virtually abandoned or destroyed by the Council's own actions in granting consents departing from the standard and hence compliance with the standard is unnecessary and unreasonable; and
- (e) to establish that "the zoning of particular land" was "unreasonable or inappropriate" so that "a development standard appropriate for that zoning was also unreasonable or unnecessary as it applied to that land" and that "compliance with the standard in that case would also be unreasonable or unnecessary.

The applicant specifically relies upon justification (a) outlined above to address clause 4.6(3)(a) of Waverley LEP 2012.

Council disagrees with the contention that the objectives of the FSR development standard are achieved. The applicant has not adequately demonstrated that the overall scale of the development preserves the environmental amenity of neighbouring properties as stated at objective (d) of the FSR development standard. The proposed development will have additional overshadowing impacts on adjoining properties.

The building as approved in 2014, was considered to be an acceptable development with regards to the FSR at the time, complying with the applicable FSR development standard. It is noted that that as part of the assessment of the original DA for the building that a non-compliance to the FSR was sought at that time, but the applicant was advised that a non-compliant FSR would not be supported. It could be reasonably argued that this building already achieves the maximum FSR permitted on the site and any further expansion of the built form must be carefully considered against the impacts upon adjoining properties and the locality.

This development application seeks a further development 'creep' with the additional floor space proposed to extend the rear building line at the upper most floor Level. With the addition of 21.1m² of GFA to the building envelope, the scale of the proposed building will change as a result of the increase

in FSR particularly with the extension of the rear building line at the fourth floor level. The proposed FSR results in an exceedance of the development standard which is visible in its local context which is considered unacceptable. Further creeping of the envelope under this current application is considered to be unacceptable resulting in unreasonable impacts on the amenity of neighbouring properties due to overshadowing and visual bulk and scale impacts. As such the scale of the development does not preserve the amenity of surrounding properties nor the desired future character of the locality contrary to objectives (c) and (d) of the FSR development standard.

Does the written request adequately address those issues at clause 4.6(3)(b)?

The applicant has not adequately addressed that there are sufficient environmental planning grounds to justify contravening the development standard.

Further creeping of the envelope under this current application is considered to be unacceptable resulting in unreasonable impacts on the amenity of neighbouring properties. The variation of the development standard is not in the public interest and the variation is inconsistent with the desired future character of the locality.

Is the development in the public interest?

The proposed development will not be in the public interest because it is not consistent with both the objectives of the particular development standard and the objectives for development within the zone in which the development is proposed to be carried out.

The relevant objectives of the FSR development standard are as follows:

- (b) to provide an appropriate correlation between maximum building heights and density controls,
- (c) to ensure that buildings are compatible with the bulk and scale of the desired future character of the locality,
- (d) to establish limitations on the overall scale of development to preserve the environmental amenity of neighbouring properties and the locality.

The objectives of the R3 Medium Density Residential zone are as follows:

- To provide for the housing needs of the community within a medium density residential environment.
- To provide a variety of housing types within a medium density residential environment.
- To enable other land uses that provide facilities or services to meet the day to day needs of residents.
- To maximise public transport patronage and encourage walking and cycling.

The departure of the proposal from the relevant planning provisions serves to demonstrate the failure of the development to meet the objectives of the development standard, particularly objectives (c) and (d) representing an overdevelopment of the site. The submitted Clause 4.6 written request is not well

founded as it does not demonstrate the outcomes required by Clause 4.6(3) and (4) of the Waverley LEP 2012.

Whilst it is acknowledged that the proposed development does provide for the housing needs of the community within a medium density environment and would improve the internal amenity for the occupants of the unit, the exceedance of the development standard and the overall planning outcome for the site to achieve this objective as proposed is unacceptable and cannot be supported. There is no reason to vary the FSR development standard as the current building represents the bulk and scale desired by the Waverley LEP 2012 and varying the development standard is not in the public interest.

The proposed non-compliance has failed to address clause 4.6 (1)(b), (3)(a) and (b), and (4)(a). The non-compliance will result in an unacceptable outcome for the site, fails to demonstrate that compliance with the development standard is unreasonable or unnecessary, does not establish sufficient environmental planning grounds to justify the breach, fails to address the objectives of the FSR development standard and is not in the public interest.

Conclusion

For the reasons provided above the requested variation to the FSR development standard is not supported as the applicant's written request has not adequately addressed the matters required to be addressed by clause 4.6(3) of the Waverley LEP 2012. In addition, the proposed development is not in the public interest because it is inconsistent with the objectives of the FSR development standard and the R3 Medium Density Residential zone.

2.1.3. Waverley Development Control Plan 2012 (Waverley DCP 2012) – Amendment No.9

The relevant matters to be considered under the Waverley DCP 2012 for the proposed development are outlined below:

Table 2: Waverley DCP 2012 – Part B General Provisions Compliance Table

Development Control	Compliance	Comment
Ecologically Sustainable Development	Yes	Satisfactory
7. Accessibility and Adaptability	Yes	Satisfactory
12. Design Excellence	No	Unsatisfactory. The proposed development does not achieve design excellence as it does not appropriately consider the site context, amenity impacts and the relationship of the development to other development on neighbouring sites and the locality.

Table 3: Waverley DCP 2012 – Part C3 Other Residential Development Compliance Table

Development Control	Compliance	Comment
3.2 Height		
 Maximum external wall height: R3/12.5m – 9.5m 	No change	
		See further discussion below this table
 3.3.2- Side and rear setbacks Minimum side setback: 1.5-2.5m Minimum rear setback: 6m or predominant rear building line, whichever is the greater setback. The predominant rear setback is determined separately for each floor level. 	Yes No	See further discussion below this table
3.11 Private Open Space		
 3.11.2 – Balconies/decks Balcony additions to match the character of the building 	Yes	The proposed new rear south-west facing balcony will overlook neighbouring properties, however, there is a mutual degree of overlooking between properties at the rear.
Should not dominate the façadeNo wrap around	Yes Yes	
balconiesLocated to maximise solar access and privacy	Partial	
Balustrades to allow views and casual surveillance of the street and privacy	Yes	
3.13 Solar access and overshad	dowing	
 New development should maintain at least two hours of sunlight to solar collectors on adjoining properties in mid winter. Direct sunlight to north 	No No	See discussion below this table.
facing windows of habitable rooms and all private open space areas of adjacent dwellings to		

Development Control	Compliance	Comment
less than three hours of sunlight on 21 June.		
3.14 Views and view sharing		
Minimise view loss through design	Yes	
Views from public spaces to be maintained.	Yes	
3.15 Visual privacy and securit	у	
 Above ground open space must not overlook rooms and private landscaped areas of adjoining properties or be screened 	No	The proposed new rear facing balcony will overlook neighbouring properties, however, there is a mutual degree of overlooking between properties at the rear.
 Privacy be considered in relation to context density, separation use and design. 	Yes	
 Prevent overlooking of more than 50% of private open space of lower level dwellings in same development 	Yes	
3.16 Dwelling size and layout		
Max habitable room depth for single aspect dwelling is 8m from a window	Yes	
All habitable rooms to have a window	Yes	
Accessible and Adaptable	Yes	
3.17 Ceiling Heights		
Min 2.7m floor to ceiling height residential floors	No	The proposal extends the existing 2.4m ceiling height which is satisfactory.
3.19 Acoustic privacy		
 Internal amenity by locating noisy areas away from quiet areas 	Yes	
3.20 Natural Ventilation		
All dwellings to be naturally cross- ventilated	Yes	

Development Control	Compliance	Comment
Building to be orientated to maximise breezes	Yes	
Ceiling fans are to be provided in all habitable rooms.	No	

The following is a detailed discussion of the issues identified in the compliance tables above in relation to the Waverley DCP 2012.

Overshadowing

Part C3 3.13 *Solar Access and Overshadowing* outlines the objectives and controls relating to solar access. Objectives (c) and (d) seek to provide adequate solar access to open spaces and minimise impacts of development on surrounding properties. Control (b) requires that new development not reduce the amount of solar access of solar panels of any property to less than two hours per day in midwinter. Control (c) requires that direct sunlight to all private open space areas of adjacent dwellings is not reduced to less than 3 hours between 9am and 3pm on June 21.

The submitted shadow diagrams demonstrate that there is to be an increase in overshadowing to those properties located to the south-east, south and south-west of the subject site. Figures 6, 7 and 8 below show an increase in overshadowing to Nos.44-46 and 48-50 Curlewis Street between 9am and 12pm on 21 June. The shadow diagrams in plan show this shadow falling on the rear open space areas of these properties, which appears to be common open space. It is noted that the shadow diagram also demonstrates that there is shadow impact on the building at Nos.48-50 Curlewis Street, however, no elevational shadow diagrams have been provided for this building to understand the extent of this impact.

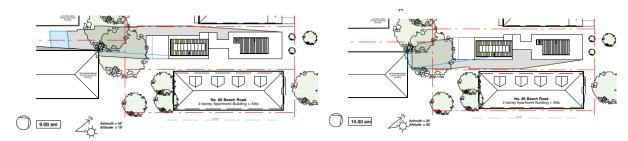


Figure 6: Shadow diagram for 9am 21 June

12.00 noon

| 12.00 m

Figure 9: Shadow diagram for 12pm 21 June

Figure 7: Shadow diagram for 10am 21 June

Figure 8: Shadow diagram for 11am 21 June

The submitted shadow diagrams also demonstrate an increase in shadow impacts to the neighbouring property to the south-west at No.86 Beach Road from 11am up until 2pm on June 21. **Figures 8-11** show the shadow falling on the rear open space area of this building and over the roof. Elevational shadows have been provided for this building which demonstrate that no habitable room windows are affected by the increase in shadow to No.86 Beach Road.

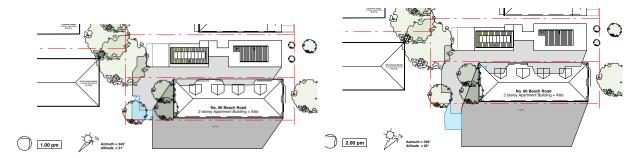


Figure 10: Shadow diagram for 1pm 21 June

Figure 11: Shadow diagram for 2pm 21 June

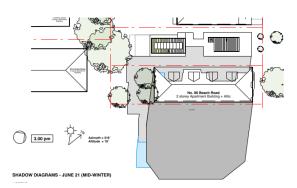


Figure 12: Shadow diagram for 3pm 21 June

The shadow diagrams indicate that overshadowing also extends beyond the boundary of No.86 Beach Road to the property at No.84 Beach Road from 1pm onwards. This shadow appears to also fall over the rear open space area of this property.

It should also be noted that when comparing the shadow diagrams submitted for DA-618/2014, which relates to the construction of the four-storey residential flat building, compared with the shadow diagrams submitted for the subject application, there appears to be inconsistences across the diagrams, particularly for shadows demonstrated at 9am. The shadow diagrams submitted for the subject application show that there would be no shadow impact to the adjoining property to the north-west at No.90 Beach Road from the building with the shadow impact stopping at the boundary. The submitted shadow diagram for 9am on 21 June as part of the original DA-618/2014 for the building indicates that the shadow extends beyond the property boundary and impacts on the property at No.90 Beach Road (refer to Figures 12 and 13 below).

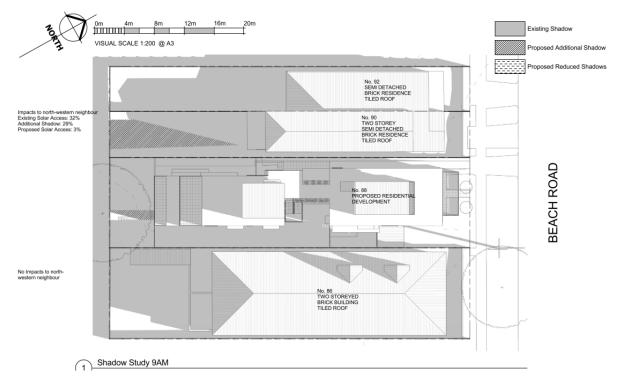


Figure 12: Submitted 9am shadow diagram for DA-618/2014 (Source: Raymond Panetta Architect dated 2/9/2014)

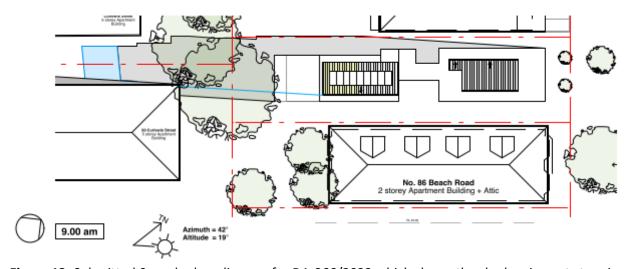


Figure 13: Submitted 9am shadow diagram for DA-366/2022 which shows the shadow impact stopping at the property boundary between Nos.88 and 90 Beach Rd, Bondi Beach (Source: Ken Powell Architect dated July 2022)

Notwithstanding these inadequacies in the documentation submitted, the shadow diagrams demonstrate that there will be shadow impacts as a result of the proposed development, with the amenity of those properties not 'preserved' contrary to the objectives of the height and FSR developments standards, which is not supported.

Building Envelope —Rear Building Line

The pattern of development in the immediate locality is a mix of two to four storey residential flat buildings, dwellings and semi -detached dwellings. The applicant's submission does not include a

context analysis of the rear building line of the adjoining and nearby properties. Control (a) of Part C3 3.3.2 *Side and Rear Setbacks* of the Waverley DCP 2012 requires proposed developments to have regards to the rear building line of nearby properties with the predominant rear setback determined for each floor level. Control (a) reads as follows:

(a) New buildings and extensions to existing buildings are to provide a minimum 6m rear setback, or extend no further to the rear than the predominant rear building line, whichever is the greater setback. The predominant rear setback is determined separately for each level.

From the rear south-western property boundary, the proposed fourth floor addition is to be setback 12.4m to the outer wall and 12.9m to the edge of the rear balcony. To the north-west of the subject site at No.90 Beach Road is a two storey semi-detached dwelling which is setback approximately 19.7m from its rear property boundary. To the south-east at No.86 Beach Road, the two storey plus attic building is setback 13.75m from its rear property boundary (see **Figure 14** below).



Figure 14: Context analysis of rear building line. Dotted line shows the extent of the rear building line proposed for the fourth floor level noting the adjoining properties are two storey in height only

The applicant argues in their submission that the minimum rear setback of the existing building is retained, however, does not assess the application against control (a) of Part C3 3.3.2 *Side and Rear Setbacks* of the Waverley DCP 2012. The proposed four storey building envelope is to be located closer to the rear boundary than the two, two storey properties either side, which is unacceptable particularly given the FSR and height exceedance proposed. The non-compliance with the rear building line of the Waverley DCP 2012 results in unreasonable amenity impacts to neighbouring properties, particularly in regards to overshadowing and visual bulk and scale which is not supported.

2.2. Other Impacts of the Development

The proposal is considered to have a significant detrimental effect relating to environmental, social or economic impacts on the locality, and is recommended for refusal.

2.3. Suitability of the Site for the Development

The site is not considered suitable for the proposal.

2.4. Any Submissions

The application was notified for 14 days in accordance with the *Waverley Community Development Participation and Consultation Plan*.

A total of three unique submissions were received from the following properties:

Table 4: Number of and where submissions were received from.

Count	Property Address
1.	4/84 Beach Road, Bondi Beach
2.	86 Beach Road, Bondi Beach
3.	3/88 Beach Road Bondi Beach

The following issues raised in the submissions have already been discussed and addressed in the body of this report and/or the Recommendation:

- Overshadowing
- Visual bulk and scale
- Not in the public interest
- Uncharacteristic of the streetscape and locality

All other issues raised in the submissions are summarised and discussed below.

Issue: View impacts from 86 Beach Road.

Response: The building at 86 Beach Road is located to the south-east of the subject site. North-westerly and western views over the subject site are already obstructed by the existing building. The proposed addition will result in the loss of some district and tree views; however, this does not provide a reason for refusal of the application.

Issue: Construction Impacts

Response: Should the application be approved, standard conditions would be recommended regarding construction matters.

2.5. Public Interest

The proposal is considered to have a detrimental effect on the public interest and is recommended for refusal.

REFERRALS

The following internal referral comments were sought:

3.1. Fire Safety Officer

The application was referred to Council's Fire Safety officer who raised no objection subject to conditions.

4. CONCLUSION

The development application seeks consent for alterations and additions at the site known as Unit 6/88 Beach Road, Bondi Beach.

The principal issues arising from the assessment of the application are as follows:

- Non-compliant FSR
- Non-compliant height
- Overshadowing
- Visual bulk and scale
- Rear building line

The assessment finds these issues acceptable.

A total number of three submissions were received and the issues raised in the submissions have been considered and addressed in this report and in the Recommendation.

The application has been assessed against the relevant matters for consideration under section 4.15(1) of the Act. It is recommended for refusal.

5. RECOMMENDATION TO WAVERLEY LOCAL PLANNING PANEL

That the development application be **REFUSED** by the Waverley Local Planning Panel for the reasons contained in Appendix A.

Report prepared by:	Application reviewed and agreed by:
JZancanaw	
Jo Zancanaro	Bridget McNamara
Senior Development Assessment Planner	Manager, Development Assessment
Date: 3 February 2023	Date: 8 February 2023
5 14,400 6 1	·

Reason for WLPP referral:

1. Departure from any development standard in an EPI by more than 10%

APPENDIX A – REASONS FOR REFUSAL

Having regard to section 4.15 (1) of the *Environmental Planning and Assessment Act 1979 (the Act)* the development application (the application) is refused for the following reasons:

1. The application does not satisfy section 4.15 (1)(a)(i) of the Act as it contrary to the following provisions of *Waverley Local Environmental Plan* (LEP) 2012:

a. Clause 4.3 Height

The application exceeds the maximum allowable height of 12.5m and the applicant's written request under clause 4.6 of Waverley LEP 2012 has failed to adequately address the required matters under subclauses 4.6 (3)(a) and (b) of Waverley LEP 2012.

Details: The proposed development does not preserve the environmental amenity of neighbouring properties as required under clause 4.3 (1) (a) of Waverley LEP 2012.

b. Clause 4.4 Floor Space Ratio

The application exceeds the maximum allowable Floor Space Ratio (FSR) of 0.9:1 and the applicant's written request under clause 4.6 of Waverley LEP 2012 has failed to adequately address the required matters under subclauses 4.6 (3)(a) and (b) of Waverley LEP 2012.

Details: The proposed development does not preserve the environmental amenity of neighbouring properties and the surrounding locality as required under clause 4.4 (1) (d) of Waverley LEP 2012.

2. The application does not satisfy section 4.15 (1)(a)(iii) of the Act as it is contrary to Waverley Development Control Plan (WDCP) 2012, in respect to the following provisions:

Part B12 – Design Excellence


a. 12.1 Design, specifically objectives (a) and (d) controls (a) and (e), and 12.2 Context Analysis, specifically objectives (a), (b), (c) and (d) as the proposal has failed to consider the suitability of the land for development, the relationship of the development to other development (existing or proposed) on the same site or on neighbouring sites in terms of amenity and urban form, the overall bulk and massing of the development and environmental impacts such as overshadowing. The development does not demonstrate an understanding of an appropriate response to the specific conditions of the site nor ensure that the opportunities and constraints of a site are fully considered and incorporated into the design proposal.

Part C3 – Other Residential Development

- b. Section 3.13 *Solar Access and Overshadowing*, specifically objective (d) and control (c) as the proposed development results in unreasonable overshadowing to the neighbouring properties.
- 3. The application does not satisfy section 4.15 (1)(b) of the Act as the proposed development is excessive in terms of its building massing, bulk and scale relative to the site area and dimensions, and consequently results in unacceptable amenity impacts upon the locality and surrounding built environment.
- 4. The application is contrary to section 4.15 (1)(c) of the Act due to the site being unsuitable to accommodate the proposed development.
- 5. The application is contrary to section 4.15 (1)(d) of the Act in relation to matters raised in the public submissions received that object to the proposed development.
- 6. The application is contrary to section 4.15 (1)(e) of the Act in relation to the public interest as it is not compatible with the existing and desired future character of the locality and the broader Waverley local government area.

Application No: DA-366/2022

Date Received: 31/08/2022

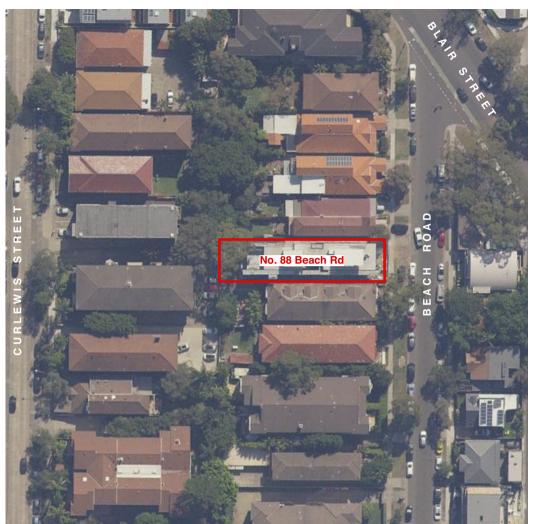

ALTERATIONS + ADDITIONS

UNIT 6, 88 BEACH ROAD, **BONDI BEACH**

DEVELOPMENT APPLICATION

DWG LIST:

Dwg No.	Title
D.4.400	0 5 5 60000
DA.100	Cover Page + BASIX Notes
DA.101	Site Plan + Site Analysis
DA.102	Existing Plans - Ground Floor + Level 1
DA.103	Existing Plans - Level 2 + Level 3
DA.104	Existing Plan - Roof
DA.105	Existing Elevations
DA.106	New Plans - Level 2 + Level 3
DA.107	New Plan - Roof
DA.108	Sections AA + BB
DA.109	New Elevations
DA.110	GFA Calculations
DA.111	Shadow Diagrams June 21 - 9:00am, 10:00am + 11:00am
DA.112	Shadow Diagrams June 21 - 12:00pm + 1:00pm
DA.113	Shadow Diagrams June 21 - 2:00pm + 3:00pm

NOTES

Sewer

General Confirm all dimensions & setout on site before

commencing work

All work to be completed in accordance with all statutory requirements and the requirements of the

Council and other relevant authorities

No change to existing

Stormwater Connect new downpipes to extg downpipes Concrete To be in accordance with Struct Eng details Structural Steel To be in accordance with Struct Eng details

Colorbond metal roof sheet in accordance with Clause F1.5 of NCC 2019 Vol 1 Alum framed windows in accordance with BASIX

Windows/doors

Glazing to be in accordance with Clause F1.13 of

NCC 2019 Vol 1

Lighting To be in acordance with BASIX Certificate

BASIX REQUIREMENTS

Minumum 40% of new or altered light fixtures are fitted with fluorescent, compact fluorescent of LED lamps to all rooms exept

External concrete panel wall: R1.39 (or R1.70 Including construction) Raked ceiling, skillion roof

Ceiling: R1.76 (up),

Roof: foil backed blanked (55mm)

Roof: Solar absorptance light < 0.475

To be installed in accordance with BASIX Certificate.



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Alterations + Additions to Unit 6, 88 Beach Rd

Bondi Beach SP95100

Coverpage + **BASIX Notes**

July 2022

2126 / **DA.100** Rev **A**



Application No: DA-366/2022



View 2



-92 Beach Road-2 storey dwelling 44 - 46 Curlewis Street Substantial trees on adjacent property providing privacy -90 Beach Road-5 storey Apartment Building 88 Beach Road 4 storey Apartment Building roposed addition at Attic Level at rear of building not visible from the street _**50 Curlewis Street** 5 storey Apartment Building - **86 Beach Road** 2 storey Apartment Building + Attic

23.08.22



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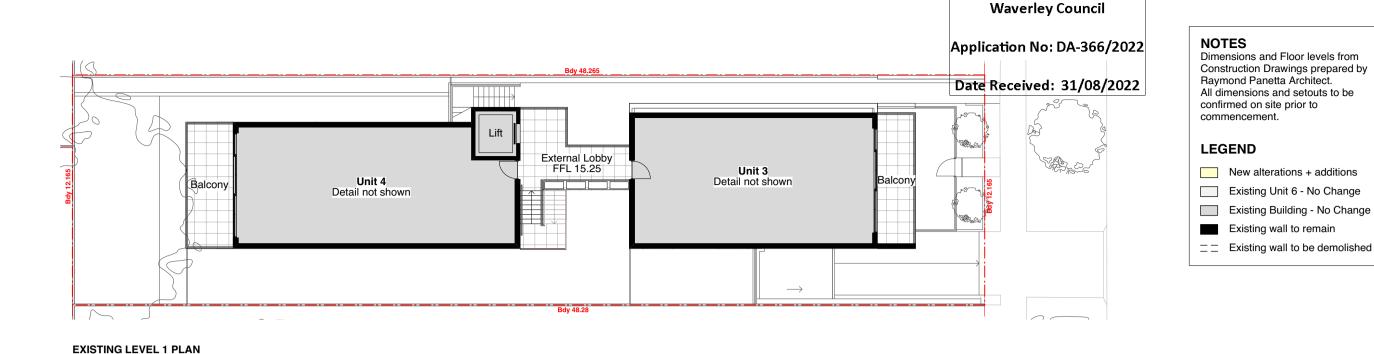
Bondi Beach SP95100


Site Plan + Site Dwg Title Analysis

1:400 (A3) July 2022

2126 / **DA.101** Rev **A**





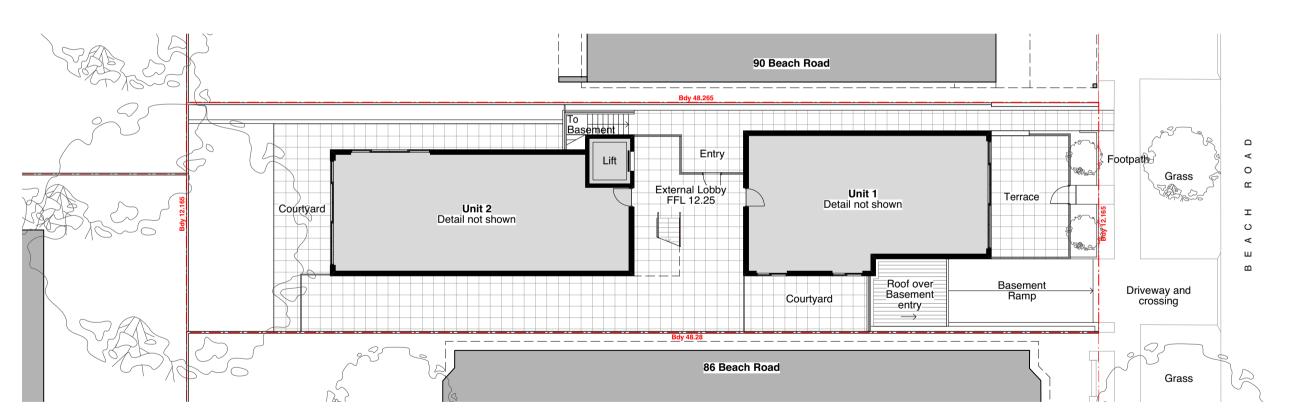

EXISTING GROUND FLOOR

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23.08.22

Existing Building - No Change

Alterations + Additions to Unit 6, 88 Beach Rd

Bondi Beach SP95100 **Existing Plans** Dwg Title

Ground Floor + Level 1 1:200 (A3)

July 2022

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2126 / **DA.102** Rev **A**



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Waverley Council
Application No: DA-366/2022

Bdy 48.265

Solve COS Lift Overrun 1335 high

Ac ducting

Conc Roof over Lobby

Bed 1

Extg Tim

Unit 6 (Upper)

Unit 5 - Upper


Detail not shown

Balcony

H/level window

Conc Roof

EXISTING LEVEL 3 PLAN

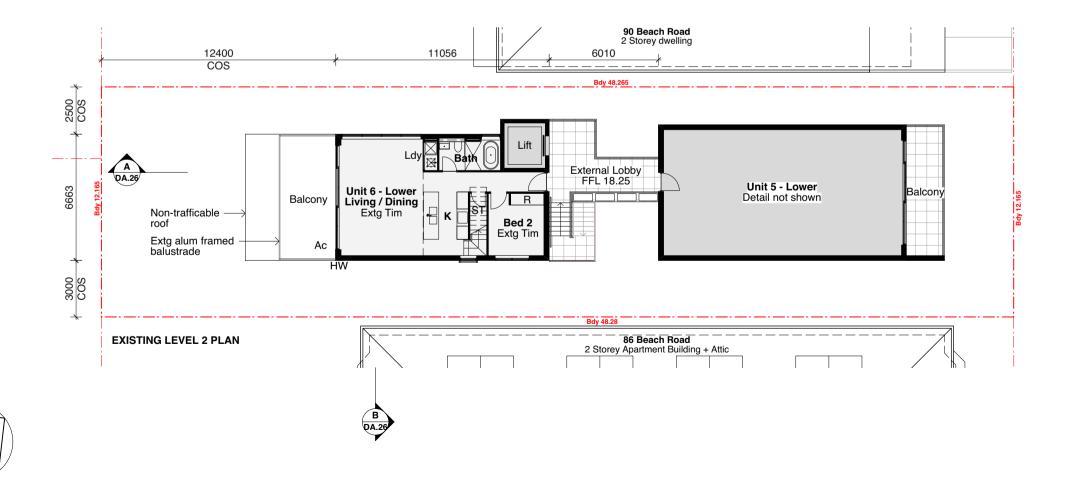

NOTES

Dimensions and Floor levels from Construction Drawings prepared by Raymond Panetta Architect. All dimensions and setouts to be confirmed on site prior to commencement.

LEGEND

New alterations + additions

Existing Unit 6 - No Change

Existing Building - No Change

Existing wall to remain

 \equiv \equiv Existing wall to be demolished

Development Application



23.08.22

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Project Alterations + Additions to Unit 6, 88 Beach Rd

Bondi Beach SP95100

Dwg Title Existing Plans Level 2 + Level 3

Scale 1:200 (A3)


Date July 2022

g No 2126 / **DA.103** Rev **A**



Application No: DA-366/2022

Date Received: 31/08/2022

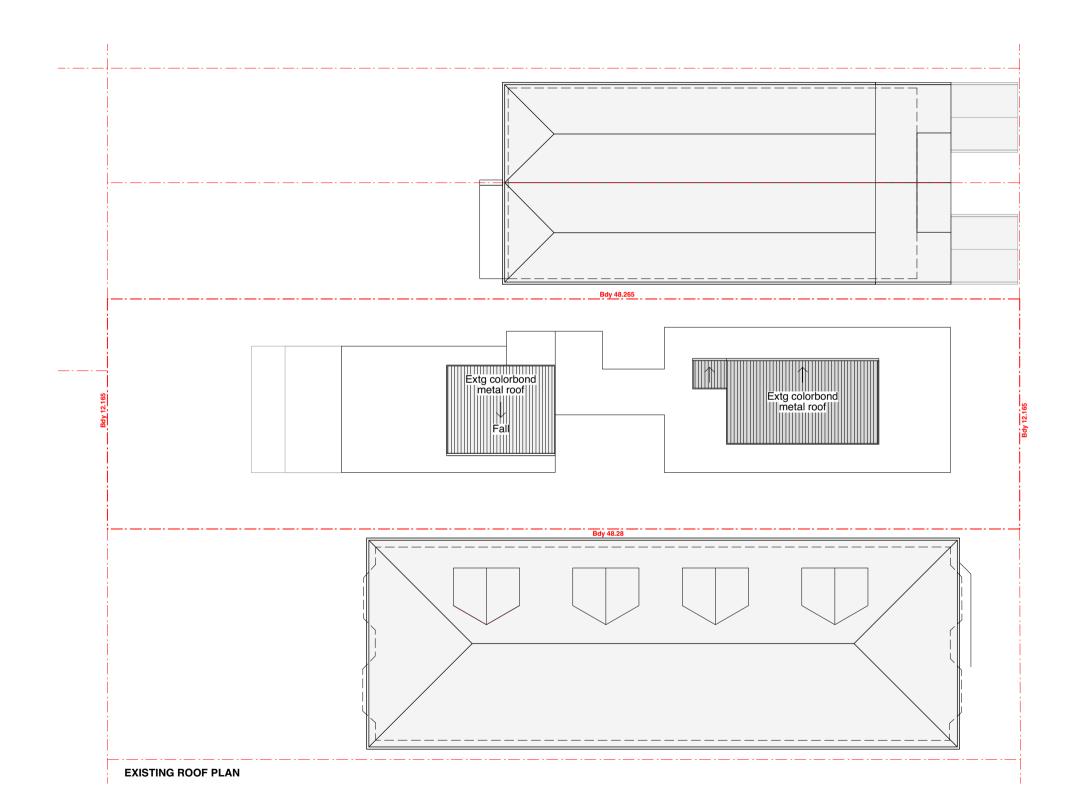



NOTES

Dimensions and Floor levels from Construction Drawings prepared by Raymond Panetta Architect. All dimensions and setouts to be confirmed on site prior to commencement.

LEGEND

New alterations + additions Existing Unit 6 - No Change

Existing Building - No Change

Existing wall to remain

23.08.22



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Alterations + Additions to Unit 6, 88 Beach Rd


Bondi Beach


SP95100 **Existing Plans** Dwg Title


Roof 1:200 (A3)

July 2022

Dwg No 2126 / **DA.104** Rev **A**

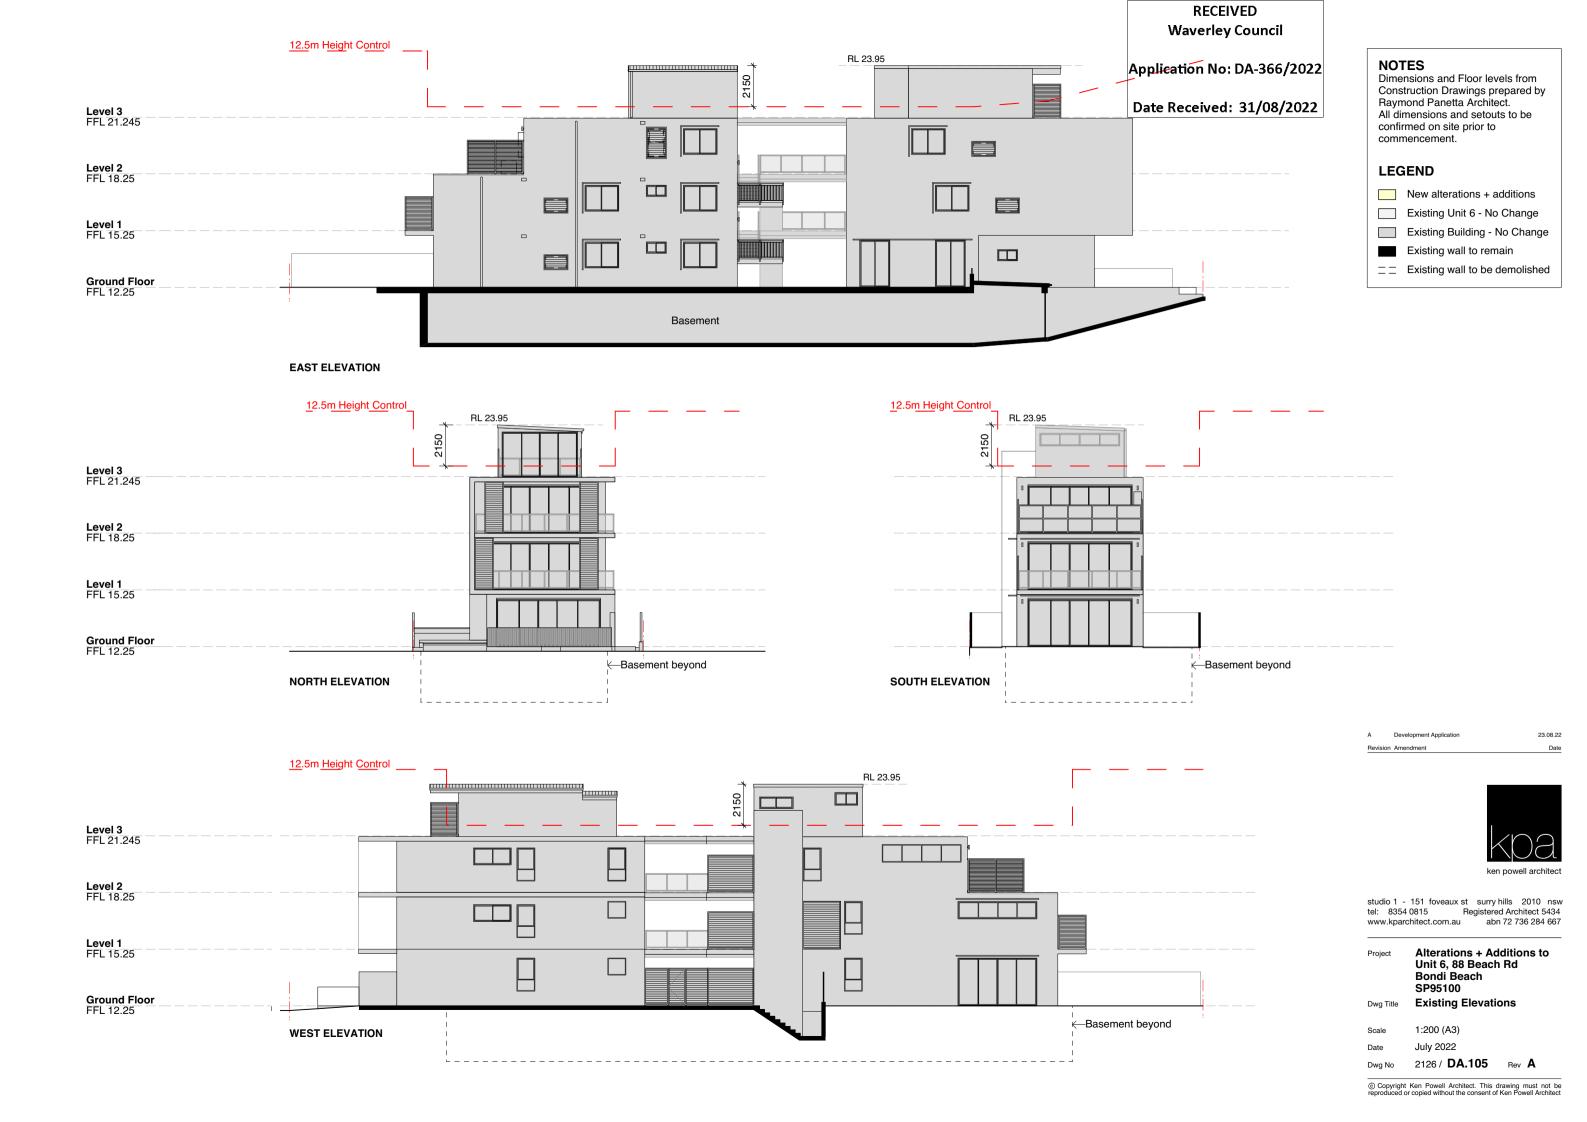

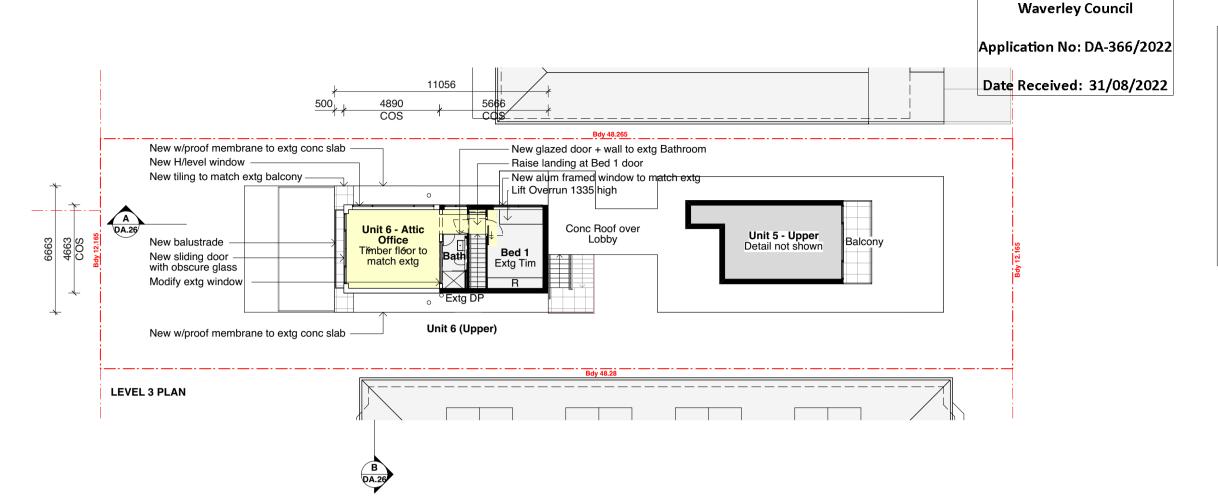

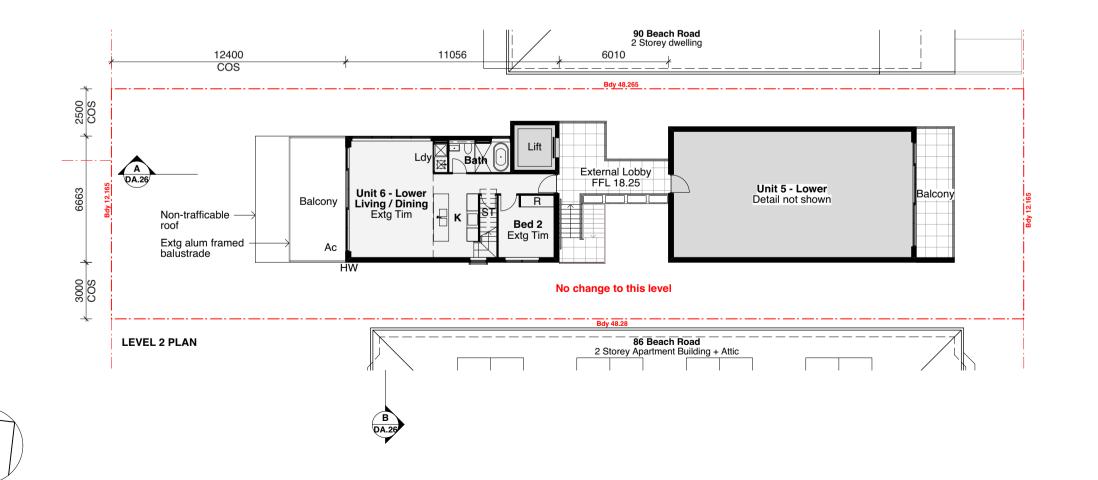

NOTES

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Dimensions and Floor levels from Construction Drawings prepared by Raymond Panetta Architect. All dimensions and setouts to be confirmed on site prior to commencement.

LEGEND

New alterations + additions

Existing Unit 6 - No Change

Existing Building - No Change

Existing wall to remain

 \equiv \equiv Existing wall to be demolished

Development Application

kpa

23.08.22

 studio 1 - 151 foveaux st
 surry hills
 2010 nsw

 tel:
 8354 0815
 Registered Architect 5434

 www.kparchitect.com.au
 abn 72 736 284 667

Project Alterations + Additions to Unit 6, 88 Beach Rd

Bondi Beach SP95100

Dwg Title New Plans
Level 2 + Level 3


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Date July 2022

Dwg No 2126 / **DA.106** Rev **A**



Application No: DA-366/2022

Date Received: 31/08/2022

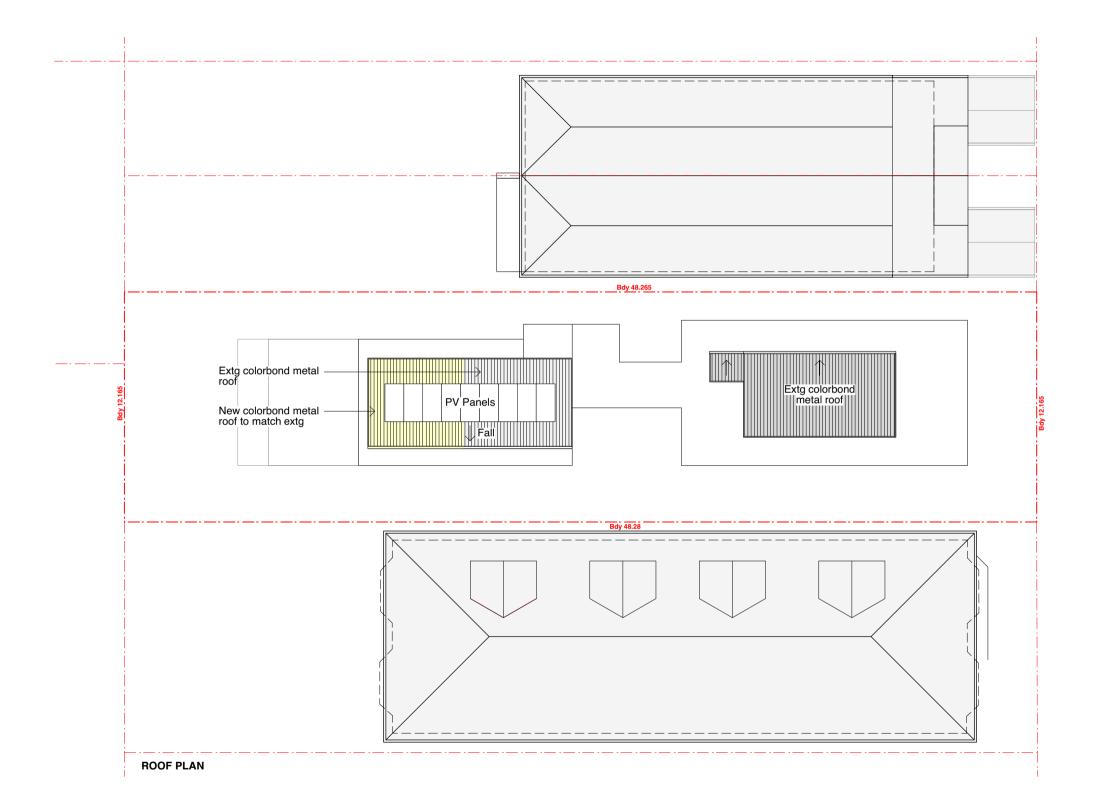



Dimensions and Floor levels from Construction Drawings prepared by Raymond Panetta Architect. All dimensions and setouts to be confirmed on site prior to commencement.

LEGEND

New alterations + additions

Existing Unit 6 - No Change

Existing Building - No Change

Existing wall to remain

23.08.22



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Alterations + Additions to Unit 6, 88 Beach Rd

Bondi Beach SP95100

New Plans

Dwg Title Roof


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Dwg No 2126 / **DA.107** Rev **A**




Application No: DA-366/2022

Date Received: 31/08/2022

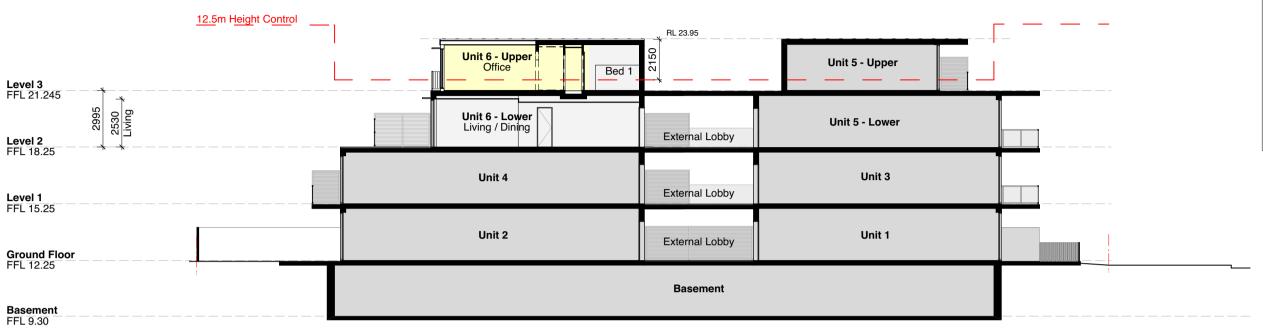

SECTION AA

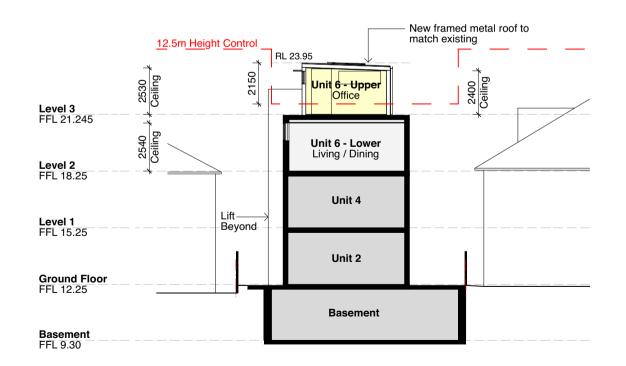

SECTION BB

NOTES

Dimensions and Floor levels from Construction Drawings prepared by Raymond Panetta Architect. All dimensions and setouts to be confirmed on site prior to commencement.

LEGEND

New alterations + additions

Existing Unit 6 - No Change Existing Building - No Change

Existing wall to remain

Development Application

23.08.22



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Alterations + Additions to Unit 6, 88 Beach Rd Bondi Beach


SP95100 Sections


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Scale July 2022

Dwg Title

2126 / **DA.108**




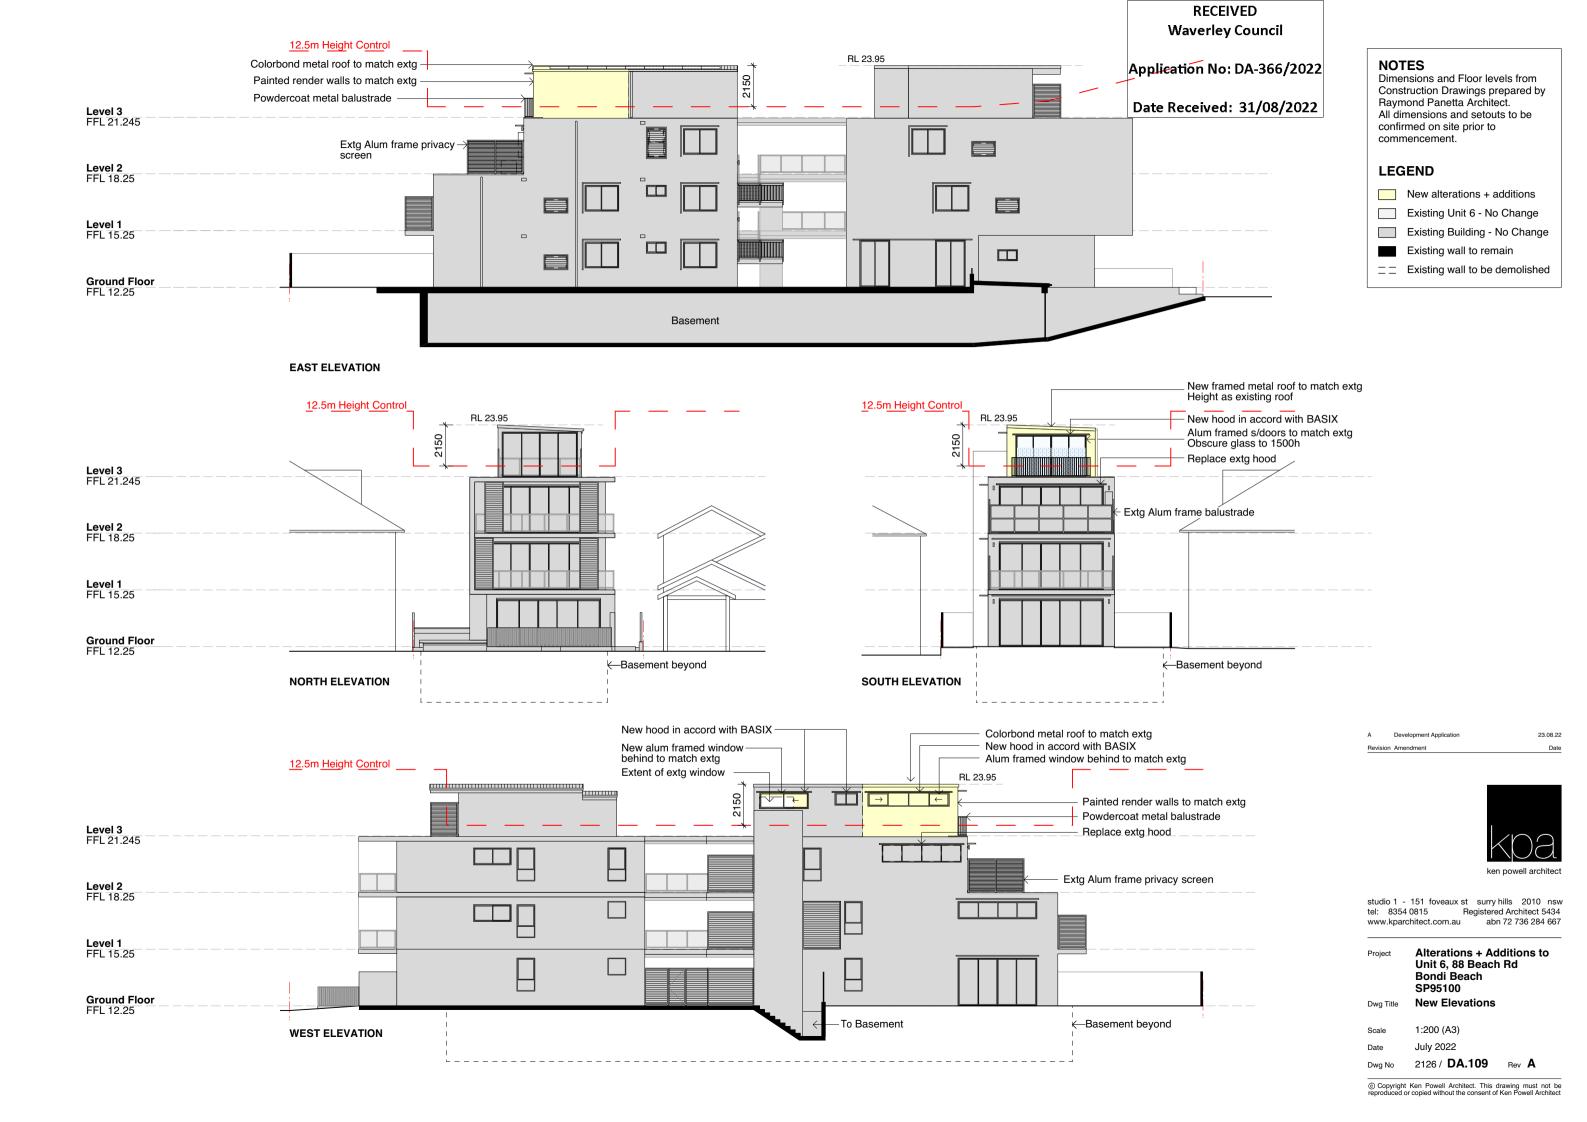

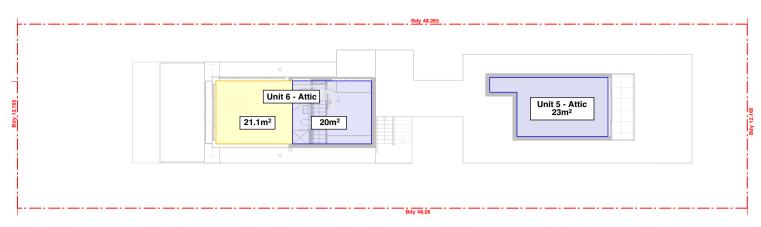
LEVEL 3



LEVEL 2

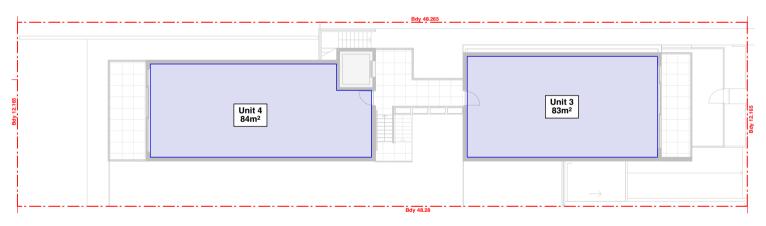

LEVEL 1

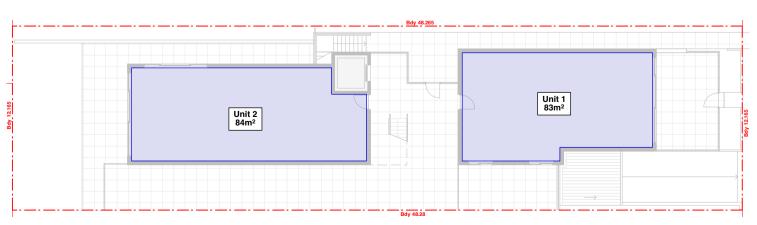

GROUND FLOOR

RECEIVED **Waverley Council**

Application No: DA-366/2022

GFA CALCULATIONS

Date Received: 31/08/2022

Note: Areas from approved DA drawings prepared by

Raymond Panetta Architect.

Site Area 587.15m²

GFA Calculation

Existing Proposed

No Change

64.1m²

541.1m²

0.92:1

(See Note 1)

167m²

Level 1 167m² Level 2 143m² 43m²

Level 3

Ground Floor

FSR

520m² 0.886:1

(Permissible 0.9:1)

23.08.22



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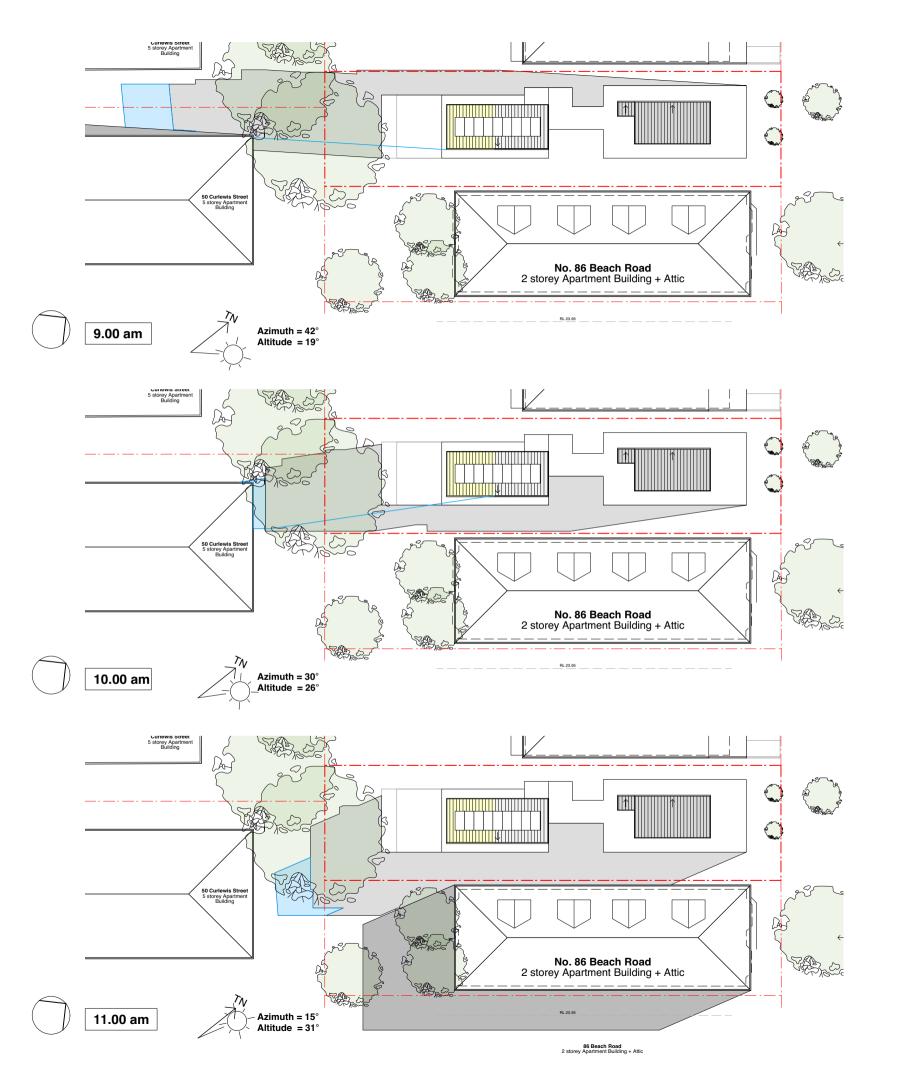
Alterations + Additions to Unit 6, 88 Beach Rd

Bondi Beach SP95100

GFA Calculations

1:250 (A3) July 2022

2126 / **DA.110** Rev **A**




SHADOW DIAGRAMS - JUNE 21 (MID-WINTER)

Additional shadows cast by proposed addition

Application No: DA-ვგ6/2022


Date Received: 31/08/2022 shadows cast by existing building

Existing shadows cast by existing neighbours

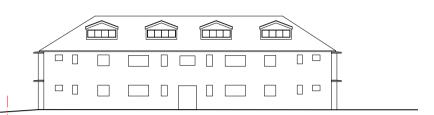

No shadow cast onto No. 86 at 9:00am


NORTH WEST ELEVATION OF No. 86 SHOWING SHADOW CAST BY No. 88

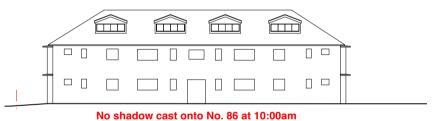

NORTH WEST ELEVATION OF No. 86 SHOWING SHADOW CAST BY No. 88

Development Application 23.08.22 vision Amendment Date



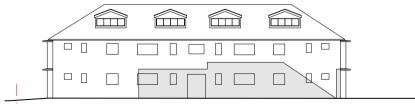

NORTH WEST ELEVATION OF No. 86 SHOWING SHADOW CAST BY No. 88

studio 1 - 151 foveaux st surry hills 2010 nsw tel: 8354 0815 Registered Architect 5434 www.kparchitect.com.au abn 72 736 284 667

Project Alterations + Additions to Unit 6, 88 Beach Rd

Bondi Beach SP95100


Dwg Title Shadow Diagrams June 21


Scale 1:400 (A3)
Date July 2022

Dwg No 2126 / **DA.111** Rev **A**


Application No: DA-366/2022


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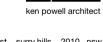
NORTH WEST ELEVATION OF No. 86 SHOWING SHADOW CAST BY No. 88

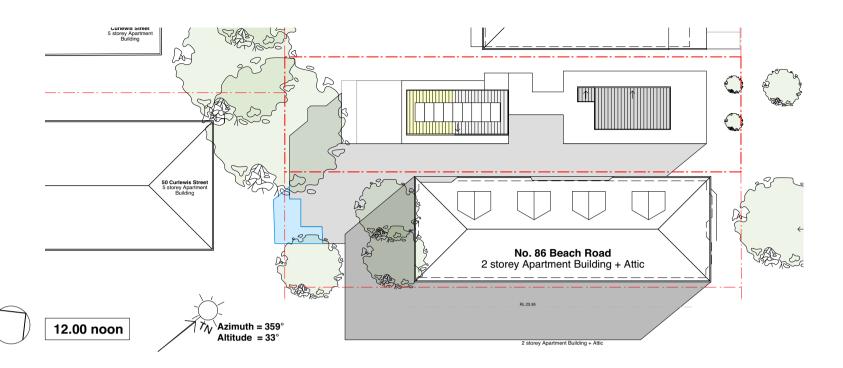

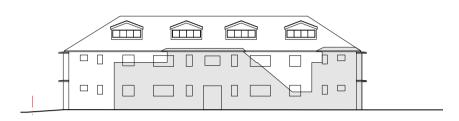

NORTH WEST ELEVATION OF No. 86 SHOWING SHADOW CAST BY No. 88

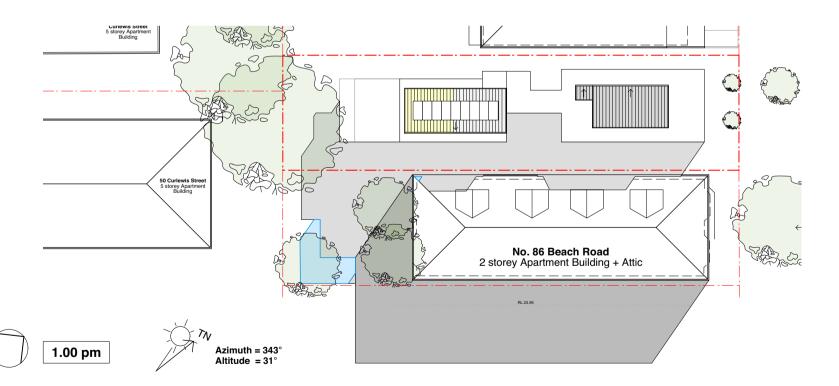23.08.22

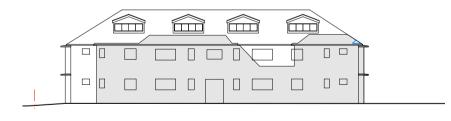

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Alterations + Additions to Unit 6, 88 Beach Rd

Bondi Beach SP95100

Shadow Diagrams Dwg Title June 21

1:400 (A3) July 2022

2126 / **DA.112** Rev **A**


SHADOW DIAGRAMS - JUNE 21 (MID-WINTER)

LEGEND

Existing shadows cast by existing building


Existing shadows cast by existing neighbours

Additional shadows cast by proposed addition

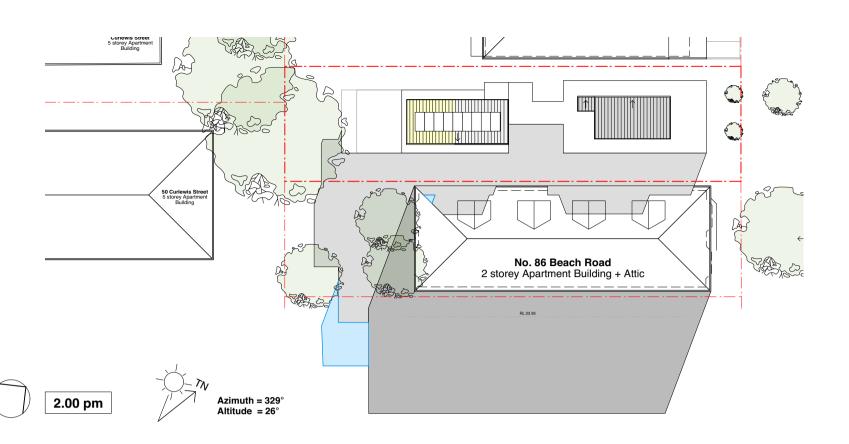



Application No: DA-366/2022

Date Received: 31/08/2022

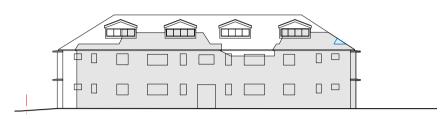

NORTH WEST ELEVATION OF No. 86 SHOWING SHADOW CAST BY No. 88

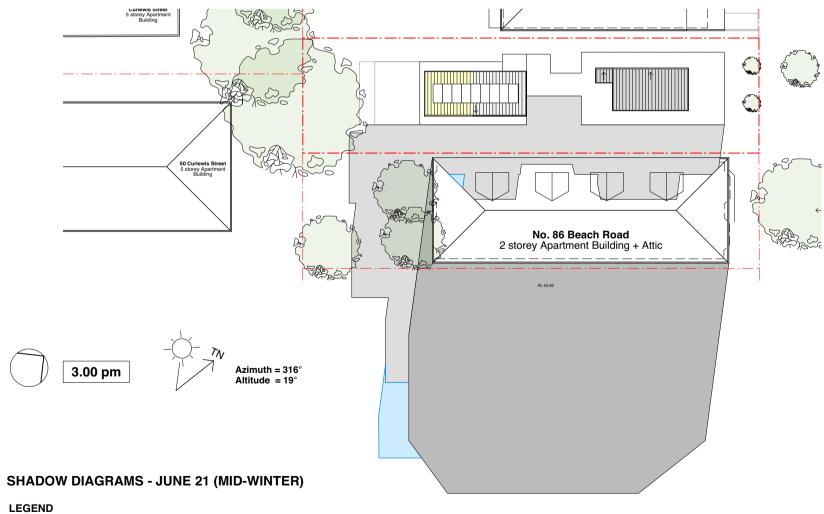

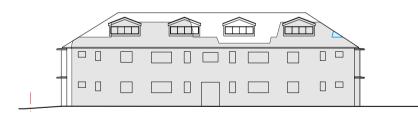

NORTH WEST ELEVATION OF No. 86 SHOWING SHADOW CAST BY No. 88

ken powell architect

23.08.22

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Project Alterations + Additions to Unit 6, 88 Beach Rd

Bondi Beach SP95100

Dwg Title Shadow Diagrams

June 21Scale 1:400 (A3)

Date July 2022

Dwg No 2126 / **DA.113** Rev **A**

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Existing shadows cast by existing building
Existing shadows cast by existing neighbours
Additional shadows cast by proposed addition





Report to the Waverley Local Planning Panel

Application number	DA-462/2021/A	
Site address	12 Princess Street, Rose Bay	
Proposal	Modifications to approved dual occupancy, including extension of basement, ground and first floor levels.	
Description of Approved Development	Demolition of existing structures; and construction of a new attached dual occupancy development with basement parking and two swimming pools at rear.	
Date of lodgement	21 July 2022	
Owner	Mr R & Mrs K R Rosettenstein and Mr J D& Mrs T M Wiseman	
Applicant	Common Office	
Submissions	Five submissions	
Amended cost of works	Applicant states 'no change'.	
Principal Issues	 Breach of the FSR development standard Impacts on amenity Overshadowing Loss of canopy trees 	
Recommendation	That the application be REFUSED for the reasons contained in the report.	

SITE MAP



1. PREAMBLE

1.1. Executive Summary

The modification application seeks to modify development consent DA-462/2021 for demolition of existing structures; and construction of a new attached dual occupancy development with basement parking and two swimming pools at rear at the site known as 12 Princess Street, Rose Bay. In summary, the proposed modifications are for the extension of the basement, ground and first floor levels, relocation of the swimming pools, tree removal and associated landscaping amendment.

The principal issues arising from the assessment of the application are as follows:

- Breach of the FSR development standard
- Impacts on amenity
- Overshadowing
- Loss of canopy trees

The assessment finds these issues unacceptable due to impacts on the amenity of the neighbouring properties.

A total number of five submissions were received and the issues raised in the submissions have been considered and addressed in this report. No Councillor submission were received.

The application has been assessed against the relevant matters for consideration under section 4.55(2) the *Environmental Planning and Assessment Act 1979* and is recommended for refusal.

1.2. Site and Surrounding Locality

A site visit was carried out on 21 December 2022.

The site is identified as Lot 12 Section B in DP 4185 known as 12A Princess Street, Rose Bay.

The site is rectangular in shape with a southern frontage of 12.192m to Princess Street. It has an area of 581.8m² and falls from the rear towards the front by approximately 4.7m.

The site is occupied by a single storey dwelling house with vehicular access provided from Princess Street.

The site is adjoined by a two storey dwelling house to the east at 14 Princess Street, and two storey detached dual occupancy dwellings to the west at 10 and 10A Princess Street, and to the north at 7 Northcote Street. The locality is characterised by a variety of low and medium density residential development.

Figures 1 to **4** are photos of the site and its context.



Figure 1: Front of the subject site as viewed from Princess Street, looking north.



Figure 2: View of neighbouring property No. 14 facing south-east.



Figure 3: Rear of the subject site facing north.



Figure 4: Rear of the subject site facing south-east.

1.3. Details of Approved Development

The original development application, known as DA-462/2021 for demolition of existing structures; and construction of a new attached dual occupancy development with basement parking and two swimming pools at rear was approved on 27 April 2027 by the Waverley Local Planning Panel (WLPP).

The following conditions from the development consent have direct relevance to this modification application.

3. DOMESTIC HEATERS

The provision of solid fuel heating is prohibited.

35. TREES PERMITTED TO BE REMOVED, RETAINED AND PROTECTED

The following trees are permitted to be removed, retained and protected as per the tables in this development consent. The trees identifications in these tables are the same as those in the Arborist Report referred to in condition 1(c) of this development consent.

Tree No.	Species	Location	Action
T 1	Cinnamomum camphora (Camphor Laurel)	On-site	Remove as per Arborist report
T 2	Cinnamomum camphora (Camphor Laurel)	On-site	Remove as per Arborist report.
Т3	Callistemon viminalis	On-site	Retain as per Arborist report.
	(Weeping Bottlebrush)		
T 4	Pinus radiata	On-site	Remove as per Arborist report.
	(Radiata Pine)		
T 5	Cotoneaster glaucophyllus	On-site	Remove as per Arborist report.
	(Large Leaf Cotoneaster)		
Α	Melaleuca quinquinervea	Street tree	Trees to be Retain and protected. (refer to
	(Broadleaved Paperbark)		condition 36 below for more details)
В	Podocarpus elatus	Neighbouring	Trees to be Retain and protected.
	(Brown Pine)	tree.	
С	Magnolia grandiflora	Neighbouring	Trees to be Retain and protected.
	(Bull Bay Magnolia)	tree.	
D	X Cupressocyparis	Neighbouring	Trees to be Retain and protected.
	leylandii	tree.	
	(Leyland Cypress)		
Ε	Eucalyptus robusta	Neighbouring	Trees to be Retain and protected.
	(Swamp Mahogany)	tree.	

1.4. Proposal

The modification application has been submitted under section 4.55 (2) of the *Environmental Planning* and Assessment Act 1979 seeking consent for the following modifications to the approved development:

Basement

• A 15.8m² extension to the basement of the eastern dwelling.

Ground Floor

- Reconfiguration of the internal layout of the kitchen within each dwelling.
- A 2.22m extension to the northern internal courtyard void.
- A 3m extension to the rear to facilitate larger living rooms within each dwelling.
- Relocating the rear terrace and awning to the north.
- Changes to openings.

First Floor

- Southern extension of bedroom 3 within each dwelling.
- Reconfiguration of the internal layout resulting in larger bathrooms and an additional bedroom to replace the study.
- A 3.93m extension to the northern void.
- A 3.135m northern extension comprising master bedrooms.

- Extension towards the eastern and western boundaries to increase the size of the bedroom and master bedrooms ensuites to provide a separate shower and toilet area within each dwelling.
- Changes to openings.
- Associated extensions to the roof.

External

- Relocating swimming pools and associated paving to the rear boundary.
- Removal of Tree 3 (Weeping Bottlebrush).
- Associated amendments to landscaping.
- Deletion of the rear swimming pool decks.
- Deletion of the four palm trees originally proposed at the rear of the site.

1.5. Background

The following background is relevant to the proposal:

- On 25 October 2021, Development Application DA-462/2021 for demolition of existing structures, and construction of a new attached dual occupancy development with basement parking and two swimming pools at the rear was lodged with Council. The proposal sought a breach of the FSR development standard which was not supported as the proposal did not demonstrate that the amenity of the neighbouring properties would be preserved. Amended plans which demonstrate compliance with the FSR development standard were requested.
- On 27 April 2022, Development Application DA-462/2022 was granted consent by WLPP. The approved development demonstrated compliance with the FSR development standard.
- On 21 July 2022, the subject Modification Application DA-462/2022/A was lodged with Council.
- On 27 July 2022, a Stop the Clock letter was issued to the applicant requesting additional information to address concerns raised in relation to solar access and insufficient plan details and documentation.
- 15 August 2022, the applicant submitted amended plans.
- On 16 August 2022, further amended plans were requested as the items requested were not adequately addressed.
- On 30 August 2022, the applicant submitted amended plans. The amended plans form the basis for the assessment.

2. ASSESSMENT

The following matters are to be considered in the assessment of this modification application under relevant sections of the *Environmental Planning and Assessment Act 1979* (the Act).

2.1. Section 4.55 – Modification of consents – generally

The application is made under section 4.55(2) of the Act.

The quantitative and qualitative elements and impacts between the approved development and the development, as proposed to be modified, are not considered overly dissimilar as demonstrated in the following sections of this report. In this regard, the proposal is considered to be *substantially the same* as the originally approved development with regard to matters arising from the NSW Land and Environment Court case of *Moto Projects (No 2) Pty Ltd v North Sydney Council (1999) 106 LGERA 298*.

The application was publicly notified between 8 and 22 September and five submissions were received. The issues and matters raised in public submissions are discussed in section 2.2.4 of this report.

2.2. Evaluation of Matters for Consideration under Section 4.15

In accordance with section 4.55(3) of the Act the following is an assessment of the proposed modifications of the development consent against the relevant matters for consideration under section 4.15(1) of the Act.

2.2.1. Planning Instruments and Development Control Plans

The following is an assessment against relevant environmental planning instruments, including State environmental planning policies (SEPPs), and development control plans.

State Environmental Planning Policies (SEPPs)

The following SEPPs apply from the 1st March 2022 and have been considered acceptable in the assessment of this development application:

- SEPP (Building Sustainability Index BASIX) 2004
- SEPP (Biodiversity and Conservation) 2021 (Vegetation in Non rural areas)
- SEPP (Resilience and Hazards) 2021 (Coastal Management and Site contamination)

Waverley Local Environmental Plan 2012 (Waverley LEP 2012)

Clause 1.2 Aims of Plan

The proposal would not satisfy the following aims of WLEP 2012:

- (f) to enhance and preserve the natural environment through appropriate planning, protecting the integrity of natural systems and by protecting existing trees.
- (m) to enhance the amenity and quality of life of local communities, including through the provision of adequate social infrastructure, services and public art.

The proposal would not enhance or preserve the natural environment and would not enhance residential amenity.

R2 Low Density Residential Zone

The land use definition of the approved development as a *dual occupancy* remains unchanged and continues to be permitted development in the R2 Low Density Residential zone under Waverley LEP 2012.

Principal Development Standards

The quantities of the approved development, as proposed to be modified, have changed as outlined in **Table 1** below in relation to principal development standards under Waverley LEP 2012.

Table 1: Waverley LEP 2012 Compliance Table

Provision	Approved	Proposed Modified	Compliance
4.3 Height of buildings8.5m	8.23m	8.23m	Yes
 4.4 Floor space ratio and 4.4A Exceptions to floor space ratio 0.5:1 / 290.9m² 	0.5:1 / 290m²	0.593:1 / 345.5m ²	No

Floor Space Ratio (FSR)

The proposed modifications result in a net increase of gross floor area (GFA) of 55.5m², resulting in an overall FSR of 0.593:1. This culminates to an overall exceedance of the FSR development standard by 54.6m² or 18.76%. The net increase of FSR due to the proposed modifications represents 98.35% of the overall exceedance of the standard.

The applicant has provided some written justification for the non-compliance with the FSR development standard and has based the justification on the performance of the proposal against the objectives of the development standard. The relevant objectives of the development standard are as follows:

- (b) to provide an appropriate correlation between maximum building heights and density controls,
- (c) to ensure that buildings are compatible with the bulk and scale of the desired future character of the locality,
- (d) to establish limitations on the overall scale of development to preserve the environmental amenity of neighbouring properties and the locality.

The justification provided by the applicant to support the increased exceedance of the FSR development standard is summarised as follows:

- Given the rear location, most of the numerical increase will not be visible from Princess Street.
 While there is a slight addition at the front on the upper floor, the recessed appearance is maintained.
- The approved building height is retained and continues to be complaint, with the front and side setbacks maintained as approved and compliant.

- The GFA addition at the rear is set back from the predominant building line, and deep soil and open space continue to be more than compliant.
- The additional floor area will improve internal amenity and will not readily contribute to bulk or scale when viewed from the street.
- The modification continues to meet the standard's objectives by preserving adjoining properties' amenity and not readily impacting the streetscape.
- It remains contextually compatible with the envelope of surrounding low density residential developments recently approved and constructed on the street.
- Environmental amenity comprises a number of elements including privacy, solar access and views. If there is a negligible impact in terms of one aspect (such as a minor impact on the solar access of one window of a neighbouring property or view from one vantage point), in our opinion, it does not mean that the amenity is not preserved for that dwelling. In this regard, it is our opinion that there is some elasticity in the term, 'preservation of amenity'.
- The modification has been carefully designed to preserve neighbour amenity. As indicated, the additional floor space will not contribute significantly to the building's perceived scale from the street.
- The FSR increase will also not have any unreasonable impact on privacy, solar access or views.

The assessment has found that the proposal would result in additional impacts on the neighbouring properties with regard to overshadowing of windows and private open space, and visual bulk and scale and therefore would not demonstrate that the amenity of the neighbouring properties would be preserved in accordance with objective (d).

An exceedance of the FSR development standard was not supported at the initial DA stage, due to impacts on the amenity of the neighbouring properties. The proposal now seeks to exceed the FSR development standard by approximately double what was initially proposed and therefore demonstrates an attempt for development creep and a disregard for the initial assessment and Panel determination.

Improving the internal amenity of a dwelling for private gain is not a reasonable justification for additional floor space, which additionally results in impacts on the amenity of neighbouring properties. The applicants focus on the lack of streetscape impact demonstrates that inadequate consideration has been given to the amenity impacts on the immediately adjacent properties at 14 and 10 Princess Street resulting from the additional floor space. The breach of the FSR development standard is not supported.

Waverley Development Control Plan 2012 (Waverley DCP 2012) – Amendment No.9

The application was lodged with Council prior to the implementation of Waverley Development Control Plan 2022 (WDCP 2022), and therefore WDCP 2012 applied.

An assessment against the parts of Waverley DCP 2012 that apply to the proposed development are provided below.

Table 2: Waverley DCP 2012 – Part B General Provisions Compliance Table

Development Control	Compliance	Comment
Landscaping and Biodiversity	No	Unsatisfactory. The proposal includes the removal of the only remaining existing tree (3m tall Weeping bottlebrush) located on the rear boundary, and the removal of the four palm trees originally proposed along the rear boundary, with no offset planting proposed. The proposal would not enhance the amenity and
		visual setting of the locality and would not contribute to or enhance the urban canopy and vegetation in accordance with objectives (a) and (b), or controls (b) and (c) under Section 3.1 of WDCP 2012.
5. Vegetation Preservation	No	The proposal would not increase the level of canopy cover or minimise the loss of vegetation in accordance with objective (d) under section 5.1 of Waverley DCP 2012.
8. Transport Maximum parking rate:	Yes	The proposal includes an extension of the basement below the eastern dwelling. The extension enables the development to facilitate parking of two vehicles in a tandem configuration.
2 spaces for 3 or more bedrooms.		The provision of two parking spaces for a four bedrooms dwelling is in keeping with Council's maximum parking rates and is not considered to be unreasonable.
12. Design Excellence	No	Unsatisfactory. Inadequate consideration has been given to the environmental and amenity impacts resulting from the proposal in regard to overshadowing and bulk and scale. The proposal does not demonstrate design excellence and does not satisfy controls (e)(iv), (v), and (vii) under section 12.1 of Waverley DCP 2012.
14. Excavation	No	Unsatisfactory. The proposal would result in a greater extent of excavation beyond that which was originally approved and accordingly has not been designed to minimise excavation in accordance with control (d) under Section B14 of Waverley DCP 2012.

Table 3: Waverley DCP 2012 – Part C2 Low Density Residential Development Compliance Table

Development Control	Compliance	Comment
2.0 General Objectives		
(a) To ensure that the scale of lower density residential accommodation is appropriate for allotment sizes and other dwellings in	No	The proposal would not satisfy the objectives of Part C of Waverley DCP 2012. The scale of the proposal would not be appropriate to the size of the allotment and would detract from the amenity of neighbouring
the vicinity.		properties.
(b) To ensure that lower density residential accommodation does not significantly detract from the amenity, privacy and views of other dwellings and public views corridors.		The bulk and scale of the proposal would not be compatible with the desired future character of the locality and the proposal would not be in accordance with the objectives and controls of this Part of Waverley DCP 2012.
(d) To ensure that new development and alterations and additions to existing lower density residential accommodation is sympathetic in bulk, scale and character with the desired future character of the area.		
(e) To encourage lower density residential accommodation to have high design standards and are built in accordance with the objectives and controls of this Part.		
2.2 Setbacks		
2.2.1 Front and rear building lines	No	The proposal would maintain a compatible front alignment.
Predominant front building line		The proposal would however be incompatible with the rear alignment of the immediately
Predominant rear building line at each floor level		adjoining properties resulting in adverse impacts with regard to visual bulk and scale, privacy and overshadowing and would not satisfy objective (c) under Section 2.2. of Waverley DCP 2012.
2.2.2 Side setbacksMinimum of 0.9m (for height up to 8.5m)	Yes	The proposal complies with the minimum 900mm minimum side setback requirement.

Development Control	Compliance	Comment
2.3 Streetscape and visual impa	act	
New development to be compatible with streetscape context	Yes	Satisfactory.
Replacement windows to complement the style and proportions of existing dwelling		
Significant landscaping to be maintained.		
2.5 Visual and acoustic privacy		
Habitable windows are not to directly face habitable windows or open space of neighbouring dwellings unless direct views are screened or other	No	The new first floor east facing bathroom window would directly face the first floor balcony at 14 Princess Street, resulting in increased adverse impacts on privacy. No details have been provided to confirm whether any window treatment is proposed.
appropriate measures are incorporated into the design		The relocation of the swimming pool and rearward extension of the dwellings would also result in increased adverse impacts on the
 Roof tops to be non- trafficable unless predominant in the 		neighbouring properties with regard to acoustic and visual privacy impacts.
immediate vicinity		The proposal would not satisfy objectives (a) or (c) and control (b) under Section 2.5 of Waverley DCP 2012.
2.6 Solar access		
Minimum of three hours of sunlight to living areas and principal open space areas on 21 June	No	As demonstrated on the solar access diagrams, the proposed extension of the dwellings which result in an exceedance of the FSR development standard would result in additional
Minimum of three hours of sunlight maintained to		overshadowing of windows and private open space which is not supported.
at least 50% I of principal open space areas of adjoining properties on 21 June.		The proposal would not minimise overshadowing of neighbouring properties and accordingly would not satisfy objectives (a), (b), (c), and (d), or control (e) under section 2.6 of Waverley DCP 2012.
 Avoid unreasonably overshadowing of solar collectors (including habitable windows). 		

Development Control	Compliance	Comment
2.7 Views		
 Views from the public domain are to be maintained Development to be designed and sited so as to enable a sharing of views with surrounding dwellings particularly from habitable rooms and decks. 	Yes	Please see below for the detailed assessment.
2.8 Car parking		
2.8.1 Design Approach	Yes	Satisfactory.
2.8.2 Parking rates	Yes	The proposal is in keeping with the parking rates set out under Part B8 of Waverley DCP 2012.
2.8.5 Dimensions5.4m x 2.4m per vehicle	Yes	The extension of the basement for the eastern dwelling would create sufficient space for two cars to be parked in a tandem parking arrangement.
2.9 Landscaping and open space	2	
 Overall open space: 40% of site area Overall landscaped area: 15% of site area Minimum area of 25m² for private open space Front open space: 50% of front building setback area Front landscaped area: 50% of front open space provided Outdoor clothes drying area to be provided 	Yes	The proposal continues to satisfy the minimum open space and landscaped area requirements and does not include any changes to the provision of open space and landscaping approve within the front setback of the site.
2.10 Swimming pools and spa po	1	
 Located in the rear of property Pool decks on side boundaries must consider visual privacy 	No	The relocation of the swimming pools, in conjunction with the rear additions to the dwellings and the removal of the palm trees approved between the swimming pools and the rear boundary, would result in additional impacts on the amenity of the neighbouring properties with regard to privacy and acoustic amenity. The relocation of the pools would result in the removal of the only remaining tree on the site

Development Control Compliance		Comment		
		which was proposed and condition to be retained under DA-462/2021.		
		The proposal therefore would not satisfy objectives (a), (b), and (c), and control (d) under Section 2.10 of Waverley 2012.		

2.7 Views

Submissions were received from 14 and 10A Princess Street raising concerns in relation to impacts on views. A site inspection of these properties was undertaken on 23 January 2023. Images of existing views from 14 Princess Street are provided below.

10A Princess Street

The submission received from 10A Princess Street raised concerns in relation to a *loss of open view* (skyline vs building views). Views to be assessed are taken to be views of iconic landmarks (e.g. Sydney Opera House), views of the Sydney skyline, harbour/water views, and district views.

The property at 10A Princess Street benefits from views of the Sydney city skyline to the west from the first floor balcony. The proposed development is located to the east of the property and therefore would not result in any impact on views. The property does not benefit from district or water views to the east.

14 Princess Street

Figures 5 to 8 below detail the existing views from the first floor of 14 Princess Street.



Figure 5. View from the first floor landing at 14 Princess Street. Zoomed in photo taken from a standing position.



Figure 6. View from first floor rear bedroom at 14 Princess Street. Photo taken from a standing position.



Figure 7. View from the first floor rear deck at 14 Princess Street. Photo taken from a standing position.



Figure 8. View from the first floor rear deck at 14 Princess Street (zoomed in).

Views of the Sydney City Skyline are currently enjoyed from the first floor landing, bedroom and rear deck of the property neighbouring to the east at 14 Princess Street. The views are obtained over a side boundary, through trees and over the rooftops of the neighbouring properties.

The assessment has found that views will be lost as a result of the approved development, and that there would be no additional view loss as a result of the proposed modification development.

2.2.2. Other Impacts of the Development

The proposal is considered to have a significant detrimental effect relating to environmental, social or economic impacts on the locality, and is recommended for refusal.

2.2.3. Suitability of the Site for the Development

The site is not considered suitable for the proposal.

2.2.4. Any Submissions

The application was notified 14 days between 8 and 22 September 2022 in accordance with the *Waverley Community Development Participation and Consultation Plan*.

Following receipt of amended plans and additional information, the application was not re-notified as the amendments related to the detailing of the documentation and did not include any new or additional impacts on the neighbouring properties.

A total of five unique submissions were received from the following properties:

- 10 Princess Street
- 10A Princess Street
- 14 Princess Street

The following issues raised in the submissions have been discussed and addressed in the body of this report:

- Breach of the FSR development standard
- Additional overshadowing
- Impacts on privacy
- View loss
- Impacts on acoustic amenity
- Adverse visual bulk and scale

All other issues raised in the submissions are summarised and discussed below.

Issue: Wood Burning Fireplaces

Response: Concerns were raised that the proposal includes wood burning fireplaces which would result in adverse impacts on the neighbouring. properties. Insufficient information has been provided on the plans to confirm the type of fireplaces proposed. As detailed under Section 1.3 of this report, a condition of consent was however included in the Development Consent which stipulates that solid fuel heating is prohibited.

Issue: Disregard for Waverley Local Planning Panel Determination.

Response: Concerns were raised that the proposal seeks to exceed the FSR development standard, when a leach was not supported at the DA stage. The comments are noted and the proposed breach of the FSR development standard is not supported.

Issue: Overshadowing from Landscaping.

Response: Concern was raised that the landscaping detailed along western boundary of the subject property located between 10 and 10A Princess Street would result in additional overshadowing of 10A Princess Street. The additional overshadowing of this area would be generated by the proposed rear extension as well as the landscaping proposed further north, adjacent 10A Princess Street. Notwithstanding, the modification application is recommended for refusal.

Issue: Substantially the same.

Response: Concerns were raised that the proposal would not be substantially the same. As detailed under Section 2.1 of this report, the proposal continues to comprise a two storey dual occupancy development with basement parking and swimming pools at the rear. The proposed development is found to be substantially the same as the approved development.

Issue: Stormwater run-off.

Response: Concern was raised that the re-positioning of the swimming pools would result in adverse stormwater run-off onto neighbouring properties. Council's Stormwater Engineering Department reviewed the proposal and raised no objection, subject to the existing conditions of consent being imposed in the event of an approval. Notwithstanding, the development would be required to comply

with Council's stormwater policy and be designed to not result in adverse impacts on the neighbouring properties.

Issue: Excavation.

Response: Concern was raised that the proposal would result in additional excavation which would result in adverse impacts on the neighbouring properties. A condition of consent was included at the DA stage requiring any excavation to be undertaken in accordance with the recommendations in the Geotechnical Report in order to minimise impacts on the neighbouring properties. Notwithstanding, the proposal is not supported.

2.2.5. Public Interest

The proposal is considered to have a detrimental effect on the public interest, and is recommended for refusal.

REFERRALS

The following internal and external referral comments were sought:

3.1. Traffic and Development

Council's Traffic Department raised no objection to the proposal and did not require any changes to the conditions of consent.

3.2. Stormwater

Council's Stormwater Engineering Department raised no objection to the proposal and did not require any changes to the conditions of consent.

3.3. Tree Management

Council's Tree Management Officer reviewed the proposal and did no raise objection to the proposed removal of Tree 3.

Whilst Tree 3 may not be considered as a significant tree and worthy of retention by Council's Tree Management Officer, the removal of the tree in conjunction with the removal of the four palm trees proposed and approved at the rear and the other existing trees proposed to be removed as part of the original DA is not supported on planning grounds as no offset planting is proposed in order to minimise the loss of vegetation and tree canopy, and enhance and protect the amenity and visual setting of the locality.

4. CONCLUSION

The modification application seeks to modify development consent DA-462/2021 for demolition of existing structures; and construction of a new attached dual occupancy development with basement parking and two swimming pools at rear at the site known as 12 Princess Street, Rose Bay. In summary, the proposed modifications are for extending the building envelope, relocating swimming pools and tree removal.

The principal issues arising from the assessment of the application are as follows:

- Breach of the FSR development standard
- Impacts on amenity
- Overshadowing
- Loss of canopy trees

The assessment finds these issues unacceptable for the reasons outline in this report.

A total number of five submissions were received and the issues raised in the submissions have been considered and addressed in this report. No Councillor submissions were received and there were no conflicts of interest raised.

The application has been assessed against relevant sections of the Act and is recommended for refusal.

5. RECOMMENDATION TO WAVERLEY LOCAL PLANNING PANEL

That the modification application be REFUSED by the Waverley Local Planning Panel the reasons contained in Appendix A.

Report prepared by:	Application reviewed and agreed by:
K.Keenan.	M
Karis Keenan	Bridget McNamara
Senior Development Assessment Planner	Manager, Development Assessment
Date: 6 February 2023	Date: 9 February 2023

Reason for WLPP referral:

The consent authority for the original development application was the WLPP, this modification is made under section 4.55(2) of the Act and relates to:

1. Departure from any development standard in an EPI by more than 10%

APPENDIX A – REASONS FOR REFUSAL

Having regard to section 4.55 (2) and section 4.15 (1) of the *Environmental Planning and Assessment Act* 1979 (the Act) the modification application (the application) is refused for the following reasons:

- 1. The application would not satisfy section 4.15 (1)(a)(i) of the Act as it is contrary to the *Waverley Local Environmental Plan 2012* (WLEP) as the application is contrary to the following provision:
 - a. Clause 1.2 Aim of the Plan

The proposal would not enhance or preserve the natural environment and would not enhance residential amenity.

b. Clause 4.4 Floor Space Ratio

The proposal exceeds the 0.5:1 Floor Space Ratio (FSR) development standard by 57m² or 19.59%, and the proposal fails to satisfy objectives (b), (c) and (d) under Clause 4.4 of WLEP.

The proposal is considered an overdevelopment of the site and would not preserve the environmental amenity of neighbouring properties and the surrounding locality.

2. The application does not satisfy section 4.15 (1)(a)(iii) of the Act as it is contrary to Waverley Development Control Plan (WDCP) 2012, in respect to the following provisions:

B3 Landscaping and Biodiversity

- a. Objective (a) is not satisfied as the proposal would not enhance the amenity and visual setting of the locality.
- b. Objective (b) and general controls (b) and (c) under Section 3.1 are not satisfied as the proposal would not contribute to the provision of urban canopy, and would not maintain or enhance vegetation.

Part B5 Vegetation Preservation

c. Objective (d) is not satisfied as the proposal would not increase the level of canopy cover of minimise the loss of vegetation and trees.

Part B12 Design Excellence

d. General controls (e)(iv), (v) and (vii) under section 12.1 are not satisfied as the proposal has not demonstrated that adequate consideration has been given to the amenity of the neighbouring properties, environmental impacts including overshadowing, and the bulk and scale of the proposal.

Part B14 Excavation

e. General control (d) is not satisfied as the proposal would not minimise excavation.

Part C2 Low Density Residential Development

- f. Section 2.0 General Objectives Objectives (a), (b), (d), and (e) are not satisfied as the scale of the proposal would not be appropriate to the size of the allotment, and would detract from the amenity of the neighbouring properties. The bulk and scale of the proposal would not be compatible with the desired future character of the locality and the proposal would not be in accordance with the objectives and controls of this Part.
- g. Section 2.2 Setbacks Objective (c) is not satisfied as the proposal would not provide sufficient separation in order to maintain adequate privacy and amenity.
- h. Section 2.5 Visual and Acoustic Privacy Objectives (a) and (c), and control (b) are not satisfied as the proposal would result in additional impacts on the amenity of the neighbouring properties with regard to visual privacy and acoustic amenity.
- i. Section 2.6 Solar Access Objectives (a), (b), (c) and (d), and control (e) are not satisfied as the proposal would not minimise overshadowing of the neighbouring properties.
- j. Section 2.10 *Swimming Pools and Spa Pools* Objectives (a), (b), and (c), and control (d) are not satisfied as the proposal would result in the removal of landscaping and result in additional impacts on the amenity of the neighbouring properties.
- 3. The application is contrary to section 4.15 (1)(c) of the Act due to the site being unsuitable to accommodate the proposed development.
- 4. The application is contrary to section 4.15 (1)(d) of the Act in relation to matters raised in the public submissions received that object to the proposed development.
- 5. The application is contrary to section 4.15 (1)(e) of the Act in relation to the public interest as it is not compatible with the existing and desired future character of the locality and the broader Waverley local government area.

2 Princess St, Rose Bay	DRAWING NUMBER	REVISION	DRAWING NAME	SCALE		
	DA000	05	COVER SHEET	nts		
	100 SITE PLANS & ANALYSIS					
	DA100	DA100 05 SITE AND ANALYSIS PLAN		1:200		
	DA101	05	SETBACK ANALYSIS	1:250		
	DA102	05	STREETSCAPE ANALYSIS	nts		
LOT 12, SEC B, DP4185	200 FLOOR PLANS 1:20	00				
, ,	DA200	05	BASEMENT PLAN	1:200		
	DA201	05	GROUND FLOOR PLAN	1:200		
	DA202	05	FIRST FLOOR PLAN	1:200		
	DA203	05	ROOF PLAN	1:200		
	300 ELEVATIONS					
NEVELODMENT ADDITOATTON	DA300	05	ELEVATIONS NORTH & SOUTH	1:200		
DEVELOPMENT APPLICATION Rev 05 S4,55 SUBMISSION	DA301	05	ELEVATIONS EAST & WEST	1:200		
	DA302	05	FENCES	1:200		
,1,00 802112821011	400 SECTIONS					
	DA400	05	SECTIONS	1:200		
	DA401	05	SECTIONS	1:200		
	500 DIAGRAMS					
25 August 2022	DA500	05	AREA DIAGRAMS: GFA	1:250		
	DA501	05	AREA DIAGRAMS: LANDSCAPE	1:250		
	DA502	05	WASTE MANAGEMENT PLAN	1:200		
	DA503	05	STREET PARKING ANALYSIS	1:100		
	600 EXTERIOR					
	DA600	05	EXTERNAL FINSIHES SCHEDULE	nts		
	DA601	05	PHOTOMONTAGE	nts		



AMENDMENT	05
Α	GF Rear glass line Extended by 3m
В	1F Rear glass line Extended by 3.1m
С	Proposed Fire Place
D	Extended Courtyard by 2.2m
E	Extended Void by 2.2m
F	Extended Skylight by 2.2m
G	Proposed Skylight
Н	Master Bathroom Extended by 200mm
1	1F Front Wall line Extended by 0.5m
J	Basement Extended
K	Pools shifted North
L	Kitchen Reconfigured
M	Bathroom Reconfigured
N	Proposed Bedroom To Replace Study





Shgc 0.47:
Aluminium A DG Argon Fill High Solar
Gain low-E Clear: Ll-Value: 4.10,
Shgc 0.52:
ExTERNAL WALLS:
Brick Veneer: R 2.73
Cavity Brick R0.41
Blockwork: R0.00
FC Sheet R2.73
ROOF:
Fall Framed R1.80 Colour Light, Solar
Absoproptance 0.30

PRINCESS DUAL OCC

12 PRINCESS ST ROSE BAY

MH, RM

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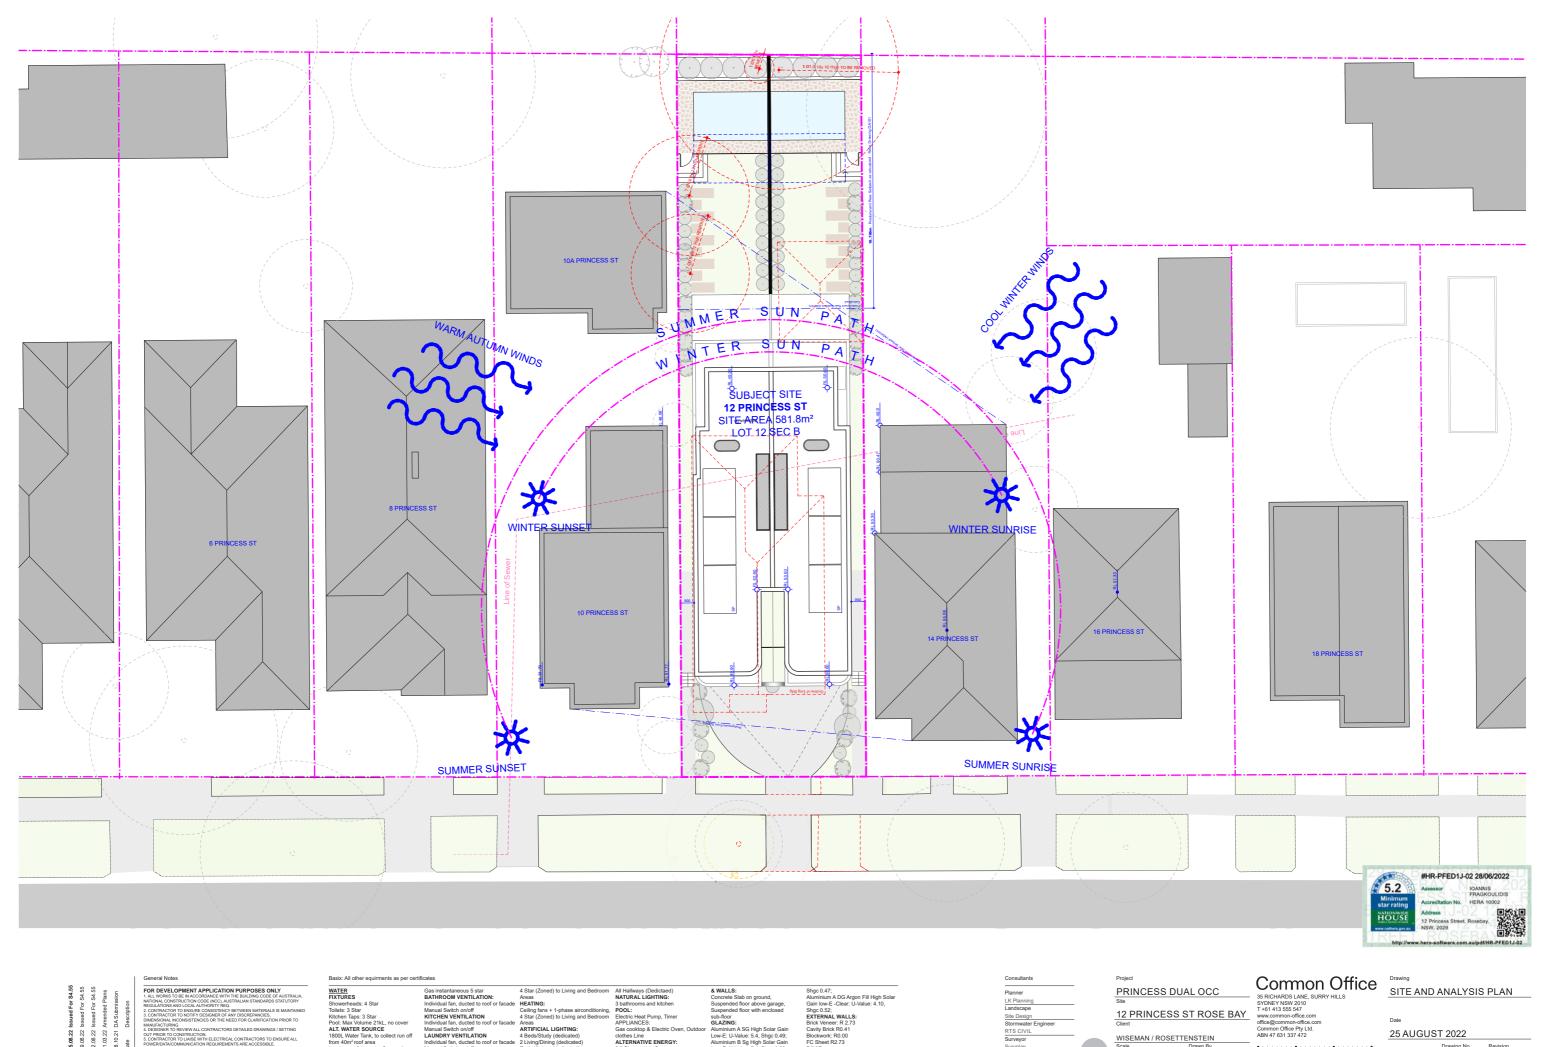
Common Office

SS RICHARDS LANE, SURRY HILLS
SYDNEY NSW 2010
1-61-413 355 547
Www.common-office.com

DA

Drawing No

Revision [05]



WATER

WATER

Showers and the equilibrium as pool of the part of t

Electric Heat Pump, Timer
APPLIANCES:
Gas cooktop & Electric Oven, Outdoor of clothes Line
ALTERNATIVE ENERGY:
2.0 Photovoltaic System
THERMAL COMFORT
CONSTRUCTION OF FLOORS


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12 PRINCESS ST ROSE BAY

1:200 at A3 MH, RM

100 [05]

REAR SETBACK ANALYSIS 12 PRINCESS ST					
Address	ddress Rear Setback at GROUND (m)				
2 Princess St	18.16	n/a single storey			
4 Princess St	19.24	19.24			
6 Princess St	19.06	19.06			
8 Princess St 17.68		17.68			
10 Princess St	9.17	9.17			
12 Princess St: Subject	Site				
14 Princess St	24.40	31.48			
16 Princess St	17.34				
18 Princess St	16.97	16.97			
20 Princess St	9.17	12.26			
PREDOMINANT	PREDOMINANT 16.798m 17.900m				



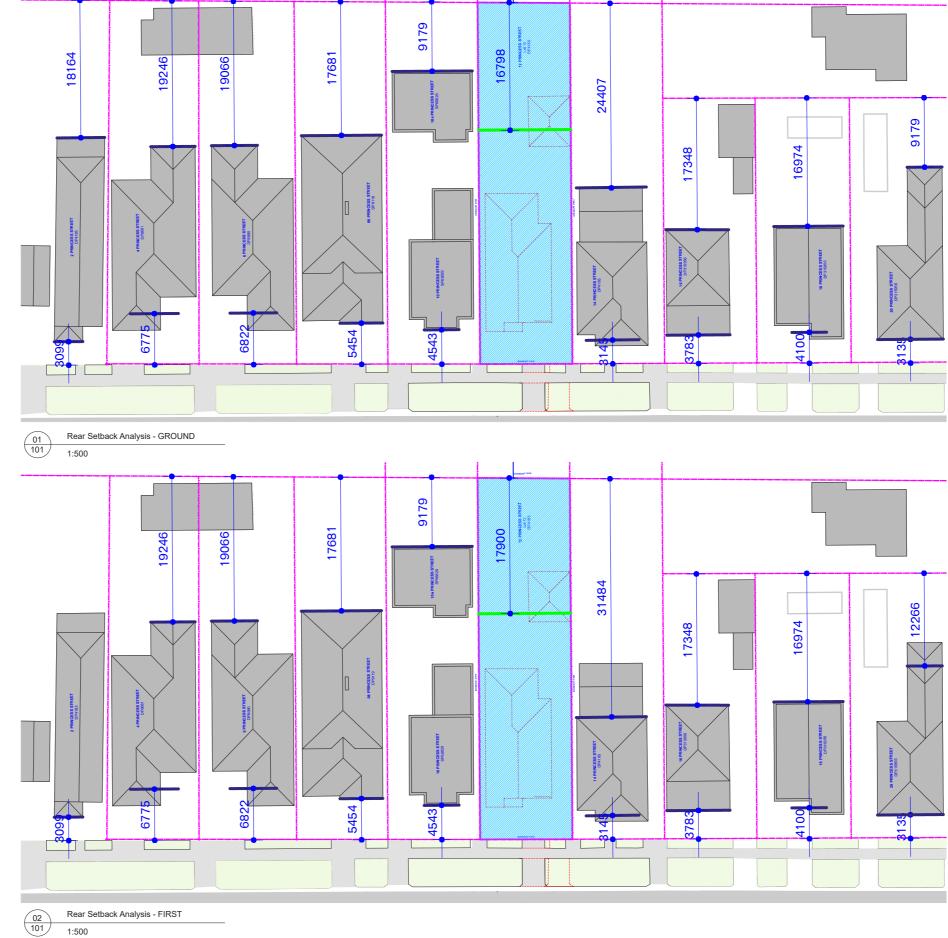

General Notes

Gas instantaneous 5 star

ASTAR (Zoned) to Living and Bedroom
All Hallways (Dedicated)
Areas
Are

All Hallways (Dedicated)

All Hallways (Dedicated)

ANTURAL LICHTING:
Concrete Slab on ground,
Suspended floor above garage,
POOL:
Suspended floor with enclosed
sub-floor
Special Sub-floor
APPLIANCES:
Gas cooktop & Electric Oven, Outdoor
clothes Line
ALTERNATIVE ENERGY:
2.0 Photovoltaic System
THERMAL GOMFORT
CONSTRUCTION OF FLOORS
Gain low-E-Clear: U-Value: 4.10,
Shgc 0.47:
Aluminium A DG Argon Fill High Solar
Shgc 0.52:
Brick Veneer: R.2.73
Brick Veneer: L.4.74
Brock Veneer: L.4.74
Bro

PRINCESS DUAL OCC

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12 PRINCESS ST ROSE BAY WISEMAN / ROSETTENSTEIN
Scale Drawn By

MH, RM

0 2 4

Common Office Drawing SETBACK ANALYSIS

25 AUGUST 2022

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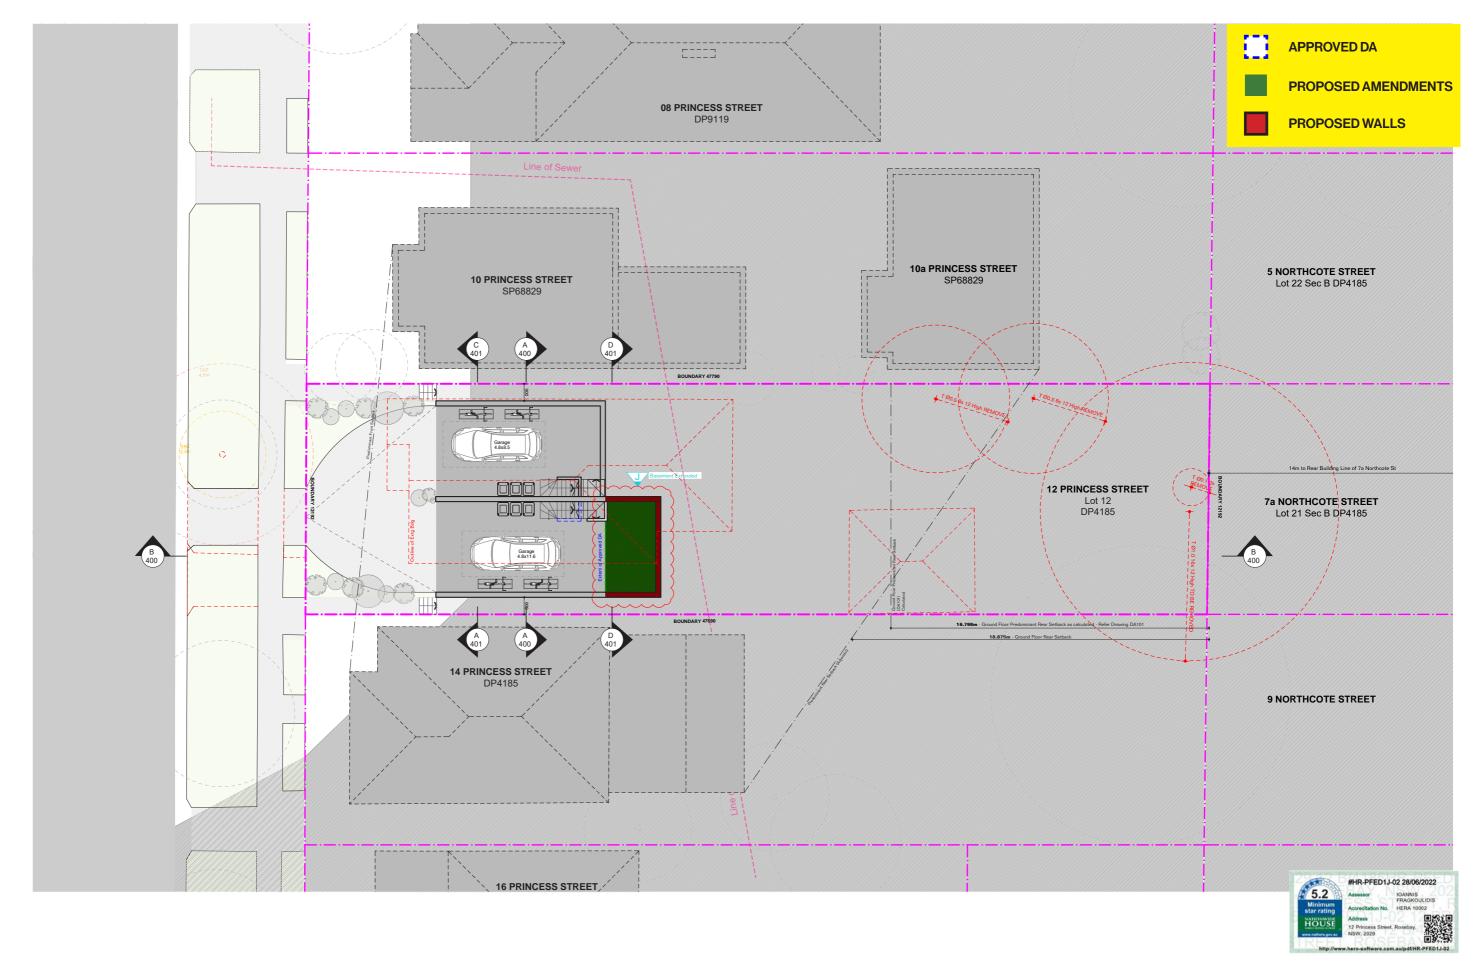
MH, RM

nts at A3

Common Office STRECHARDS LANE SURRYHILLS STREETSCAPE ANALYSIS

DA

102 [05]





WATER
FIXTURES
Showerheads: 4 Star
Toilets: 3 Star
Kitchen Taps: 3 Star
Poot: Max Volume 21kL, no cover
ALT, WATER SOURCE
1800L Water Tank, to collect run off
from 40m* roof area
Landscape & Laundry Connection
ENERGY
HOT WATER:

Electric Heat Pump, Timer APPLIANCES: Gas cooktop & Electric Oven, Outdoor clothes Line ALTERNATIVE ENERGY:

2.0 Photovoltaic System
THERMAL COMFORT
CONSTRUCTION OF FLOORS

Shgc 0.47; Aluminium A DG Argon Fill High Solar Gain low-E-Clear: U-Value: 4.10, Shgc 0.52; EXTERNAL WALLS: Brick Veneer: R 2.73 Cavily Brick R0.41 Blockwork: R0.00 FC Sheet R2.73 ROOF: FIlat Framed R1.80 Colour Light, Solar Absoprotance 0.30


PRINCESS DUAL OCC 12 PRINCESS ST ROSE BAY

1:200 at A3

MH, RM

Common Office Drawing
35 RICHARDS LANE SURRY HILLS
BASEMENT PLAN

25 AUGUST 2022 200 [05]

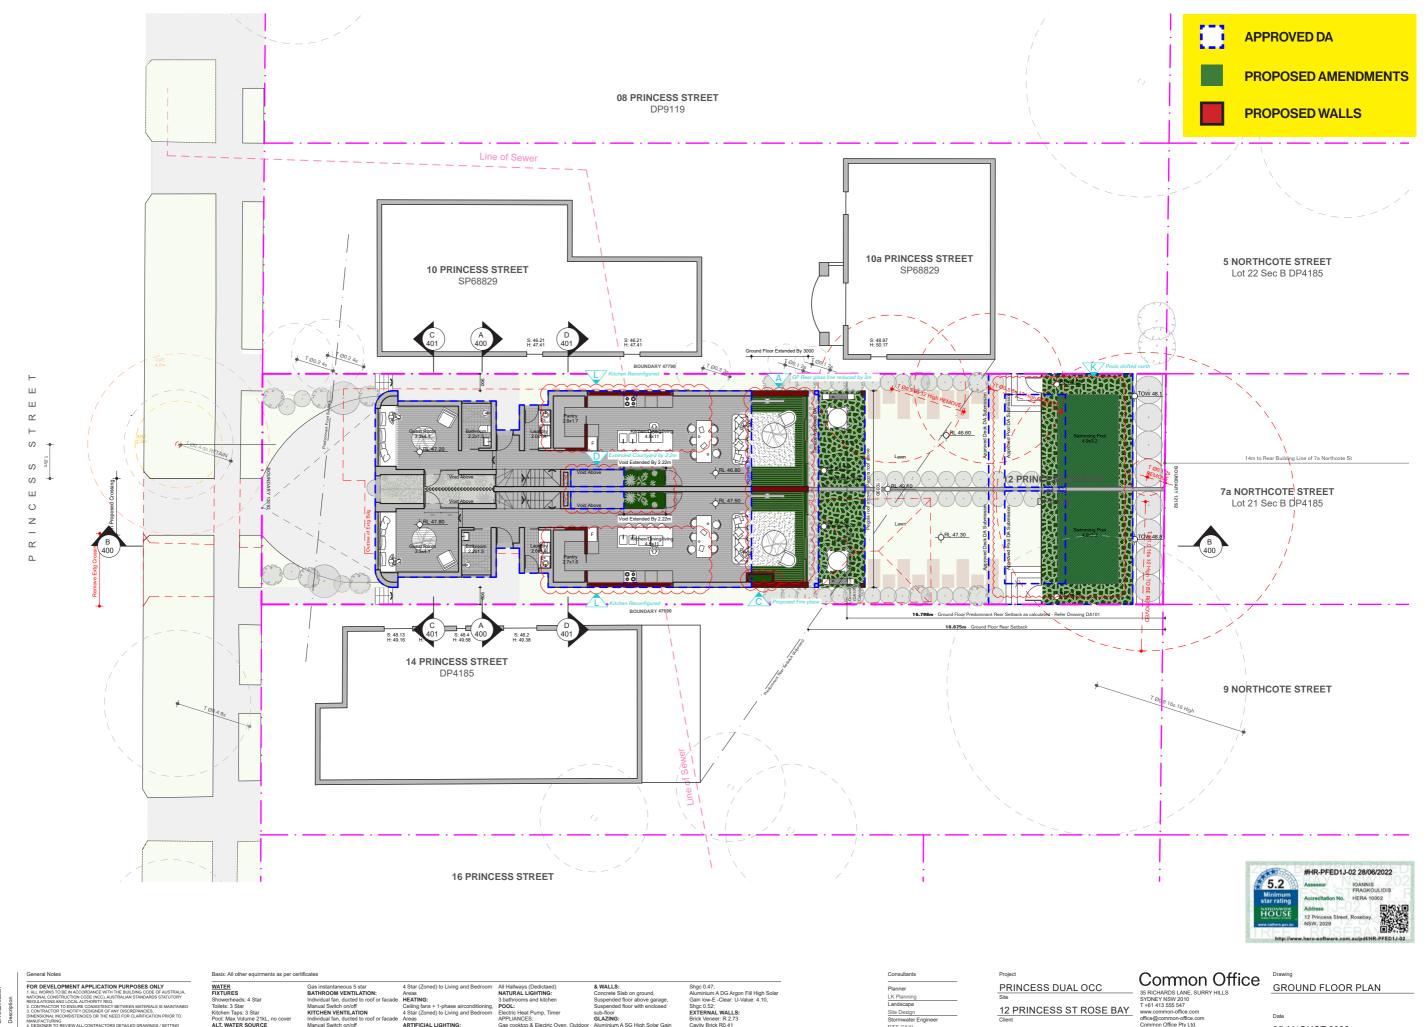

FIXTURES
Showetheads: 4 Star
Tollets: 3 Star
Klichen Taps: 3 Star
Pool: Max Volume 2 TkL, no cover
ALT. WATER SOURCE
1800L. Water Tank, to collect run off
from 40n° roof area
Landscape & Laundry Connection
ENERGY
HOT WATER:

Areas
ARTIFICIAL LIGHTING:
4 Beds/Study (dedicated)
2 Living/Dining (dedicated)
Each Kitchen (dedicated)
All bathrooms (Dedicated)

APPLIANCES:
Gas cooktop & Electric Oven, Outdoor clothes Line
ALTERNATIVE ENERGY: 2.0 Photovoltaic System
THERMAL COMFORT
CONSTRUCTION OF FLOORS

Shgc 0.47;
Aluminium A DG Argon Fill High Solar
Gain low-E-Clear: U-Value: 4.10,
Shgc 0.52;
ExTERNAL WALLS:
Brick Veneer: R 2.73
Cavity Brick R0.41
Blockwork: R0.00
FC Sheet R2.73
ROOF:
Fall Framed R1.80 Colour Light, Solar
Absorptance 0.30

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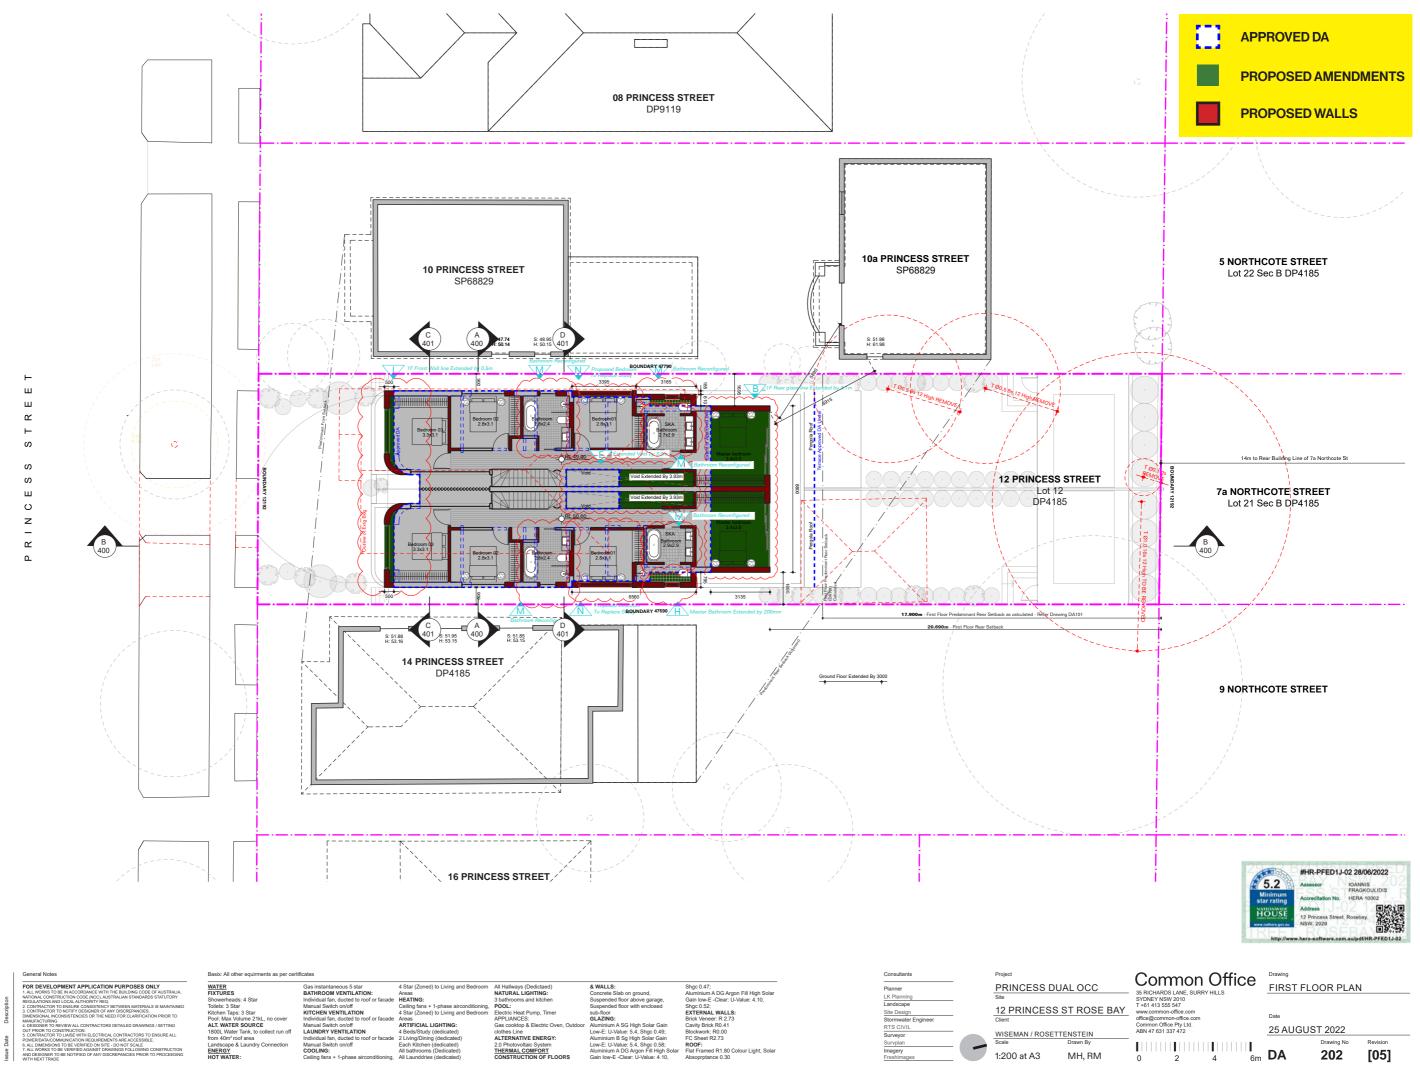
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25 AUGUST 2022

6m DA

201 [05]



WATER
FIXTURES
Showerheads: 4 Star
Toilets: 3 Star
Kitchen Taps: 3 Star
Poot: Max Volume 21kL, no cover
ALT, WATER SOURCE
1800L Water Tank, to collect run off
from 40m* roof area
Landscape & Laundry Connection
ENERGY
HOT WATER:


Gas instantaneous 5 star
BATHROOM VENTILATION:
Individual fain, dusted to roof or facade
Manual Switch onloff
KITCHEN VENTILATION
Individual fan, dusted to roof or facade
Manual Switch onloff
LAUNDRY VENTILATION
Individual fan, dusted to roof or facade
Manual Switch onloff
COUING:
Ceiling fans + 1-phase airconditioning,

Electric Heat Pump, Timer APPLIANCES: Gas cooktop & Electric Oven, Outdoor clothes Line ALTERNATIVE ENERGY: 2.0 Photovoltaic System
THERMAL COMFORT
CONSTRUCTION OF FLOORS

1:200 at A3

MH, RM

25 AUGUST 2022 202 [05]

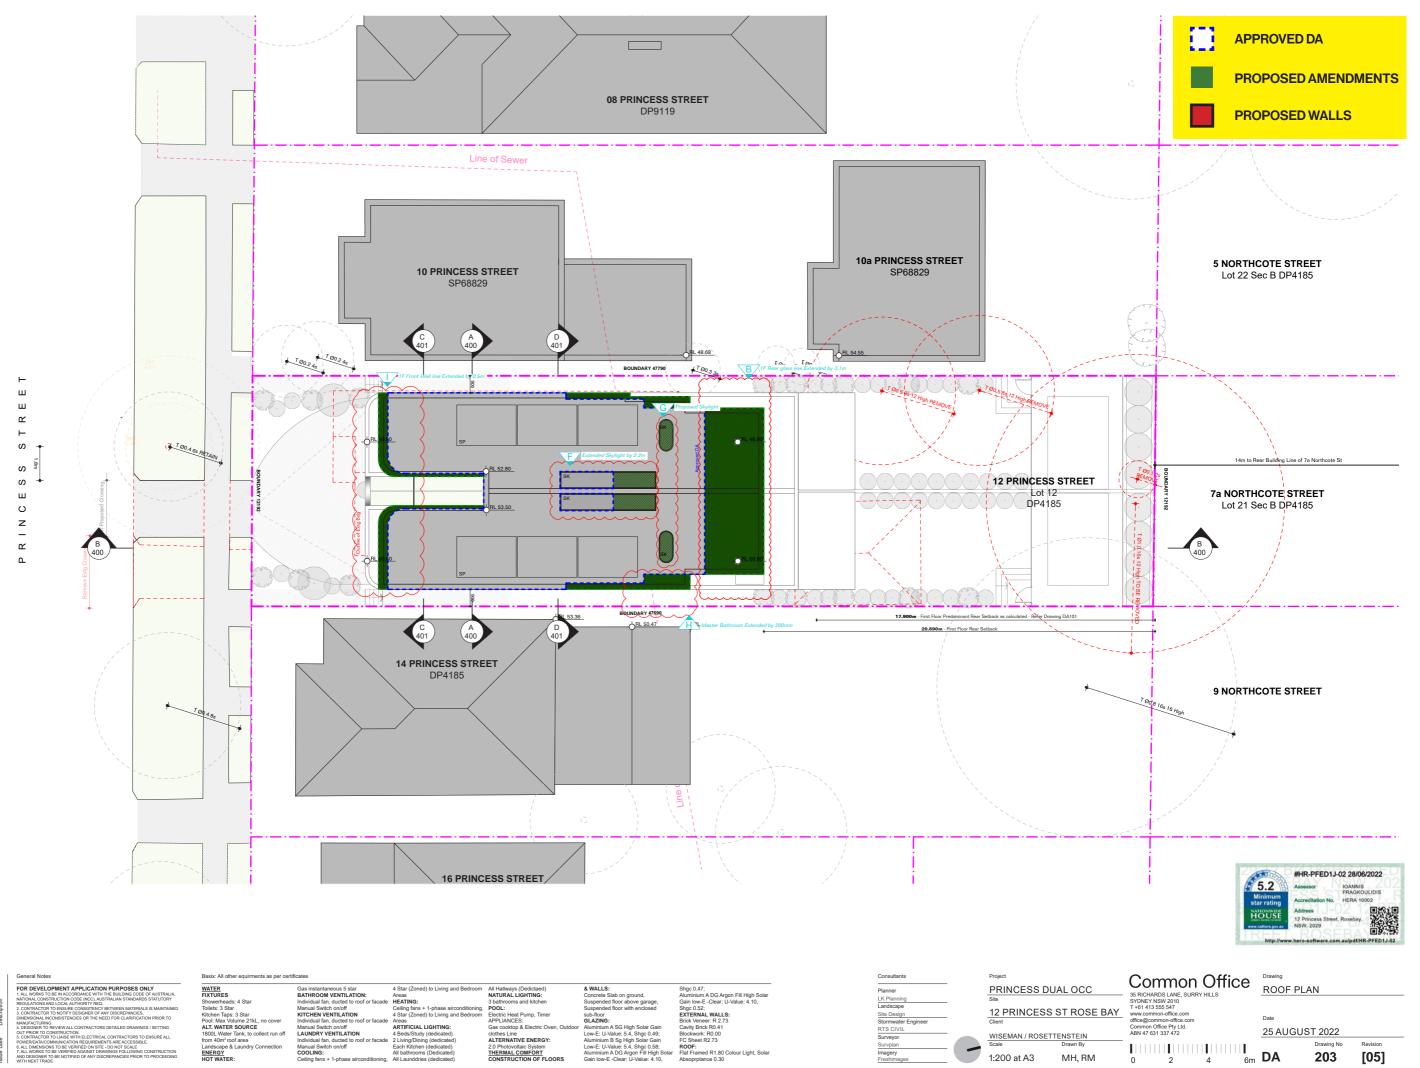

WATER
FIXTURES
Showerheads: 4 Star
Toilets: 3 Star
Kitchen Tape: 3 Star
Pool: Max Volume 2 LL, no cover
ALT, WATER SOURCE
1800L Water Tank, to collect run off
from 40m* roof area
Landscape & Laundry Connection
ENERGY
HOT WATER:

Areas
ARTIFICIAL LIGHTING:
4 Beds/Study (dedicated)
2 Living/Dining (dedicated)
Each Kitchen (dedicated)
All Launddries (dedicated)
All Launddries (dedicated)

Electric Heat Pump, Timer APPLIANCES: Gas cooktop & Electric Oven, Outdoor clothes Line ALTERNATIVE ENERGY:

2.0 Photovoltaic System
THERMAL COMFORT
CONSTRUCTION OF FLOORS


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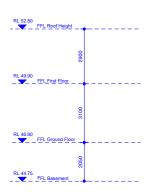
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12 PRINCESS ST ROSE BAY

MH, RM


25 AUGUST 2022 203 [05]



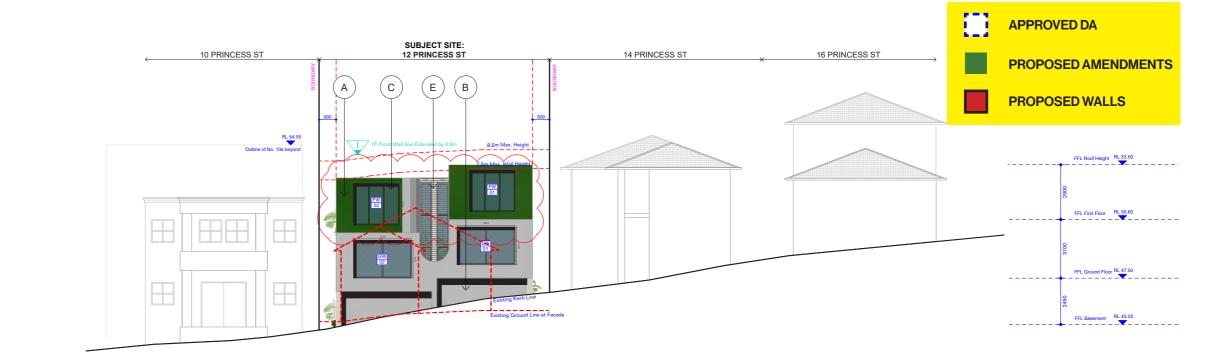

South (Princess St) Elevation

1:200

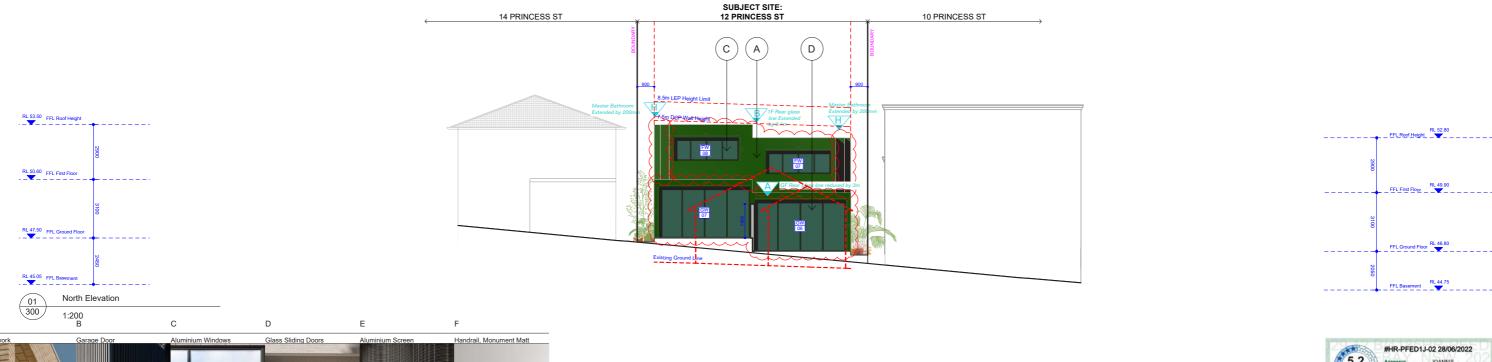



300

[05]

WATER
FIXTURES
Showerheads: 4 Star
Toletes: 3 Star
Kitchen Taps: 3 Star
Pool: Max Volume 21kt., no cover
ALT, WATER SOURCE
1800L Water Tank, to collect run off
from 40m roof area
Landscape & Laundry Connection
ENERGY
HOT WATER:

Gas instantaneous 5 star
BATHROOM VENTILATION:
Individual fan, ducted to roof or facade
Manual Switch on/off
KITCHEN VENTILATION
Individual fan, ducted to roof or facade
Manual Switch on/off
LAUNDRY VENTILATION
Individual fan, ducted to roof or facade
Manual Switch on/off
COOLING:
Celling fans + 1-phase airconditioning,

Electric Heat Pump, Timer APPLIANCES: Gas cooktop & Electric Oven, Outdoor clothes Line ALTERNATIVE ENERGY: 2.0 Photovoltaic System
THERMAL COMFORT
CONSTRUCTION OF FLOORS

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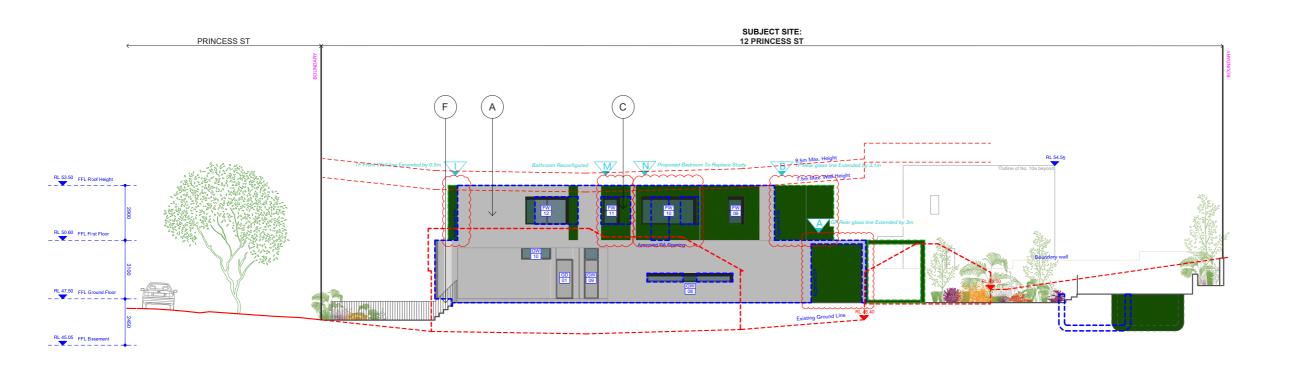
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12 PRINCESS ST ROSE BAY 0 2 4 6m

MH, RM

Common Office Drawing ELEVATIONS NORTH/SOUTH 25 AUGUST 2022


6m DA





East Elevation

1:200

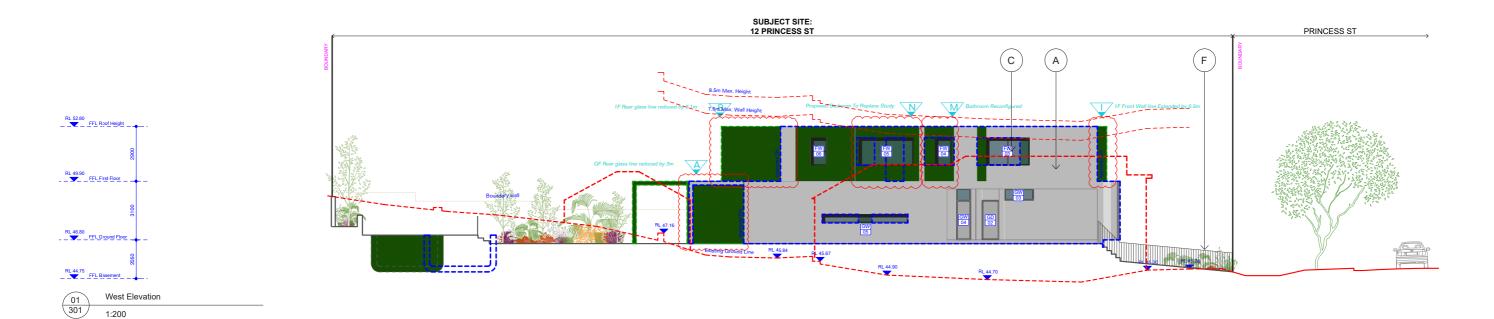





WATER
FIXTURES
Showerheads: 4 Star
Toletes: 3 Star
Kitchen Tags: 3 Star
Pool: Max Volume 21kL, no cover
ALT, WATER SOURCE
1800L Water Tank, to collect run off
from 40m roof area
Landscape & Laundry Connection
ENERGY
HOT WATER:

Gas instantaneous 5 star
BATHROOM VENTILATION:
Individual fan, ducted to roof or fs
Manual Switch on/off
KITCHEN VENTILATION
Individual fan, ducted to roof or fs
Manual Switch on/off
LAUNDRY VENTILATION
Individual fan, ducted to roof or fs
Manual Switch on/off
COOLING:
Ceiling fans + 1-phase airconditic

POOL: Electric Heat Pump, Timer APPLIANCES: Gas cooktop & Electric Oven, Outdoor clothes Line ALTERNATIVE ENERGY: 2.0 Photovoltaic System
THERMAL COMFORT
CONSTRUCTION OF FLOORS

Shgc 0.47;
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Gain low-E-Clear: U-Value: 4.10,
Shgc 0.52;
ExTERNAL WALLS:
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Cavity Brick R0.41
Blockwork: R0.00
FC Sheet R2.73
ROOF:
Fall Framed R1.80 Colour Light, Solar
Absorptance 0.30

PRINCESS DUAL OCC 12 PRINCESS ST ROSE BAY 0 2 4 6m

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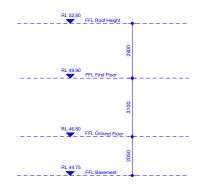
Common Office Drawing SIRICHARDS LANE SURRY HILLS ELEVATIONS EAST/WEST 25 AUGUST 2022

301

[05]


6m DA











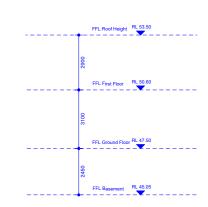

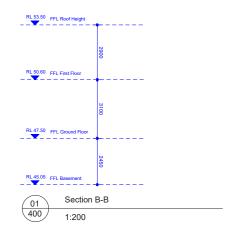

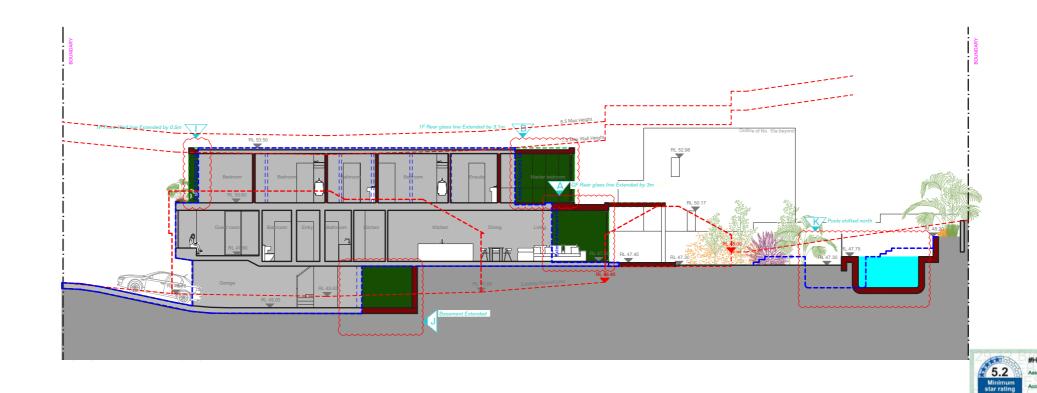

25.08.22 Issued For S4.55	19.08.22 Issued For S4.55	12.08.22 Issued For S4.55	14.07.22 Issued For S4.55	01.03.22 Amended Plans	08.10.21 DA Submission	Description
25.08.22	19.08.22	12.08.22	14.07.22	01.03.22	08.10.21	o Date

WATER
FIXTURES
Showetheads: 4 Star
Toletes: 3 Star
Kitchen Taps: 3 Star
Pool: Max Volume 21kt., no cover
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1800L Water Tank, to collect run off
from 40m froof area
Landscape & Laundry Connection
ENERGY
HOT WATER:

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PRINCESS DUAL OCC

12 PRINCESS ST ROSE BAY

1:200 at A3


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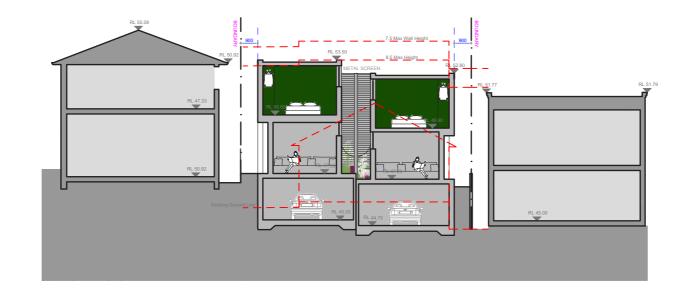
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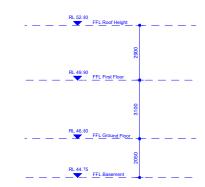
25 AUGUST 2022


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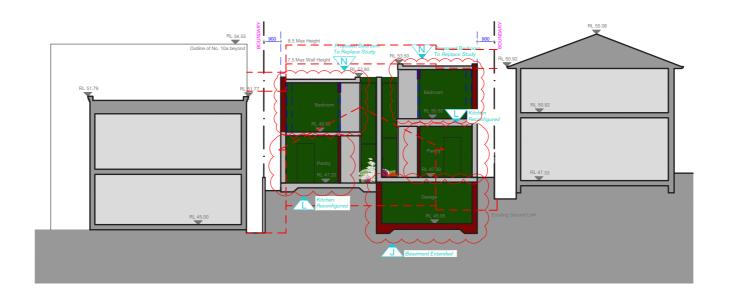







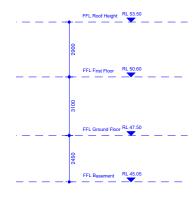

Section C 1:200

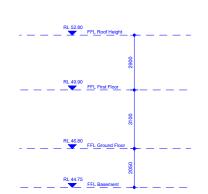

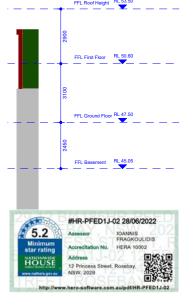

25.08.22 Issued For S4.55	19.08.22 Issued For S4.55	12.08.22 Issued For S4.55	01.03.22 Amended Plans	08.10.21 DA Submission	
25.08.22	19.08.22	12.08.22	01.03.22	08.10.21	

WATER

WATER

PATRURES
Showesheads: 4 Star
Toolets: 3 Star
Toolets: 4 Star
Toolets: 4 Star
Toolets: 5 Star
Too

Shgr 0.47;
Aluminium A DG Argon Fill High Solar
Gain low-E-Clear: U-Value: 4.10,
Shgr 0.52;
EXTERNAL WALLS:
Brick Veneer: R 2.73
Cavity Brick R0.41
Blockwork: R0.00
FC Sheet R2.73
ROOF:
Flat Framed R1.80 Colour Light, Solar
Absorpptance 0.30

1:200 at A3

PRINCESS DUAL OCC 12 PRINCESS ST ROSE BAY

MH, RM

Common Office

SS RICHARD ADDR. SURRY HILLS

SECTION


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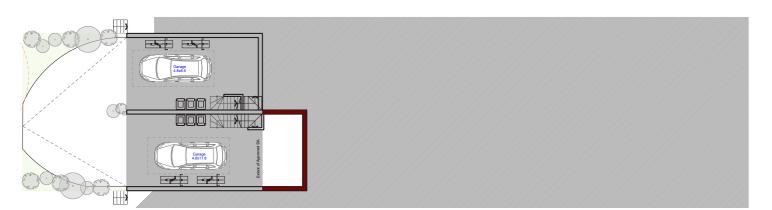
First Floor Plan

1:200



500

Ground Floor Plan 1:200

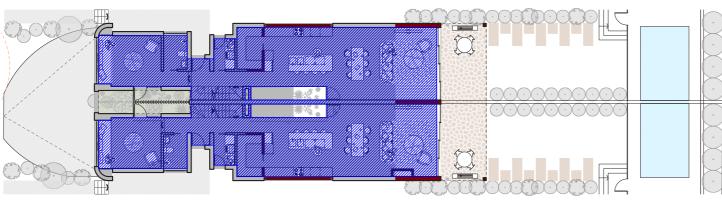

500

Basement Plan

1:200

Gas instantaneous 5 star
BATHROOM VENTILATION:
Individual fain, ducted to roof or
Manual Switch on/off
MITCHEN VENTILATION
Individual fain, ducted to roof or
Manual Switch on/off
LAUNDRY VENTILATION
Individual fain, ducted to roof or
Manual Switch on/off
COOLING:
Ceiling fains + 1-phase aircondit

SITE AREA: 581.8m²

ALLOWABLE FSR AT 0.5:1 290.9M²

	GFA CALCU SITE AREA		
	Approved DA m²	S4.55 Rev 04 m ²	\$4.55 Rev 05 m ²
BASEMENT	0	0	0
GROUND FLOOR	156	179.6	181.8
FIRST FLOOR	134	163.8	165.6
Totals	290	343.4	347.4
FSR	0.5:1	0.590:1	0.597:1
Breach of	0%	18%	19%

Window	and a	dama d	dean	aabadul	

	Window	Window	Heinh	Width	Window	Opening
Location	ID	no.	(mm)	(mm)	type	%
EVENE:	100000000000000000000000000000000000000	200			Double	
BATHFF	ALM-002-03 A	FW04	1450	850	Hung	45
BATH GF	ALM-002-03 A	GW03	600	1555	Sliding	45
BED 01	ALM-004-03 A	FW05	1450	2875	Sliding	45
BED 02	ALM-004-03 A	FW03	1450	2275	Sliding	45
BED 03	ALM-004-03 A	FGL10	2600	1974	Fixed	0
BED 03	ALM-004-03 A	FW02	2185	2410	Sliding	60
ENS MB	ALM-004-03 A	FW06	1450	850	Double Hung	45
ENTRY/STAIRS GF	ATB-006-03 B	GGL06	2700	630	Fixed	0
ENTRY/STAIRS GF	ATB-005-03 B	GD02	2100	900	Casement	90
HALL/STAIRS FF	THC-033-02 B	FGL08	2600	630	Fixed	0
HALL/STAIRS FF	THC-033-02 B	FGL09	2600	2112	Fixed	0
HALL/STAIRS FF	THC-033-02 B	FGL06	2600	5034	Fixed	0
HALL/STAIRS FF	THC-033-02 B	FGL05	2600	800	Fixed	0
KLD	ATB-005-03 B	GGLD03	2400	900	Casement	90
KLD	ATB-006-03 B	GGL05	2700	5030	Fixed	0
KLD	ATB-006-03 B	GW06	2700	4790	Sliding	45
KLD	ATB-006-03 B	GW05	450	4535	Fixed	0
LDRY GF	ALM-001-03 A	GW04-A	2100	750	Casement	90
LDRY GF	ALM-002-03 A	GW04-8	600	750	Fixed	0
LIVING	ATB-006-03 B	GW02	1900	3065	Sliding	30
LIVING	ATB-006-03 B	GGL08	2400	900	Fixed	0
LIVING	ATB-005-03 B	GGLD04	2400	900	Casement	90
MIRED	ATR-MA-M3 R	EW07	1200	3400	Skillen	30

Window and glazed door schedule

Location	Window	Window no.	Height (mm)	Width (mm)	Window	Opening %
BATH FF	ALM-002-03 A	FW11	1450	850	Double Hung	45
BATH GF	ALM-002-03 A	GW10	600	1555	Sliding	90
BED 03	ALM-004-03 A	FW01	2185	2410	Sliding	45
BED 03	ALM-004-03 A	FGL01	2600	2008	Fixed	0
BED 1	ALM-004-03 A	FW10	1450	2875	Sliding	45
BED 2	ALM-004-03 A	FW12	1450	2275	Sliding	45
ENS MB	ALM-004-03 A	FW09	1450	850	Double Hung	45
ENTRY/STAIRS GF	ATB-006-03 B	GGL03	2700	630	Fixed	0
ENTRY/STAIRS GF	ATB-005-03 B	GD01	2100	900	Casement	90
HALL/STAIRS FF	THC-033-02 B	FGL02	2600	2062	Fixed	0
HALL/STAIRS FF	THC-033-02 B	FGL01	2600	630	Fixed	0
HALL/STAIRS FF	THC-033-02 B	FGL03	2600	800	Fixed	0
HALL/STAIRS FF	THC-033-02 B	FGL04	2600	4964	Fixed	0
KLD	ATB-006-03 B	GGL04	2700	5030	Fixed	0
KLD	ATB-005-03 B	GGLD02	2400	900	Casement	90
KLD	ATB-006-03 B	GW07	2700	4790	Sliding	80
KLD	ATB-006-03 B	GW08	450	4535	Fixed	0
LDRY GF	ALM-002-03 A	GW9-8	600	750	Fixed	0
LDRY GF	ALM-001-03 A	GW9-A	2100	750	Casement	90
LIVING	ATB-006-03 B	GW01	1900	3065	Sliding	30
LIVING	ATB-005-03 B	GGLD01	2400	900	Casement	90
IVING	ATB-006-03 B	GGL01	2400	900	Fixed	0
M BED	ATB-006-03 B	FW08	1200	3400	Sliding	75



PRINCESS DUAL OCC

1:250 at A3

12 PRINCESS ST ROSE BAY

0 2 4 6m MH, RM


Common Office Drawing AREA DIAGRAMS: GFA


25 AUGUST 2022


DA 500 [05]

WATER
FIXTURES
Showerheads: 4 Star
Toilets: 3 Star
Kitchen Taps: 3 Star
Pool: Max Volume 21kL, no cover
ALT, WATER SOURCE
1800L Water Tank, to collect run off
from 40m* roof area
Landscape & Laundry Connection
ENERGY
HOT WATER:

Electric Heat Pump, Timer APPLIANCES: Gas cooktop & Electric Oven, Outdoor clothes Line ALTERNATIVE ENERGY: 2.0 Photovoltaic System
THERMAL COMFORT
CONSTRUCTION OF FLOORS

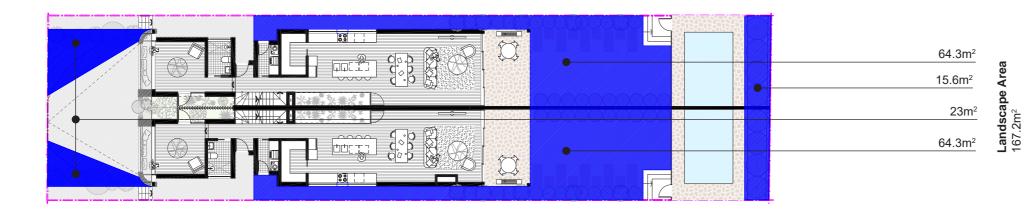

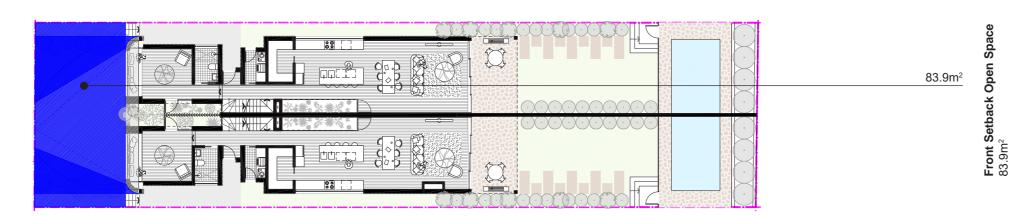

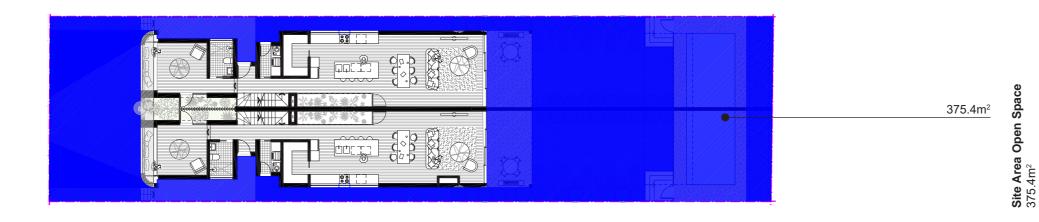

LANDSCAPE CALCULATIONS SITE AREA IS 581.8m² COMPLIANCE DCP/LEP **PROPOSED** CONTROL % Site Area 40% of 581.8m²= 375.4m² Yes to be Open 232.72m² Space % Site 15% of 581.8m²= Yes 167.2m² Total Landscaped Area Area to be 87.27m² Landscaped A minimum of 50% of the area between the front of the primary | 50% of 83.9m² = Yes 83.9m² building and 41.95m² the street alignment is to be open space. Each dwelling to Private Open have minimum of 60.4m² for each dwelling Yes Space 25m²

<u>*Landscaped Area:</u>

A part of a site used for growing plants, grasses and trees, but does not include any building, structure or hard paved area

**Deep Soil Zone:

site area that is not built on, or underneath, thereby leaving an area of deep soil for deep-rooted vegetation, native vegetation and natural drainage. The zone must have a minimum dimension of 2 by 2 metres and should be positioned to enable the retention of existing mature and / or significant trees. Open Space:

An area external to a building (including an area of land, terrace, balcony or deck) and includes hard paved areas, areas containing swimming pools as well as landscaped area.



Showerheads: 4 Star Toilets: 3 Star Kitchen Taps: 3 Star Pool: Max Volume 21kL, no cover ALT. WATER SOURCE 1800L Water Tank, to collect run of from 40m² roof area

Gas instantaneous 5 star BATHROOM VENTILATION

Gas cooktop & Electric Oven, Outdoo clothes Line
ALTERNATIVE ENERGY: 2.0 Photovoltaic System
THERMAL COMFORT
CONSTRUCTION OF FLOORS

Shgc 0.47;
Aluminium A DG Argon Fill High Solar
Gain low-E-Clear: U-Value: 4.10,
Shgc 0.52;
EXTERNAL WALLS:
Brick Veneer: R 2.73
Cavity Brick R0.41
Blockwork: R0.00
F C Sheet R2.73
ROOF:
Flat Framed R1.80 Colour Light, Solar
Absoprptance 0.30

1:250 at A3

PRINCESS DUAL OCC 12 PRINCESS ST ROSE BAY

MH. RM


Common Office

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AREA DIAGRAMS: LANDSCAPE

25 AUGUST 2022

DA 501 [05]



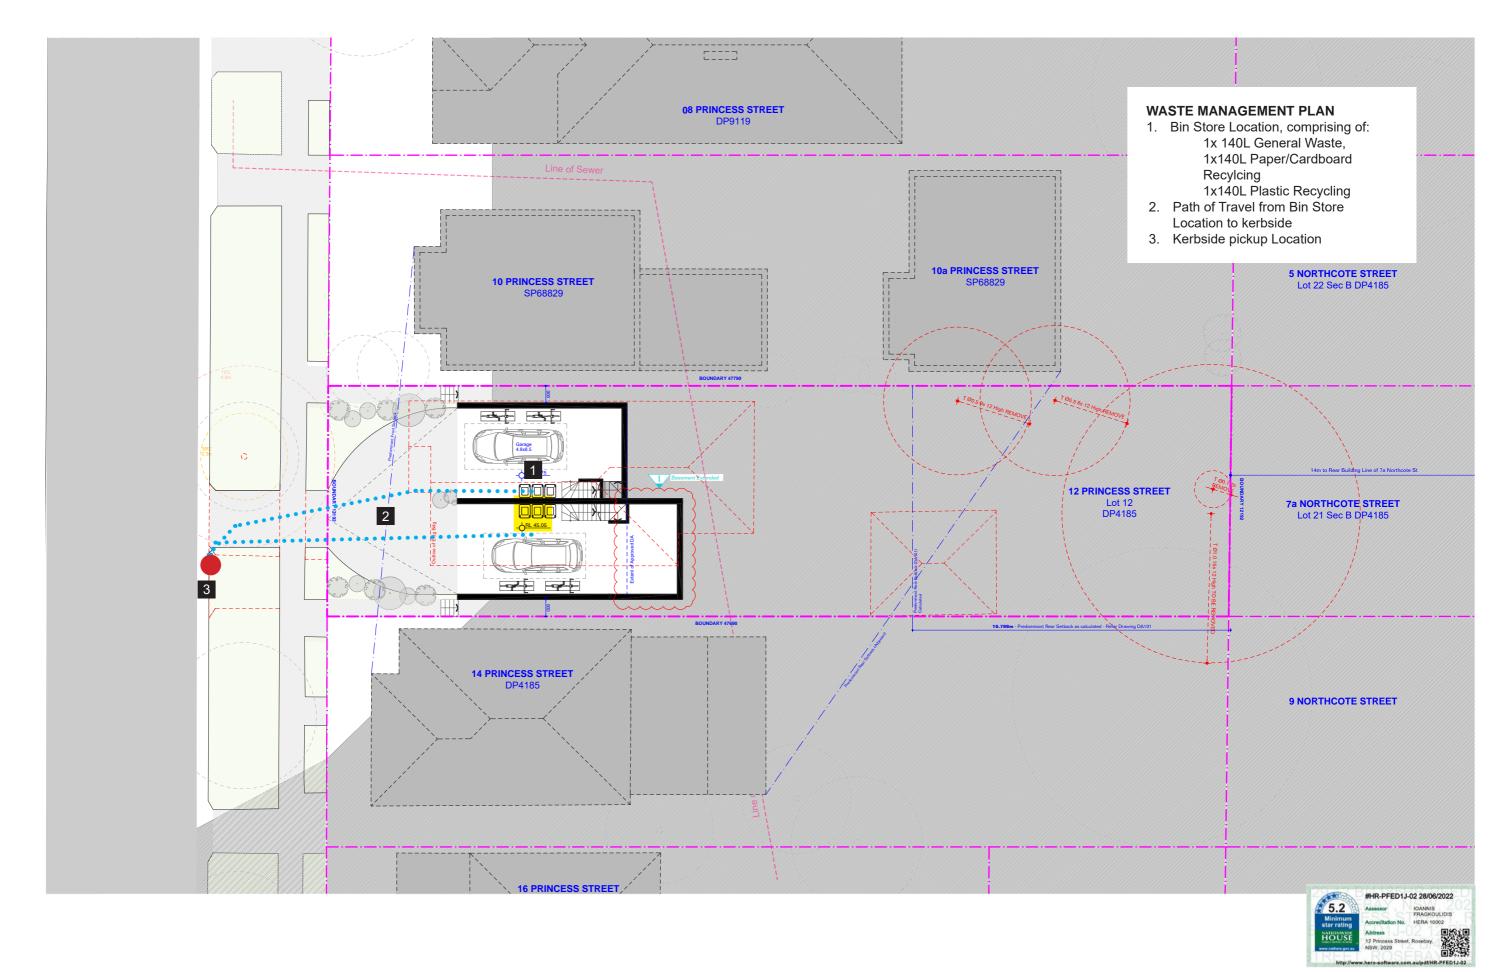

FIXTURES
Showerheads: 4 Star
Toilets: 3 Star
Klitchen Taps: 3 Star
Pool: Max Volume 2*IkL, no cover
ALT. WATER SOURCE
1800L Water Tank, to collect run off
from 40m* roof area
Landscape & Laundry Connection
EMERGY
HOT WATER:

APPLIANCES:
Gas cooktop & Electric Oven, Outdoor clothes Line
ALTERNATIVE ENERGY:

2.0 Photovoltaic System
THERMAL COMFORT
CONSTRUCTION OF FLOORS

Shg- 0.47:
Aluminium A DG Argon Fill High Solar
Gain low-E-Clear: U-Value: 4.10,
Shg- 0.52:
EXTERNAL WALLS:
Brick Veneer: R.2.73
Cavly Brick Rio.41
Blockwork: Rio.00
F.C Sheet Ri.273
ROP:
olar Fila Framed R1.80 Colour Light, Sx
Absoprptance 0.30


PRINCESS DUAL OCC 12 PRINCESS ST ROSE BAY 1:200 at A3

0 2 4 6m


Common Office Drawing WASTE MANAGEMENT PLAN

25 AUGUST 2022 6m DA

502 [05]

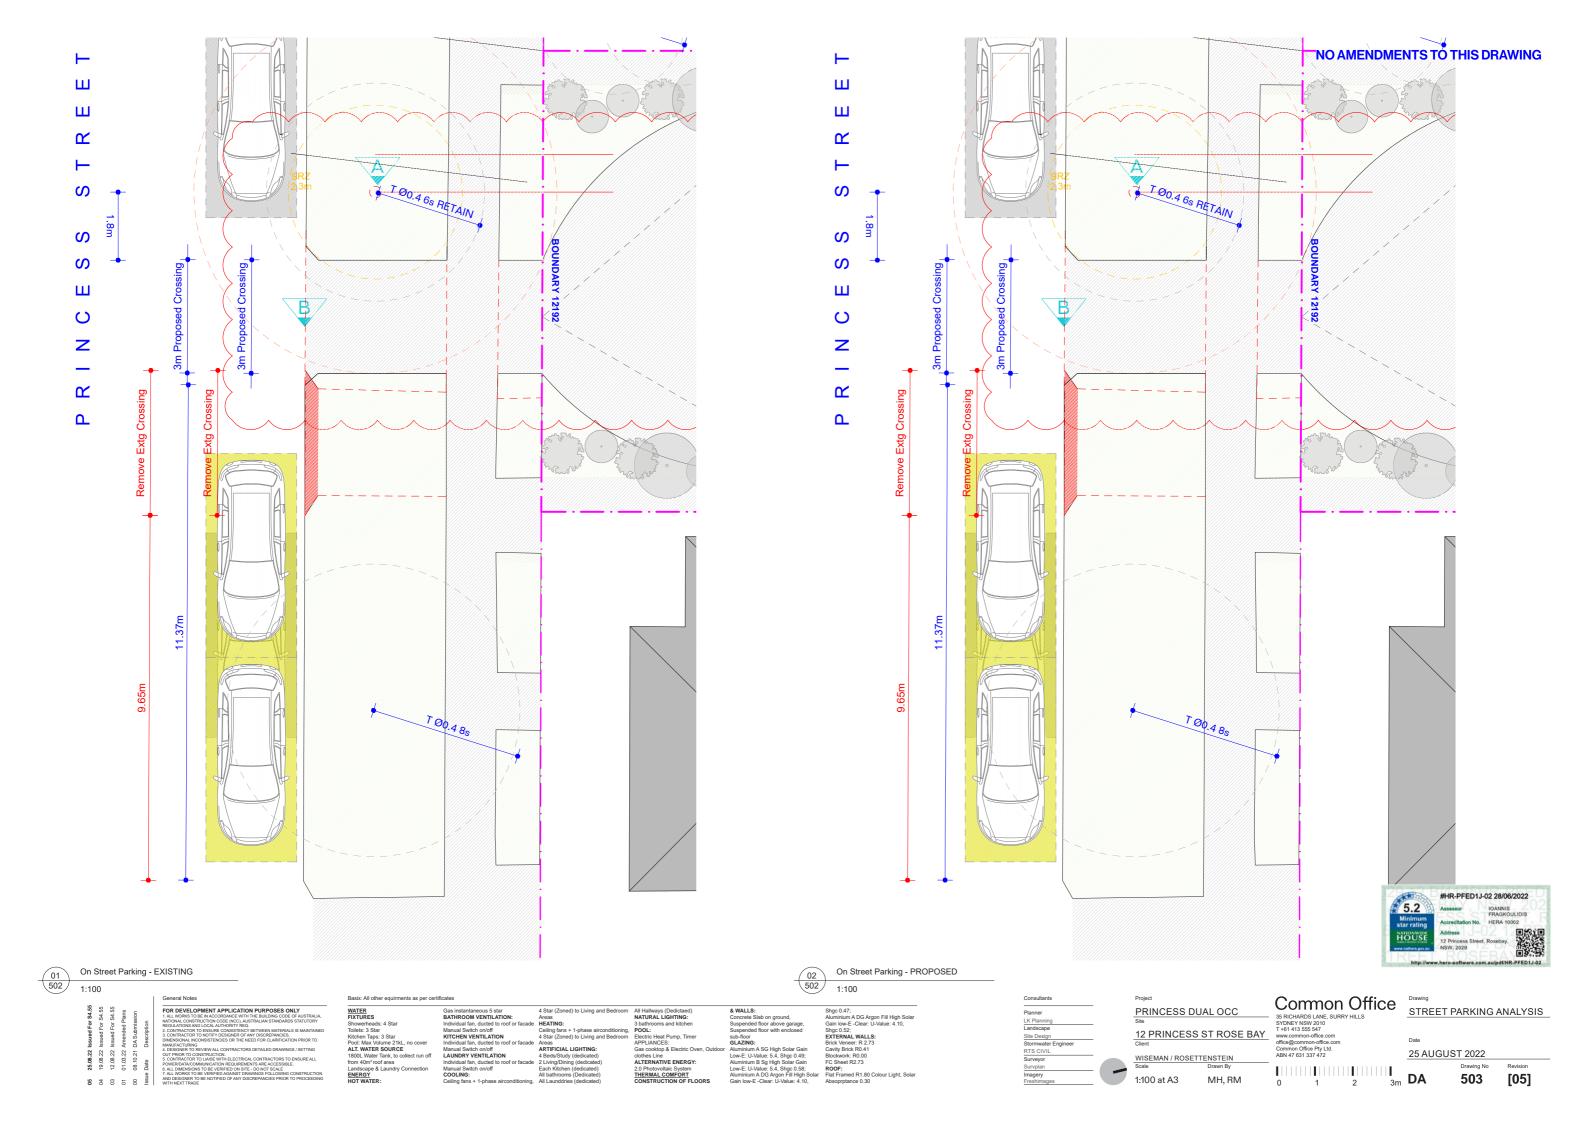

NO AMENDMENTS TO THIS DRAWING

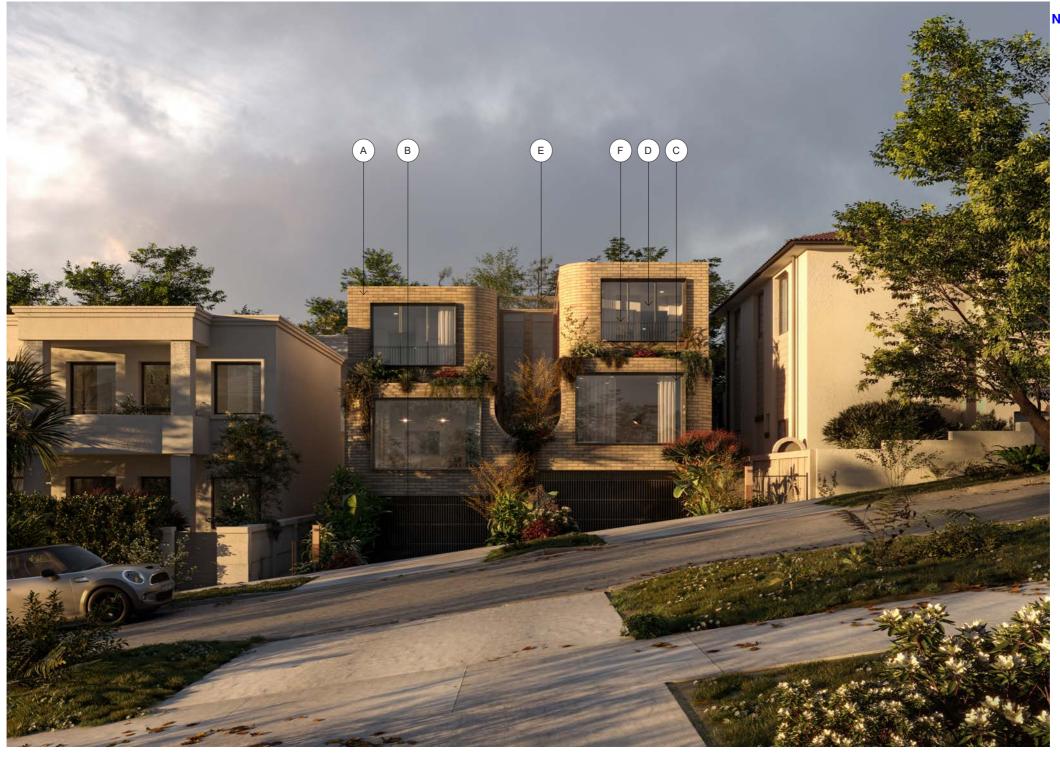





PRINCESS DUAL OCC

MH, RM

1:200 at A3

Common Office

STRICHARDS LANE, SURRY HILLS
SYDNEY NSW 2010
T-61 413 555 547
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DA

Drawing No 600 [05]





PRINCESS DUAL OCC

MH, RM

nts at A3

Common Office


35 RICHARDS LANE, SURRY HILLS
SYDNEY NSW 2010
T-46 1413 555 547
www.common-office.com


Chica@hormony.dfice com

Drawing No Revision [05] DA

RL 53.50 8.5 Ma METAL SCREEN 602 Section A 1:50

<<<<<<<<< First Floor Plan - Courtyard

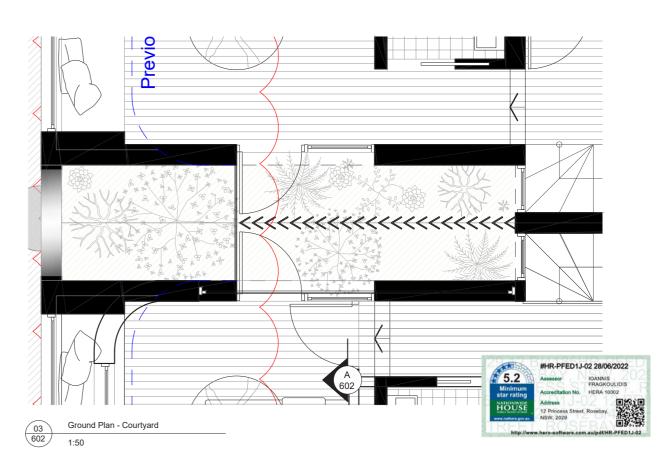

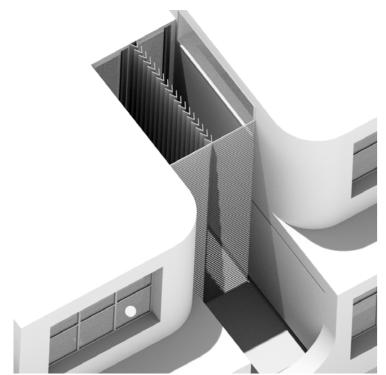

01 602

WATER
FIXTURES
Showetheads: 4 Star
Tollets: 3 Star
Kitchen Taps: 3 Star
Pool: Max Volume 2*IL. no cover
ALT. WATER SOURCE
1800L. Water Tank, to collect run off
from 40m* roof area
Landscape & Laundry Connection
ENERGY
HOT WATER:

7.5 Ma

Shgc 0.47;
Aluminium A DG Argon Fill High Solar
Gain low-E-Clear: U-Value: 4.10,
Shgc 0.52;
ExTERNAL WALLS:
Birkk Veneer: R 2.73
Cavity Birks R0.41
Blockwork: R0.00
FC Sheet R2.73
ROOE:
Falt Framed R1.80 Colour Light, Solar
Absopripance 0.30

PRINCESS DUAL OCC 12 PRINCESS ST ROSE BAY

1:50 at A3

Common Office

3S RICHARDS LANE, SURRY HILLS
SYDNEY NW 2010
T +61 413 555 547
www.common-office.com
office@common-office.com
Common Office Ply Ltd.
ABN 47 631 337 472

Drawing
COURTYARD ANALYSIS
Date

25 AUGUST 2022

NO AMENDMENTS TO THIS DRAWING

602 [05]

BASIX Certificate

Multi Dwelling

Certificate number: 1241426M_02

This certificate confirms that the proposed development will meet the NSW government's requirements for sustainability, if it is built in accordance with the commitments set out below. Terms used in this certificate, or in the commitment have the meaning given by the document entitled "BASIX Definitions" dated 10/09/2020 published by the Department. This document is available at



Certificate Prepared by	
Name / Company Name: Max Brightwell	
ABN (if applicable): 95897024384	

		W	Fixtur	es		Арр	liances		Indi	ividual pool	13	li	ndividual	spa
Dwelling no.	All shower- heads	All toilet flushing systems	kitchen	All bathroom taps	HW recirculation or diversion	All clothes washers	All dish- washers	Volume (max volume)	Pool cover	Pool location	Pool shaded	Volume (max volume)	Spa cover	Spa shaded
All dwellings	4 star (> 4.5 but <= 6 L/min)	3 star	3 star	3 star	no	3		21.0	no	outdoors	no	-	(S)	

	Alternative water source								
Dwelling no.	Alternative water supply systems	Size	Configuration	Landscape connection	Toilet connection (s)	Laundry connection	Pool top-up	Spa top-up	
All dwellings	Individual water tank (no. 1)	Tank size (min) 1800.0 litres	To collect run-off from at least: 40.0 square metres of roof area;	yes	no	yes	-	-	
None	a .	-		100	-	3		-	

	Hot water	Bathroom ventilation system		Kitchen vent	ilation system	Laundry ventilation system		
Dwelling no.	Hot water system	Each bathroom	Operation control	Each kitchen	Operation control	Each laundry	Operation control	
All dwellings	gas instantaneous 5 star	individual fan, ducted to façade or roof	manual switch on/off	individual fan, ducted to façade or roof	manual switch on/off	individual fan, ducted to façade or roof	manual switch on/off	

	Cooling		Heating		Artificial lighting						Natural lighting	
Dwelling no.	living areas	bedroom areas	living areas	bedroom areas	No. of bedrooms &/or study	No. of living &/or dining rooms	Each kitchen	All bathrooms/ toilets	Each laundry	All hallways	No. of bathrooms &/or toilets	Main kitcher
All dwellings	oeiling fans + 1-phase airconditioning 4 star (average zone) (zoned)	ceiling fans + 1-phase airconditioning 4 star (average zone) (zoned)	1-phase airconditioning 4 star (average zone) (zoned)	1-phase airconditioning 4 star (average zone) (zoned)	4 (dedicated)	2 (dedicated)	yes (dedicated)	yes (dedicated)	yes (dedicated)	yes (dedicated)	3	yes

- 3	Individual	pool	Individual	spa			Appliance	es & other effic	iency mea	sures		
Dwelling no.	Pool heating system	Timer	Spa heating system	Timer	Kitchen cooktop/oven	Refrigerator	Well ventilated fridge space	Dishwasher	Clothes washer	Clothes dryer	Indoor or sheltered clothes drying line	Private outdoor or unsheltered clothes drying line
All dwellings	electric heat pump	yes	2	les .	gas cooktop & electric oven	-	no	201		-	yes	yes

	Alternative energy
Dwelling no.	Photovoltaic system (min rated electrical output in peak kW)
All dwellings	2.0

Project name	37721, 12 Princess St_02					
Street address	12 Princess Street Rose Bay 2029					
Local Government Area	Waverley Council					
Plan type and plan number	deposited 4185					
Lot no.	12					
Section no.	-					
No. of residential flat buildings	0					
No. of units in residential flat buildings	0					
No. of multi-dwelling houses	2					
No. of single dwelling houses	0					
Project score						
Water	✓ 40 Target 40					
Thermal Comfort	✓ Pass Target Pas					
Energy						

Specification					Sales Sandard Company	
Project Address:	12 Princess Street Rosebay	-				
BASIX CERTIFICA	ATION NUMBER: 1241426M 2			7		
	ecification outlines ONLY some of the and construction allocations, you document that has been	must refer to the corre			www.aenec.com.au	
		External Walls	Specification:	***		
Туре	Material	Added Insulation	Colour**	Detail		
TO SECULIAR		A CONTRACTOR OF THE PARTY OF TH	Electric and	100000		
Masonry	Concrete Blockwork	Nil	Light	As per drawing	IS	
Masonry	Cavity Brick	R1.60	Light	Ground Floor		
Masonry	Brick Veneer	R2.73	Light	First Floor		
Framed	FC	R2.74	Light	VOID, As per d	rawings	
	22.00	Internal Walls s	enecification:	31-71-0-7-1		
Type	Material	Added Insulation	Colour**	Detail		
Framed	The state of the s		Colour	As per drawing	18	
Masonry Double Brick		Nil	8	Partition walls	, ,	
masoniy	Double Brick	Linii		i di ddoll walla		
		Roof Spec	ification:			
Туре	Material	Added Insulation	Colour**	Detail		
Masonry	Concrete	R4.00	Light	Balcony		
Framed	Metal/CT outer & Plasterboard inner	R4.00+Anticon R1.80	Light	First floor Roof		
Section 19			20/10/20	2202		
		Floors/Ceilings	Specification:			
Туре	Material	Added Insulation	Covering	Detail		
Masonry	Concrete	Nil	As per drawings	Slabs on groun		
Masonry	Concrete	R2.00	As per drawings	DWA KLD GF	Slab on ground only	
Masonry	Concrete	R4.00	As per drawings	to external air	and over BS	
		Window Spe	cification*			
Frame material		Glazing	U Value	SHGC	Detail	
Aluminum		Giazing	5.40 or Lower	0.58+-5%	Refer to NatHERS for more info	
Aluminum			5.40 or Lower	0.49+-5%	Refer to NathERS for more info	
		2	4.10 or Lower	0.49+-5%	Refer to NathERS for more info	
Aluminum Aluminum		1	4.10 or Lower	0.47+-5%	Refer to NathERS for more info	
Aluminum		1	2.90 or Lower	0.51+-5%	Refer to NathERS for more info	
Aluminum		+	2.91 or Lower	0.44+-5%	Refer to NathERS for more info	
Thermeco THC-033	2 02 B		2.05 or Lower	0.58+-5%	HALL FF. Refer to NatHERS	
THETHECO THE-033	J-V2 U	1	Z.05 Of LOWER	U.30+-3%	INALL FF, REIEF TO NATHERS	

Australian Energy Efficiency Consulting E:info@aenec.com.au P:0416 316 204

CAUTION - ALL OF THE ITEMS BELOW MUST BE ADHERED BY FOR NATHERS TO BE VALID

NOTES:

Project

- 1. ALL DOWNLIGHTS TO BE:
 - a. APPROVED NON-VENTILATED
 - b. WITH FIRE-RATED COVER/SHIELD TO ALLOW CONTINUOUS INSULATION LED TYPE. IF HALOGEN LIGHT ARE TO BE INSTALLED THIS CERTIFICATION IS NOT VALID
- 2. ALL VENTS AND WALL OPENINGS INSTALLED TO BE "THE SEALED" TYPE
- 3. ALL INSULATION IS TO BE INSTALLED IN ACCORDANCE NCC PART 3.12.1.1
 - a. CREATION OF CONTINUOUS THERMAL BARRIER
 - b. COMPLIANCE WITH AS4859
 - c. MAINTAINING THICKNESS OF BULK INSULATION AND AIR GAPS FOR REFLECTIVE INSULATION
- 4. BUILDING SEALING AS PER NCC PART 3.12.3
 - a. WEATHER SEALS AND DRAFT EXCLUDERS
 - b. DRAFT STOPPER CAPS

5. SERVICES AS RER NCC PART 3.12.5 a. INSULATION OF SERVICES, PIPING AND DUCTWORK

Nationwide House Energy Rating Scheme — Class 1 Summary NatHERS Certificate No. #HR-PFED1J-02

Generated on 28 June 2022 using Hero 1.2-beta

Property

AENEC

Address 12 Princess Street, Rosebay, NSW, 2029

Lot/DP 12 B/4185

NatHERS climate zone 56 - Mascot AMO

Accredited assessor

IOANNIS FRAGKOULIDIS 4M AUSTRALIA PTY LTD

yanni.frag@gmail.com +61 452648288

Accreditation No. 10002

Assessor Accrediting Organisation HERA

HOUSE ENERGY RATING SCHEME The rating above is the minimum of all dwellings in this summary. www.nathers.gov.au

NATIONWIDE



Verification

To verify this certificate, scan the QR code or visit http://www.hero-software.com.au/pdf/HR-PFED1J-02 . When using either link, ensure you are visiting http://www.hero-software.com.au

Summary of all dwellings

Certificate number and link	Unit Number	Heating load (MJ/m²)	(MJ/m²)	Total load (MJ/m²)	Star
HR-RVJL2P-02	DWA 12 Princess Street Rosebay	38.1	20.6	58.7	5.4
HR-OYR6FF-02	DWB 12 Princess Street Rosebay	37.4	25.7	63.1	5.2
Maximum Loads and Minimum Rating		38.1	25.7	63.1	5.2
Average	2x (Total)	37.7	23.1	60.9	5.3

National Construction Code (NCC) requirements

The NCC's requirements for NatHERS-rated houses are detailed in 3.12.0(a)(i) and 3.12.5 of the NCC Volume Two. For apartments the requirements are detailed in J0.2 and J5 to J8 of the NCC Volume One.

In NCC 2019, these requirements include minimum star ratings and separate heating and cooling load limits that need to be met by buildings and apartments through the Nati+ERS assessment. Requirements additional to the Nati+ERS assessment that must also be satisfied include. but are not limited to: insulation installation methods, thermal breaks, building sealing, water heating and pumping, and artificial lighting requirements. The NCC and NatHERS Heating and Cooling Load Limits (Australian Building Codes Board Standard) are evallable at www.

State and territory variations and additions to the NCC may also apply

REFER TO CORRESPONDING NATHERS CERTIFICATE(S) FOR CORRECT WINDOW SPECIFICATIONS / ALLOCATIONS (SEE AE.05 FORM FOR DETAIL)

Gas instantaneous 5 star BATHROOM VENTILATION Showerheads: 4 Star
Toilets: 3 Star
Kitchen Taps: 3 Star
Pool: Max Volume 21kL, no cover
ALT. WATER SOURCE
1800L Water Tank, to collect run off
from 40m² roof area Landscape & Laundry C ENERGY HOT WATER:

ARTIFICIAL LIGHTING:

Gas cooktop & Electric Oven, Outdoo clothes Line
ALTERNATIVE ENERGY:

2.0 Photovoltaic System
THERMAL COMFORT
CONSTRUCTION OF FLOORS

Shgc 0.47; Δluminium A DG Argon Fill High Solar Aluminium A DG Argon Fill High St Gain low-E-Olear: U-Value: 4.10, Shgc 0.52; EXTERNAL WALLS: Brick Veneer: R 2.73 Cavity Brick R0.41 Blockwork: R0.00 FC Sheet R2.73

PRINCESS DUAL OCC

12 PRINCESS ST ROSE BAY

WISEMAN / ROSETTENSTEIN

nts

Common Office

BASIX SUMMARY

25 AUGUST 2022


DA 700

[05]

S4.55 PLANS

12 PRINCESS STREET, ROSE BAY NSW



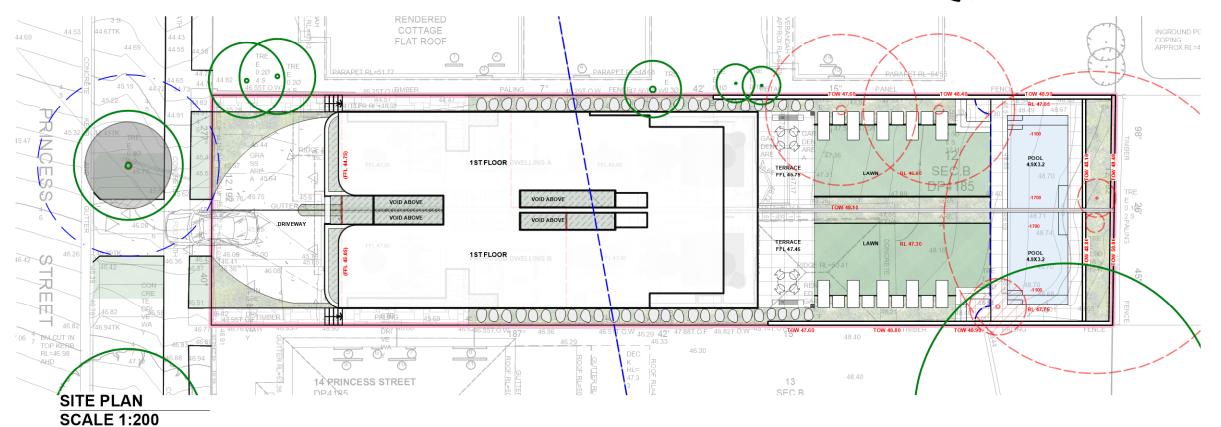



PROJECT LOCATION

LEGEND

DRIVEWAY TURF AREAS DEEP SOIL GARDENS PROPOSED RESIDENCE PROPOSED POOL PAVED AREA SELECTED STONE ON SLAB

SITE CALCULATION

TOTAL SITE AREA : 582 sqm TOTAL LANDSCAPE AREA: 163 sqm/28.0% MIN LANDSCAPE REQ

LANDSCAPE AREA

PROPOSED DUAL OCCUPANCY

12 PRINCESS STREET, ROSE BAY NSW

EXISTING TREE LEGEND



19/08/22 ADDED 1ST FLOOR

DATE COMMENT

AMENDMENTS

Date 19/08/22

L-01

Page

SITE PLAN CALCULATION **SCALE 1:250**

SITEDESIGN +STUDIOS


SYDNEY CITY STUDIO PO BOX 576 DOUBLE BAY 1360 p 1300 22 44 55 info@sdstudios.com.au www.sdstudios.com.au

Project

Drawing Title SITE PLANS

creating places to live in and enjoy

Drawing No. 7106

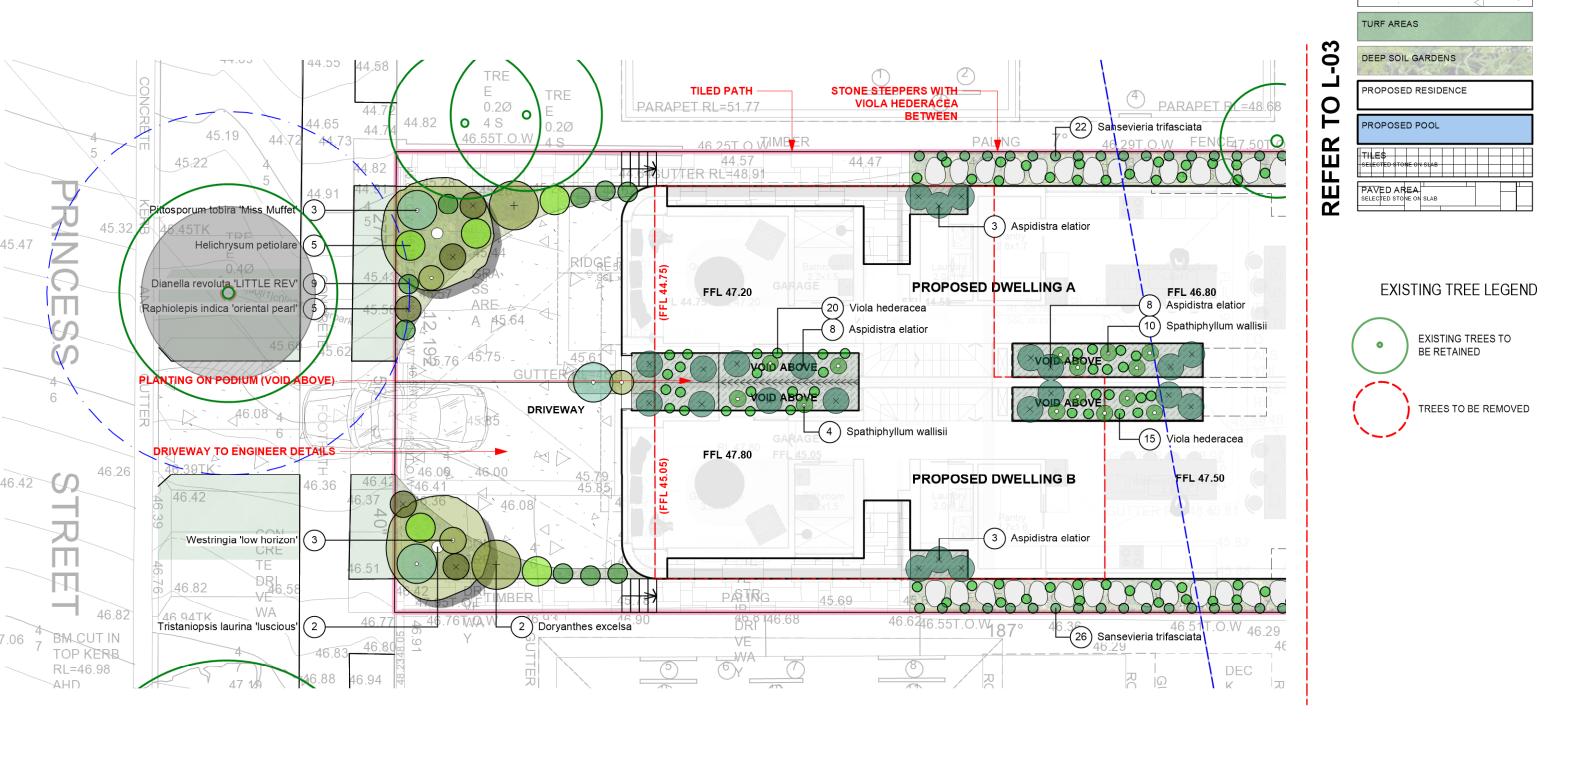

19/08/22 ADDED 1ST FLOOR

ISSUE DATE

COMMENT

Page

L-02

LEGEND


DRIVEWAY

SITEDESIGN +STUDIOS

creating places to live in and enjoy

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PROPOSED DUAL OCCUPANCY Project Address 12 PRINCESS STREET, ROSE BAY NSW Date 19/08/22 Drawing Title FRONT LANDSCAPE PLAN Scale 1:100 Drawing No. **7106**

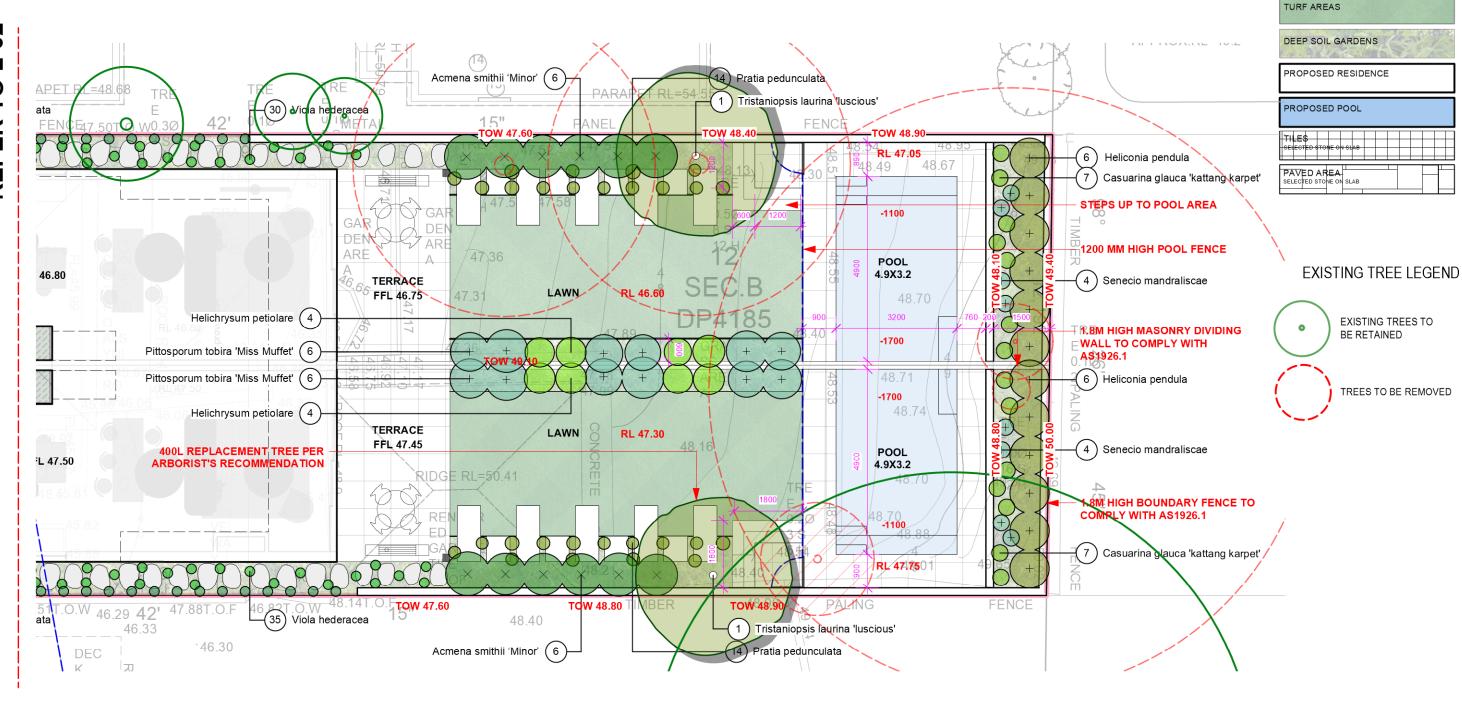

10 M



SITEDESIGN +STUDIOS

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			AMENDMENTS	
1	Project	PROPOSED DUAL OCCUPANCY		│
	Address	12 PRINCESS STREET, ROSE BAY NSW	Date 19/08/22	1_03
	Drawing Title	REAR LANDSCAPE PLAN	Scale 1:100	_ L-0,
1			Drawing No. 7106	_ I

19/08/22 ADDED 1ST FLOOR

COMMENT


L-03


ISSUE DATE

LEGEND

DRIVEWAY

creating places to live in and enjoy

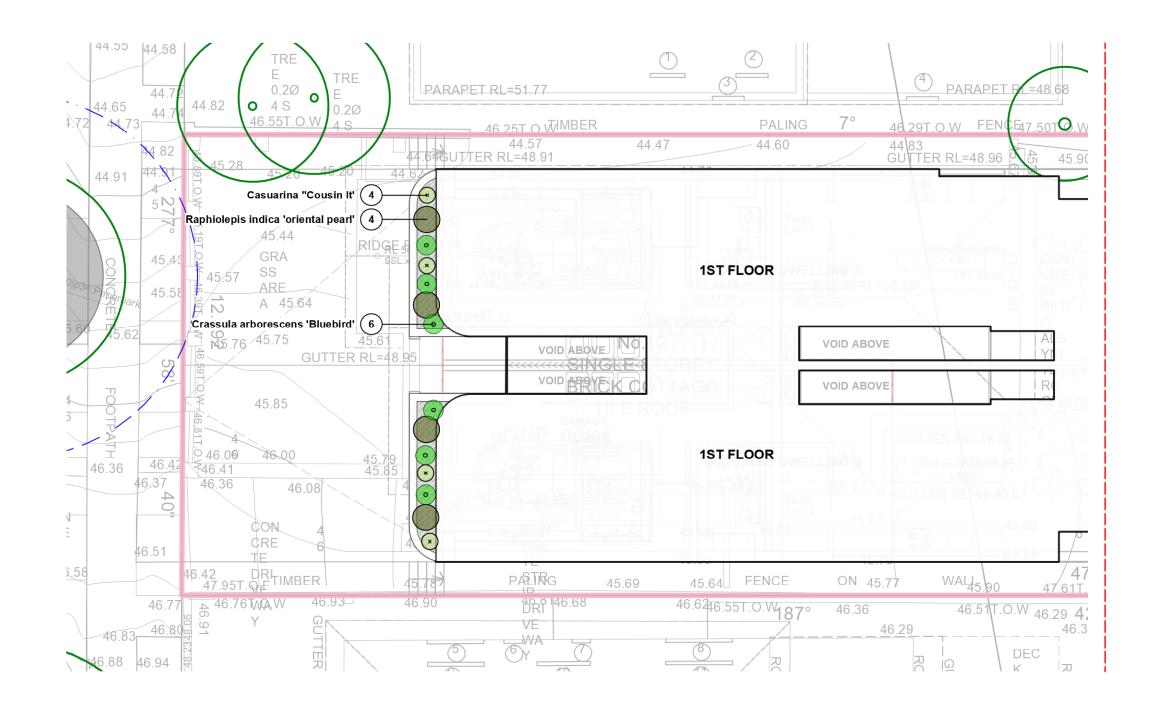

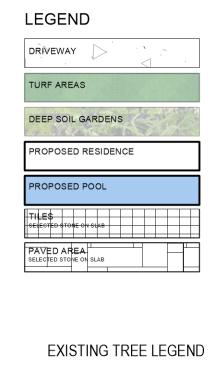



10 M

19/08/22 ADDED 1ST FLOOR ISSUE DATE COMMENT

AMENDMENTS

Page

L-04

SITEDESIGN +STUDIOS

creating places to live in and enjoy

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l	Project	PROPOSED DUAL OCCUPANCY	
	Address	12 PRINCESS STREET, ROSE BAY NSW	Date 19/08/22
	Drawing Title	1ST FLOOR PLAN	Scale 1:100
ı			Drawing No. 7106

PLANTING SCHEDULE **Botanical Name Common Name** Scheduled Size Qty Trees 100L Tris-Lau Kanooka, Water Gum Tristaniopsis laurina 'luscious' TLaur-lus Tristaniopsis laurina 'luscious' Kanooka, Water Gum 400L 2 **Shrubs** Acm-smi Acmena smithii 'Minor' Lillypilly 100mm 12 Hel-pet Helichrysum petiolare liquorice plant 150mm 13 Tristaniopsis laurina luscious Acmena smithii 'Minor' Helichrysum petiolare Heliconia pendula Sansevieria trifasciata Watergum Hel-pen Heliconia pendula Bird Of Paradise 200mm 12 Bird of paradise Snake plant Liquorice plant Pit-tob-mm Pittosporum tobira 'Miss Muffet' 200mm 15 Rap-ind-op Raphiolepis indica 'oriental pearl' Indian Hawthorn 300mm 9 **Ground Covers** Asp-ela 22 Aspidistra elatior Cast Iron Plant 150mm 150mm 4 cas'ci' Casuarina "Cousin It' Casuarina "Cousin It" Cas-gl'kk' Casuarina glauca 'kattang karpet' Kattang karpet 150mm 14 6 Cra-arb Crassula arborescens 'Bluebird' 'Blue Bird' 150mm Pittosporum tobira Raphiolepis 'oriental pearl' Aspidistra elatior Casuarina glauca Westringia low horizon 'Miss Muffet' **Cast Iron Plant** Pra-pe 28 Kattang karpet Coastal rosemary Pratia pedunculata Blue star creeper 150mm 150mm 48 San-tri Sansevieria trifasciata snake plant Blue Chalk Sticks 8 sen-ma Senecio mandraliscae 150mm Spa-sp Spathiphyllum wallisii Peace Lily 150mm 14 Native Violet 150mm 100 vio-he Viola hederacea wes-lh' Westringia 'low horizon' coastal rosmary 200mm 3 **Grasses** DIA 'LR' Dianella revoluta 'LITTLE REV' 150mm 9 Dianella Crassula arborescens Spathiphyllum wallisii Senecio mandraliscae Viola hederacea Doryanthes excelsa 'Blue Bird' Peace Lilly Blue Chalk Stick Native Violet **Gymea Lilly** Dor-exc Doryanthes excelsa Gymea Lily 300mm 2 Climbers **Aquatic Plants Perennials** Ferns MIN TWO OFF 38 X 38 X 1800MM HIGH SPREAD & RAKE MIN. 100MM LAYER OF TURF SIR WALTER TURF ROLLS AS SPECIFIED. LAY ROLLS SO THAT TURF UNDERLAY SOIL (80/20 SAND/SOIL MIX). GRADE TO POINTED HARDWOOD STAKES FINISHES 300MM PROUD OF ADJACENT SURFACES. LIGHTLY COMPACT EDGES TO PREVENT SUBSIDENCE. FINISHED LEVELS & LIGHTLY CONSOLIDATE POSITION TIE ABOVE SUITABLE Casuarina 'Cousin it' Dianella revoluta BRANCH CROTCH LIGHTLY Cousin it 'Litte Rev' **FERTILISE** PLANTING AS RIP SUBGRADE SPECIFIED 50MM WIDE JUTE MESH WEBBING STAPLED TURF DETAIL 80MM MULCH AS SPCIFIED SHRUB REFER TO PLANTING SCHEDULE 80MM DEPTH MULCH (AS SPECIFIED DISHED TO BASE OF TREE) EDGING AS SHOWN ON PLAN STAGGERED PATTERN TO PLANTING HOLE **DENSITIES AS** COMPACTED TOP SOIL **SCHEDULE** CONTAINERISED PLANT AS UP TO 600MM IMPORTED SOIL MIX FOR SHRUBS **CULTIVATE SUB BASE WITH GYPSUM AS** PER PLANTING SCHEDULE SPECIFIED IN CLAY SOILS BACKFILL AND CONSOLIDATE WITH MIN 50MM DEPTH **PLAN VIEW** AS SPECIFIED 1000 X 1000 MULCH EXISTING SUBGRADE BREAK UP AND CULTIVATE TYPICAL TREE PLANTING DETAIL SUBGRADE TO MIN TYPICAL SHRUB PLANTING DETAIL 19/08/22 ADDED 1ST FLOOR

NERAL NOTES

All sorks to be careful out in accordance with the Building Code of Australia, all Local and State Government Ordinances, relevant Australian Standards, Local Authorities Regulations and all other relevant Authorities roomened.

All structural sorks and site drainage to be subject to Engineer's details or certification where required by Council. This shall includer cr. slabs and foolings, r.c. and steel beams & columns, wind brain to \$1.170.

and 43055, eachor rods or boths, the downs, fixings etc., driveway wides and drainage to Council's satisfaction. All timbers to be in accordance with SAA Timber Structure Code AS1720 and SAA Timber Francisco Code AS1824, All work to be carried out in a professional and workman-shiplike manner according to the plans and specification.

NOTE

On rot scale of the drawings submiss otherwise stated and use focused dimensions in preference.

NOTE
Do not coale off the drawings unless otherwise stated and use figured dimensions in preference.
All dimensions are to be decided and verified on site betwe the commencement of any work, all dimensions and levels are subject to final survey and selecut.
No responsibility will be accepted by Sitederigh for any variations in design, builders method of construction or materials used, deviation from specification without permission or accepted we practices resulting in inferior construction. Locate and protect all services prior to construction.

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 Project
 PROPOSED DUAL OCCUPANCY

 Address
 12 PRINCESS STREET, ROSE BAY NSW
 Date 19/08/22

 Drawing Title
 PLANTING DETAILS
 Scale NTS

Page

L-05

Drawing No. **7106**

COMMENT

ISSUE

AMENDMENTS

DATE

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POOL COMPLIANCE NOTES

The design of the swimming pool and associated equipment must comply with the following requirements:

i) The Swimming Pools Act & Regulations.

ii) Australian Standard 1926 Swimming Pool Safety as prescribed under the

Building Code of Australia.

iii) The pump and associated equipment must be sound insulated and/or isolated so

that the noise emitted does not exceed an LAeq (15min) of not more than 5 dB(A) above the background level in any octave band from 31.5Hz to 8KHz centre frequencies inclusive at the boundary of the site

The swimming pool excavation and/or swimming pool must be provided with a suitable barrier to prevent a risk of falling into the excavation or pool at all times throughout the construction phase.

-The measurement of sound must be carried out in accordance with Australian

Standard 1055.1.

-Additional information is available from Sutherland Shire Swimming Pool

Environmental Specification.

-Landscaping and ancillary structures must not intrude into the child-resistant

barrier Non-Climbable Zone.

-Only structures associated with the pool may be located within the pool area.

-Clothes lines, barbeque, sheds, entertainment structure, outside toilets or any other non pool-related structures are not permitted

Before the issue of any Occupation Certificate;

- i) The child resistant barrier must be installed in accordance with A above.
- ii) The swimming pool is to be registered in the NSW Swimming Pool Register.

The pump and associated equipment must be maintained and operated in accordance with the noise levels described above.

ii) The child resistant barrier must be maintained in accordance with the Australian Standard as described above.

PLAN NOTES

This plan should be read in conjunction with the architectural and hydraulics plans. Work specific to these plans should be prepared in accordance to these plans, including

specification and details prior to the installation of landscaping, and should not be altered or compromised during landscape construction

Retaining wall details to engineers design

Elements such as drainage swales may be incorporated in garden bed areas (using non-floatable mulch) without compromising the capacity or form

The Design & location of new letter boxes shall be in accordance with Australia Post's "Requirements for Delivery of Mail to Residential Premises" published Feb '97. All noxious weed listed in Councils weed lists & located on the site shall be continually removed & suppressed. Reinstate all boundary fencing in poor condition with Council approved 1.8m fencing to rear of building line, rake to 1m forward of BL. Pollution, sediment & erosion control devices as specified shall be in place, and maintained for the duration of the construction period Proposed excavation near existing established trees to be supervised by arborist

This plan has been prepared for DA approval only, not for construction.

Planting proposed using commercially available plant species selected from local planting lists and the BASIX local plant list

D.A approved landscape plan's are required to be constructed as approved to obtain occupancy certificate.



LANDSCAPE MAINTENANCE NOTES

MONTH	MOWING EDGING BLOWING	FERTILISING (SEASOL)	CHECK	HAND WEED REMOVAL	PRUNING	WEED SPARAYING	WATERING/ IRRIGATION	PLANT REPLACEMENT IF REQUIRED
DEC	W	М	M	W	F	М	D	W
JAN	W	М	M	W	F	М	D	W
FEB	W	М	М	W	F	М	D	W
MAR	F	М	M	F	M	М	D	W
APR	F	N/A	M	F	M	М	D	W
MAY	F	N/A	М	М	M	М	D	W
JUNE	М	N/A	М	М	N/A	N/A	2ND D	W
JULY	M	N/A	M	М	N/A	N/A	2ND D	W
AUG	М	N/A	М	М	N/A	N/A	2ND D	W
SEP	M	М	М	М	N/A	N/A	2ND D	W
OCT	F	F	M	F	M	М	D	W
VOV	F	F	М	F	M	M	D	W

EXTERNAL LIGHTING - (AMENITY)

To ensure that any lighting on the site does not cause a nuisance to neighbours or motorists on nearby roads:

Design

All lighting must be designed in accordance with Australian Standard AS4282 - Control of the Obtrusive Effects of Outdoor

Ongoing

All lighting must be operated and maintained in accordance with

PROPOSED DUAL OCCUPANCY

12 PRINCESS STREET, ROSE BAY NSW

MAINTENANCE GENERAL NOTES

SECTION C: LANDSCAPE MAINTENANCE SPECIFICATION 1.0 SCOPE 1.1 PERIOD

The 52 week Planting Establishment Period commences at the date of registration of the repective plan.

The contractor is to also allow for maintenance from the date of Practical Completion to the start date of the 52 week Planting Establishment Period. The allowance shall be for a weekly rate which will then be implemented until the formal maintenance period commences.

1.2 PROGRAM

Furnish a proposed planting maint 1.3 MAINTENANCE LOGBOOK

Contractor to keep a maintenance record of works carried out on a monthly basis. Log should include but not limited to: - Activities carried out during each attendance;

- Irregularities encountered and actions taken;

NB: Maintenance payments will be evaluated on submission of monthly logbooks 1.4 RECURRENT WORKS

1.4 RECURRENT WORNS
Throughout the Planting Establishment Period, continue to carry out recurrent works of a maintenance nature including, but not limited to, watering, mowing, weeding, rubbish removal, fertilising, pest and disease control, staking and tying, replanting, cultivating, pruning and keeping the site neat and tidy. All rubbish related to landscape works shall be emoved by the landscape contractor before it is allowed to accumulate

stock arriving on site is protected and maintained for healthy growth 1.6 REPLACEMENTS
Continue to replace failed, damaged or stolen plants for the extent of the Planting

Establishment Period.

1.7 MULCHED SURFACES

Maintain the surface in a clean and tidy condition and reinstate the mulch as necessary. 1.8 GRASSED AREAS

Commence grass maintenance works at the completion of turfing, and continue to carry out grass maintenance throughout the contract and Planting Establishment Period, maintaining healthy weed free growth
1.9 STAKES AND TIES

Adjust or replace as required. Remove those not required at the end of the Planting Establishment Period.

1.10 WATERING/ IRRIGATION

An irrigation system is to be installed to all mass planted beds and new tree planting, connected to a pump and the rainwater tank /OSD tank. Install one tap near the front boundary (Wurrook Circuit) and one tap on the rear (eastern) boundary. This system shall be installed and maintained for the duration of the maintenance period (52 weeks) and in perpetuity of the development. All irrigation works shall be performed by a licensed irrigation contractor. Materials to be used are to be submitted to the site superintendent for approval The contractor shall provide design drawings and material specifications/samples prior to commencing work. All works are to be conducted to all current and relevant Australian

The contractor is to be completely responsible for the coordination of the installation of the irrigation system with other services throughout the site. Recommended flow rates: The system shall be set up on a trial basis and them adjusted to suit the local requirements and conditions. Once the system is satisfactorily adjusted the contractor shall make fortnightly visits within the establishment period to ensure satisfactory performance of the system and to adjust the watering periods as required. A minimum even coverage of 25mm of water per

2.1 LANDSCAPE MAINTENANCE REPORT

Landscape Maintenance Reports' shall be submitted to the Principle Certifying Authority by the contractor verifying that satisfactory maintenance of the landscape works has been undertaken and that any necessary rectification measures have been carried out to a high professional standard. This documentation is to be submitted through the plant establishme period.

19/08/22 ADDED 1ST FLOOR

ISSUE DATE COMMENT

AMENDMENTS

Scale NTS

Page

Date 19/08/22

L-06

to ined out in accordance with the Building Code of Australia. all Local and State Government Ordinances, relevant Australian Standards, Local Authorities Regulations and all other Resevant Autonomes concerned.

All structural work and site drainage to be subject to Engineer's details or certification where required by Council. This shall include r.c. slabs and footings, r.c. and steel beams & columns, wind brown to the control of the con

A & 1170 and A4055, anchor rods or bolls, its downs, fixings etc., driveway slabs and drainage to Council's satisfaction. All timbers to be in accordance with SAA Timber Structure Code AS1720 and SAA Timber Framing Code AS 1884. All work to be carried out in a professional and workman- anjoine manner according to the plans and specification.

OIE
on stocke off the drawings unless otherwise stated and use figured dimensions in preference.
If dimensions are to be discited and verified on site before the commencement of any vork, all dimensions and levels are subject to final survey and self-out
or esponsibility will be accepted by Stedesign for any variations in design, builder's method of construction or materials used, deviation from specification with
actices resulting in interfer construction. Locate and protect all services prior to construction.

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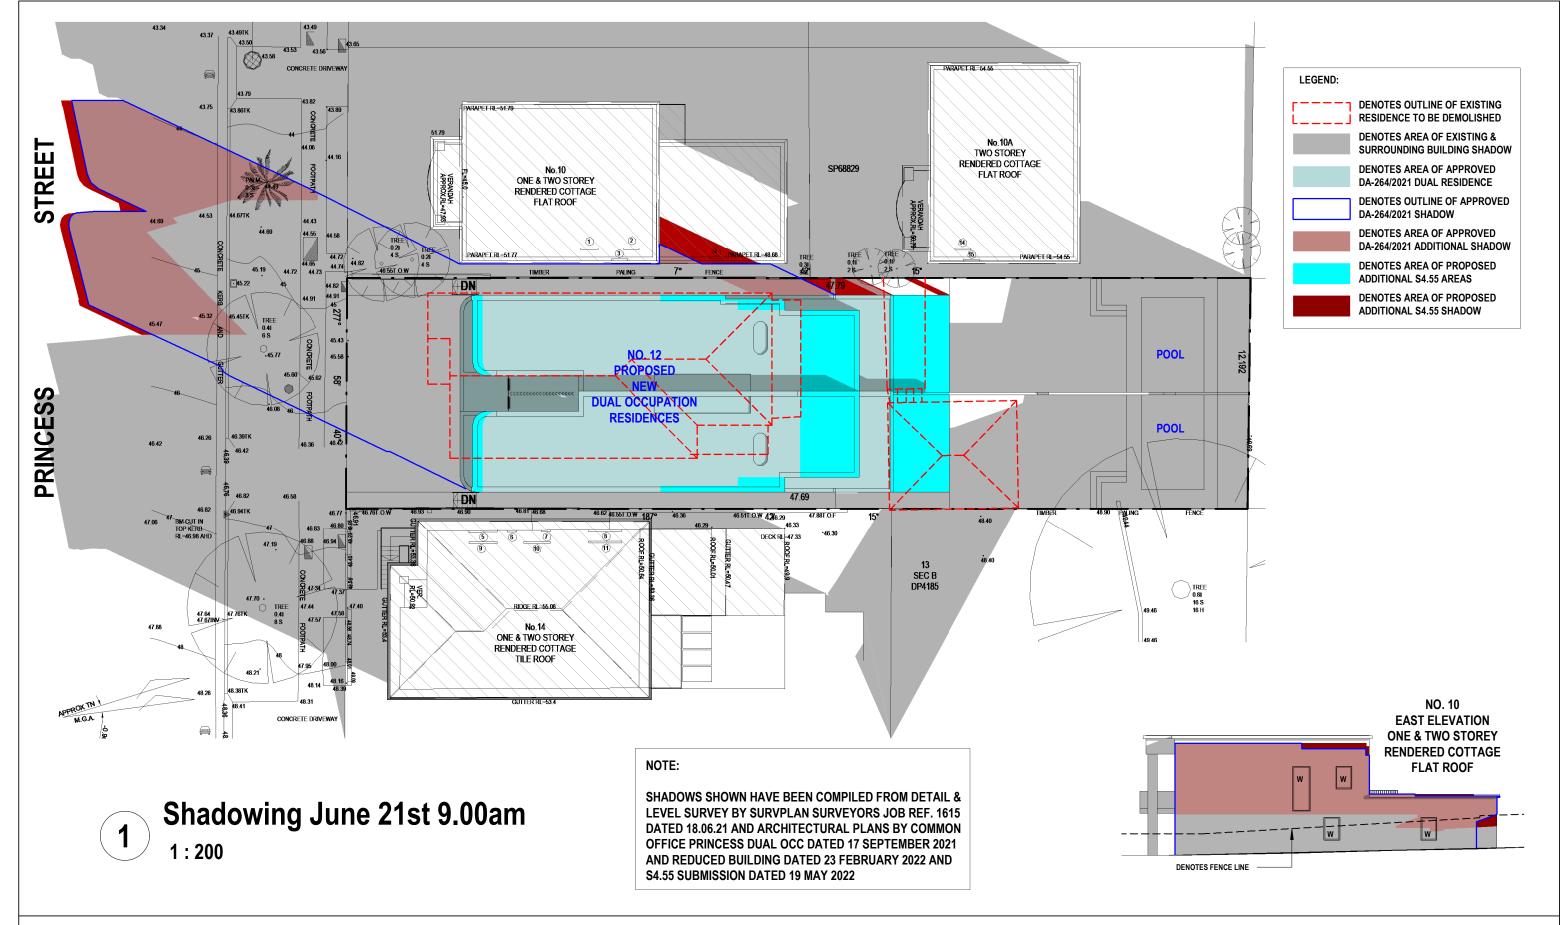
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Drawing Title NOTES

Project

Address

Drawing No. **7106**




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ABN 27 083 288 153	PH: 9555 8545
SUITE 1, 505 BALMAIN ROAD, LILYFIELD, NSW 2040	info@caddraftnsw.com.au

No.	Description	Date

CLIENT: WISEMAN / ROSETTENSTEIN

Shadowing June 21st 9.00am			
Project number	21-105		
Date	08-08-2022	Δ	\100
Drawn by	KP		
Checked by	JD	Scale	1 : 200

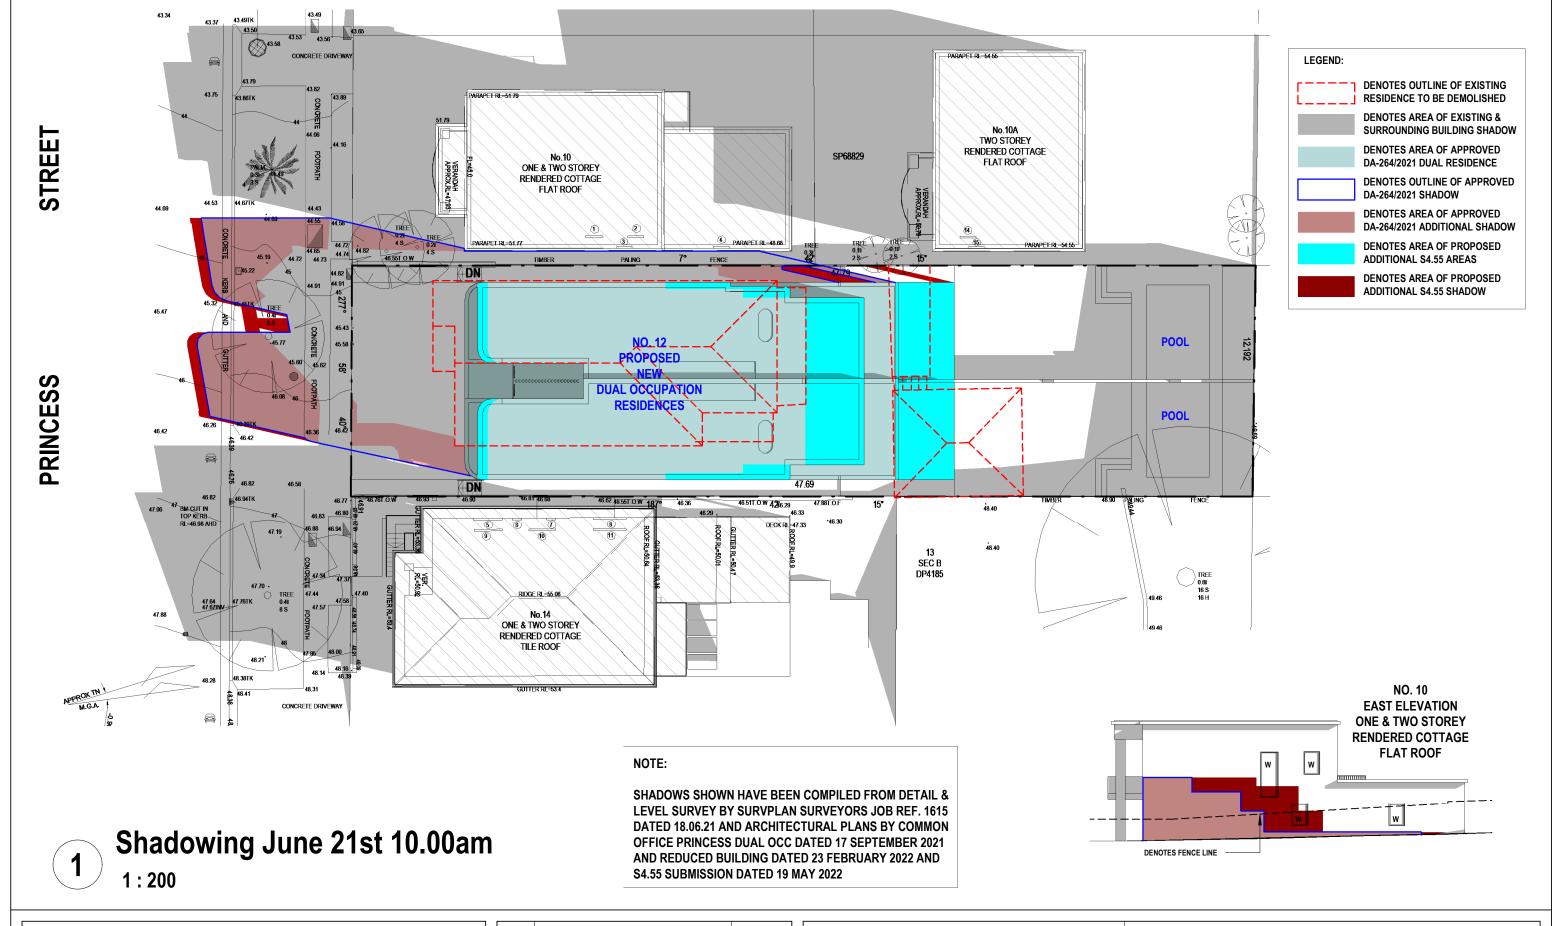


No.	Description	Date

S.4.55 SHADOW DIAGRAMS
No. 12 PRINCESS STREET
ROSE BAY

	CLIENT: WISEMAN	/ ROSETTENSTEII
ı	CLIENT. WISEINAIN	/ KUSETTENSTEIL

Shadowing June 21st 10.00am			
Project number	21-105		
Date	08-08-2022	A1	01
Drawn by	KP		• •
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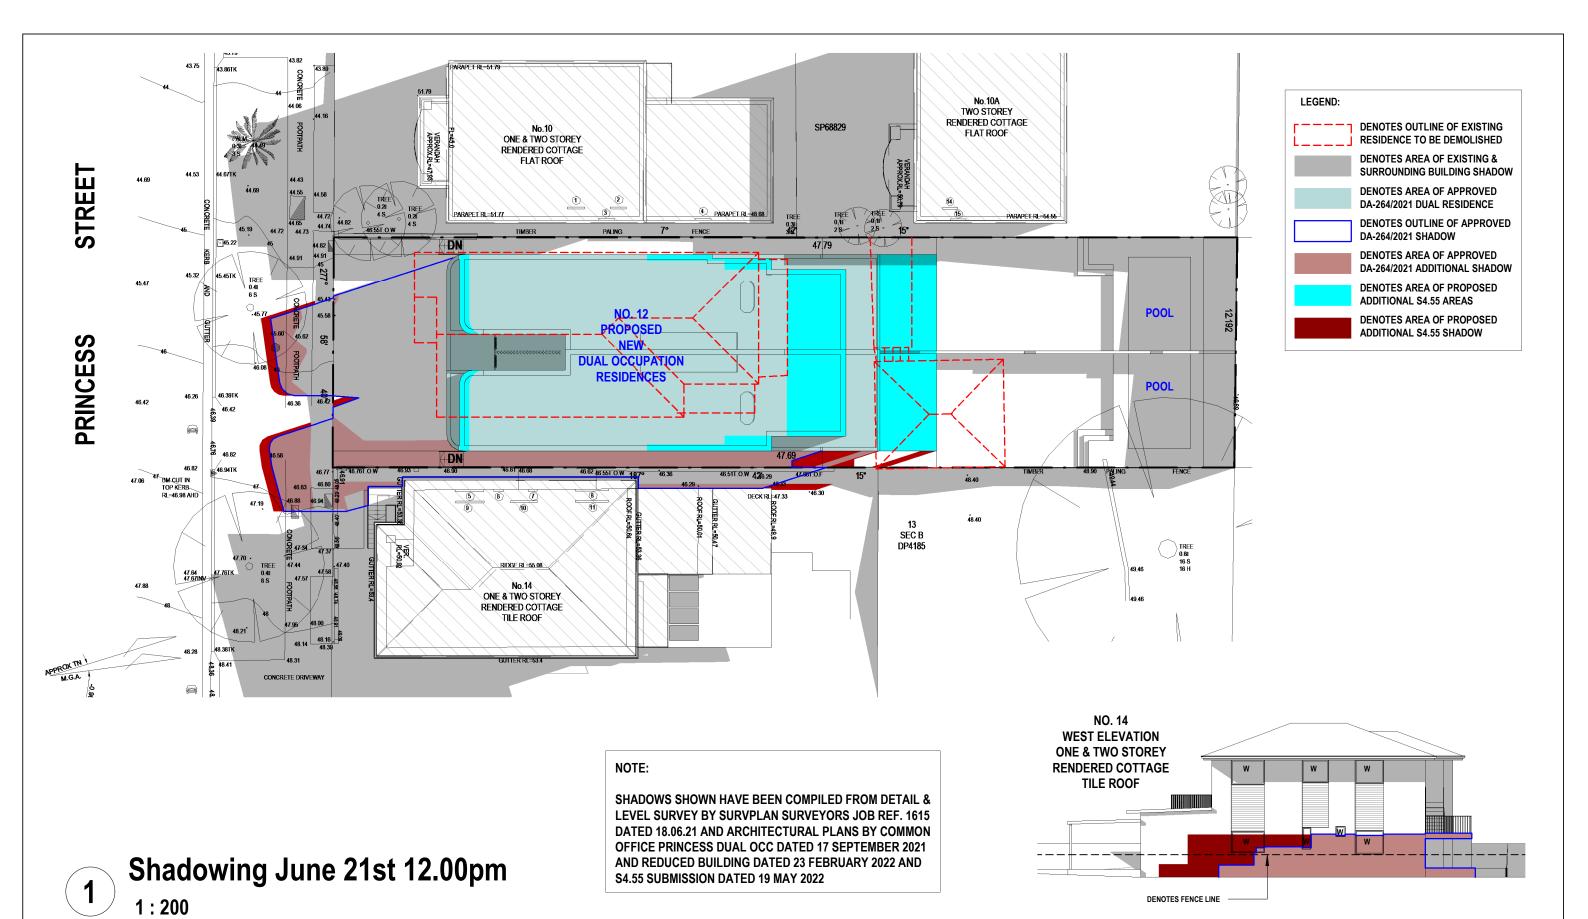

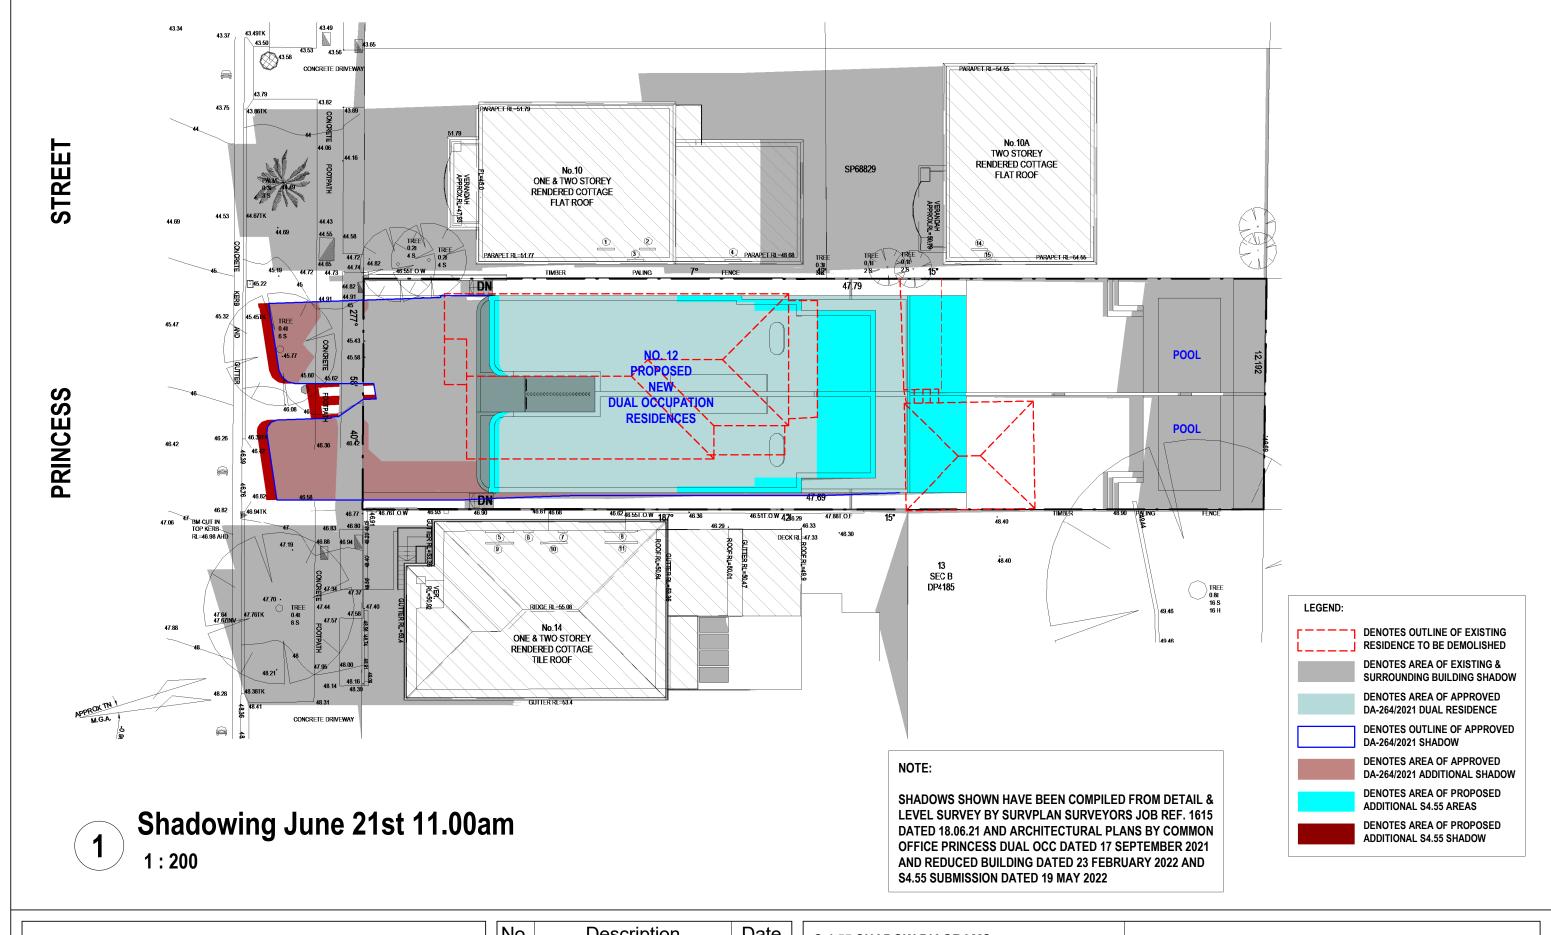
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SUITE 1, 505 BALMAIN ROAD, LILYFIELD, NSW 2040	info@caddraftnsw.com.au

No.	Description	Date

CLIENT: WISEMAN	/ ROSETTENSTEIN

Shadowing June 21st 11.00am			
Project number	21-105		
Date	08-08-2022	Α1	102
Drawn by	KP		
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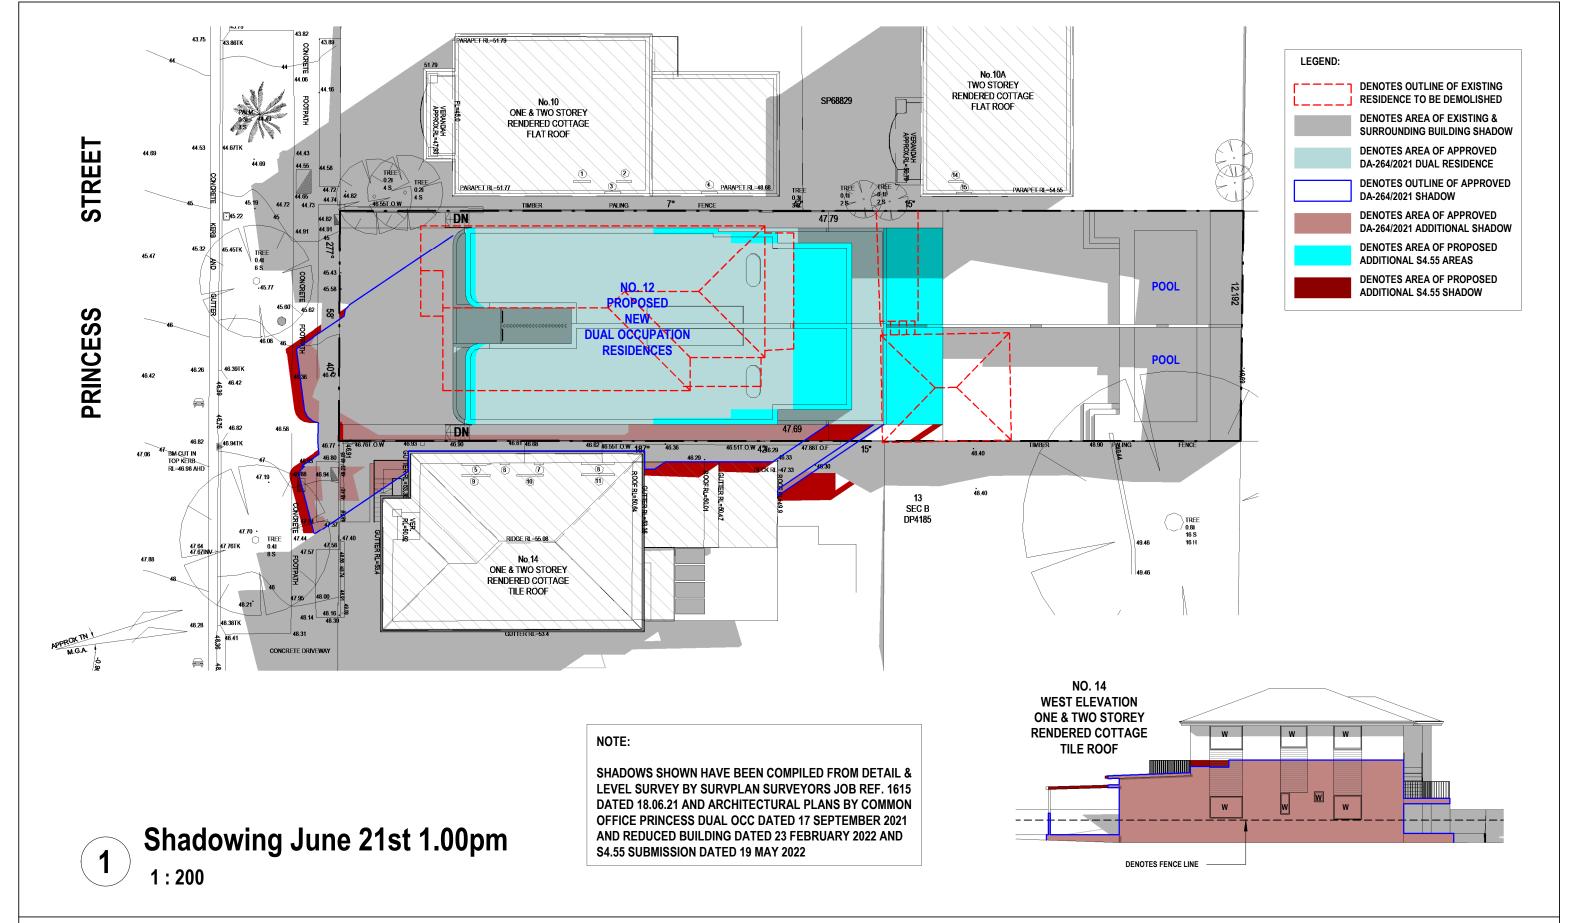


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No.	Description	Date

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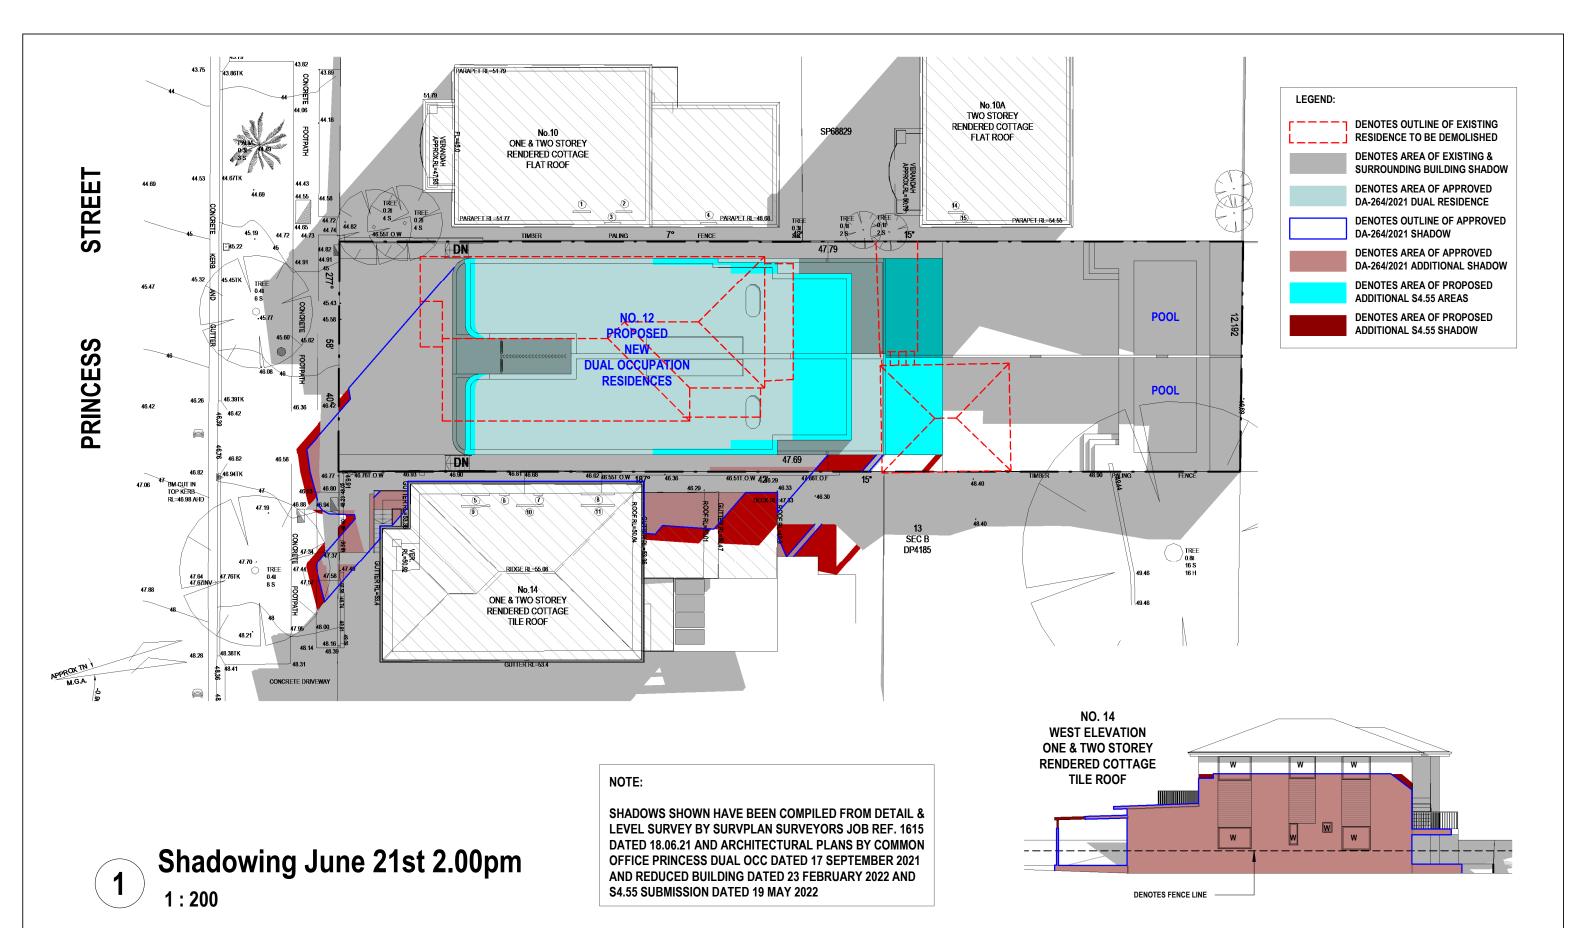
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Project number	21-105		
Date	08-08-2022	A1	103
Drawn by	KP		
Checked by	JD	Scale	1 : 200



No.	Description	Date

l	CLIENT: WISEMAN /	ROSETTENSTEIN
- 1		


Shadowing June 21st 1.00pm			
Project number	21-105		
Date	08-08-2022	A 1	104
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No.	Description	Date

	CLIENT: WISEMAN	/ ROSETTENSTEII
ı	CLIENT. WISEINAIN	/ KUSETTENSTEIL

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Project number	21-105		
Date	08-08-2022	Δ	105
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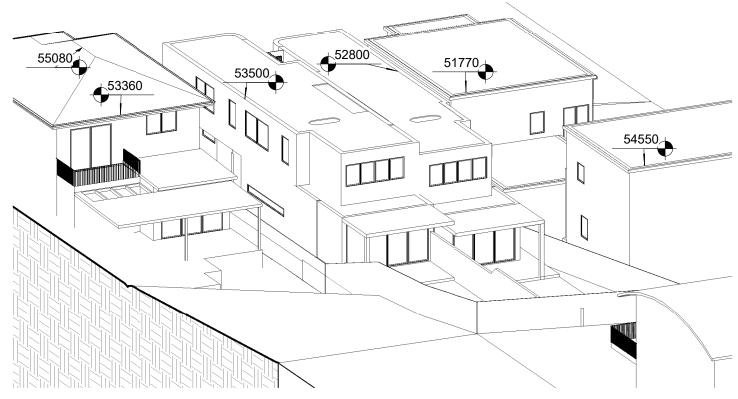


No.	Description	Date

	l	CLIENT: WISEMAN	ROSETTENSTE
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Shadowing June 21st 3.00pm		m	
Project number	21-105		
Date	08-08-2022	A	106
Drawn by	KP]	
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2 June 9.00am S4.55
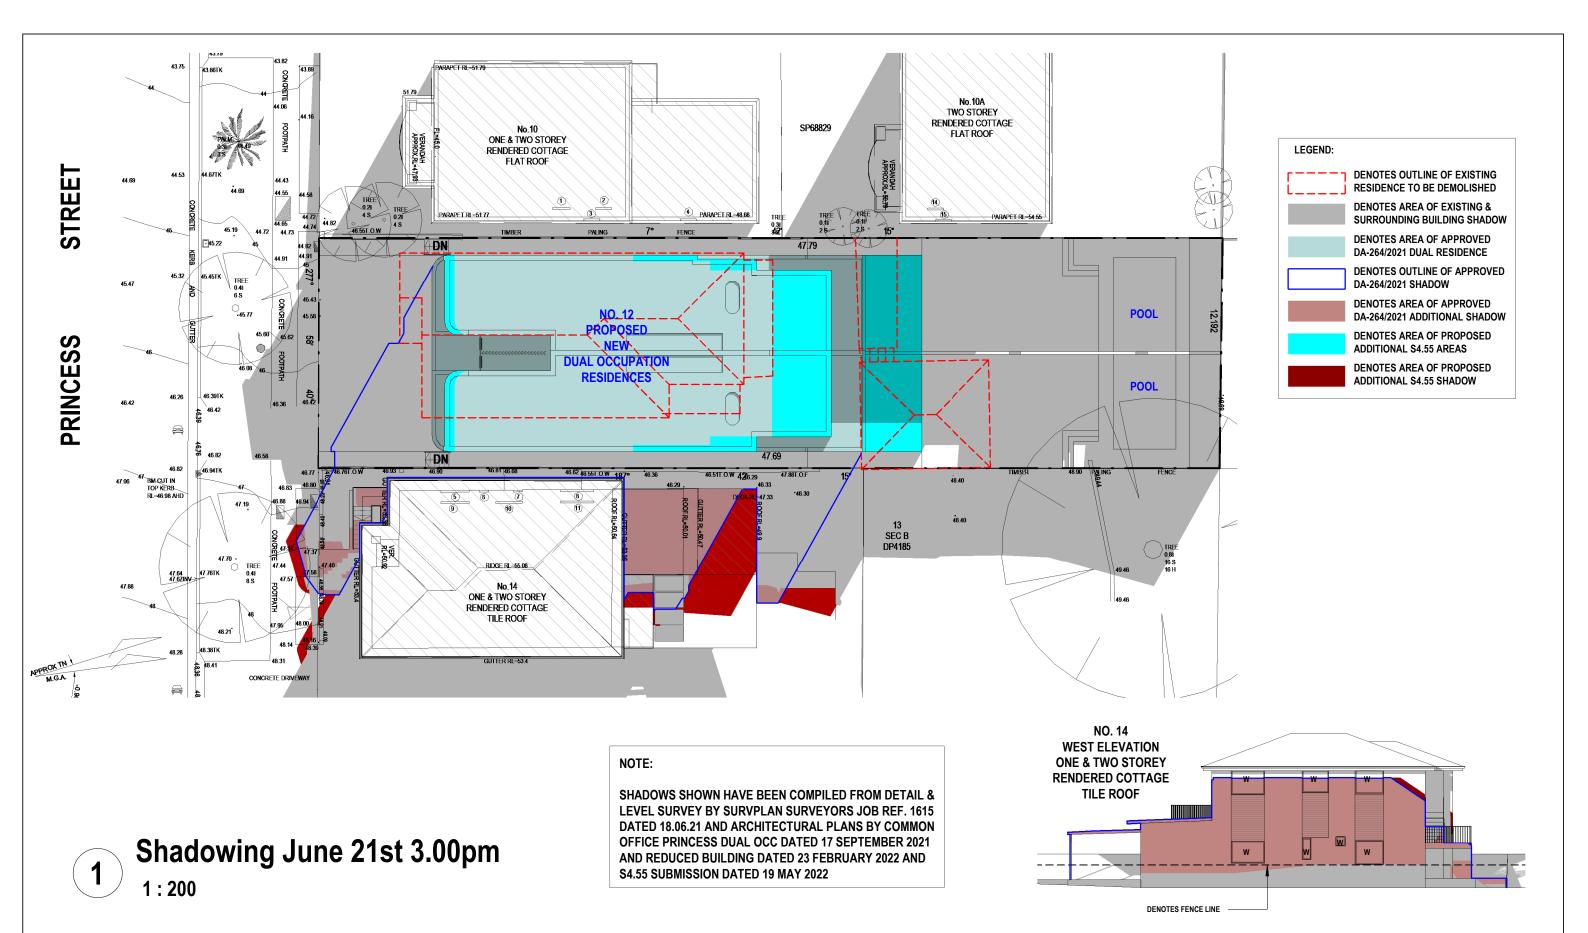
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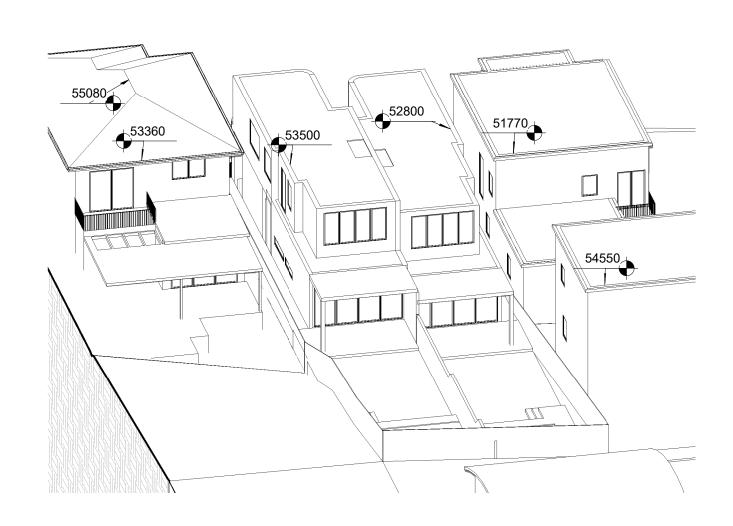
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No.	Description	Date
	1	

S.4.55 SHADOW DIAGRAMS
No. 12 PRINCESS STREET
ROSE BAY

CLIENT: WISEMAN / ROSETTENSTEIN

View from	Sun June	21st 9.00am



55080
53360
53500
51770
54550

Drawn by

Checked by

June 10.00am S4.55

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June 10.00am Approved

Description

Date

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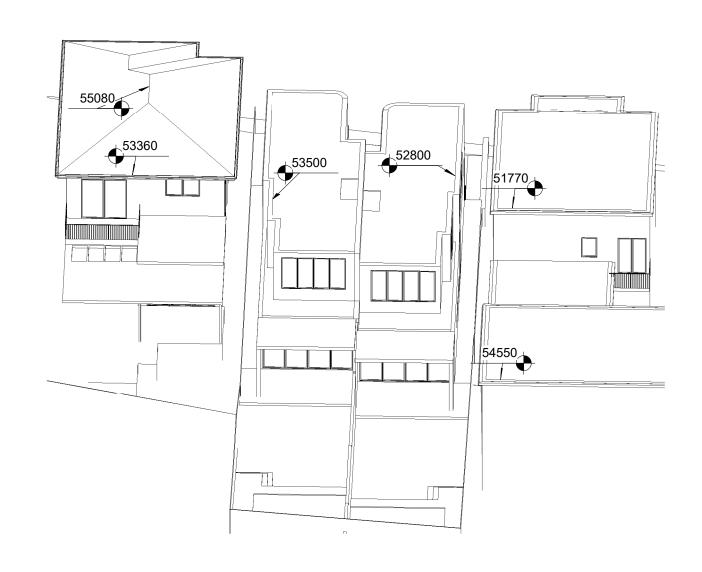
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View from	Sun Jun	e 21st 10.00am
Project number	21-105	
Date	08-08-2022	A108

JD Scale

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08/08/2022 16:06:59



53360 53500 51770

June 11.00am S4.55

June 11.00am Approved

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SUITE 1, 505 BALMAIN ROAD, LILYFIELD, NSW 2040 No. Description Date

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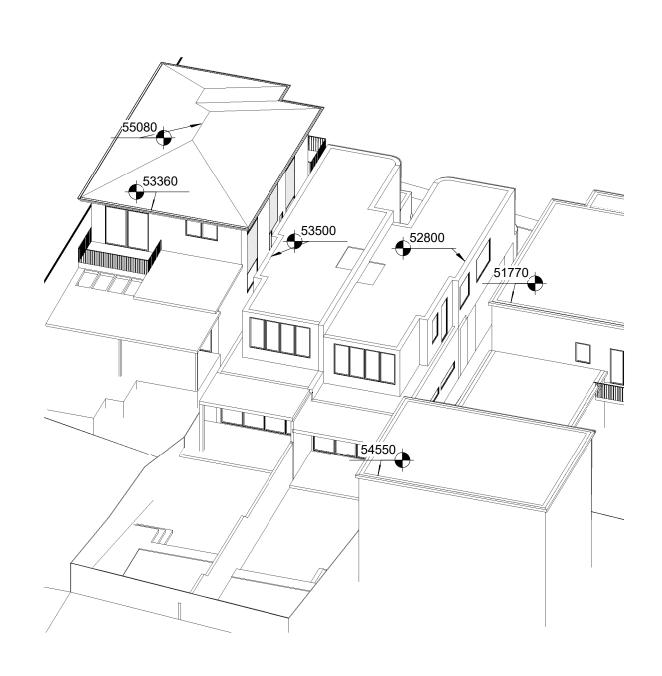
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 Project number
 21-105


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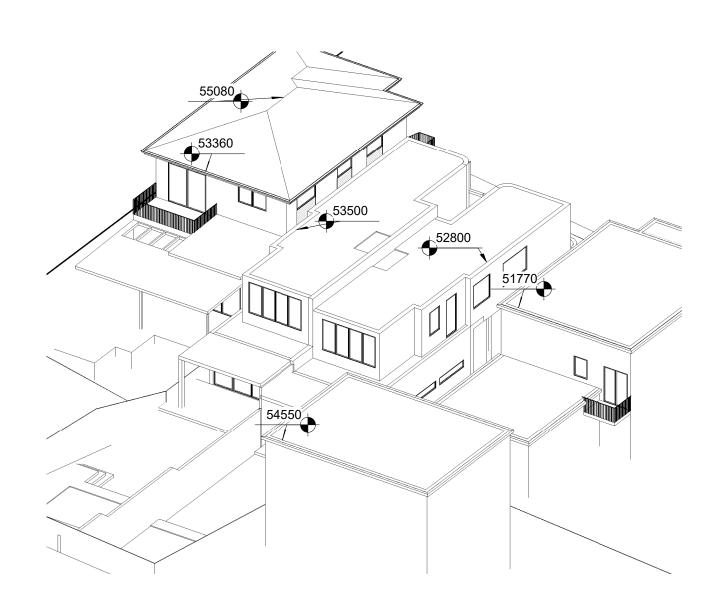
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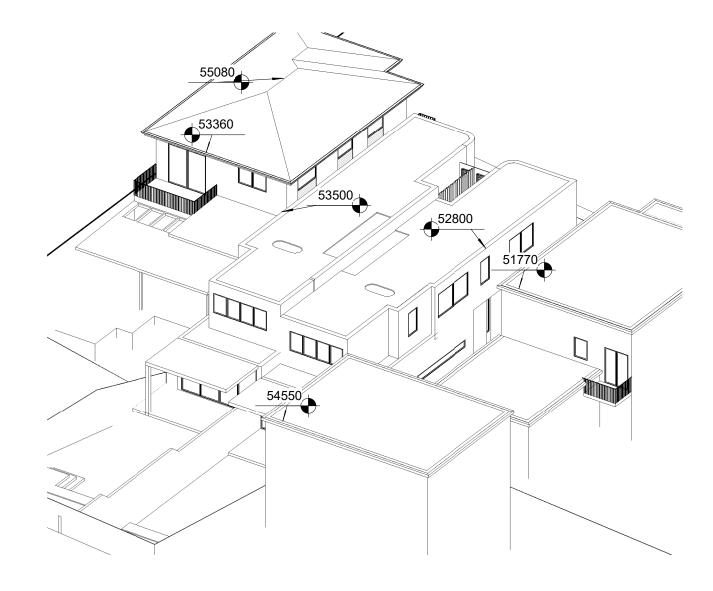
S.4.55 SHADOW DIAGRAMS No. 12 PRINCESS STREET **ROSE BAY**

CLIENT: WISEMAN / ROSETTENSTEIN

View from Sun June 21	st 12.00pm
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Project number	21-105	
Date	08-08-2022	A110
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2 June 1.00pm S4.55

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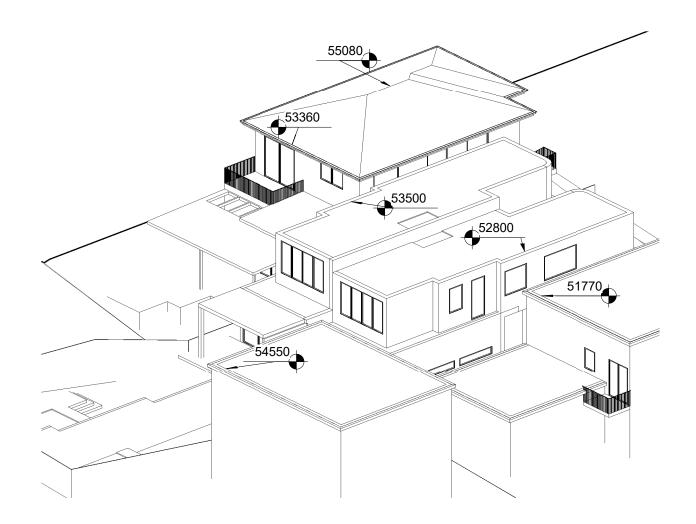
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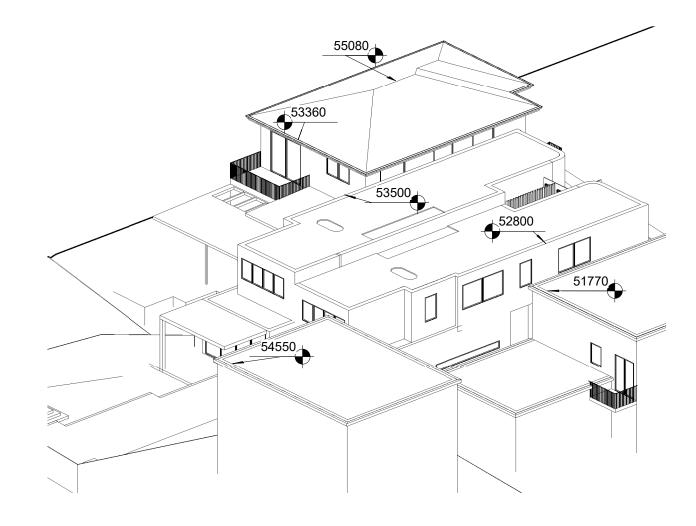
CLIENT: WISEMAN / ROSETTENSTEIN

View from Sun June 21st 1.00pm		
Project number	21-105	
Date	08-08-2022	A111
Drawn by	KP	
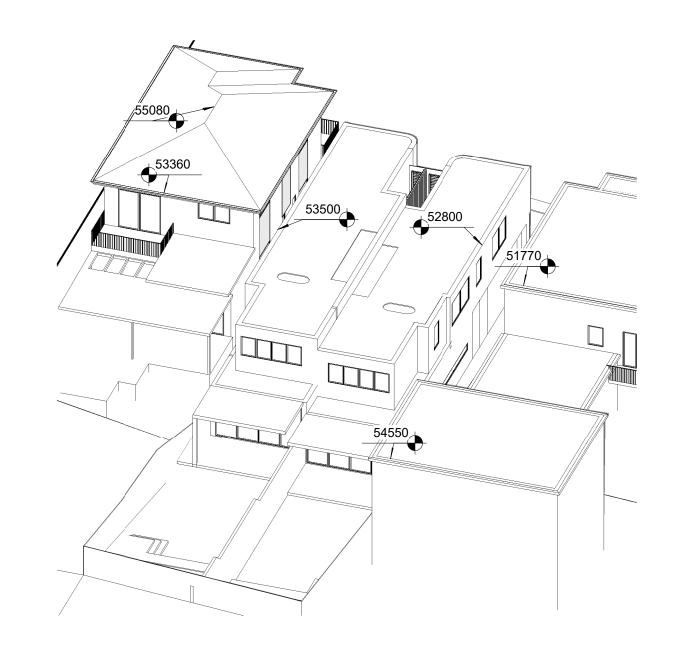
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2 June 2.00pm S4.55

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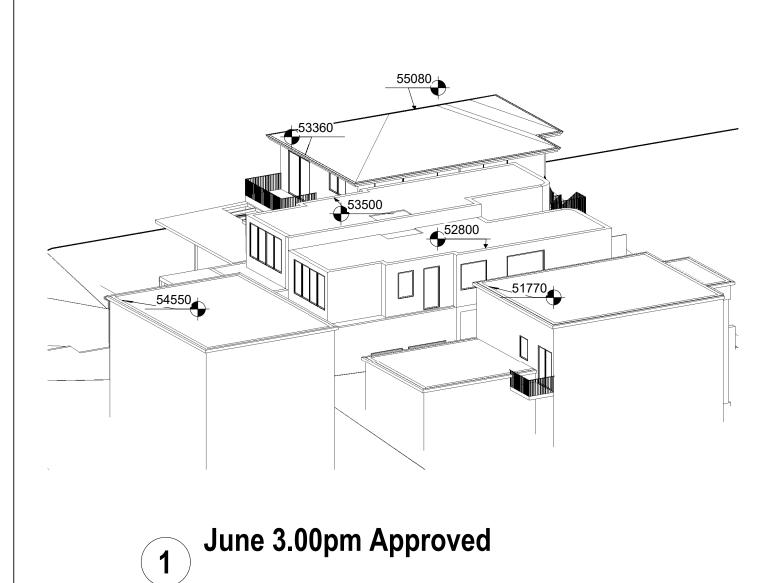
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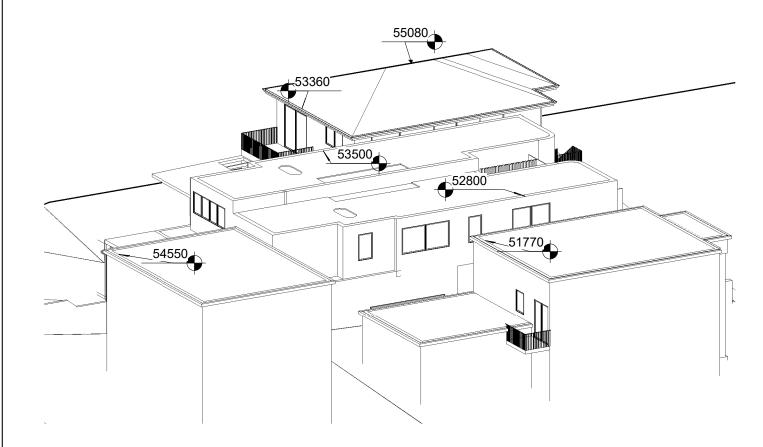
S.4.55 SHADOW DIAGRAMS No. 12 PRINCESS STREET **ROSE BAY**

CLIENT: WISEMAN / ROSETTENSTEIN

View from Sun June 21st 2.00pm		
Project number	21-105	
Date	08-08-2022	A112
Drawn by	KP	

JD Scale





June 3.00pm S4.55

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No.	Description	Date
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S.4.55 SHADOW DIAGRAMS No. 12 PRINCESS STREET **ROSE BAY**

CLIENT: WISEMAN / ROSETTENSTEIN

View from Sun June 21st 3.00pm			
Project number	21-105		
Date	08-08-2022	A113	
Drawn by	KP		
Checked by	JD	Scale	





Report to the Waverley Local Planning Panel

Application number DA-334/2022		
Site address	100 Francis Street, BONDI BEACH NSW 2026	
Proposal	Alterations and additions to dwelling including new first floor addition	
Date of lodgement	17 August 2022	
Owner	Mr M S Bland, Mrs J S Bland	
Applicant	Mr S A P Bland	
Submissions	Two	
Cost of works	\$475,200	
Principal Issues	 Overall building height Bulk and scale Front predominant building line Overshadowing impacts 	
Recommendation That the application be REFUSED for the reasons contained in the		

SITE MAP



(Source: Near map,2022)

1. PREAMBLE

1.1. Executive Summary

The development application seeks consent for alterations and additions to the existing dwelling including new first floor addition at the site known as 100 Francis Street, Bondi Beach.

The principal issues arising from the assessment of the application are as follows:

- Noncompliance with overall building height standard
- Noncompliance with front predominant building line control
- Unreasonable overshadowing impacts on neighbouring property
- Bulk and scale

The assessment finds these issues unacceptable. The proposed overall building height is 10.6m measured from the existing ground level, which is 21% of what is permitted, being 8.5m. The proposed exceedance in building height causes unreasonable overshadowing impacts to the neighbouring property (98 Francis Street), into their principal open and habitable areas and therefore does not preserve their environmental amenity. The proposed front balcony on the first floor is also non-compliant in regard to the front predominant building line and results in adverse visual bulk and scale impacts from a streetscape perspective and on the existing dwelling itself.

A total number of two submissions were received and the issues raised in the submissions have been considered and addressed in this report and in the Recommendation.

The application has been assessed against the relevant matters for consideration under section 4.15(1) of the *Environmental Planning and Assessment Act 1979*. It is recommended for refusal.

1.2. Site and Surrounding Locality

A site visit was carried out on 28 September 2022.

The site is identified as Lot 4 in DP 9638, known as 100 Francis Street, BONDI BEACH. The site is rectangular in shape with a north front boundary measuring 12.19m, east side boundary measuring 24.13m, south rear boundary measuring 12.19m and west side boundary measuring 24.125m. The site has an area of 294.2 m² and the site falls from the south-west (rear) towards the north-east (front) by approximately 3.5m.

The site is occupied by a single storey detached dwelling with sub-floor, workshop and garage below with vehicular access provided from Francis Street to a garage located at the front of the site, adjacent the sites western side boundary. The dwelling is set on the site at an elevated level with a subfloor below. The subject site is adjoined by semi-detached dwellings on either side. The locality is characterised by a variety of residential developments including semi-detached, detached dwellings and residential flat buildings.

Francis Street is identified as a Landscape Conservation Area, providing protection to the street trees located within it. Adjacent to the subject site are two mature street trees *Melaleuca quinquenervia* (Broad-leaved Paperbark); both trees are not included in Council's Significant Tree Register.



Figure 1: Subject site frontage from Francis Street



Figure 2: Side setback view from the front of the subject site (102 Francis Street on the right side)



Figure 3: Side setback view from the front of the subject site (98 Francis Street on the left side)



Figure 4: Rear yard view of the subject site looking towards southeast



Figure 5: Rear view from the subject site looking towards west

1.3. Relevant Development History

A search of Council's records revealed the following recent and relevant development history of the site:

DA-320/2011 - Alterations & additions for a first storey on the existing detached dwelling & lower ground double garage, approved 20 December 2011 subject to the deletion of the ground floor/ garage level. This consent was subsequently modified (A) on 30 April 2012; however, the works were not undertaken.

DA-447/2015 - Alterations and additions to an existing dwelling to include new first floor and garage to existing building, approved 12 May 2016 subject to the imposition of conditions.

Condition 2 (General Modifications) is of relevance and required the proposal to be amended to reduce the height and its overshadowing impact on neighbouring properties, as follows:

- (a) The garage and associated terrace above are not approved and shall be deleted. In this regard, all works within the footprint of the ground floor level are permitted and all works/structures within the front setback of the dwelling, with the exception of the entry stairs, shall be deleted. The new driveway and kerb and gutter crossing is not approved and vehicular access to the site shall only be permitted from the existing driveway.
- (b) The front verandah and front stairs shall be retained and amended to retain the existing front hard stand car space if necessary.
- (c) The height of the dwelling is to be reduced to RL 51.22, to reduce overshadowing to the adjoining property.

The proposed works have not been undertaken on the site.

DA-60/2018, Alterations and additions to dwelling house, including basement addition, garage and terrace, approved as a Deferred Commencement 1 March 2019. Satisfaction of Deferred Commencement Approval 4 June 2019.

DA-60/2018/A, Alterations and additions to modify the approved garage and terrace. Approved 6 September 2019.

DA-60/2018/B, Modification to excavate basement to provide additional storage and workshop. Approved 9 September 2019.

DA-60/2018/C, Modification including skylights a new bin store and window opening to the garage. Approved 15 November 2019.

1.4. Proposal

The development application seeks consent for alterations and additions to the detached dwelling, specifically the following:

- Extension and reconfiguration of the existing garage and under-croft storage area. The storage is an existing space used as subfloor area in the basement. Both the garage and storage area will have an additional 0.9m x 11.4m of space on the south-east side of the dwelling and will maintain 0.905m side setback from this boundary. This basement/garage level will provide storage, an extension to the garage, w/c and a workshop area which is accessible from the outside of the dwelling. The basement level has a floor to ceiling height of 2.71m.
- Partial demolition of ground floor and extension of ground floor, including internal reconfiguration. It has a similar addition of 0.9m x 12.7m on the southeast side of the dwelling and provides a 0.904m side setback from the boundary. It includes internal reconfiguration of the living, dining, kitchen and laundry area.
- Addition of first floor, including three bedrooms, a bathroom, ensuite and unlabelled area. A
 1.5m deep balcony to the front of the dwelling is also proposed. This level will provide a 1.108m
 setback from the south-eastern boundary.
- Solar panels are proposed on the roof.

1.5. Background

The development application was lodged on 17 August 2022 and deferred on 17 October 2022 for the following reasons:

- The proposed extension of the basement floor has height of 2.71m and has existing windows
 and therefore this is a habitable space. Clarification of the use of basement floor spaces
 (excluding garage and storage area) was requested and was required to be included as gross
 floor area (GFA). In addition, window details were required to ensure compliance with NCC
 standards.
- 2. The proposed northern and southern elevation windows were considered to adversely impact on the visual privacy of the adjoining properties. Similarly, the large window at the rear and bedroom window on the south-eastern were suggested to be treated with privacy screens or glazing treatment for privacy impact mitigation.
- 3. The proposed first floor was not consistent with the predominant front building line of the street, and the proposed front balcony was requested to be deleted.
- 4. Additional information was required as following:

- The basement floor window details to understand the window opening ratio compared to the basement floor areas.
- Correct shadow diagram specifically on 21 June at 9:00 am.

An amended set of architectural plans, shadow diagrams were submitted on 28 October 2022. However, the first-floor balcony was not deleted as requested.

On 3 November 2022, additional shadow diagrams to clearly distinguish between existing and proposed shadows were requested.

The amended shadow diagram was submitted on 4 November 2022.

The development application was further deferred on 10 November 2022 for the following reason:

 The building height has been measured from the natural ground level to the side of the dwelling rather than existing ground level (EGL) (basement). The proposal therefore exceeds the maximum height permitted of 8.5m, with 10.6m proposed. A clause 4.6 variation demonstrating that the proposed exceedance preserves the environmental amenity of the neighbouring properties is required or amended plans are required to comply with the maximum height standard.

A clause 4.6, architectural plans and shadow diagrams were submitted on 24 November 2022.

The development application was further deferred on 6 December 2022 for the following reasons:

- 1. The proposal results in overshadowing impacts on 98 Francis Street, as a result of the height exceedance, which cannot be supported.
- 2. Elevational shadow diagrams of no.98 were requested with an hourly breakdown between 9am to 3pm on 21 June demonstrating that the amended proposal will not impact the adjacent property in terms of solar access.
- 3. The proposed first floor balcony was again requested to be deleted to ensure that the development sits behind the front predominant building line.

An amended set of plans and shadow diagrams were submitted on 9 January 2023 and form the basis of this assessment.

2. ASSESSMENT

The following matters are to be considered in the assessment of this development application under section 4.15 of the *Environmental Planning and Assessment Act 1979* (the Act).

2.1. Planning Instruments and Development Control Plans

The following is an assessment against relevant legislation, environmental planning instruments, including State environmental planning policies (SEPPs), and development control plans.

2.1.1. State Environmental Planning Policies (SEPPs)

The following SEPPs apply from the 1st March 2022 and have been considered acceptable in the assessment of this development application:

- SEPP (Building Sustainability Index BASIX) 2004
- SEPP (Resilience and Hazards) 2021

2.1.2. Waverley Local Environmental Plan 2012 (Waverley LEP 2012)

The relevant matters to be considered under the Waverley LEP 2012 for the proposed development are outlined below:

Table 1: Waverley LEP 2012 Compliance Table

Provision	Compliance	Comment
Part 1 Preliminary		
1.2 Aims of plan	Yes	The proposal is not inconsistent with the aims of the plan.
Part 2 Permitted or prohibited de	velopment	
Land Use Table R2 Zone Low Density Residential zone	Yes	The proposal is defined as alterations and additions to a dwelling, which is permitted with consent in the R2 zone.
Part 4 Principal development star	dards	
4.3 Height of buildings8.5m	No	The proposal has a maximum building height of 10.6m, exceeding the development standard by 12.4%.
 4.4 Floor space ratio and 4.4A Exceptions to floor space ratio 0.78:1 GFA 229.88 m² 	Yes	The proposal is complying with the exceptions to FSR standards with total proposed GFA of 217.3 m ² (or 0.73:1 FSR).
4.6 Exceptions to development standards	See discussion	The application is accompanied by a written request pursuant to clause 4.6 of Waverley LEP 2012 to vary the maximum building height standard. A detailed discussion of the variation to the development standard is presented below this table.
Part 5 Miscellaneous provisions		
5.10 Heritage conservation	No	The site is not a heritage item and is not located within an existing conservation area; however, the site is located on Francis Street which is a landscape heritage conservation area and is within a draft conservation area.
		Council's Heritage advisor has reviewed the proposal notes that the residence forms part of a cohesive group of Inter-War housing with

Provision	Compliance	Comment
		later first floor additions which are set back from and retain the existing front elevation and form of the residences. It is considered that the proposal dilutes the cohesion of the existing residence and the paired residences to adjacent sites.

The following is a detailed discussion of the issues identified in the compliance table above in relation to the Waverley LEP 2012.

Clause 4.6 Exceptions to Development Standards

The application seeks to vary the height of buildings development standard in clause 4.3 under Waverley LEP 2012.

The site is subject to a maximum height development standard of 8.5m. The proposed development has a height of 10.6m, exceeding the standard by 2.1 m equating to a 12.4 % variation.

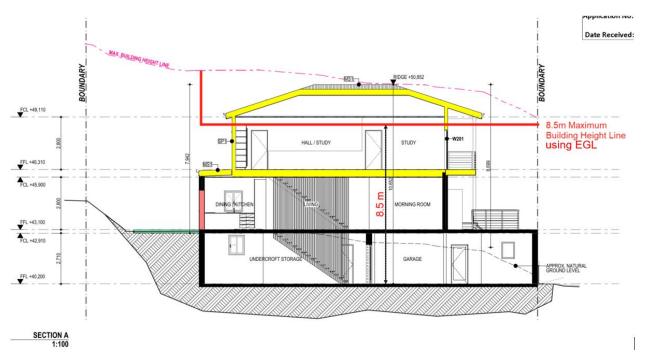


Figure 6: Proposed height in relation to the existing ground level (EGL) of the site.

A written request has been submitted to Council in accordance with clause 4.6(3)(a) and (b) of Waverley LEP 2012 seeking to justify the contravention of the development standard by demonstrating:

- (a) That compliance with the development standard is unreasonable or unnecessary in the circumstances of the case; and
- (b) That there are sufficient environmental planning grounds to justify contravening the standard.

A copy of the applicant's written request has been provided to the Waverley Local Planning Panel for consideration.

Applicant's Written Request - Clause 4.6(3)(a) and (b)

The applicant seeks to justify the contravention of the height of buildings development standard on the following basis:

- (a) That compliance with the development standard is unreasonable or unnecessary in the circumstances of the case:
 - The majority of the building form and roof line complies with the height limit as measured from ground level using the court approach consistent with the NSW LEC. In fact, the majority of the building to the street is under the height standard and reads as a building height when measured from the street level as being under 8.5m the height standard (with the exception of the minor front verandah protrusion).
 - The proposed height standard variation does not result in any adverse environmental amenity impacts to neighbouring properties or public spaces which includes view loss.
 - The proposal generally includes a height of less than 8.5m when measured from the ground level (existing) located immediately outside of the building footprint, and technically non-compliances relates to the historically excavated subterrain level and slab. The height of the building ensures that neighbour dwelling houses habitable room windows and private open space areas will receive at least 3 hours of mid-winter sunlight access between 9am to 3pm.
 - The dwelling house predominantly includes a height of less than 8.5m when measured from the ground level (existing) located immediately outside of the building footprint, the historically excavated subterrain level and slab does not contribute any bulk or scale to the area. The maximum height of the building is similar to the height of the two adjoining dwelling houses and therefore the building height is contextually appropriate and consistent with the streetscape character.
 - The underlying purpose of the development standard is to present a building that is compatible with the height, context and character of the locality whilst preserving the amenity of neighbouring properties. Strict compliance with the height development standard would defeat or thwart the achievement of underlying objectives of the standard.
 - The building height has generally been measured from beneath the historically excavated subterrain existing slab of the lower ground level which has been identified as having a 0.2m and sits up to 3.1m below the ground level (existing) immediately adjoining the perimeter of the lower ground level. Therefore, if the development standard was strictly complied with than the building would read as a height of 5.4m (8.5m minus 3.1m) as measured from ground level (existing) at the rear of the site. The height of building would sit out of character of both the adjoining dwelling houses which appear to have a height of 8.5m or greater.
 - While the standard has not been virtually abandoned or destroyed, it is important to note that Council have consented to proposals in the locality with a building height that exceeds the

development standard, as evidenced in the Register of Exceptions to Development Standards published on Council's website.

- There are numerous examples of developments in the Waverley LGA and in the immediate area which have been approved despite non-compliances with the maximum Height of Building development standard. This includes both the adjoining three storey dwelling houses appear to exceed the 8.5m height standard. Whilst each DA is assessed on its own merits and each site has different characteristics, Council has accepted variations to the maximum building height standard in the past.
- Further, the building height has been measured from beneath the historically excavated subterrain existing slab of the lower ground level which has been identified as having a 0.2m slab thickness and sits up to 3.1m below the ground level (existing) immediately adjoining the perimeter of the lower ground level. Therefore, the proposed height of the building will predominantly read as less than 8.5m as viewed externally from the site and subterranean level or slab (with the exception of a portion of the front verandah roof) does not present any bulk or scale and therefore the intent of standard has not been abandoned.
- (b) That there are sufficient environmental planning grounds to justify contravening the standard:
 - The proposal is predominantly compliant with the 8.5m height of building standard when adopting the practical height of building measurement adopted by the courts in Bettar v Council of the City of Sydney [2014] NSWLEC 1070 (with the exception of a portion of the front verandah roof);
 - The building height has predominantly been measured from beneath the historically excavated subterrain existing slab of the lower ground level which has been identified as having a 0.2m thickness and sits up to 3.1m below the ground level (existing) immediately adjoining the perimeter of the lower ground level. Therefore, if the development standard was strictly complied with than the building would read as a height of 5.4m (8.5m minus 3.1m) as measured from ground level (existing) at the rear of the dwelling house. The height of building would sit out of character of both the adjoining dwelling houses which appear to have a height of 8.5m or greater. Therefore, strict compliance with the height of building standard would defeat or thwart the achievement of underlying objectives of the standard.
 - The height of the verandah roof is a result of a historical natural ground level being excavated which has reduced the ground level (existing) which height would historically be measure from. Strict compliance with the development standard would not result in a better outcome for development but would result in a building height which sits artificially below both the adjoining dwelling houses or a roof pitch out of character with the subject dwelling house or adjoining dwelling houses;
 - The adjoining three storey dwelling houses at 98 and 102 Francis Street include a height similar
 to the proposal ensuring the height of the proposed upper level additions fits contextually and
 would be complementary to the streetscape character;
 - The area of non-compliance relating to the subterrain level does not result in any view loss, overlooking, visual bulk or overshadowing.
 - Strict compliance with the development standard would not result in a better outcome for development but would result in a building height which sits artificially below both the adjoining

dwelling houses or a roof pitch out of character with the subject dwelling house or adjoining dwelling houses;

 Ability to satisfy the height objectives of the development standard and R2 Low Density Zone objectives.

Consideration of Applicant's Written Request - Clause 4.6(4) (a) (i) and (ii)

Development consent must not be granted unless the consent authority is satisfied that:

- (a) The applicant's written request has adequately addressed the matters required to be demonstrated by subclause 3 of clause 4.6 being that compliance with the development standard is unreasonable or unnecessary in the circumstances of the case, and that there are sufficient environmental planning grounds to justify contravening the standard; and
- (b) The proposed development will be in the public interest because it is consistent with the objectives of the particular development standard and the objectives for development within the zone in which the development is proposed to be carried out.

Does the written request adequately address those issues at clause 4.6(3)(a)?

It is considered that the applicant has not adequately addressed that compliance with the standard is unreasonable or unnecessary in the circumstances of the case and has referenced one or more of the following justifications as set out in *Wehbe v Pittwater Council* (2007) 156 LGERA 446:

- (a) the objectives of the development standard are achieved notwithstanding non-compliance with the standard;
- (b) to establish that the underlying objective or purpose is not relevant to the development with the consequence that compliance is unnecessary;
- (c) to establish that the underlying objective or purpose would be defeated or thwarted if compliance was required with the consequence that compliance is unreasonable;
- (d) to establish that the development standard has been virtually abandoned or destroyed by the Council's own actions in granting consents departing from the standard and hence compliance with the standard is unnecessary and unreasonable; and
- (e) to establish that "the zoning of particular land" was "unreasonable or inappropriate" so that "a development standard appropriate for that zoning was also unreasonable or unnecessary as it applied to that land" and that "compliance with the standard in that case would also be unreasonable or unnecessary.

The applicant specifically relies upon justification (a) outlined above to address clause 4.6(3)(a) of Waverley LEP 2012.

The applicant states the proposed height is consistent with the objectives of the height development standard and will not result in unreasonable impacts. Council disagrees with the contention that the objectives of the height development standard are achieved.

The proposal will result in additional impacts to adjoining properties in regards to overshadowing and will not 'preserve the environmental amenity of neighbouring properties' thereby being contrary to objective (a) of the height development standard. The extent of these impacts is discussed later in this report. The proposed development is also not compatible with the height, bulk and scale of the desired future character of the locality contrary to objective (d) of the height development standard.

In addition, the examples of nearby properties provided were approved prior to 2007, and are prior to the current Waverley LEP 2012.

Does the written request adequately address those issues at clause 4.6(3)(b)?

The applicant has not adequately addressed that there are sufficient environmental planning grounds to justify contravening the development standard. The proposal results in adverse overshadowing impacts and therefore does not preserve the environmental amenity of the neighbouring property. The variation of the development standard is not in the public interest and is inconsistent with the desired future character of the locality.

Is the development in the public interest?

The proposed development will not be in the public interest because it is inconsistent with both the objectives of the particular development standard and the objectives for development within the R2 Low Density Residential Zone in which the development is proposed to be carried out.

The relevant objectives of the building height development standard are as follows:

- (a) to establish limits on the overall height of development to preserve the environmental amenity of neighbouring properties and public spaces and, if appropriate, the sharing of views,
- (d) to ensure that buildings are compatible with the height, bulk and scale of the desired future character of the locality and positively complement and contribute to the physical definition of the street network and public space.

Objective (a) is not satisfied as the area of building height non-compliance would result in overshadowing of the neighbouring property at 98 Francis Street located to the south-east, and accordingly does not demonstrate that the amenity of the neighbouring property would be preserved.

Objective (d) is not satisfied as the breach of the building height standard would result in overshadowing of the neighbouring properties, and in addition to the breach of the predominant front building line control, the proposed bulk and scale would not be in keeping with desired future character of the locality.

The objectives of the R2 zone are as follows:

- To provide for the housing needs of the community within a low density residential environment.
- To enable other land uses that provide facilities or services to meet the day to day needs of residents.
- To maximise public transport patronage and encourage walking and cycling.

Whilst it is acknowledged that the proposed development does provide for the housing needs of the community within a low density environment and would improve the internal amenity for the occupants of the dwelling, the exceedance of the development standard and the overall planning outcome for the site to achieve this objective as proposed is unacceptable and cannot be supported.

Conclusion

For the reasons provided above, the requested variation to the height of the building standard is not supported as the applicant's written request has not adequately addressed the matters required to be addressed by clause 4.6(3) of the Waverley LEP 2012. In addition, the proposed development is not in the public interest because it is inconsistent with the objectives of height of the building and the R2 Low Density Residential Zone.

2.1.3. Waverley Development Control Plan 2012 (Waverley DCP 2012) - Amendment No.9

The relevant matters to be considered under the Waverley DCP 2012 for the proposed development are outlined below:

Table 2: Waverley DCP 2012 – Part B General Provisions Compliance Table

Development Control	Compliance	Comment
1. Waste	Yes	Satisfactory.
Ecologically Sustainable Development	Yes	Satisfactory. A valid BASIX Certificate was lodged with the application.
5. Vegetation Preservation	Yes	No tree removal is proposed with this application.
6. Stormwater	Yes	Satisfactory. Refer to section 3 of this report on referral commentary in relation to stormwater.
9. Heritage	No	Unsatisfactory Refer to the comments above and section 3 of this report.
12. Design Excellence	No	Unsatisfactory, the proposed development does not achieve design excellence as it does not appropriately consider the site context, amenity impacts and the relationship of the development to other development on neighbouring sites and the locality.

Table 3: Waverley DCP 2012 – Part C2 Low Density Residential Development Compliance Table

Development Control	Compliance	Comment
2.0 General Objectives		
	No	The proposal would result in adverse impacts on the amenity of the neighbouring properties in regard to overshadowing and would not be in keeping with the desired future character of the locality.

Development Control	Compliance	Comment
2.1 Height		
Pitched roof dwelling house Maximum external wall height of 7m	No	The proposal comprises a wall height of 8.4m from the southwest elevation and 8.9m from the northwest elevation which exceeds the maximum wall height control by 1.4m (12%) 1.9m (12.7%) respectively.
2.2 Setbacks		
2.2.1 Front and rear building linesPredominant front building line	No	The proposal sits forward of the predominant front building line of the street and is not acceptable. In addition, Council's Heritage officer has noted that is adversely impacts on the dwelling and the streetscape.
Predominant rear building line at each floor level	Yes	The proposed rear building line at each floor is acceptable.
2.2.2 Side setbacks	Yes	The proposal provides a minimum 0.9m side
 Minimum of 0.9m (for height up to 8.5m) and 1.5m (up to 12.5m) 		setback from south-east boundary and 2.2m side setback from north-west boundary.
2.3 Streetscape and visual imp	pact	
 New development to be compatible with streetscape context Replacement windows to complement the style and proportions of existing dwelling 	No	The proposal will result in additional unacceptable bulk to the streetscape. The proposed first-floor and over-sized balcony will dominate the streetscape by not following the predominant front building line and is not compatible with the streetscape context.
Significant landscaping to be maintained.		
2.4 Fences		
 Front: Maximum height of 1.2m Solid section no more than 0.6m high Side and Rear: 	N/A	There are no changes proposed to the existing fence of the dwelling.
Maximum height of 1.8m		
2.5 Visual and acoustic privac	y	
Habitable windows are not to directly face habitable windows or open space of neighbouring dwellings unless direct views are screened or other appropriate measures	Yes	The amended proposal will generally maintain visual privacy from adjacent properties. The proposed windows either do not face neighbouring windows, are highlight or have privacy screening to mitigate any potential privacy impact.

Development Control	Compliance	Comment
are incorporated into the designExternal stairs are not acceptable.	N/A	The proposed first-floor balcony is 1.5m deep and has an area of 13.3sqm which is noncompliant to WDCP.
 Maximum size of balconies: 10m² in area 1.5m deep 	No	
Roof tops to be non- trafficable unless predominant in the immediate vicinity	N/A	
2.6 Solar access		
Minimum of three hours of sunlight to living areas and principal open space areas on 21 June	No	As detailed on the elevational shadow diagrams, the proposal results in additional overshadowing impacts on 98 Francis Street (south-east side).
 Minimum of three hours of sunlight maintained to at least 50% I of principal open space areas of adjoining properties on 21 June. 		
 Avoid unreasonably overshadowing of solar collectors (including habitable windows). 		
2.8 Car parking		
2.8.1 Design Approach 2.8.2 Parking rates 2.8.3 Location 2.8.4 Design 2.8.5 Dimensions 2.8.6 Driveways	Yes	There are no changes proposed to the existing car parking, with the exception of an extension to the garage. One car space is maintained on site.
2.9 Landscaping and open spa		
Overall open space: 40% of site area	Yes	The proposal provides an overall open space greater than 40% (131.3sqm approximately) of the site area.
Overall landscaped area: 15% of site area	No	The proposal provides an overall landscape area
Minimum area of 25m² for private open space	Yes	less than 15% (26.8sqm – 9.1% approximately) of site area.
Front open space: 50% of front building setback area	No	The proposal provides a minimum 25sqm of private open space. The proposal does not change the existing front open space of the site.

Development Control	Compliance	Comment
 Front landscaped area: 50% of front open space provided Outdoor clothes drying area to be provided 	No Yes	The proposal does not change the existing front landscape area of the site. The existing outdoor clothes drying area is retained.

2.2. Other Impacts of the Development

The proposal is considered to have a significant detrimental effect relating to environmental, social or economic impacts on the locality, and is recommended for refusal.

2.3. Suitability of the Site for the Development

The site is not considered suitable for the proposal.

2.4. Any Submissions

The application was notified for 14 days between 24 August 2022 and 7 September 2022 in accordance with the *Waverley Community Development Participation and Consultation Plan*.

Following receipt of amended plans and additional information, the application was not notified as the amended plans did not include any new or additional impacts on the streetscape of neighbouring properties.

A total of two unique submissions were received from 98 Francis Street.

The following issues raised in the submissions have already been discussed and addressed in the body of this report and/or the Recommendation:

- Noncompliance with overall building height standards
- Noncompliance with front predominant building line standards
- Unreasonable overshadowing impacts on neighbouring property
- Overlooking and privacy impact (due to reduction in setback on southeast boundary)
- Bulk and scale

2.5. Public Interest

The proposal is considered to have a detrimental effect on the public interest, and is recommended for refusal.

3. REFERRALS

The following internal and external referral comments were sought:

3.1. Traffic and Development

From a traffic and development perspective there are no objections to approval of this application subject to the conditions.

3.2. Stormwater

From a stormwater drainage perspective there are no objections to approval of this application subject to the conditions.

3.3. Tree Management

From a stormwater drainage perspective there are no objections to approval of this application subject to the conditions.

3.4. Heritage

The proposal was referred to council's heritage officer who provided the following comments:

To maintain the cohesion of the existing cottage with the adjacent residences, the Landscape Conservation Area, and the draft Conservation Area it is recommended that:

- First floor additions are to be set back and retain the forward form and detail of the existing building.
- First floor additions are to align with the front line of adjacent first floor additions.

4. CONCLUSION

The development application seeks consent for alterations and additions to dwelling including new first floor addition at the site known as 100 Francis Street, Bondi Beach.

The principal issues arising from the assessment of the application are as follows:

- Overall building height
- Front predominant building line
- Overshadowing impacts
- Bulk and scale

The assessment finds these issues unacceptable for the reasons outlined within this report.

A total number of two submissions were received and the issues raised in the submissions have been considered and addressed in this report and in the Recommendation.

The application has been assessed against the relevant matters for consideration under section 4.15(1) of the Act. It is recommended for refusal.

5. RECOMMENDATION TO WAVERLEY LOCAL PLANNING PANEL

That the development application be REFUSED by the Waverley Local Planning Panel for the reasons contained in Appendix A.

Report prepared by:	Application reviewed and agreed by:
B	
Saumya Shah	Bridget McNamara
Development Assessment Planner	Manager, Development Assessment
Date: 25/01/2023	Date: 9 February 2023

Reason for WLPP referral:

1. Departure from any development standard in an EPI by more than 10%

APPENDIX A – REASONS FOR REFUSAL

Having regard to section 4.55 (2) and section 4.15 (1) of the *Environmental Planning and Assessment Act* 1979 (the Act) the development application (the application) is refused for the following reasons:

- 1. The application does not satisfy section 4.15 (1)(a)(i) of the Act as it contrary to the following provisions of *Waverley Local Environmental Plan* (WLEP) 2012:
 - a. Clause 4.3 Height

The application exceeds the maximum allowable height of 8.5m and the applicant's written request under clause 4.6 of WLEP has failed to adequately address the required matters under subclauses 4.6 (3)(a) and (b) of Waverley LEP 2012.

Details: The proposed development does not preserve the environmental amenity of neighbouring properties as required under clause 4.3 (1) (a) of Waverley LEP 2012.

2. The application does not satisfy section 4.15 (1)(a)(iii) of the Act as it is contrary to Waverley Development Control Plan (WDCP) 2012, in respect to the following provisions:

Part B9 Heritage

 a. General Objectives (e) and (f), as the proposal will not enhance the significance of landscape conservation area of Francis Street with the proposed additional bulk and scale.

Part B12 Design Excellence

b. General objectives (a), (c) and (d) and controls (a) and (e), as the proposal will have an environmental impact such as overshadowing and will not contribute to the architectural and overall urban design quality of Waverley.

Part C2 Low Density Residential Development

- c. 2.0 General Objectives, specifically (b) and (d) as the proposal would result in impacts on the amenity of the neighbouring properties. The proposal would not be in keeping with the desired future character of the locality.
- d. 2.1 Height, specifically objective (d) and control (a) as the proposal comprises a wall height of 6.87m (at southeast elevation) and 8.9m (at north-west elevation) which exceeds the 7m wall height control by 1.9m (12.7%) (at north-west elevation).
- e. 2.2 Setbacks, specifically objectives (a) and (f) and 2.2.1 Front and Rear Building lines (a) as the proposal would not maintain the predominant front building line..
- f. 2.3 Streetscape and Visual Impact, specifically control (d) as the proposed first floor would not minimise the visual bulk and scale or dominance from a streetscape perspective.
- g. 2.5 Visual and Acoustic Privacy, specifically control (e) as the proposal comprises of first floor balcony of 13.3sqm.

- h. 2.6 Solar Access, specifically objectives (a), (b), and (d), and control (c) as the development exceeds the building height development standards and would result in overshadowing of the neighbouring property at 98 Francis Street.
- 3. The application does not satisfy section 4.15 (1)(b) of the Act as the proposed development is excessive in terms of its building massing, bulk and scale, and consequently results in unacceptable amenity and streetscape impacts upon the locality and surrounding built environment.
- 4. The application is contrary to section 4.15 (1)(c) of the Act due to the site being unsuitable to accommodate the proposed development.
- 5. The application is contrary to section 4.15 (1)(d) of the Act in relation to matters raised in the public submissions received that object to the proposed development.
- 6. The application is contrary to section 4.15 (1)(e) of the Act in relation to the public interest as it is not compatible with the existing and desired future character of the locality and the broader Waverley local government area.

DEVELOPMENT APPLICATION

AMENDED PLANS

100 Francis St Bondi Beach NSW

DRAWING LIST

A02 BASIX CERTIFICATE	DRAWING No.	DESCRIPTION	REV	ISSUED
A03 AREA DIAGRAMS O	A01	TITLE PAGE	0	
A04 SITE ANALYSIS O	A02	BASIX CERTIFICATE	0	
A05	A03	AREA DIAGRAMS	0	
A06 EX. GROUND PLAN O	A04	SITE ANALYSIS	0	
A07 GARAGE / BASEMENT DEMOLITION PLAN	A05	EX. GARAGE / BASEMENT	0	
A08 GROUND FLOOR DEMOLITION PLAN	A06	EX. GROUND PLAN	0	
A09 SITE & ROOF PLAN	A07	GARAGE / BASEMENT DEMOLITION PLAN	0	
A110 PROPOSED BASEMENT O	A08	GROUND FLOOR DEMOLITION PLAN	0	
A11 PROPOSED GROUND FLOOR	A09	SITE & ROOF PLAN	0	
A12 PROPOSED FIRST FLOOR	A10	PROPOSED BASEMENT	0	
A13	A11	PROPOSED GROUND FLOOR	0	
A14 ELEVATIONS O	A12	PROPOSED FIRST FLOOR	0	
A15 ELEVATIONS O	A13	ELEVATIONS	0	
A16	A14	ELEVATIONS	0	
A17 SECTION O	A15	ELEVATIONS	0	
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	A27	STREETSCAPE ANALYSIS	0	

LOCATION PLAN (NTS)



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FINISHES SCHEDULE















RN1 - CEMENT RENDER. APPLIED TO ALL EXISTING WALLS. NEW RENDER TO MATCH.

RECEIVED **Waverley Council**

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DEVELOPMENT APPLICATION

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1/08/2022 19/10/2022 28/10/2022 24/11/2022

9/01/2023

ng with ibility CLIENT(S):Stan & Penny Bland

PAGE: TITLE PAGE







Alterations and Additions

Certificate number: A468478

This certificate confirms that the proposed development will meet the NSW government's requirements for sustainability, if it is built in accordance with the commitments set out below. Terms used in this certificate, or in the commitments, have the meaning given by the document entitled "BASIX Alterations and Additions Definitions" dated 06/10/2017 published by the Department. This document is available at www.basix.nsw.gov.au



Project name	100 Francis St
Street address	100 Francis Street Bondi Beach 2026
Local Government Area	Waverley Council
Plan type and number	Deposited Plan 9638
Lot number	4
Section number	
Project type	
Dwelling type	Separate dwelling house
Type of alteration and addition	My renovation work is valued at \$50,000 or more and does not include a pool (and/or spa).


Certificate Prepared by (please complete before submitting to Council or PCA)
Name / Company Name: Sandbox Studio Pty Ltd
ABN (if applicable): 612363372

Fixtures and systems	Show on DA Plans	Show on CC/CDC Plans & specs	Certifier Check
Lighting			
The applicant must ensure a minimum of 40% of new or altered light fixtures are fitted with fluorescent, compact fluorescent, or light-emitting-diode (LED) lamps.		✓	✓
Fixtures			
The applicant must ensure new or altered showerheads have a flow rate no greater than 9 litres per minute or a 3 star water rating.		✓	✓
The applicant must ensure new or altered toilets have a flow rate no greater than 4 litres per average flush or a minimum 3 star water rating.		✓	~
The applicant must ensure new or altered taps have a flow rate no greater than 9 litres per minute or minimum 3 star water rating.		✓	

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PLANS AMENDED

Di tont Continuato	Humber, A4004	****							page 477
Glazing requirements								Show on CC/CDC Plans & specs	Certifier Check
Windows a	ınd glazed	doors							
					nading devices, in accordar each window and glazed	ance with the specifications listed in the table below. door.	~	~	✓
The following	g requiremen	its must also	be satisfi	ed in relation	to each window and glaz	red door:		✓	✓
Each window or glazed door with standard aluminium or timber frames and single clear or toned glass may either match the description, or, have a U-value and a Solar Heat Gain Coefficient (SHGC) no greater than that listed in the table below. Total system U-values and SHGCs must be calculated in accordance with National Fenestration Rating Council (NFRC) conditions.							✓	~	
					each eave, pergola, vera	ndah, balcony or awning must be no more than 500 mm sill.	✓	✓	✓
Pergolas wit	h polycarbon	ate roof or s	similar trar	slucent mate	erial must have a shading	coefficient of less than 0.35.		✓	✓
					e window or glazed door a ens must not be more thar	above which they are situated, unless the pergola also in 50 mm.		✓	✓
	ving buildings the 'overshad				nt and distance from the co	entre and the base of the window and glazed door, as	✓	✓	✓
Windows	and glaze	d doors g	Jazing r	equireme	nts		1		
Window / do	oor Orientati	on Area of glass		<u> </u>	Shading device	Frame and glass type			
110.		inc. frame (m2)	Height (m)	Distance (m)					
W101	SE	0.6	4.1	2.4	none	standard aluminium, single clear, (or U-value: 7.63, SHGC: 0.75)			
W102	SE	1.5	5.6	2.4	none	standard aluminium, single clear, (or U-value: 7.63, SHGC: 0.75)			
W103	SE	1.5	5.6	2.4	none	standard aluminium, single clear, (or U-value: 7.63, SHGC: 0.75)			
W104	NW	0.4	4.5	2.7	none	standard aluminium, single clear, (or U-value: 7.63, SHGC: 0.75)			

Planning, Industry & Environment page 7 / 7

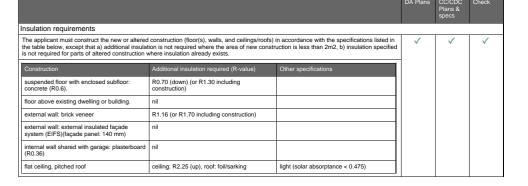ommitments identified with a "\script" in the "Show on DA plans" column must be shown on the plans accompanying the development application for the proposed development (if a evelopment application is to be lodged for the proposed development).

commitments identified with a " $\sqrt{}$ " in the "Show on CC/CDC plans & specs" column must be shown in the plans and specifications accompanying the application for a constructio ertificate / complying development certificate for the proposed development.

mnitments identified with a "

" in the "Certifier check" column must be certified by a certifying authority as having been fulfilled, before a final occupation certificate for the elopment may be issued.

Planning, Industry & Environmen

Glazing requ	irements						Show on DA Plans	Show on CC/CDC Plans & specs	Certifier Check
Window / door no.	Orientation	Area of glass inc. frame (m2)	Oversha Height (m)	Distance (m)	Shading device	Frame and glass type			
D101	NE	6.3	9.1	7.9	eave/verandah/pergola/balcony >=900 mm	standard aluminium, single clear, (or U-value: 7.63, SHGC: 0.75)			
D102	NE	2.1	9.1	7.9	eave/verandah/pergola/balcony >=900 mm	standard aluminium, single clear, (or U-value: 7.63, SHGC: 0.75)			
D103	NW	1.9	6.9	2.7	none	standard aluminium, single clear, (or U-value: 7.63, SHGC: 0.75)			
D104	SW	6.3	0	0	none	standard aluminium, single clear, (or U-value: 7.63, SHGC: 0.75)			
W201	NE	1.9	5.8	7.9	eave/verandah/pergola/balcony >=900 mm	standard aluminium, single clear, (or U-value: 7.63, SHGC: 0.75)			
W202	SE	0.4	1.2	2.4	eave/verandah/pergola/balcony >=450 mm	standard aluminium, single clear, (or U-value: 7.63, SHGC: 0.75)			
W203	NW	1	1.7	2.7	eave/verandah/pergola/balcony >=450 mm	standard aluminium, single toned, (or U-value: 7.57, SHGC: 0.57)			
W204	SE	1.45	2.2	2.4	eave/verandah/pergola/balcony >=450 mm	standard aluminium, single clear, (or U-value: 7.63, SHGC: 0.75)			
W205	NW	0.8	2.3	2.7	eave/verandah/pergola/balcony >=450 mm	standard aluminium, single toned, (or U-value: 7.57, SHGC: 0.57)			
W206	NW	0.65	1.7	2.7	eave/verandah/pergola/balcony >=450 mm	standard aluminium, single toned, (or U-value: 7.57, SHGC: 0.57)			
W207	SE	0.4	1.2	2.4	eave/verandah/pergola/balcony >=450 mm	standard aluminium, single clear, (or U-value: 7.63, SHGC: 0.75)			
W208	NW	0.65	1.7	2.7	eave/verandah/pergola/balcony >=450 mm	standard aluminium, single toned, (or U-value: 7.57, SHGC: 0.57)			
W209	SW	1.8	0	0	eave/verandah/pergola/balcony >=450 mm	standard aluminium, single clear, (or U-value: 7.63, SHGC: 0.75)			

Planning, Industry & Environmen

							Show on DA Plans	Show on CC/CDC Plans & specs	Certifier Check
Window / door no.	Orientation	Area of glass inc. frame (m2)	Oversha Height (m)	Distance (m)	Shading device	Frame and glass type			
W210	SW	0.75	0	0	eave/verandah/pergola/balcony >=450 mm	standard aluminium, single clear, (or U-value: 7.63, SHGC: 0.75)			
D201	NE	2.4	5.8	7.9	eave/verandah/pergola/balcony >=900 mm	standard aluminium, single clear, (or U-value: 7.63, SHGC: 0.75)			
D202	NE	2.4	5.8	7.9	eave/verandah/pergola/balcony >=900 mm	standard aluminium, single clear, (or U-value: 7.63, SHGC: 0.75)			

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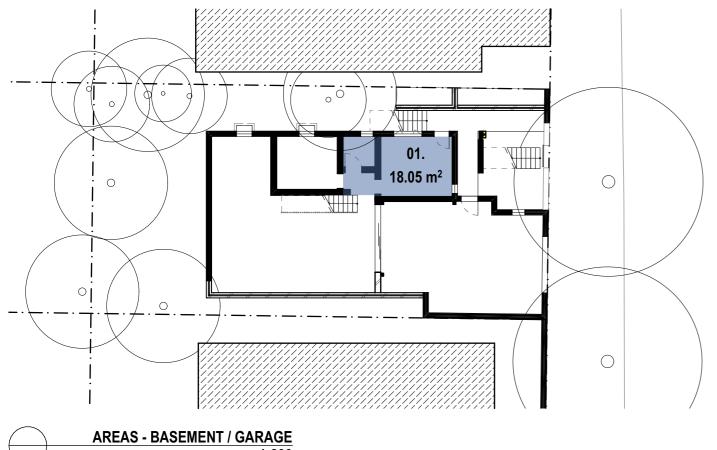
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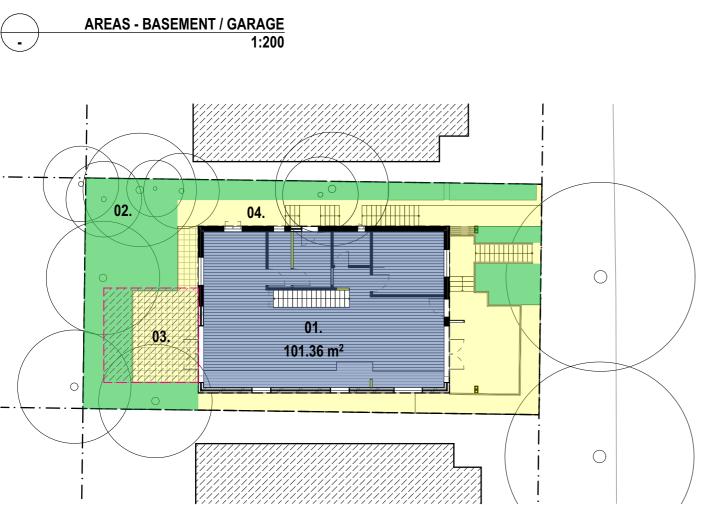
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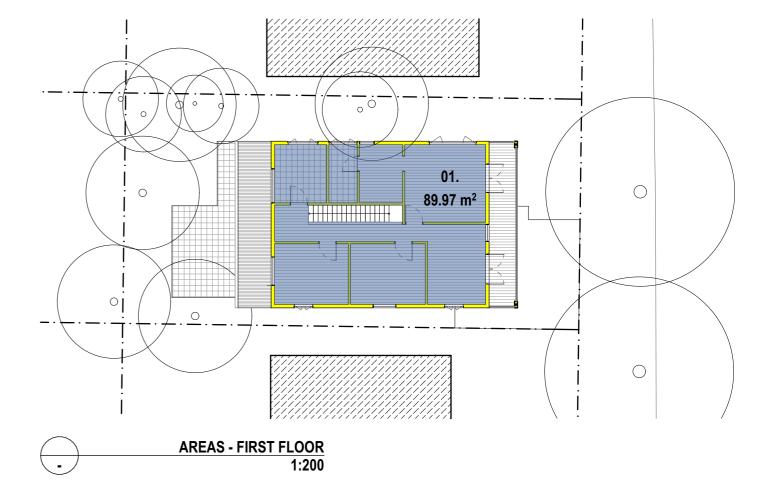
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ting with client(s):Stan & Penny Bland


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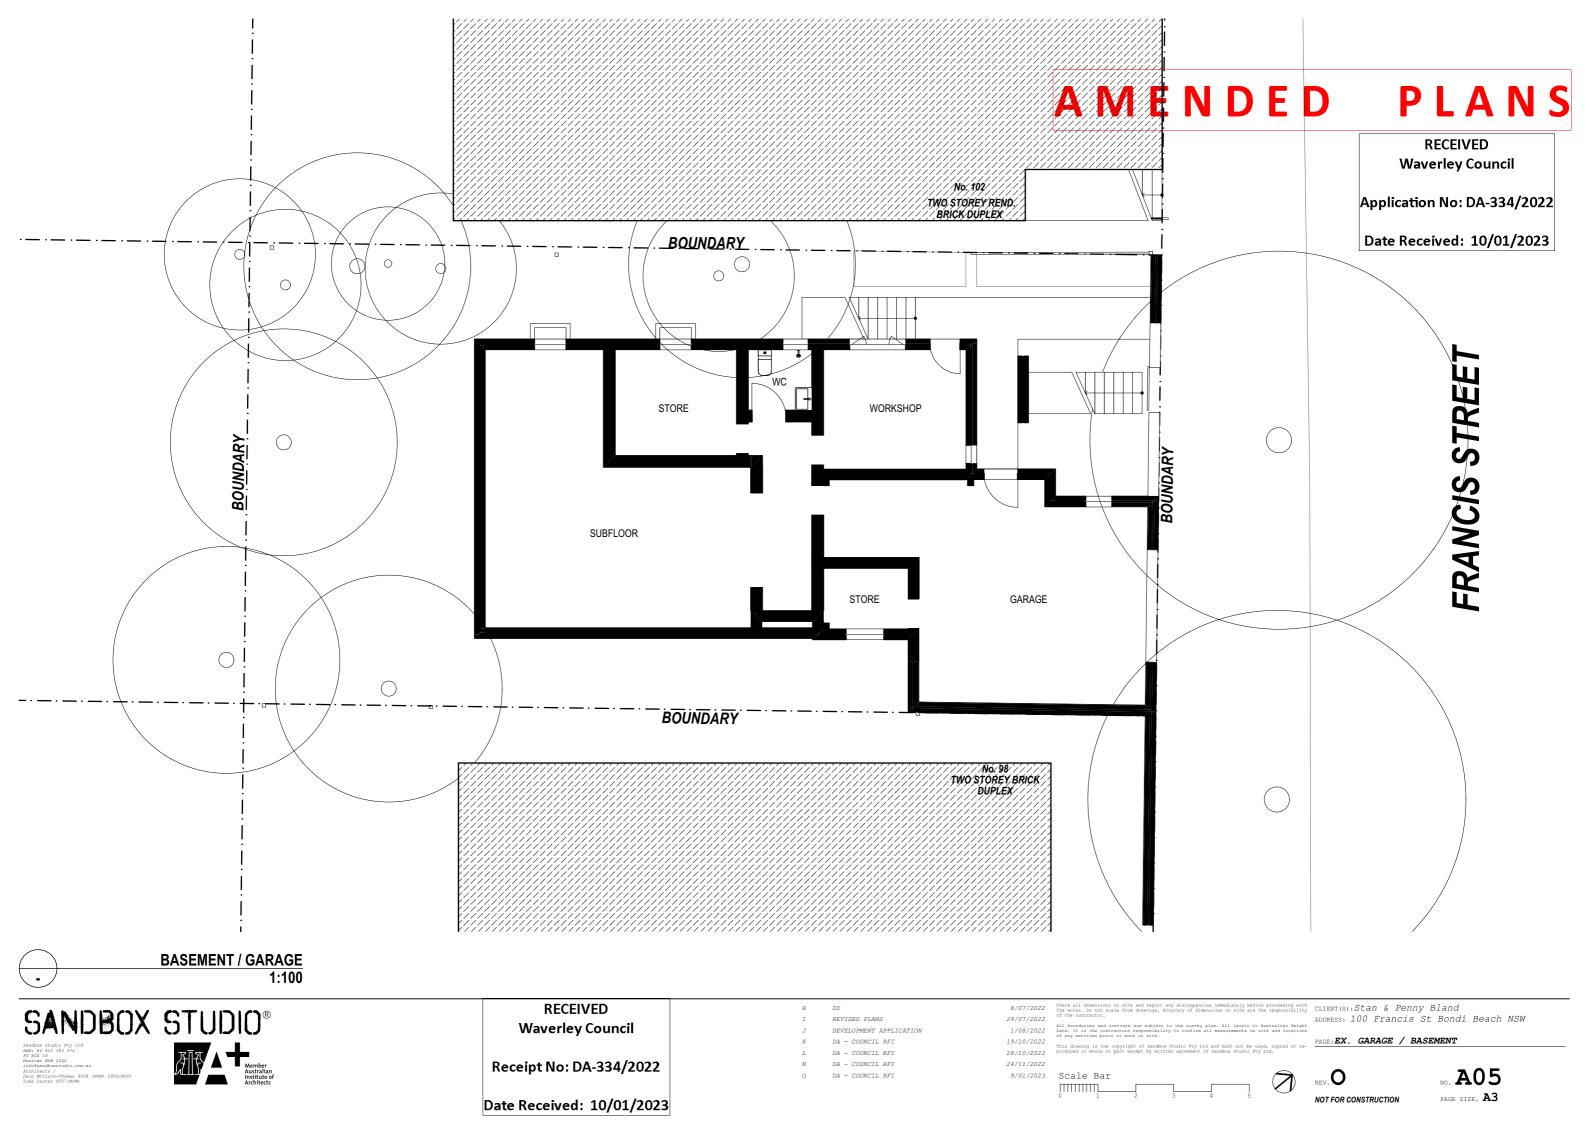
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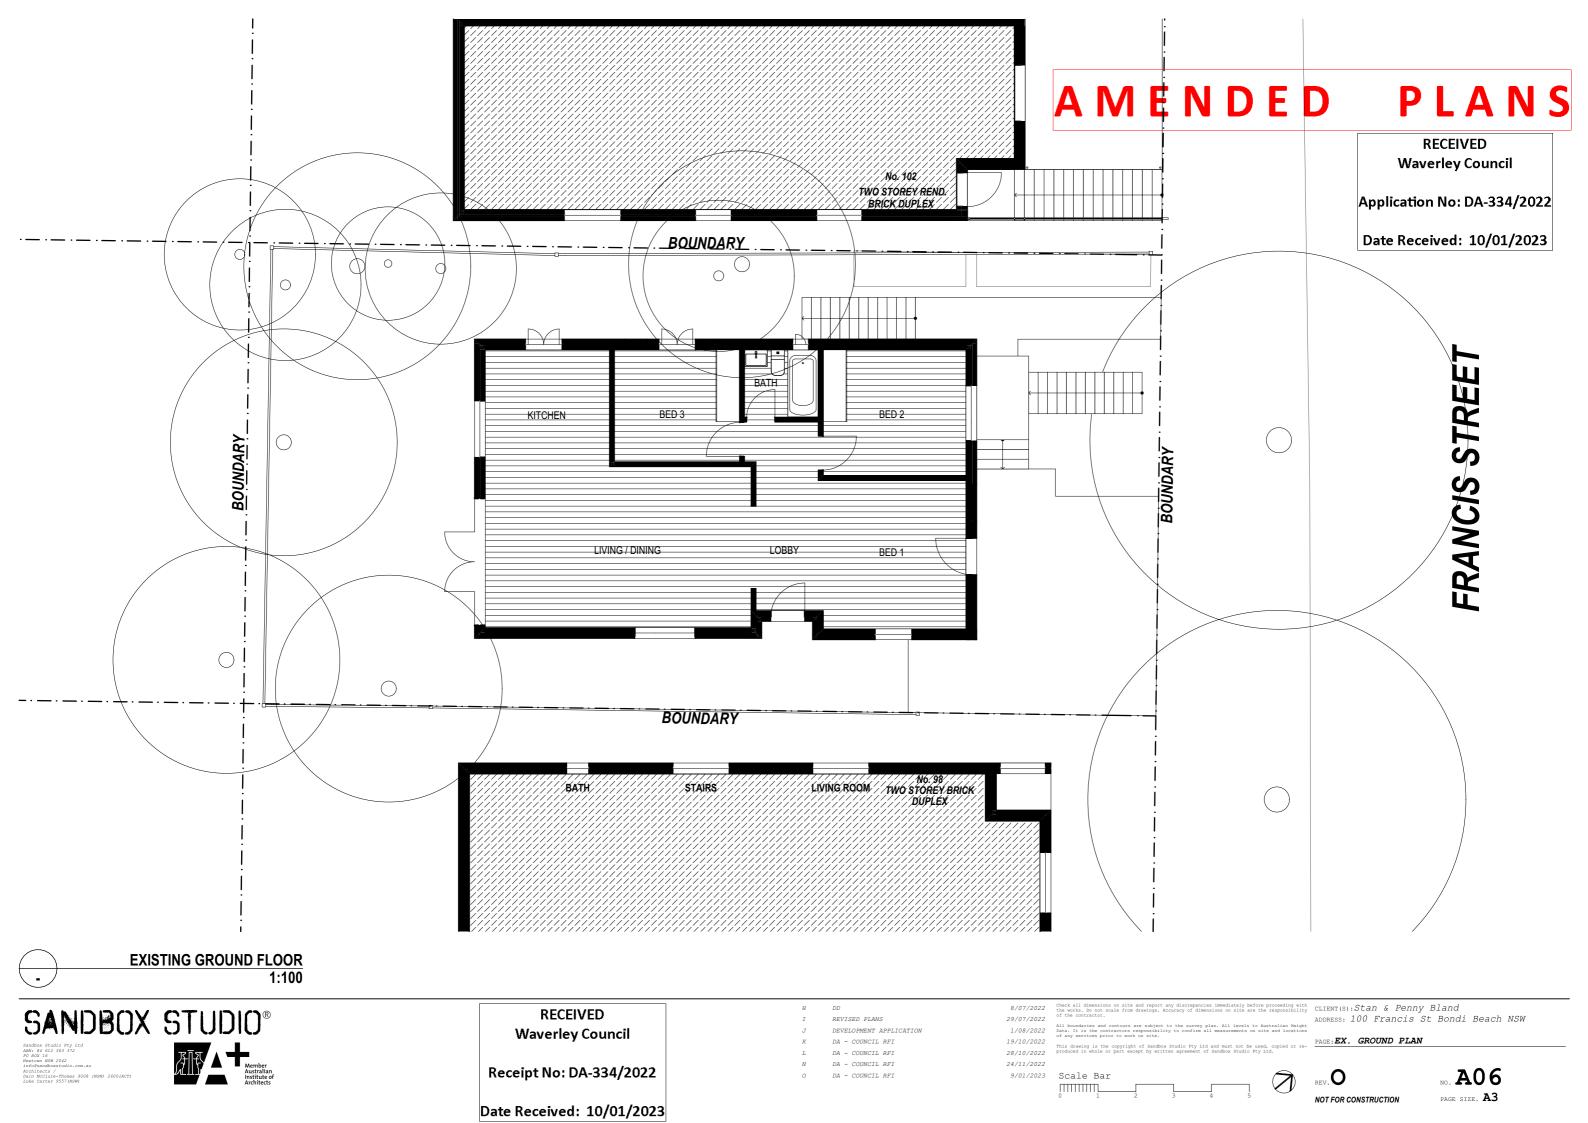
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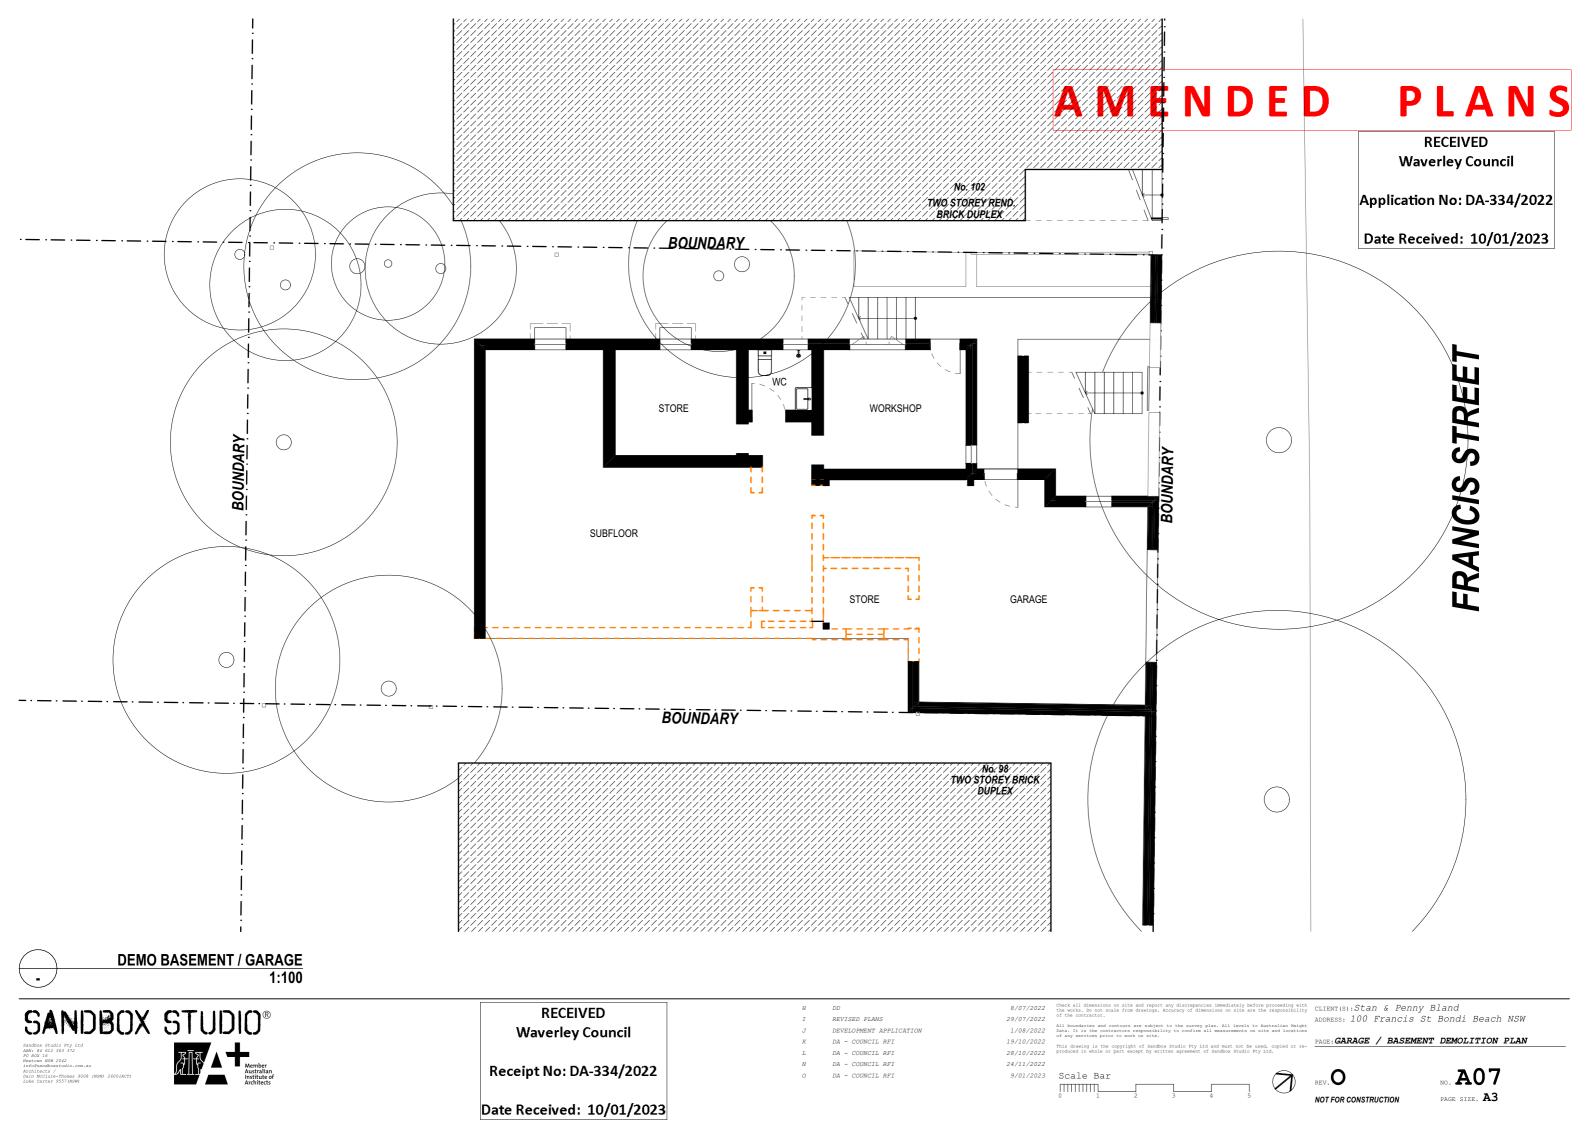














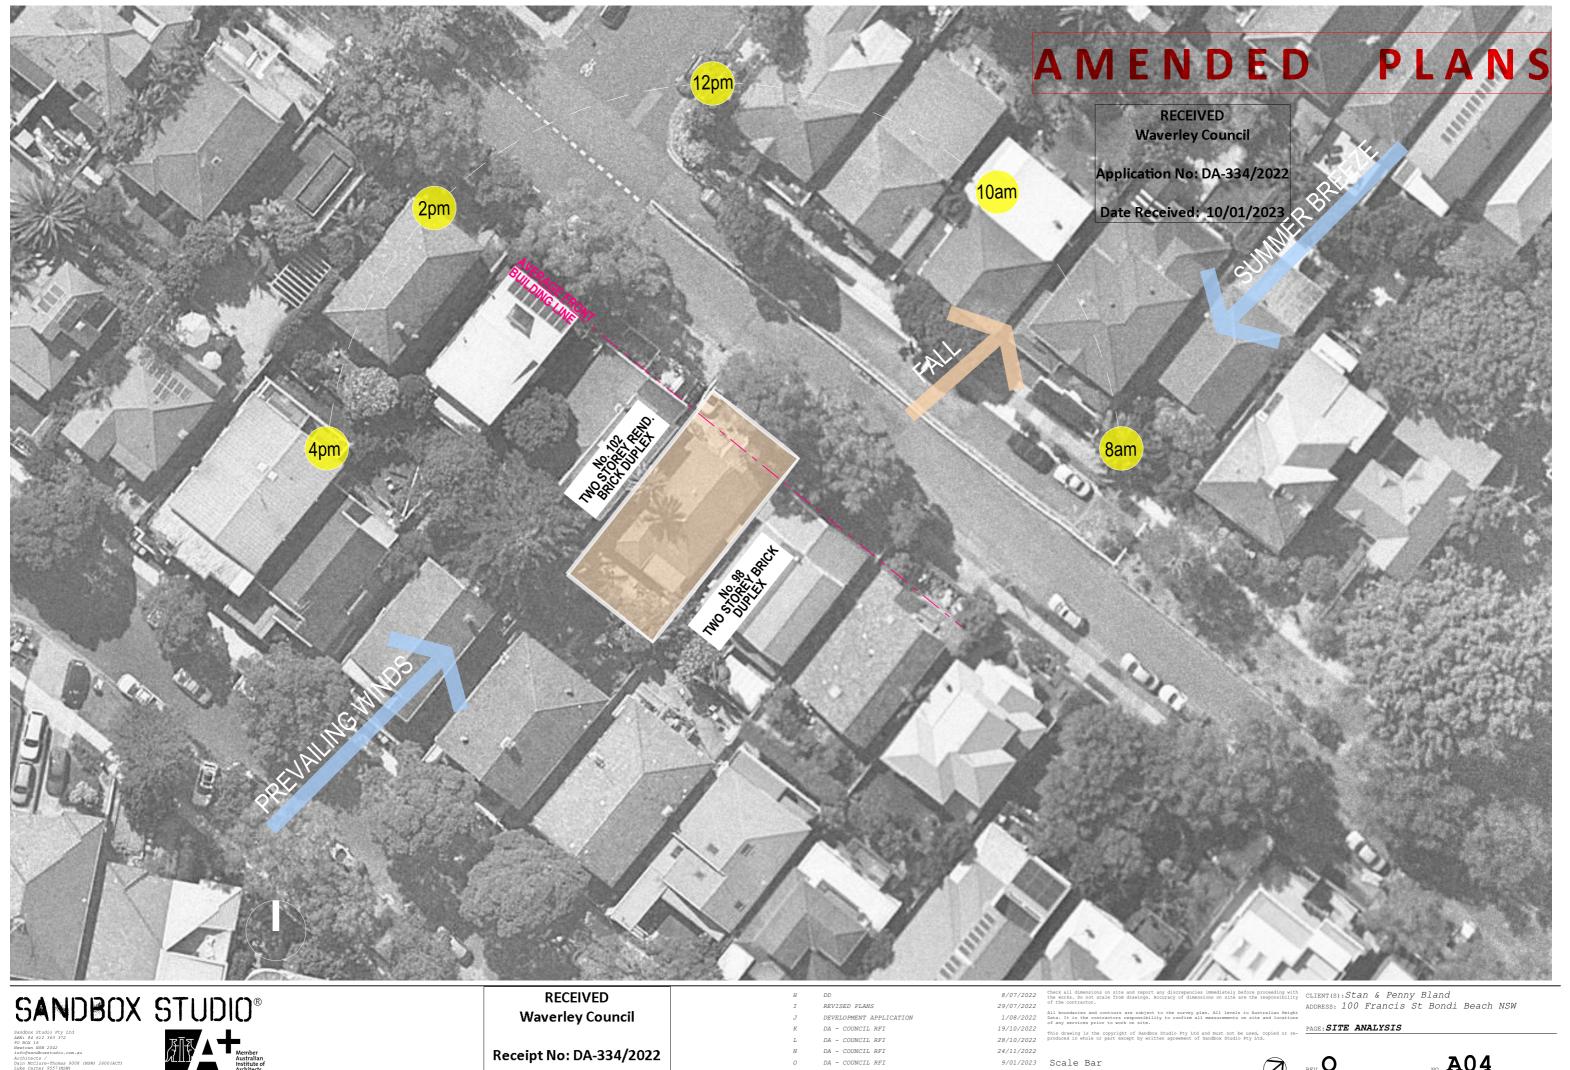


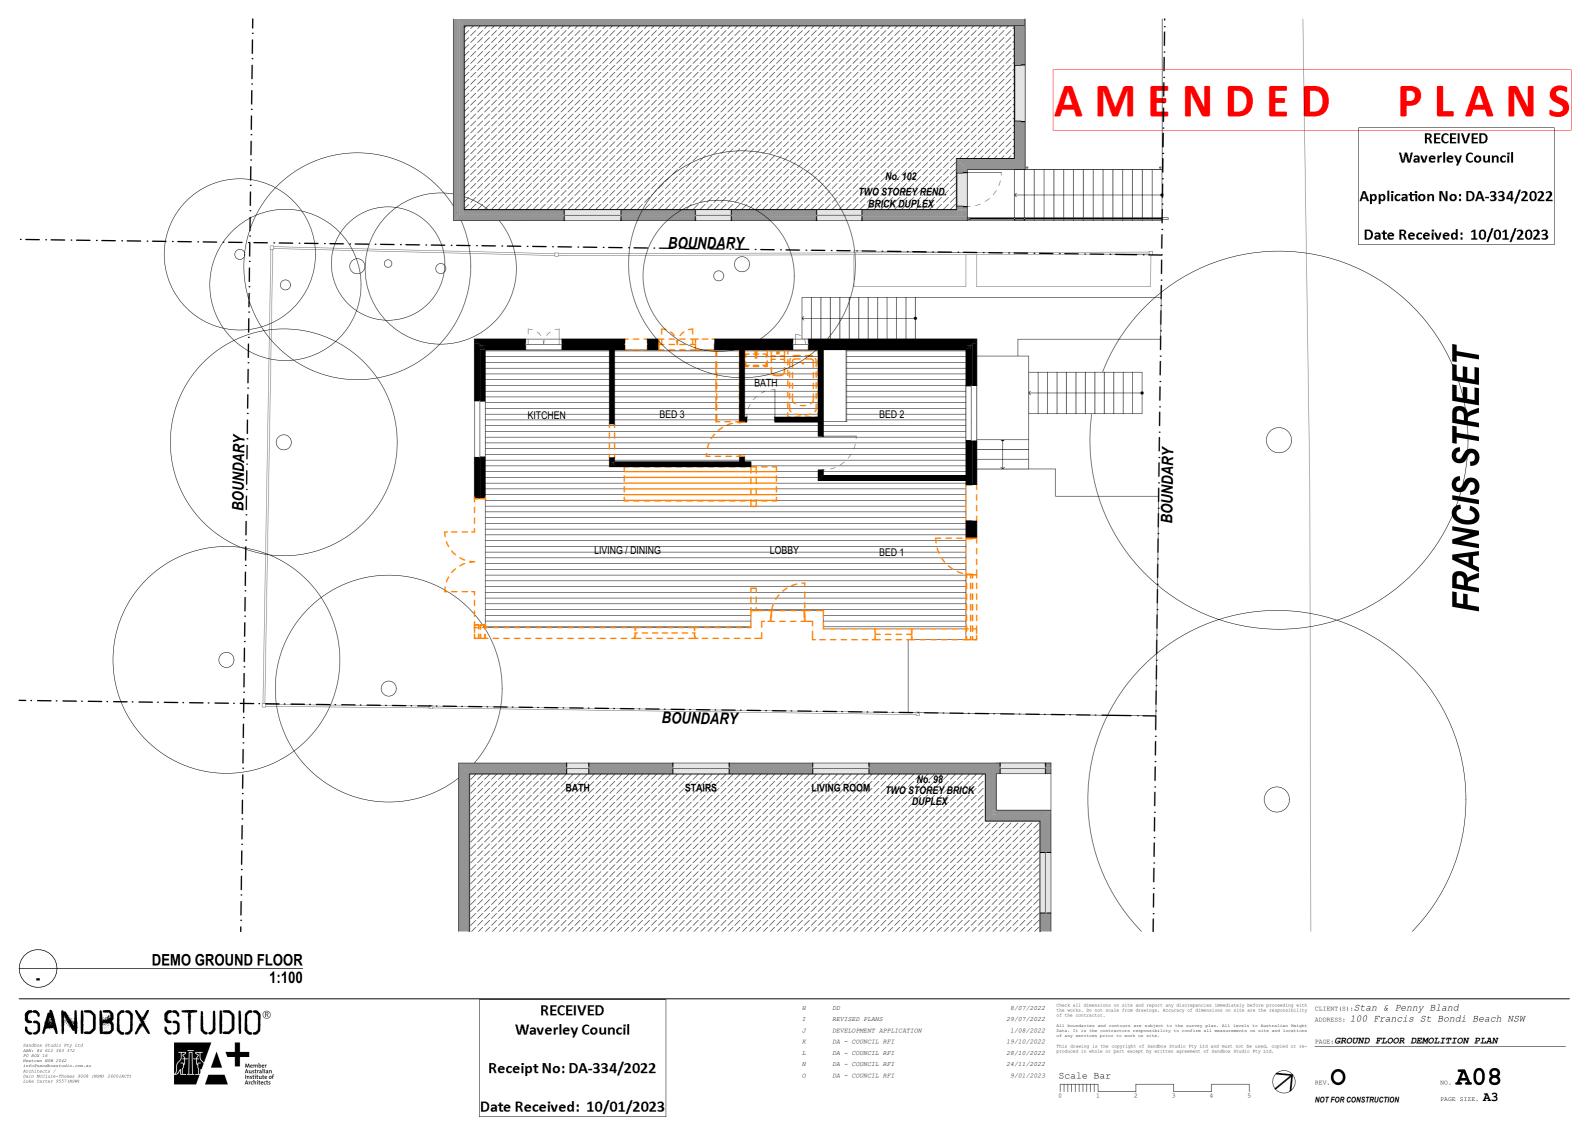

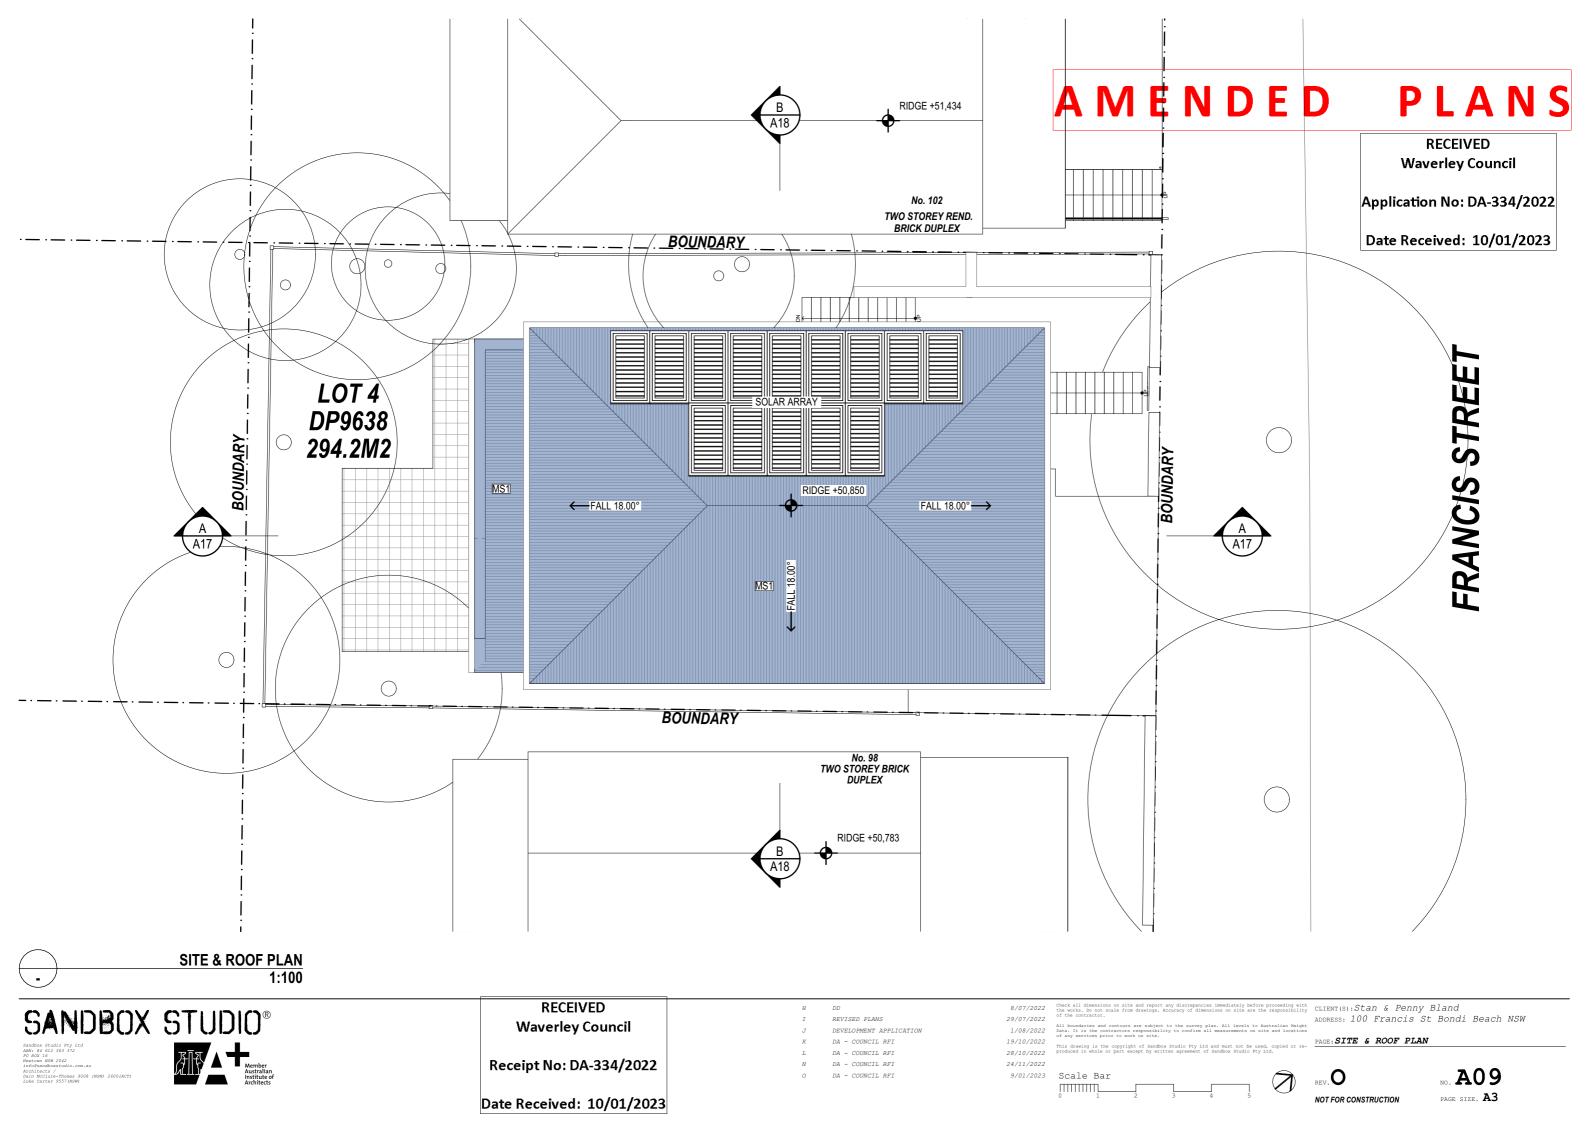

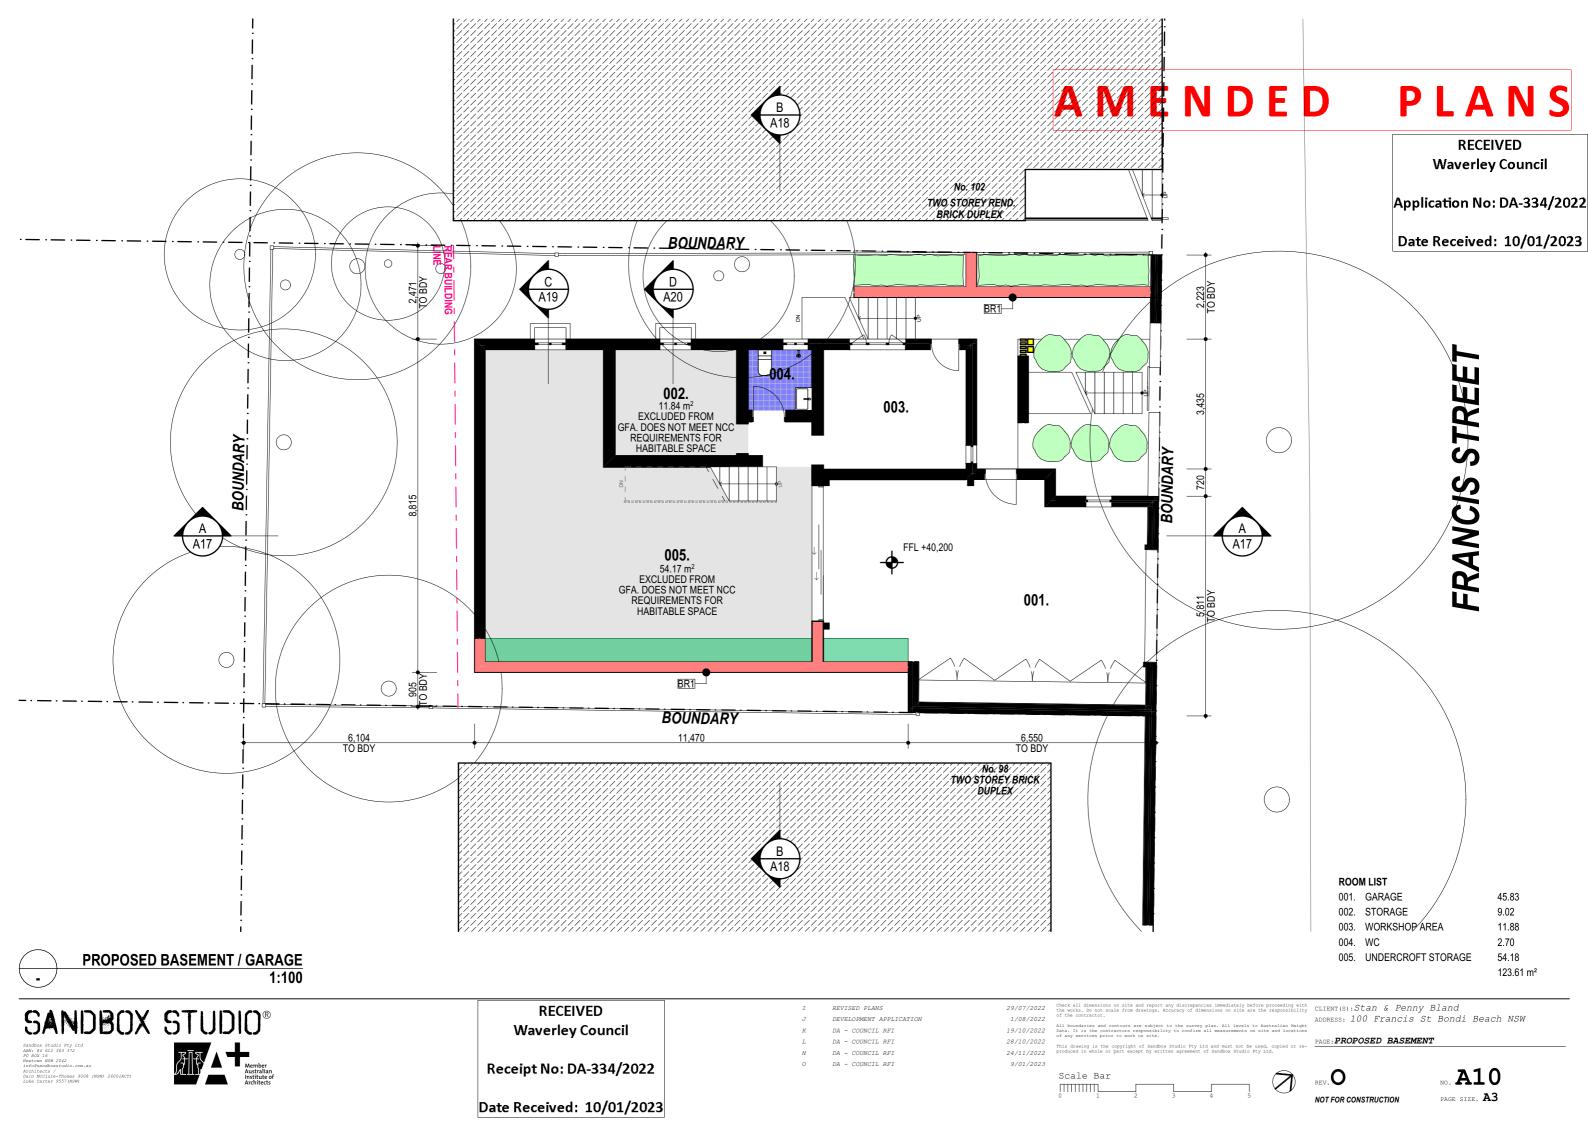

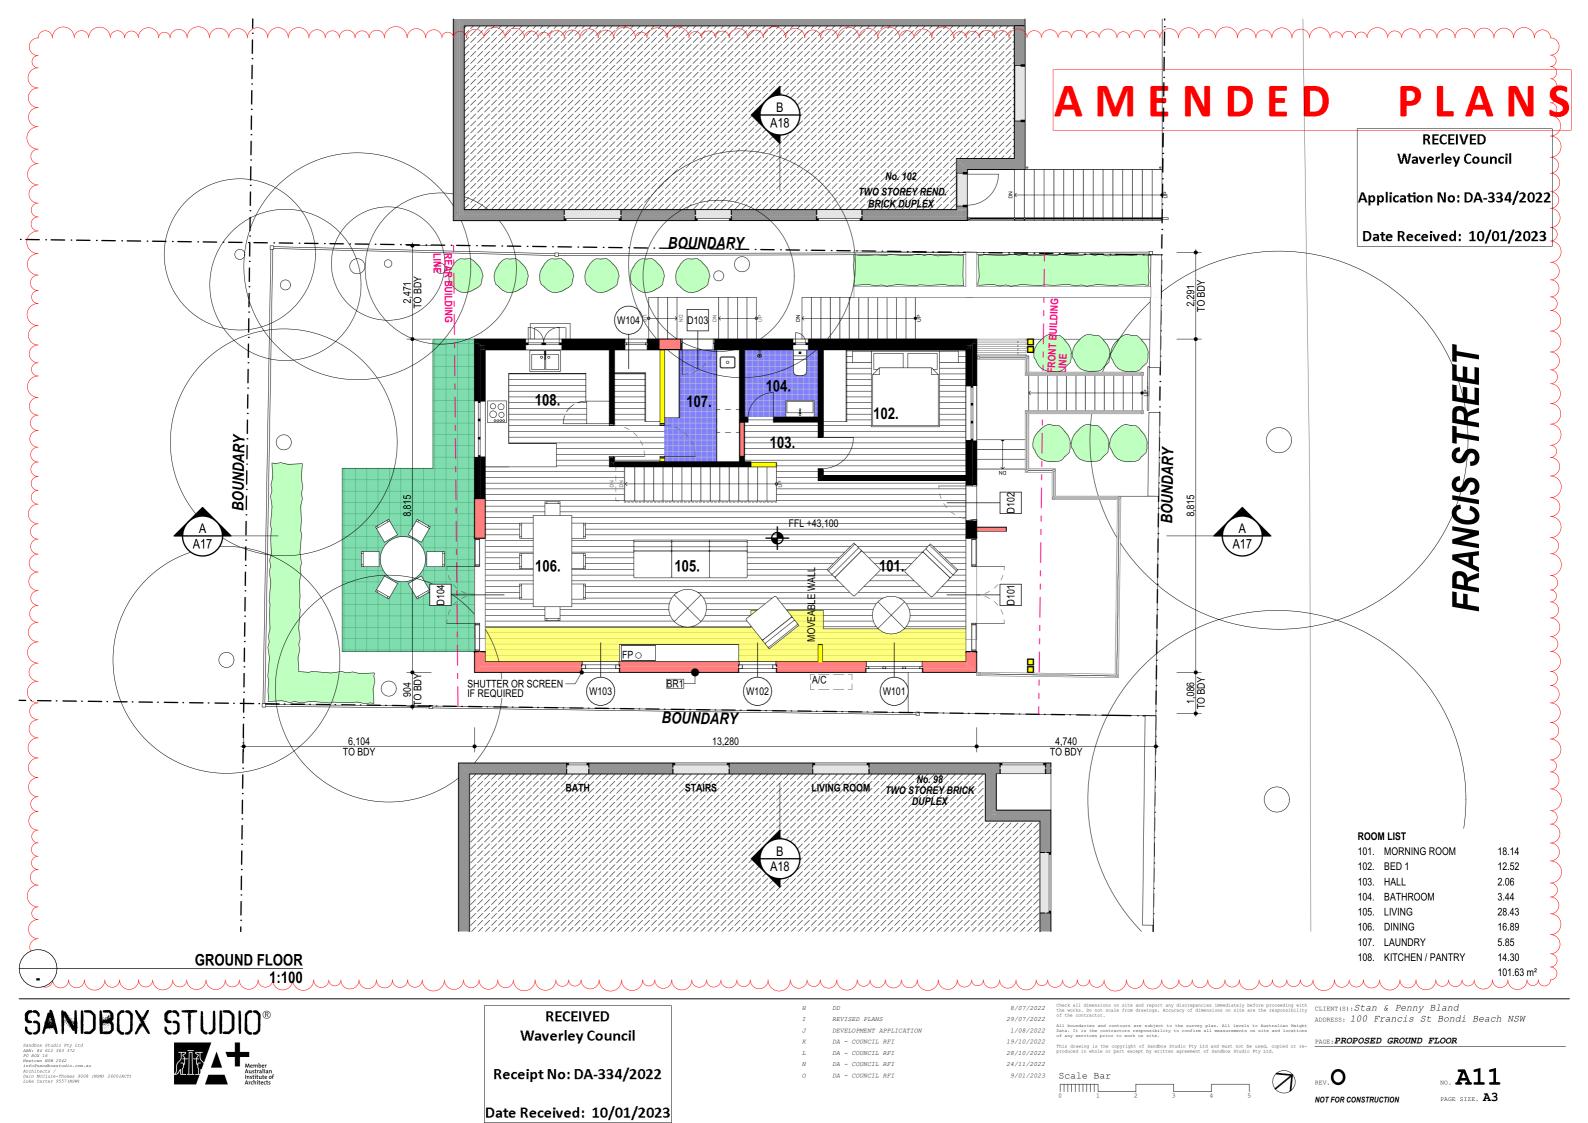

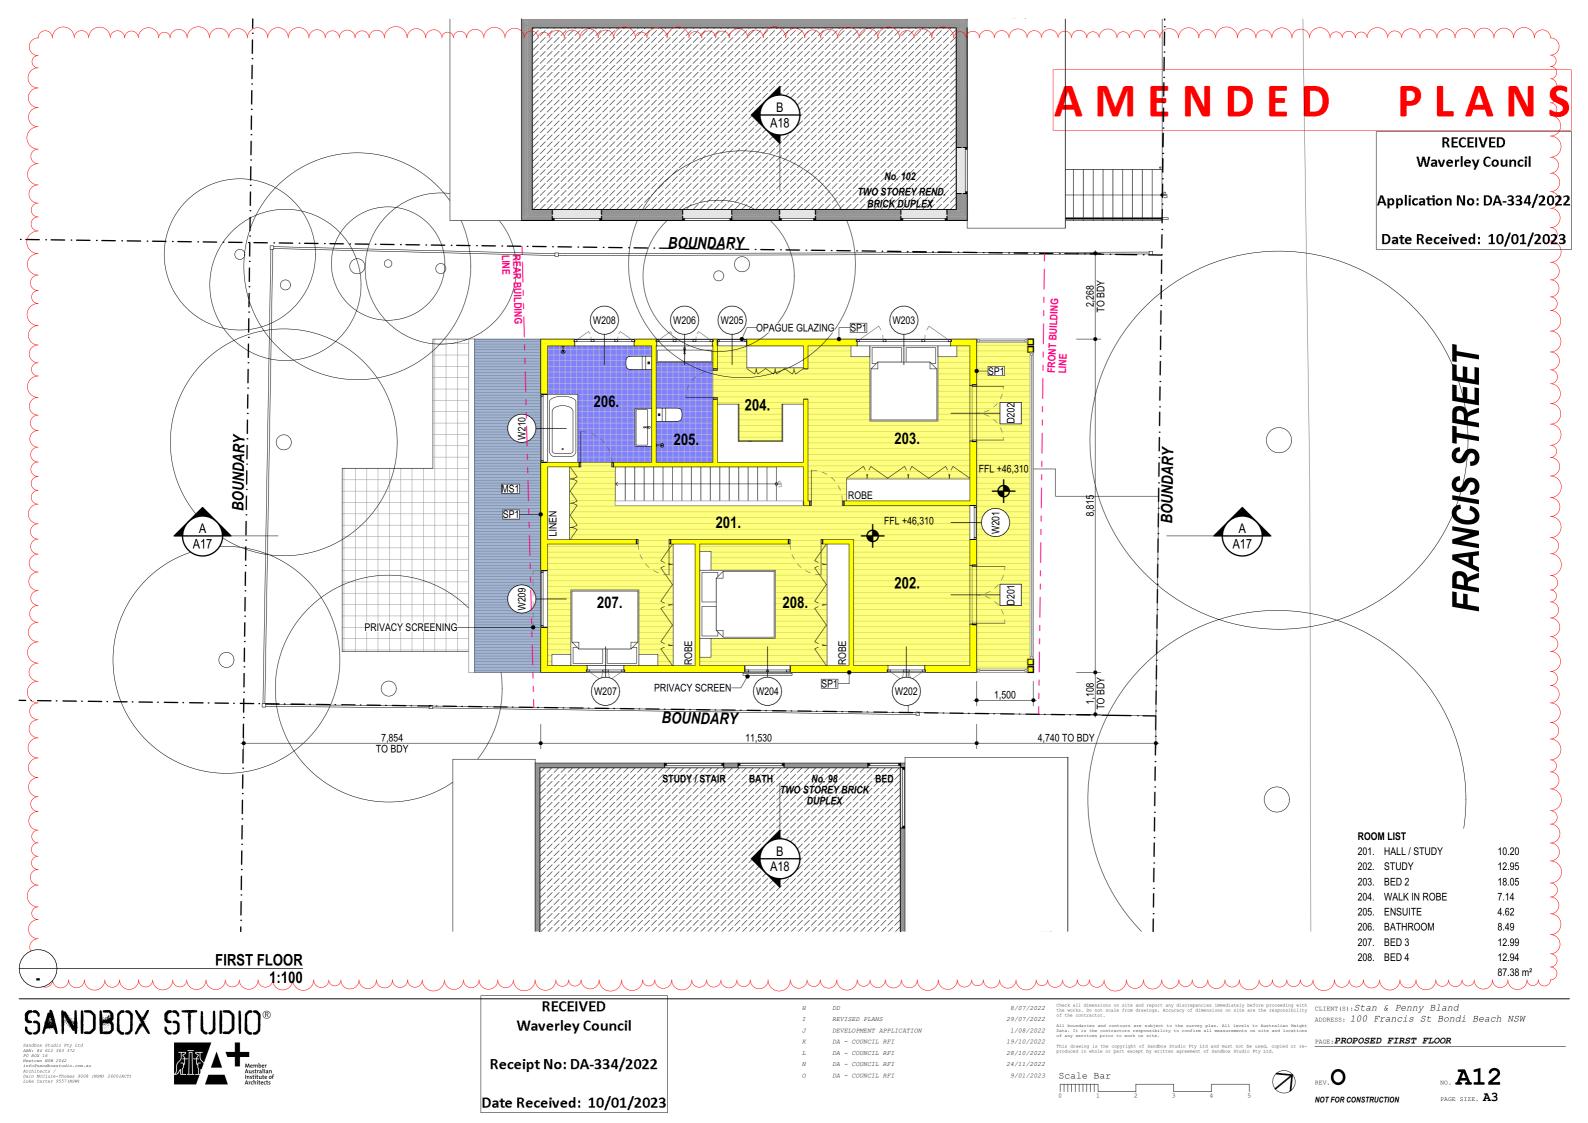


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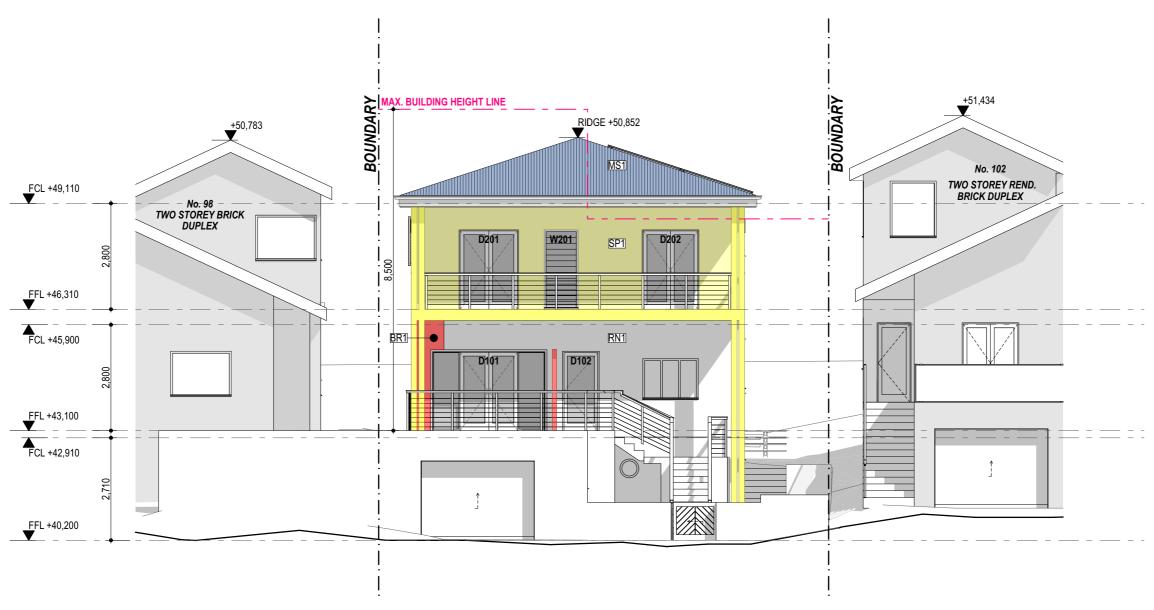
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NORTH EAST ELEVATION 1:100

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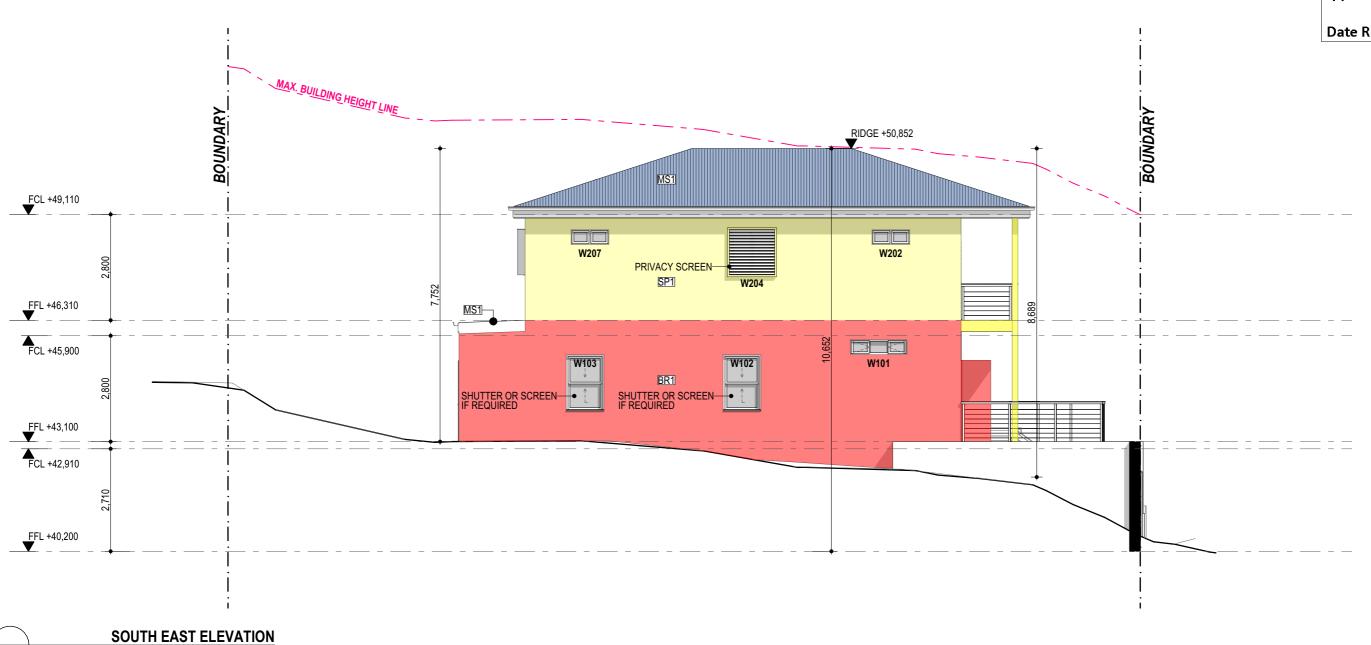
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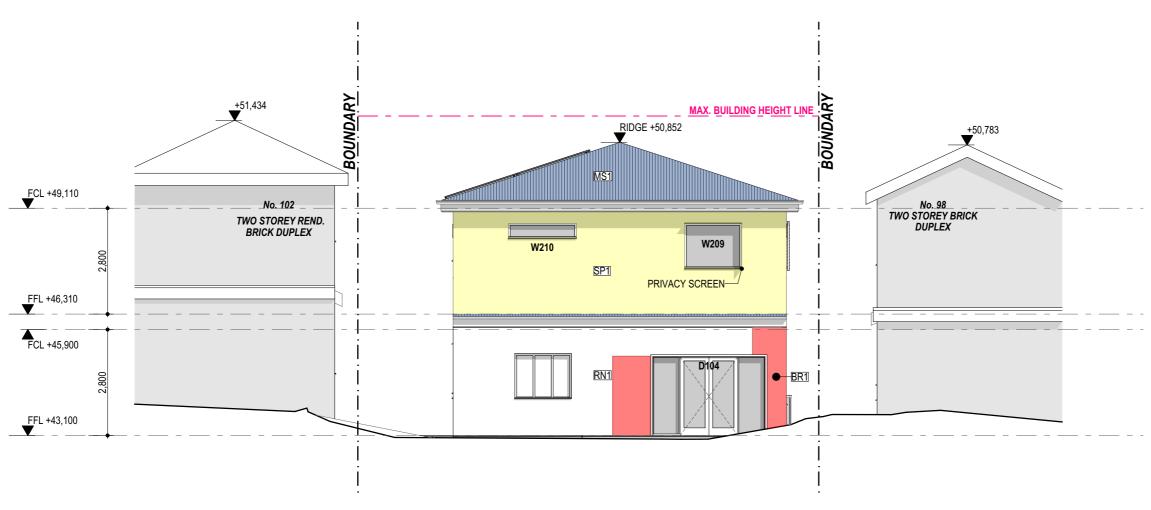
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SOUTH WEST ELEVATION 1:100

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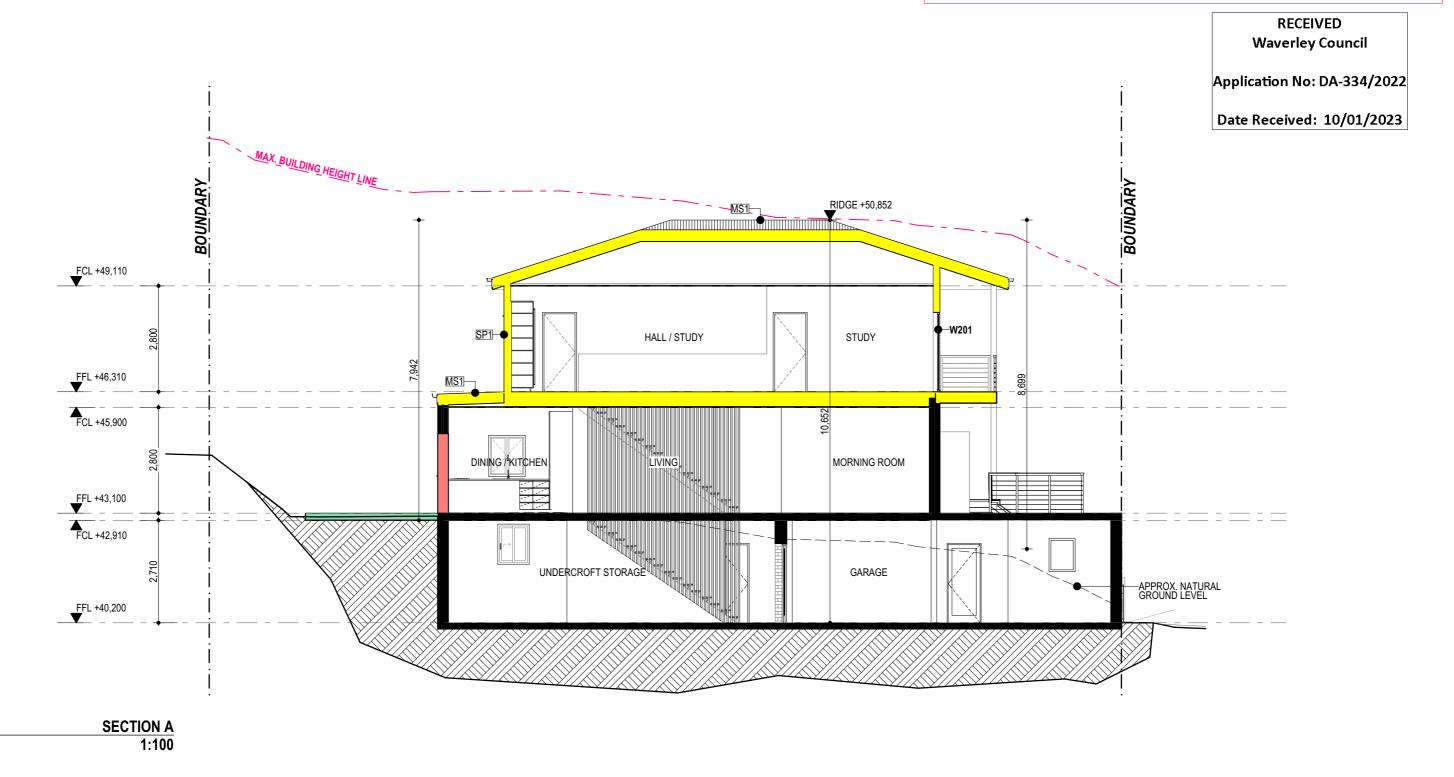
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41 boundaries and contours are subject to the survey plan. All levels to Australia bats. It is the confrictor responsibility to confirm all measurements on site and 1 of any services prior to work on site.

75 This drawing is the copyright of Sandbox Studio Fty Ltd. and must not be used, copie produced in whole or part except by written agreement of Sandbox Studio Fty Ltd.
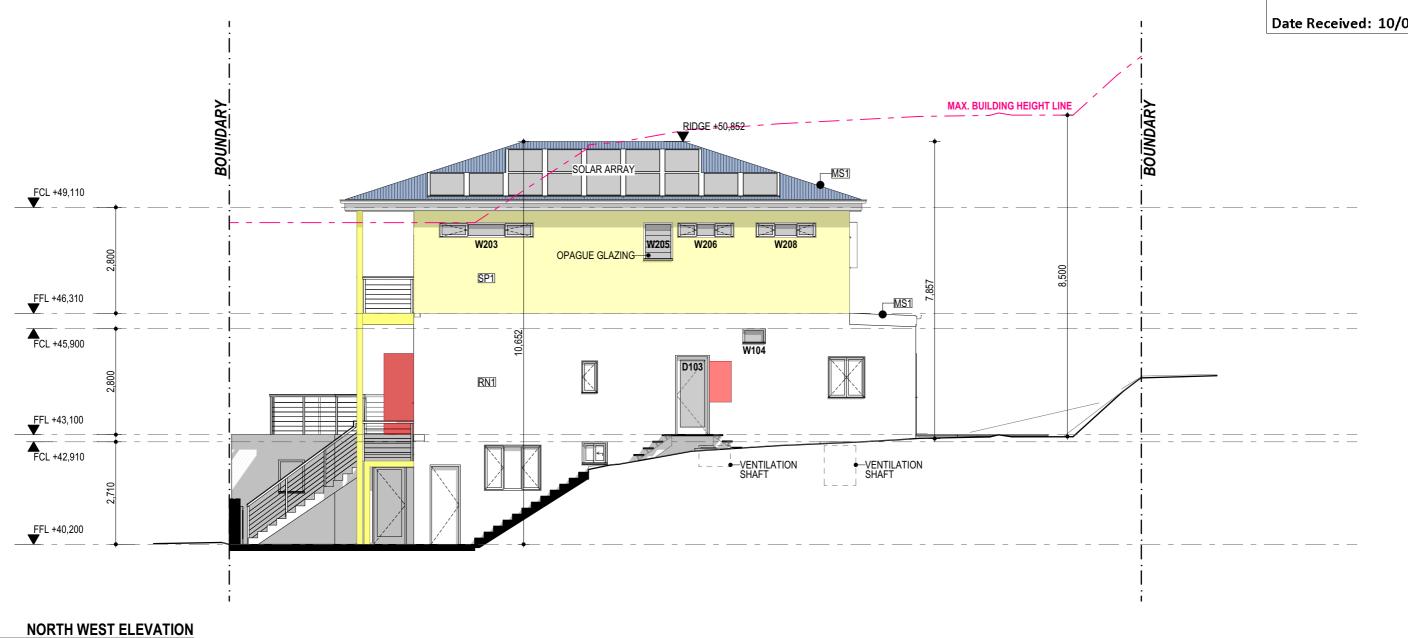
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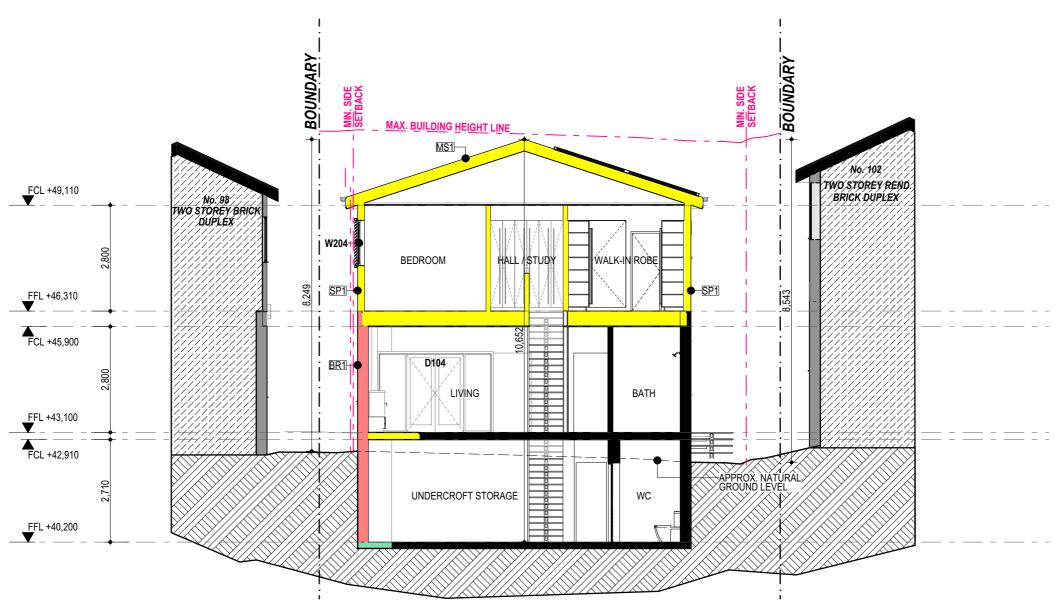
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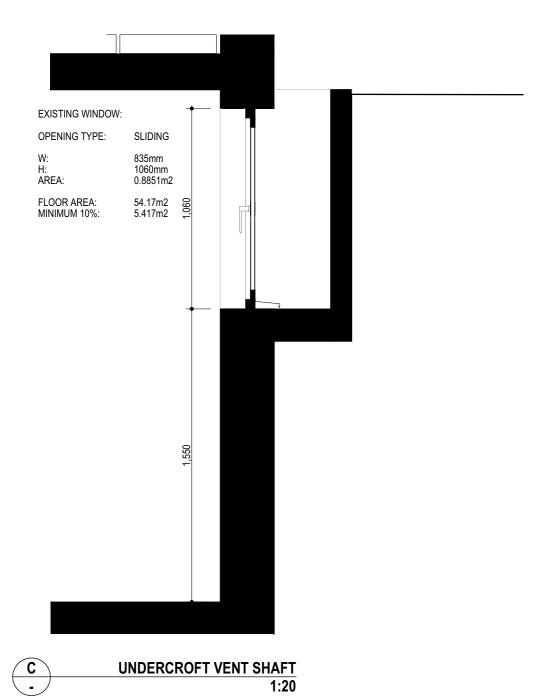
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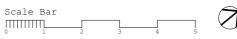
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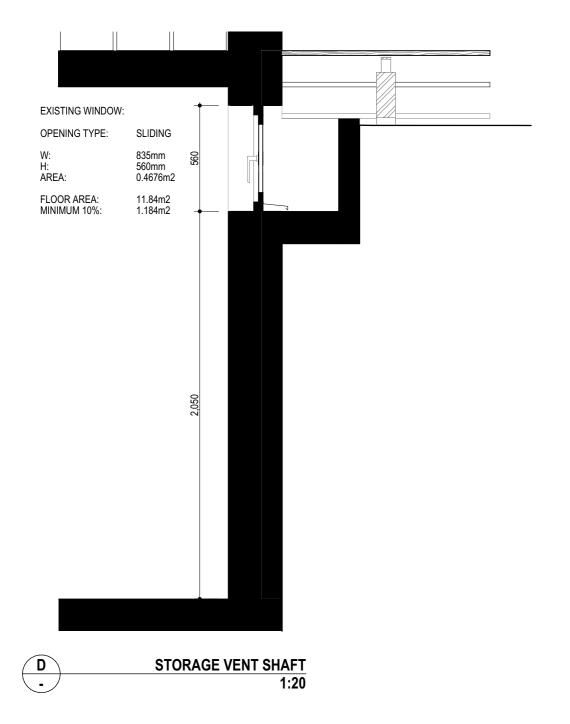
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PAGE: **DETAIL SECTIONS**









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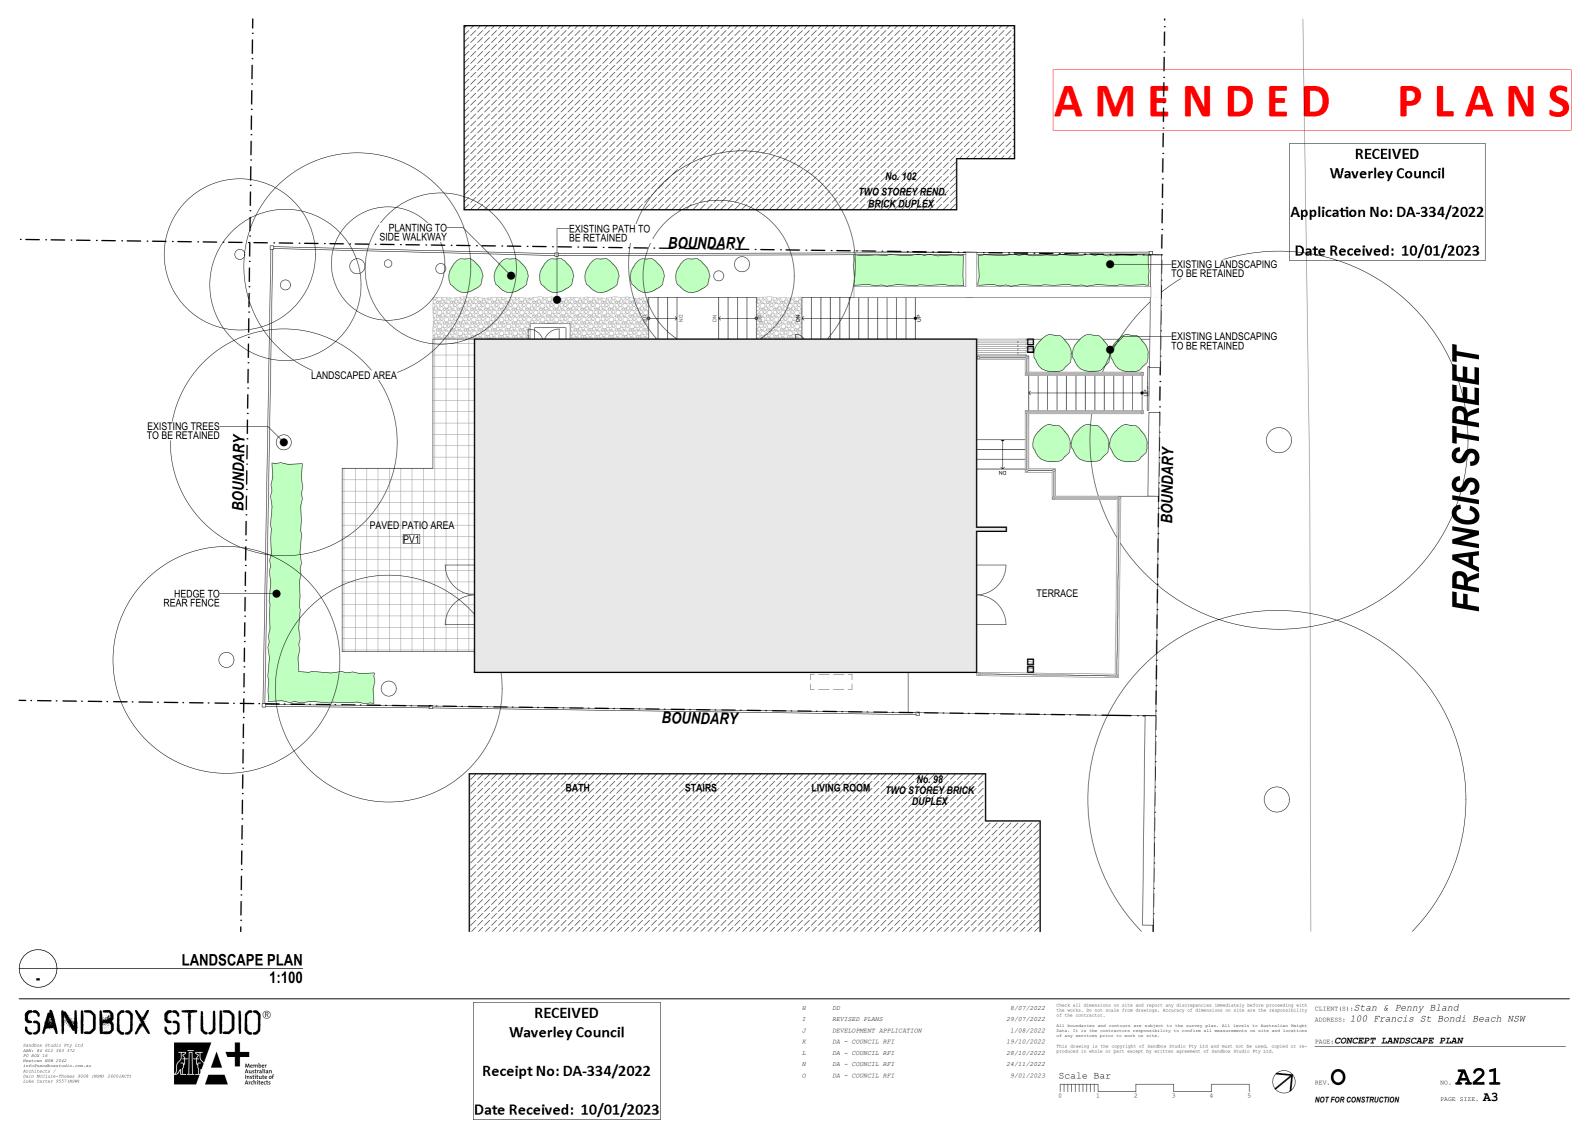
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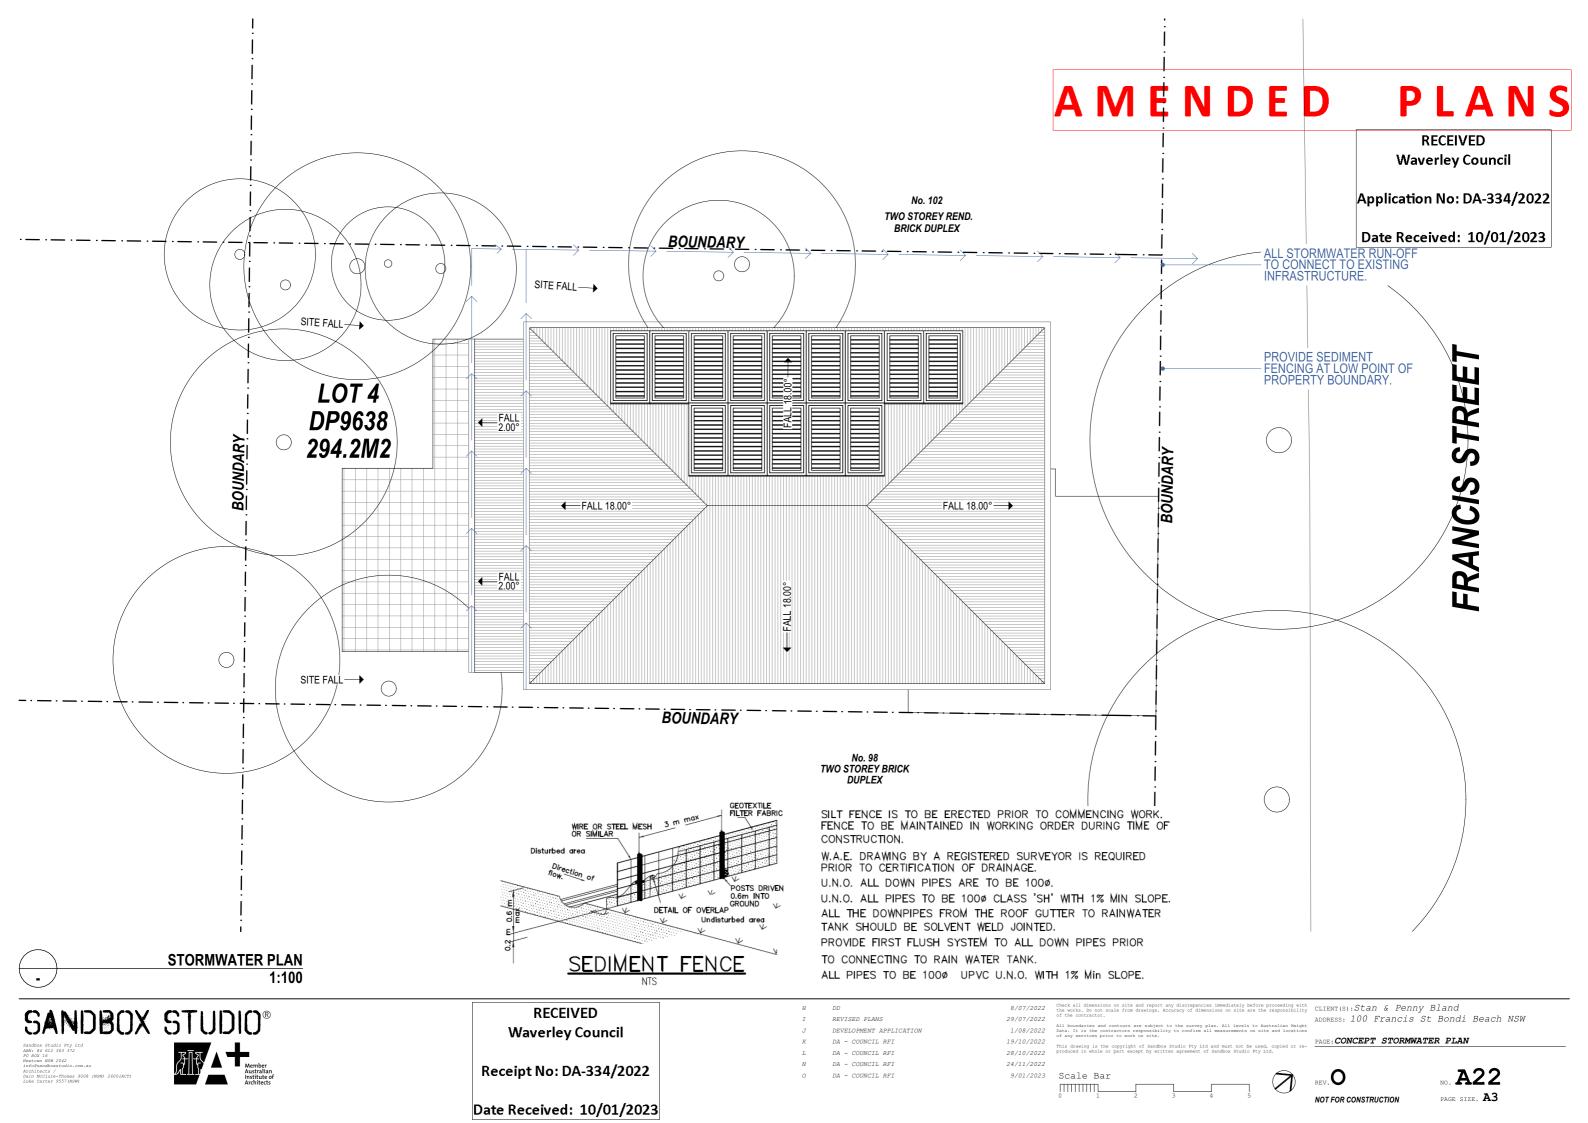
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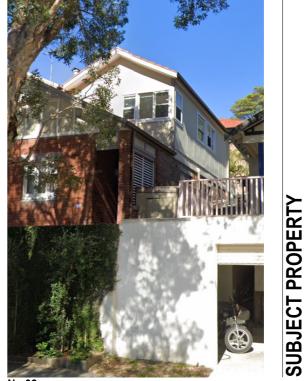
NO. **A26** PAGE SIZE. A3



No 94. App. FRONT SETBACK: 3400mm



No 96. App. FRONT SETBACK: 3100mm



No 98. App. FRONT SETBACK: 3100mm

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Application No: DA-334/2022

Date Received: 10/01/2023

AMENDED PLANS



No 102. App. FRONT SETBACK: 3200mm

SUBJECT PROPERTY



No 104. App. FRONT SETBACK: 3200mm



No 106. App. FRONT SETBACK: 2600mm FIRST FLOOR ROOFED BALCONY FACING FRANCIS ST.



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Receipt No: DA-334/2022

Date Received: 10/01/2023

DA - COUNCIL RFI


CLIENT(S):Stan & Penny Bland
ADDRESS: 100 Francis St Bondi Beach NSW



A27

AMENDED PLANS



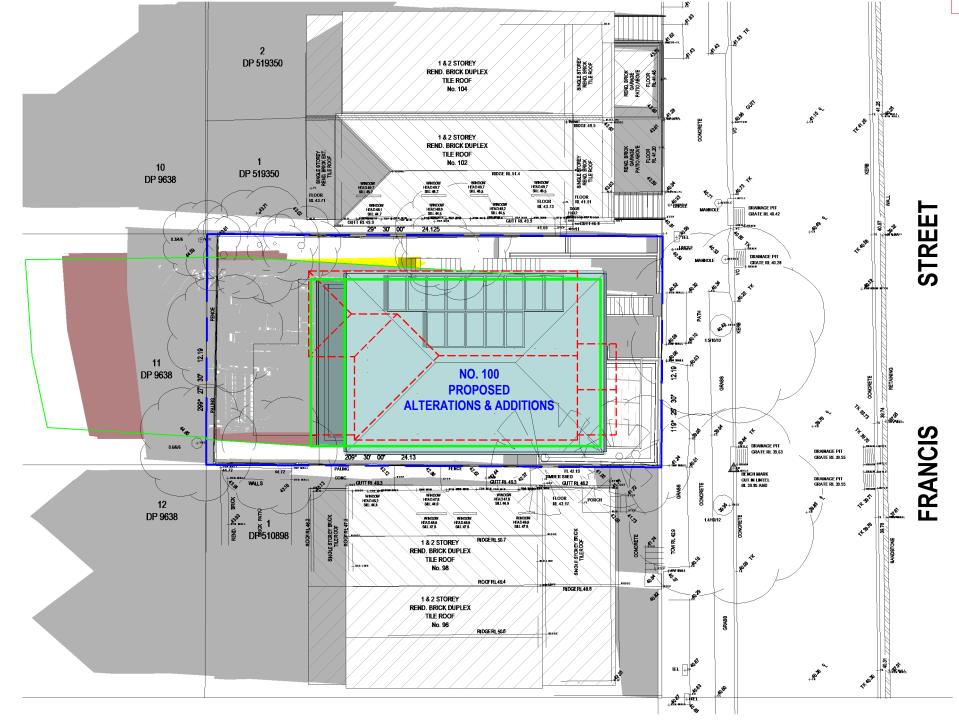

LEGEND:

DENOTES OUTLINE OF EXISTING
STRUCTURES TO BE DEMOLISHED

DENOTES AREA OF EXISTING &
SURROUNDING BUILDING SHADOW
DENOTES AREA OF PROPOSED

DENOTES AREA OF PROPOSED ADDITIONAL BUILDING SHADOW

ADDITIONS & ALTERATIONS

DENOTES AREA OF PROPOSED REDUCTION OF BUILDING SHADOW (STRUCTURES TO BE DEMOLISHED)

DENOTES OUTLINE OF COMPLIANT ENVELOPE MODEL & SHADOW

NOTE:

Checked by

SHADOWS SHOWN HAVE BEEN COMPILED FROM INFORMATION FROM DETAIL & LEVEL SURVEY BY BALLENDEN SURVEYORS REF NO. 210218 ISSUED 16/11/2021 & ARCHITECTURAL PLANS & MODELS SUPPLIED BY SANDBOX STUDIO REV.N DATED 24/11/2022

Shadowing June 21st 9.00am

1:200

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ABN 27 083 288 153

SUITE 1, 505 BALMAIN ROAD, LILYFIELD, NSW P.O.BOX 446 GLADESVILLE 2111 SHADOW ANALYSIS CONSULTANTS

MOBILE: 0410 699919

info@caddraftnsw.com.au

No.	Description	Date
	1	L

SHADOW DIAGRAMS
No. 100 FRANCIS STREET
BONDI BEACH

CLIENT: STAN & PENNY BLAND


Shadowing	Shadowing June 21st 9.00am					
Project number	22-165					
Date	20-12-22	A100				
Drawn by	КР					

JD Scale

1:200


AMENDED PLANS



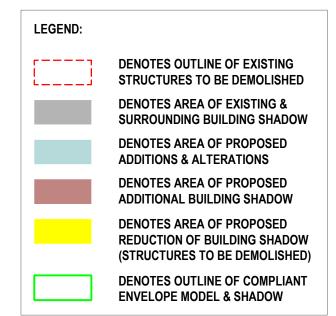

NOTE:

SHADOWS SHOWN HAVE BEEN COMPILED FROM INFORMATION FROM DETAIL & LEVEL SURVEY BY BALLENDEN SURVEYORS REF NO. 210218 ISSUED 16/11/2021 & ARCHITECTURAL PLANS & MODELS SUPPLIED BY SANDBOX STUDIO REV.N DATED 24/11/2022

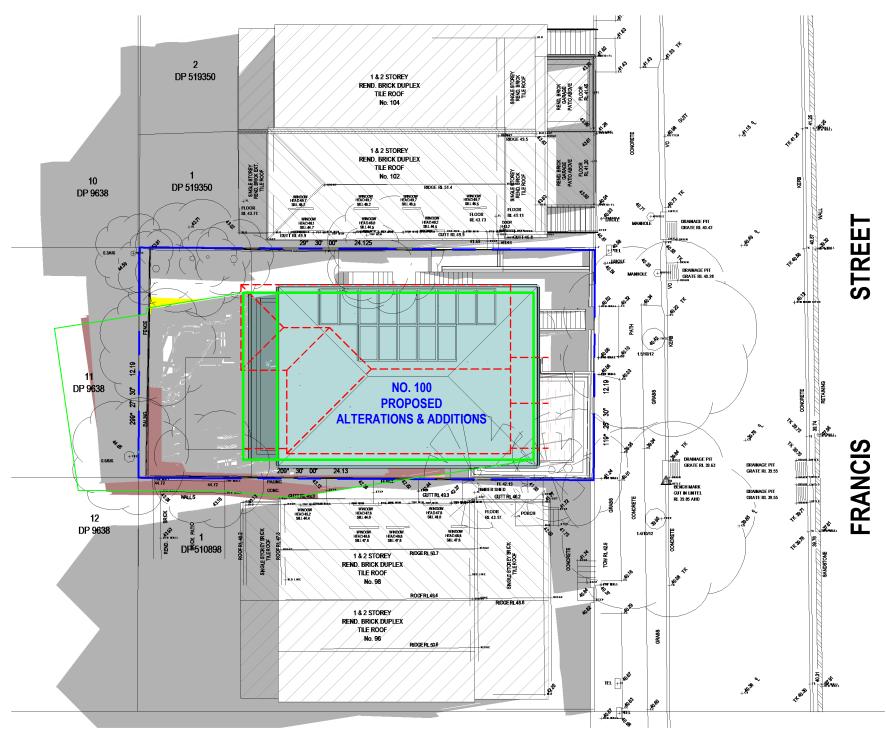

Shadowing June 21st 10.00am

1:200

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Date Received: 10/01/2023

Date

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SUITE 1, 505 BALMAIN ROAD, LILYFIELD, NSW P.O.BOX 446 GLADESVILLE 2111


SHADOW ANALYSIS CONSULTANTS		
MOBILE: 0410 699919		
info@caddraftnsw.com.au		

Description

No.

SHADOW DIAGRAMS No. 100 FRANCIS STREET **BONDI BEACH**

Project number	22-165		
Date	20-12-22	A101	
Drawn by	КР		
Checked by	JD	Scale	1 : 200

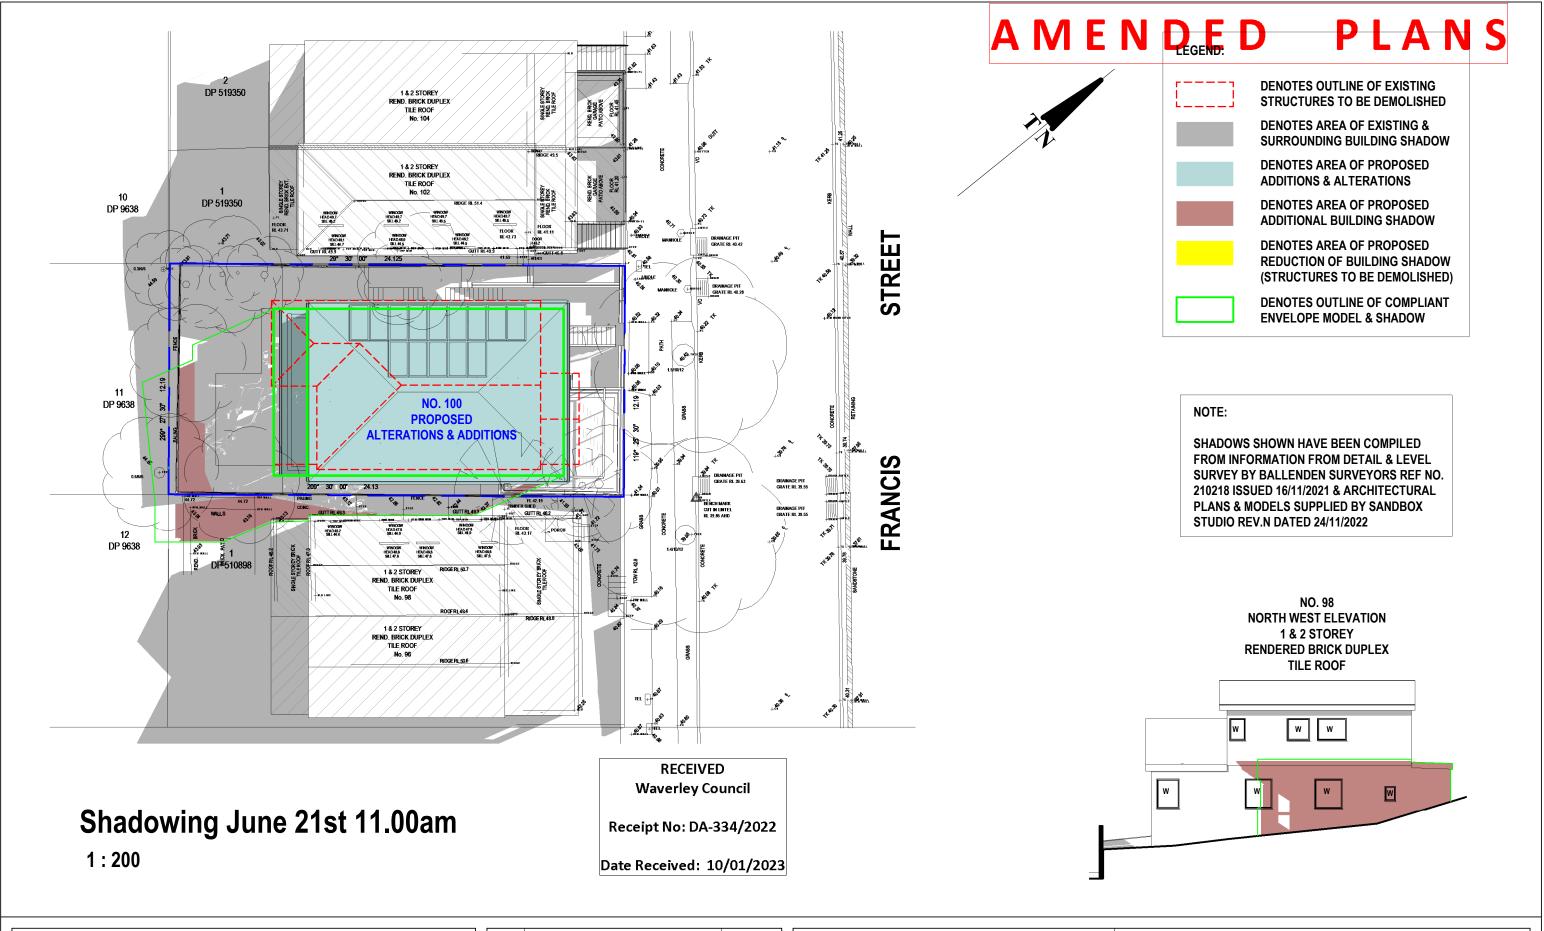

Cad	Draft	D/I
Vau	Diail	

ABN 27 083 288 153

SUITE 1, 505 BALMAIN ROAD, LILYFIELD, NSW P.O.BOX 446 GLADESVILLE 2111 SHADOW ANALYSIS CONSULTANTS


MOBILE: 0410 699919

info@caddraftnsw.com.au

	No.	Description	Date
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SHADOW DIAGRAMS
No. 100 FRANCIS STREET
BONDI BEACH

Shadowing June 21st 11.00am			
Project number	22-165		
Date	20-12-22	A 1	102
Drawn by	KP		_
Checked by	JD	Scale	1:200

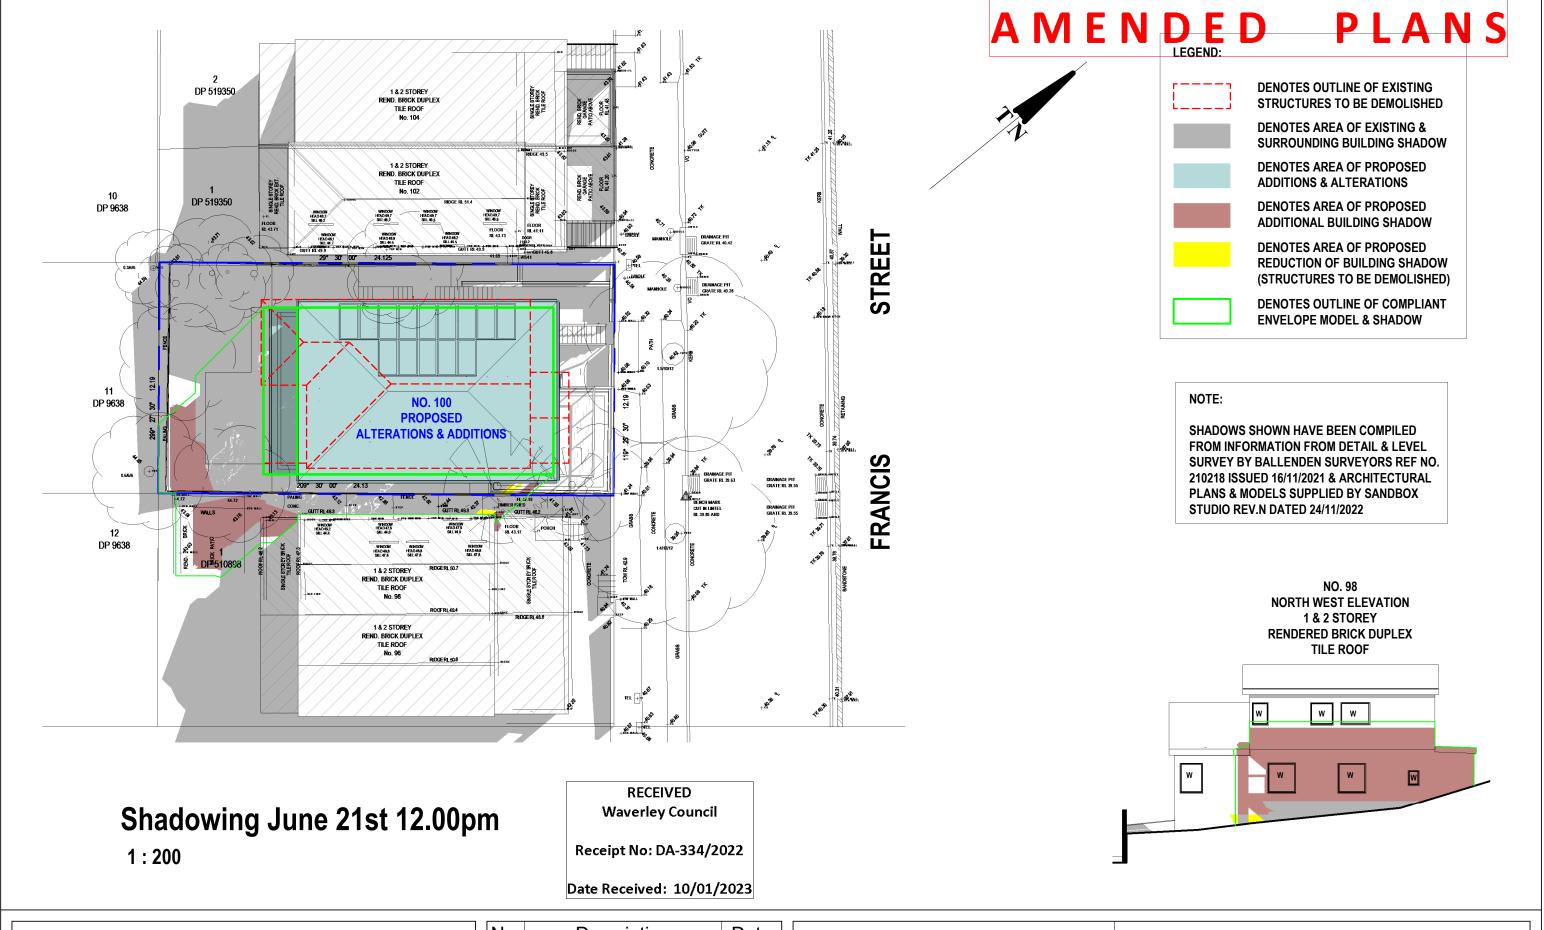

Cad	Draft	P/I
Jau	Diait	

ABN 27 083 288 153

SUITE 1, 505 BALMAIN ROAD, LILYFIELD, NSW P.O.BOX 446 GLADESVILLE 2111 SHADOW ANALYSIS CONSULTANTS


MOBILE: 0410 699919

info@caddraftnsw.com.au

No.	Description	Date

SHADOW DIAGRAMS
No. 100 FRANCIS STREET
BONDI BEACH

Shadowing June 21st 12.00pm				
Project number	22-165			
Date	20-12-22		A103	
Drawn by	KP			
Checked by	JD	Scale		1:200

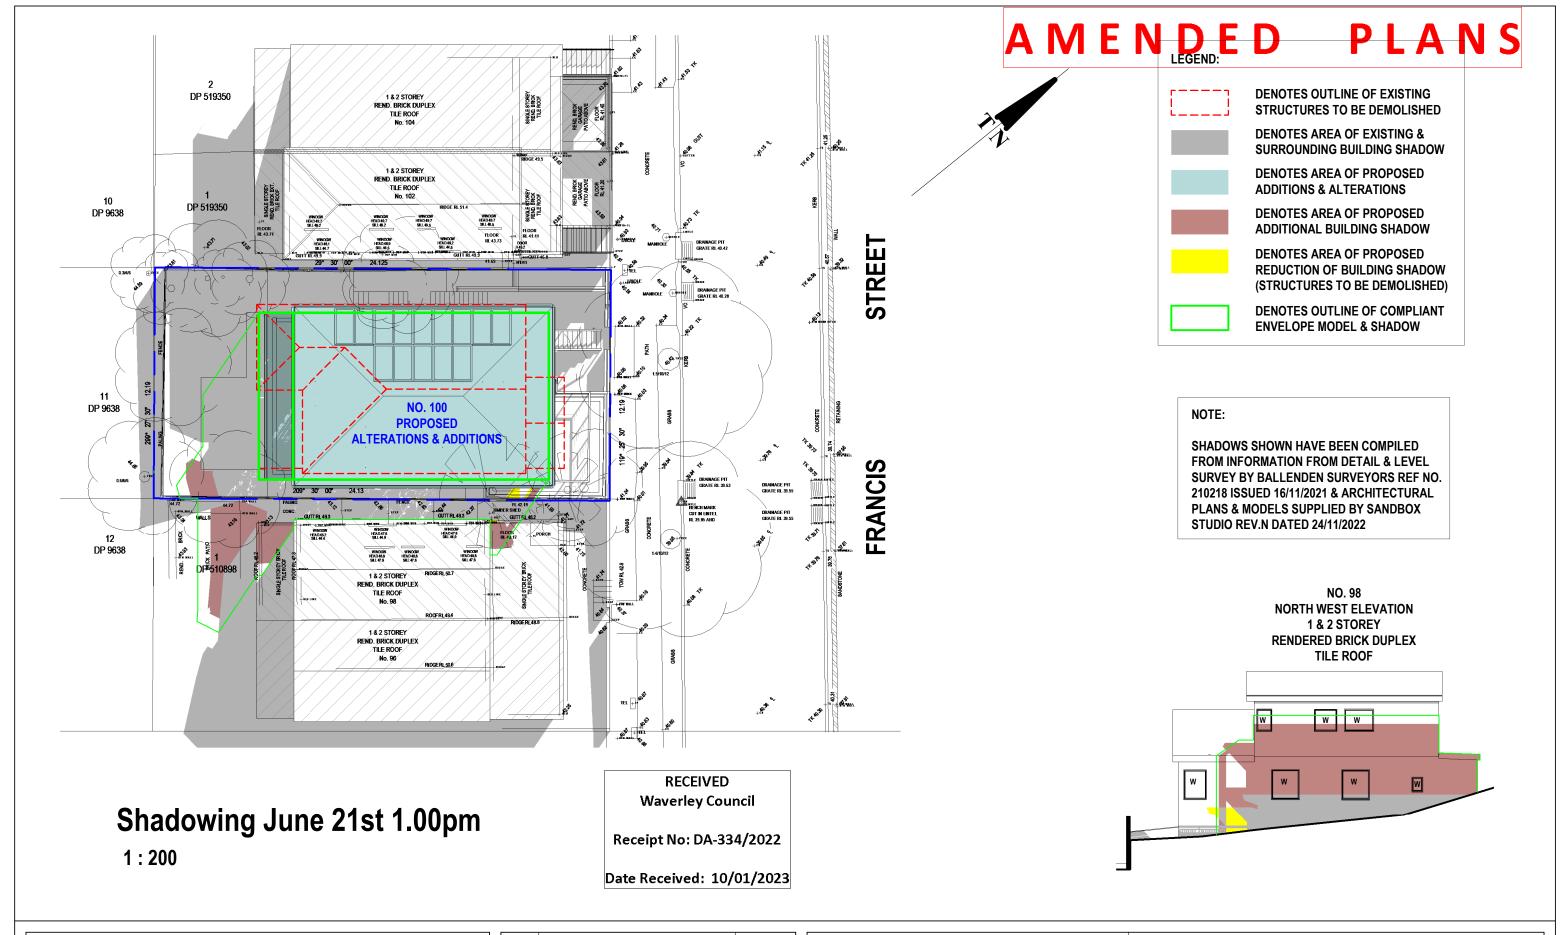

		D /I
Cad	Draft	P/L

ABN 27 083 288 153

SUITE 1, 505 BALMAIN ROAD, LILYFIELD, NSW P.O.BOX 446 GLADESVILLE 2111 SHADOW ANALYSIS CONSULTANTS


MOBILE: 0410 699919

info@caddraftnsw.com.au

No.	Description	Date

SHADOW DIAGRAMS
No. 100 FRANCIS STREET
BONDI BEACH

Shadowing June 21st 1.00pm			
Project number	22-165		
Date	20-12-22	A	104
Drawn by	KP		
Checked by	JD	Scale	1:200

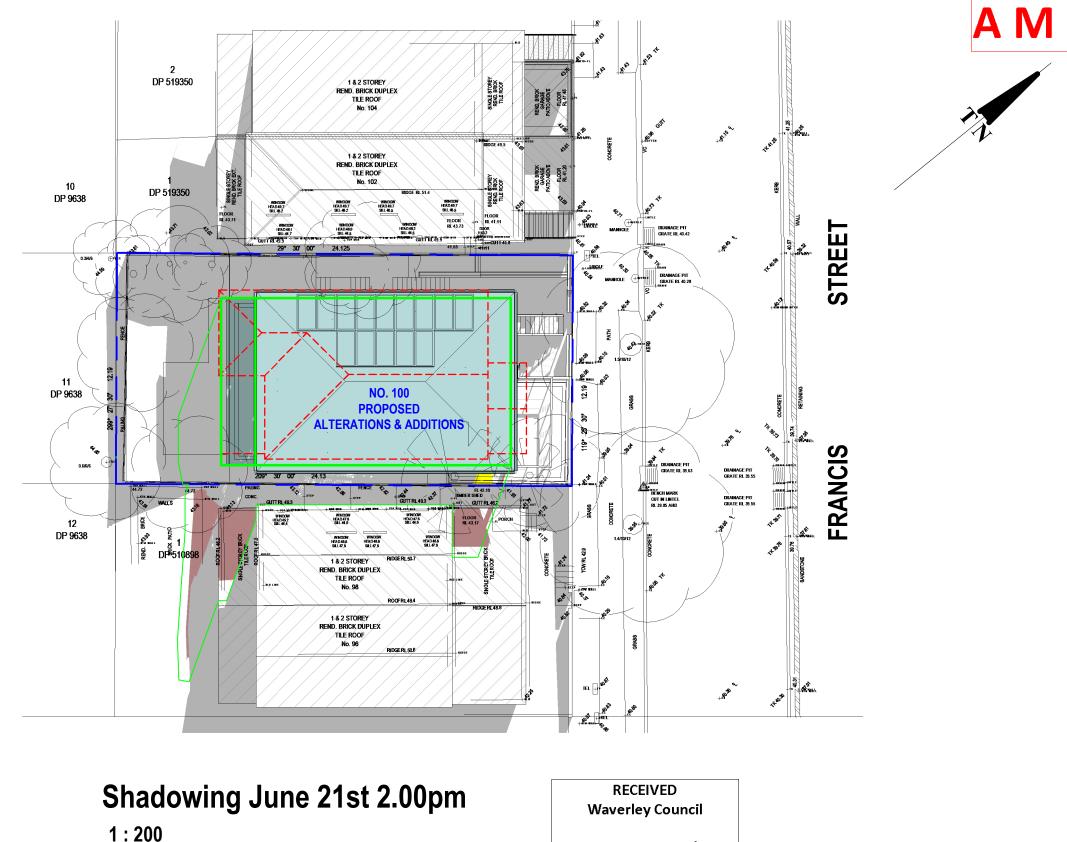

AMENDED PLANS

DENOTES OUTLINE OF EXISTING STRUCTURES TO BE DEMOLISHED

DENOTES AREA OF EXISTING & SURROUNDING BUILDING SHADOW

DENOTES AREA OF PROPOSED ADDITIONS & ALTERATIONS

DENOTES AREA OF PROPOSED ADDITIONAL BUILDING SHADOW


DENOTES AREA OF PROPOSED REDUCTION OF BUILDING SHADOW (STRUCTURES TO BE DEMOLISHED)

DENOTES OUTLINE OF COMPLIANT ENVELOPE MODEL & SHADOW

NOTE:

SHADOWS SHOWN HAVE BEEN COMPILED FROM INFORMATION FROM DETAIL & LEVEL SURVEY BY BALLENDEN SURVEYORS REF NO. 210218 ISSUED 16/11/2021 & ARCHITECTURAL PLANS & MODELS SUPPLIED BY SANDBOX **STUDIO REV.N DATED 24/11/2022**

> NO. 98 **NORTH WEST ELEVATION** 1 & 2 STOREY RENDERED BRICK DUPLEX **TILE ROOF**

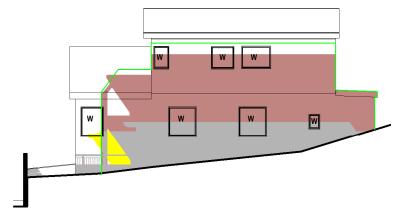

Receipt No: DA-334/2022

Date Received: 10/01/2023

Cad Draft P/L

SUITE 1, 505 BALMAIN ROAD, LILYFIELD, NSW P.O.BOX 446 GLADESVILLE 2111 SHADOW ANALYSIS CONSULTANTS


MOBILE: 0410 699919

info@caddraftnsw.com.au

No.	Description	Date
	_	

SHADOW DIAGRAMS No. 100 FRANCIS STREET **BONDI BEACH**

Project number	22-165		
Date	20-12-22	Α	105
Drawn by	KP		
Checked by	JD	Scale	1:200

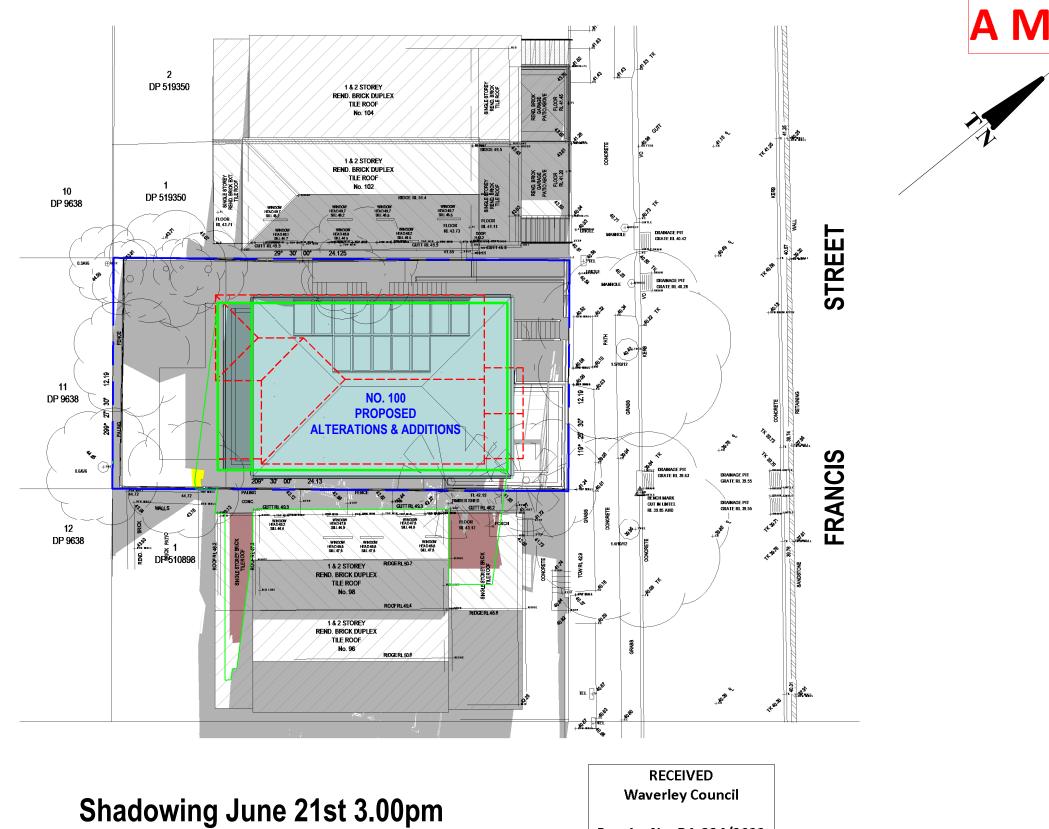

AMEN DED PLANS



DENOTES AREA OF EXISTING & SURROUNDING BUILDING SHADOW

DENOTES AREA OF PROPOSED ADDITIONS & ALTERATIONS

DENOTES AREA OF PROPOSED ADDITIONAL BUILDING SHADOW

DENOTES AREA OF PROPOSED REDUCTION OF BUILDING SHADOW (STRUCTURES TO BE DEMOLISHED)

DENOTES OUTLINE OF COMPLIANT ENVELOPE MODEL & SHADOW

NOTE:

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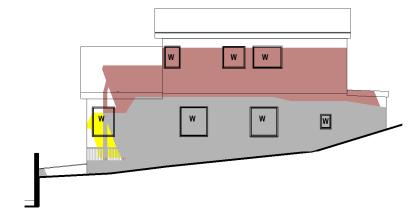
NO. 98

NORTH WEST ELEVATION

1 & 2 STOREY

RENDERED BRICK DUPLEX

TILE ROOF



1:200

Receipt No: DA-334/2022

Date Received: 10/01/2023

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ABN 27 083 288 153

SUITE 1, 505 BALMAIN ROAD, LILYFIELD, NSW P.O.BOX 446 GLADESVILLE 2111 SHADOW ANALYSIS CONSULTANTS

MOBILE: 0410 699919


info@caddraftnsw.com.au

Description	Date
	Description

SHADOW DIAGRAMS
No. 100 FRANCIS STREET
BONDI BEACH

pm

Project number	22-165		
Date	20-12-22	A 1	06
Drawn by	КР		
Checked by	JD	Scale	1 : 200

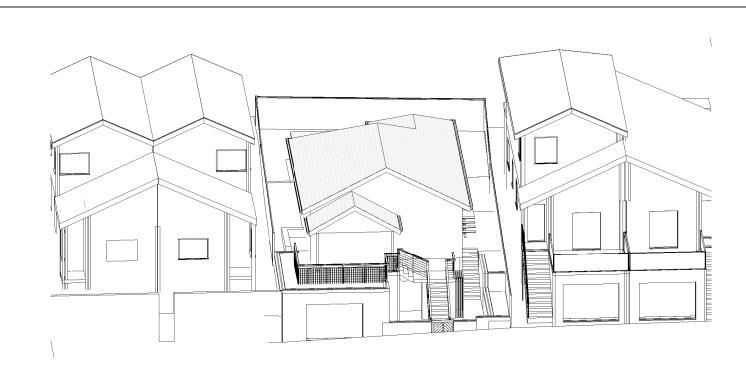


June 21st 9.00am Existing


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Receipt No: DA-334/2022

Date Received: 10/01/2023

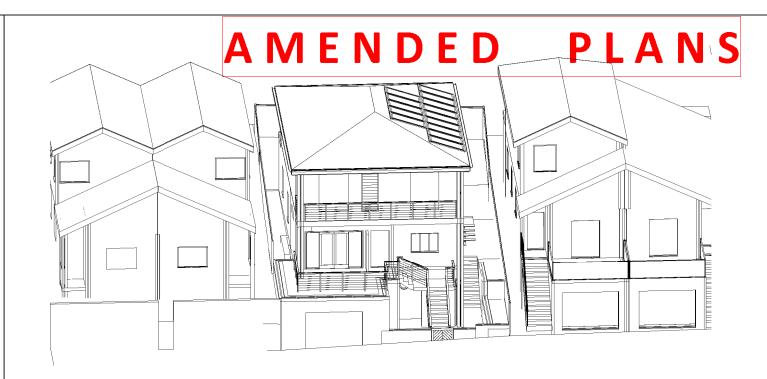

June 21st 9.00am Proposed

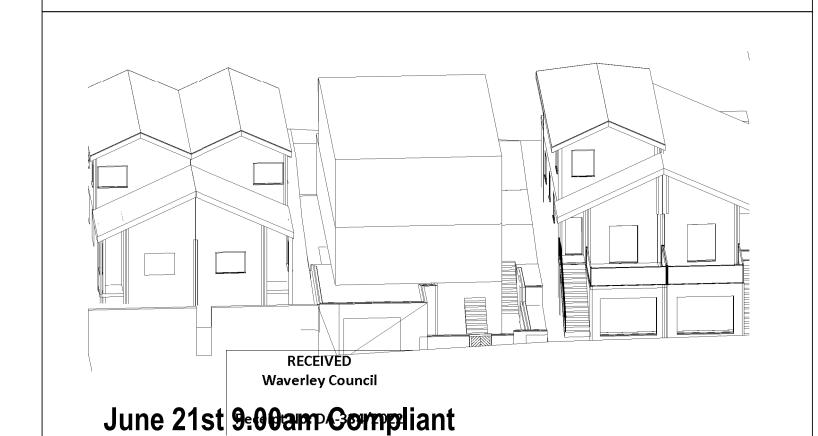

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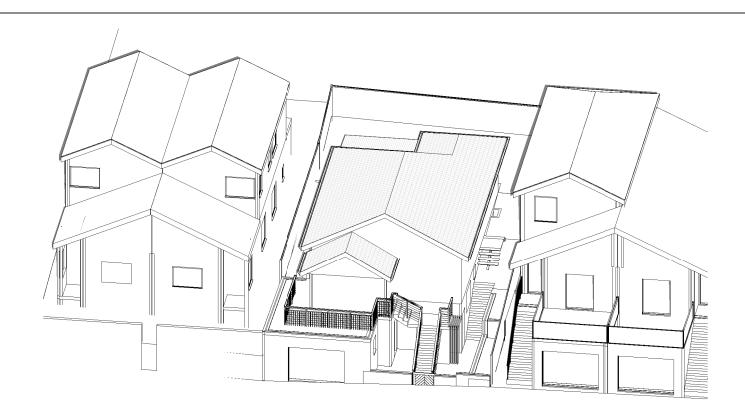
MOBILE: 0410 699919

info@caddraftnsw.com.au

No.	Description	Date
	1	

SHADOW DIAGRAMS
No. 100 FRANCIS STREET
BONDI BEACH

Project number	22-165	
Date	20-12-22	A107
Drawn by	KP	
Checked by	JD	Scale




June 21st 10.00am Existing

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June 21st 10.00am Proposed



June 21st 10.00am Compliant
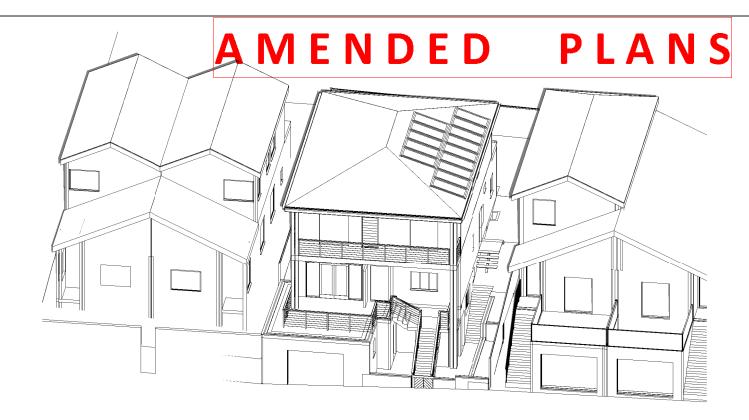
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SUITE 1, 505 BALMAIN ROAD, LILYFIELD, NSW P.O.BOX 446 GLADESVILLE 2111 **SHADOW ANALYSIS CONSULTANTS**

MOBILE: 0410 699919

info@caddraftnsw.com.au

No.	Description	Date

SHADOW DIAGRAMS
No. 100 FRANCIS STREET
BONDI BEACH


CLIENT: STAN & PENNY BLAND


3D Sun Views June 21st 10.00am

Project number	22-165	
Date	20-12-22	A108
Drawn by	KP	
Checked by	JD	Scale





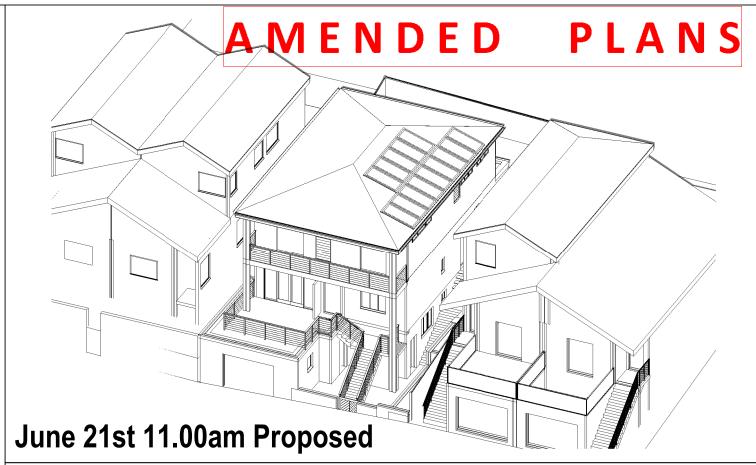

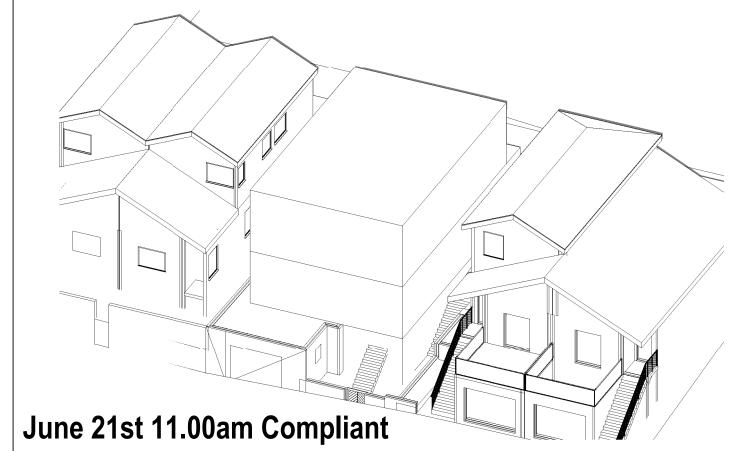

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ABN 27 083 288 153

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MOBILE: 0410 699919

info@caddraftnsw.com.au

No.	Description	Date

SHADOW DIAGRAMS
No. 100 FRANCIS STREET
BONDI BEACH

CLIENT: STAN & PENNY BLAND

3D Sun Views June 21st 11.00am


Project number	22-165	
Date	20-12-22	A109
Drawn by	KP	
Checked by	JD	Scale




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Date Received: 10/01/2023



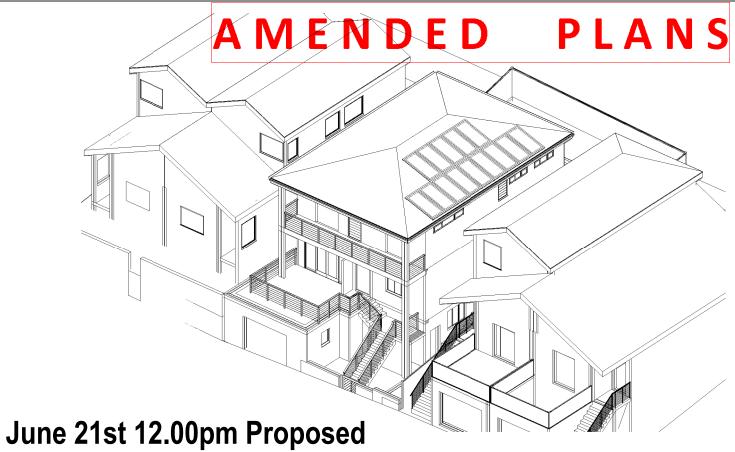

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MOBILE: 0410 699919

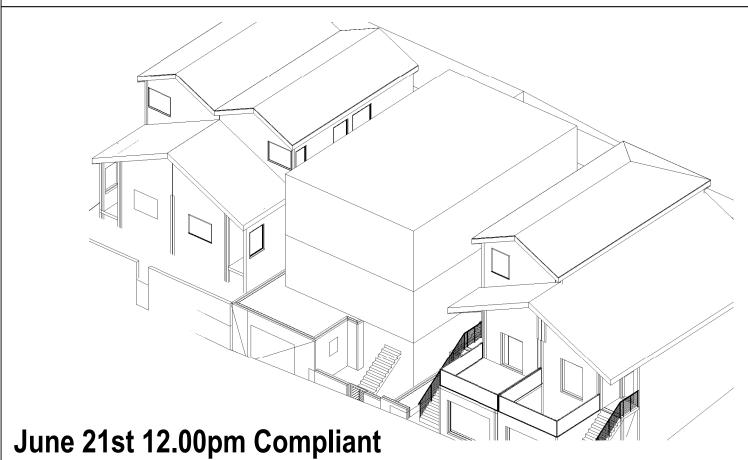info@caddraftnsw.com.au


No.	Description	Date

SHADOW DIAGRAMS
No. 100 FRANCIS STREET
BONDI BEACH

CLIENT: STAN & PENNY BLAND

3D Sun Views June 21st 12.00pm


Project number	22-165	
Date	20-12-22	A110
Drawn by	KP	
Checked by	JD	Scale

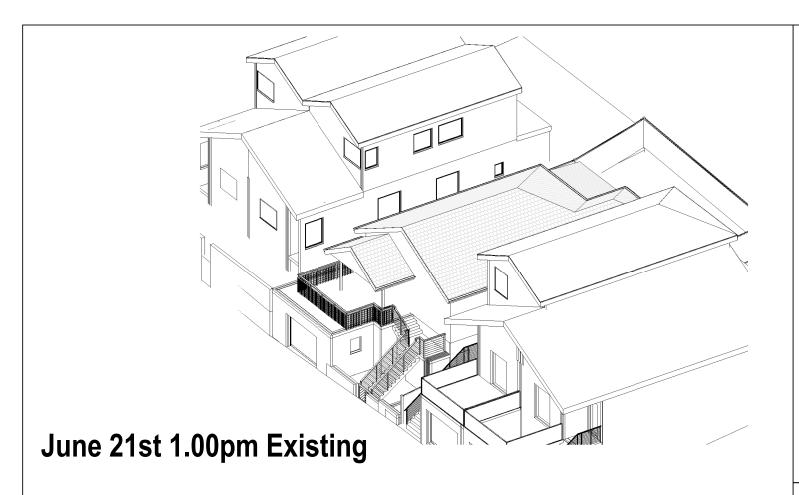


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SUITE 1, 505 BALMAIN ROAD, LILYFIELD, NSW P.O. BOX 446 GLADESVILLE 2111 SHADOW ANALYSIS CONSULTANTS

MOBILE: 0410 699919


info@caddraftnsw.com.au

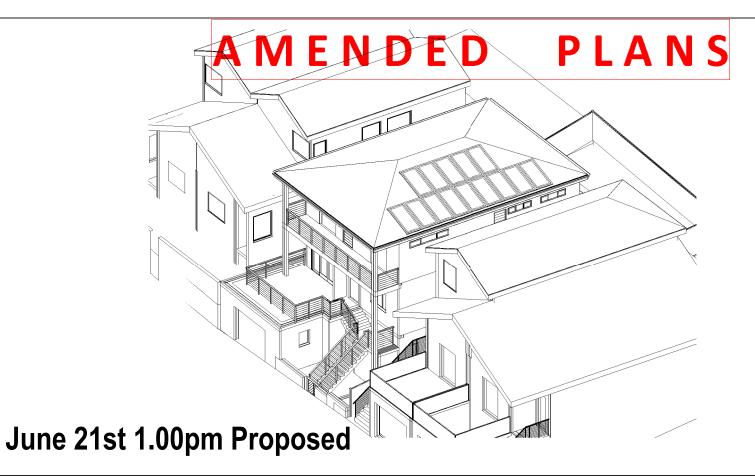SHADOW DIAGRAMS
No. 100 FRANCIS STREET
BONDI BEACH

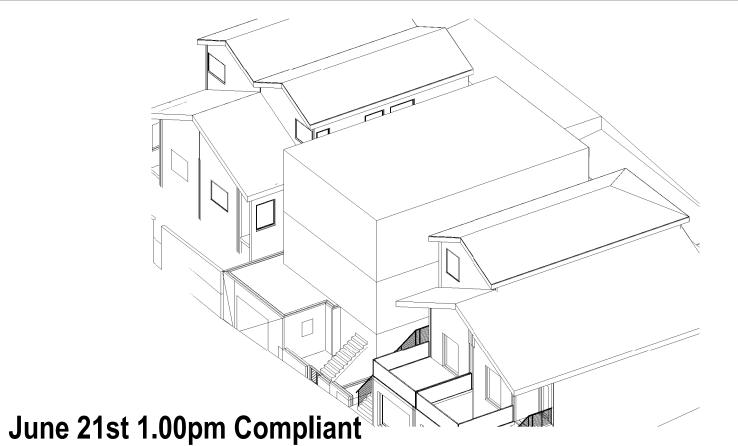CLIENT: STAN & PENNY BLAND

3D Sun Views June 21st 1.00pm

Project number	22-165	
Date	20-12-22	A111
Orawn by	KP	
Checked by	JD	Scale

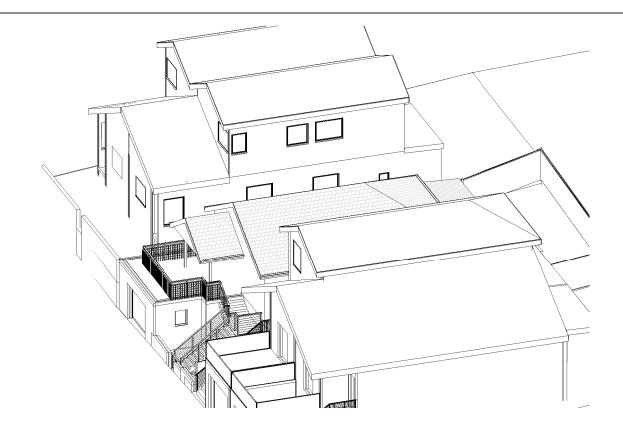


June 21st 2.00pm Existing


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Receipt No: DA-334/2022

Date Received: 10/01/2023

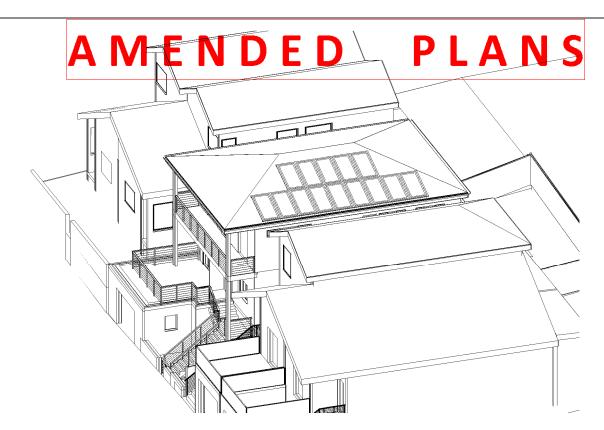

June 21st 2.00pm Proposed

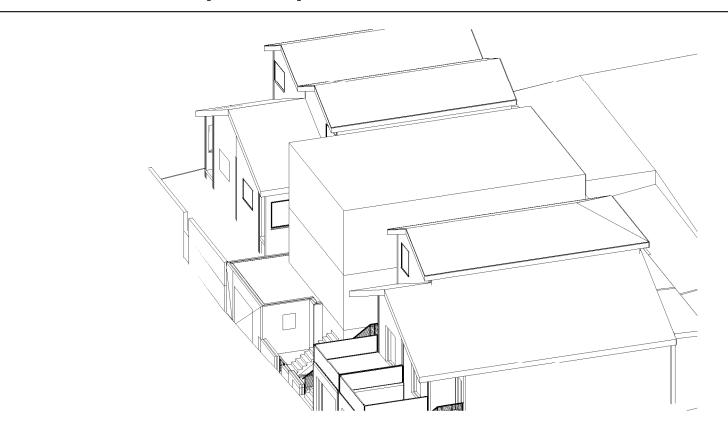

June 21st 2.00pm Compliant

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SUITE 1, 505 BALMAIN ROAD, LILYFIELD, NSW P.O.BOX 446 GLADESVILLE 2111 SHADOW ANALYSIS CONSULTANTS

MOBILE: 0410 699919

info@caddraftnsw.com.au

No.	Description	Date

SHADOW DIAGRAMS
No. 100 FRANCIS STREET
BONDI BEACH

CLIENT: STAN & PENNY BLAND

3D Sun Views June 21st 2.00pm

Project number	22-165	
Date	20-12-22	A112
Drawn by	KP	
Checked by	JD	Scale



June 21st 3.00pm Existing


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Receipt No: DA-334/2022

Date Received: 10/01/2023



June 21st 3.00pm Proposed

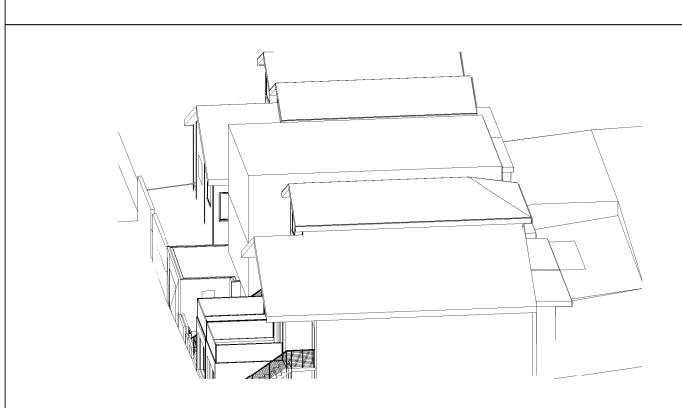

June 21st 3.00pm Compliant

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ABN 27 083 288 153

SUITE 1, 505 BALMAIN ROAD, LILYFIELD, NSW P.O.BOX 446 GLADESVILLE 2111 SHADOW ANALYSIS CONSULTANTS

MOBILE: 0410 699919

info@caddraftnsw.com.au

Description	Date
	Description

SHADOW DIAGRAMS
No. 100 FRANCIS STREET
BONDI BEACH

CLIENT: STAN & PENNY BLAND

3D Sun Views June 21st 3.00pm

Project number	22-165	
Date	20-12-22	A113
Drawn by	KP	
Checked by	JD	Scale